

PETROLEUM DEVELOPMENT OMAN

Nimr Sludge Pit System Upgrade – FEED + DD


Construction Scope of Work Main Project

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By



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1.0 INTRODUCTION

Petroleum Development Oman (PDO – Herein after called as Company) has proposed to construct and upgrade the existing Sludge disposal system at Nimr. The Nimr sludge pits are at about 3.5 km distance from NRPS sludge tank. Transfer of oil from sludge pit to sludge tank at NRPS is by trucks. The number of trucks has recently increased because of the increase in the amount of the oil in the sludge pits due to the increase in the number wells drilled, works over, and tanks cleaning activities. Hence two options studied for better handling of the sludge oil.

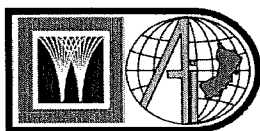Option-1 is using existing system in which oil will be transferred by trucks/tanker however two new pumps to be installed at NRPS instead of existing pump P-48129.

Option-2 is installation of two new pumps at sludge pit and approx 3.5 km 6" line from sludge pits to sludge tank.

After comparison of the two options it is decided by PDO to go with option 2.

The scope is as stated below:

To carry out FEED, Detail Design & Procurement to construct and upgrade the sludge transfer system at NRPS.

Construction activity for this project to be carried out by others.

2.0 EXTENT OF RESPONSIBILITY

The Scope of Work covers construction activities for **Civil, Mechanical, Electrical, Pipelines & Instrumentation**. Pre-commissioning and Commissioning assistance, in accordance with the enclosed drawings, specifications and requirements laid down in the contract. The Scope of Work as a minimum, shall include, but is not limited to the following:

The following sections describe the overall scope only and the actual extent of work shall be as given in the attached demolition and construction drawings. The Contractor shall review the documents and check and confirm with the Company if there are any discrepancies or ambiguities before proceeding with work.

Document Control Index for Process, Civil, Mechanical, Electrical and Control & Automation works are included in Appendix-1. For information and to assist the Contractor, drawings have been referenced throughout this Scope of Work as appropriate to the various areas of work described. While every effort has been made to ensure that these reference listings are complete, it must be realized that the full scope is defined by the attached drawings and not solely those that have been referenced herein the text.

3.0 CIVIL

3.1 General

The Contractor's scope of work involves in the following areas:

- Nimr Sludge pit area



- Nimr Production station area
- Off-plot area

Various civil & structural activities involved in the above areas are as follows:

Nimr Sludge Pit area

- Modification / installation of existing fence and new gates
- Installation of new bench mark & wind sock
- Fabrication and installation of all structural steel components necessary for pipe supports, Valve operating platforms & cross overs
- Construction of foundations for pipe supports, sleepers, platforms & Cross overs
- Construction of RCC drain pits
- Construction of flange pits and collection pits
- Construction of spill pit and hard stand for pig launcher
- Update / preparation of necessary construction drawings based on final Vendor data
- Necessary Earth work excavation and backfilling for foundations, trenches
- Necessary checking at site for any discrepancies for the work involved before starting the work

Nimr Production Station area

- Fabrication and installation of all structural steel components necessary for pipe supports, Valve operating platforms & cross overs
- Construction of foundations for pipe supports, sleepers, platforms & Cross overs
- Construction of RCC drain pits
- Construction of flange pits and collection pits
- Construction of spill pit and hard stand for pig launcher
- Update / preparation of necessary construction drawings based on final Vendor data
- Necessary Earth work excavation and backfilling for foundations, trenches
- Necessary checking at site for any discrepancies for the work involved before starting the work

Off-plot area

- Construction of new culverts including earth filling
- Necessary Earth work excavation and backfilling for foundations
- Necessary checking at site for any discrepancies for the work involved before starting the work

3.2 Construction Drawings update

Construction drawings were prepared based without Vendor information. Based on final information, any update or new drawings needs to be prepared, it shall be done by the Contractor.

All engineering work shall be done as per PDO SP requirements.

3.3 Structural Steel Works

All structural steel for pipe supports, platforms, ladders & cross over shall be fabricated in fabrication yard. Fabrication shall be done as shown in the construction drawings listed in Appendix.

Handrail shall be provided as per drawing for all platforms. For typical grating and hand railing details, refer to drawings listed in Appendix.

All pipe supports structural members shall be as per details shown on drawings given in Appendix.



Prior to fabrication, contractor shall check at site for any discrepancies and make necessary modifications to suite site conditions.

All Structural steel fabrication and erection shall be carried out as per SP-1279 Section G. Corrosion protection shall be as specified in SP-1246.

3.4 Concrete Works for pipe supports, platforms, crossovers and sleepers

All foundations for platforms, pipe supports, crossovers and sleepers shall be constructed as per the drawings. For location of foundations and sleepers, refer foundation location plan drawings. If in-situ casting of concrete foundations proves economical, then they can be cast in-situ, however loading of pipes on supports shall be allowed only after the concrete is fully cured.

All foundation works shall be protected with protective coating as indicated in the drawings. The protective membrane shall be with Fosroc 'Nitocote PE 135' in 2 coats with glass mat or equivalent on bottom and sides of foundations.

The foundations are located within the existing facility. Hence before constructing the foundations, required space & under ground clearance for the foundation at site to be verified by the Construction Contractor.

Contractor to check and ascertain under ground cables. All earthing cables, if any, shall be suitably re-routed to install foundations.

All earthworks necessary for the installation of foundations and sleepers are deemed to be included in this scope of work.

All concrete works shall be carried out strictly in accordance with SP-1279 Section D.

All earth works shall be carried out as per SP-1279 Section C.

3.5 Drain Pit

Concrete drain pit, flange pit & collection pit shall be constructed as per drawings listed in Appendix. Outside surface of pit shall be protected with 2 coats of Fosroc's 'Nitocote PE 135' with glass mat or equivalent. Suitable manhole cover, for accessing the pit, shall be provided.

Excavation, backfilling & compaction required for construction of pit shall also form a part of this scope.

All concrete works shall be carried out strictly in accordance with SP-1279 Section D.

All earth works shall be carried out as per SP-1279 Section C.

3.6 Flange pit and collection pit

Flange pit wall shall be constructed with concrete hollow block work and base concrete slab with mesh reinforcement. The collection pit wall shall be constructed with solid concrete block work and base concrete slab. Outside surfaces of pits shall be protected with 2 coats of Fosroc's 'Nitocote PE 135' with glass mat or equivalent. For details, refer drawings listed in Appendix.

3.7 Spill pit and hard strand for Launcher / Receiver

The spill pit and hard stand is provided to contain the spillage expected during the pigging operation. Outside surface of pit shall be protected with 2 coats of Fosroc's 'Nitocote PE 135' with glass mat or equivalent. The pit shall be constructed as per the details shown on the drawings listed in Appendix.



3.8 Culverts

In the off-plot area, new concrete culverts are provided to facilitate new pipe crosses the existing road and to protect existing pipelines. Contractor shall verify the existing buried pipeline top elevation, prior to construction. Before starting the construction of culvert, required space & under ground clearance for the foundation at site shall be verified by the Construction Contractor. Due to culvert installation, existing roads shall be modified as shown in the construction drawings.

All concrete works shall be carried out strictly in accordance with SP-1279 Section D.

All earth works shall be carried out as per SP-1279 Section C.

3.9 Excavation and Backfilling

Earthwork required for the construction of foundations, pits and grade slab shall be carried out and blinding concrete laid to level for the construction works. Care shall be taken not to damage any underground pipes and cables. After the completion of foundations including curing, the sides shall be back filled and compacted. All earth works shall be carried out as per SP-1279 section C.

Prior to the excavation for foundations, Contractor to check the under ground cables with cable detectors and the same shall be protected during the construction.

4.0 MECHANICAL

4.1 General

All the Mechanical work shall be carried out in accordance with the relevant drawings listed under Appendix-1 of this document & relevant Company standards such as Shell DEPs, PDO SPs / ERDs, standard drawings listed elsewhere in this document

The Mechanical / piping Scope of Work shall include, but not be limited to the following:

4.2 Piping

The Piping Scope of Work shall include, but not be limited to the following:

The Demolition and Construction scope of work shall be carried out in accordance with the Piping G.A drawings, Isometric drawings and Tie-in-schedule (Refer under this attached **Document control index**).

The contractor shall ensure that the following activities carried out during the work:

- a) **Piping spool fabrication shall be started only after field verification of actual dimensions with the isometrics and piping General Arrangement drawings provided and checking site conditions.**
- b) Piping material to be re-used shall be identified and shifted to the contractor store.
- c) The contractor shall complete testing, coating and painting of piping spools and keep ready with proper identification/ mark up for erection at the time of shut down.
- d) Ensure the positive isolation / Blinding of the process piping before and after demolition of piping.
- e) Locations of supports are to be as per piping General Arrangement drawings provided.

The mechanical work shall include, but not be limited to, the following:

- Demolition of existing piping, wherever specified.



- Pre-fabrication and Installation of piping.
- Non-destructive testing of piping.
- Coating and Painting.
- Flushing and hydrostatic testing.
- Bolting and torquing

For all the specifications, codes and standards indicated in this section, latest editions shall be followed. For all the drawings, latest revisions of NIMR Production station (NRPS), Piping demolition drawings, GA drawings and Isometric drawings shall be followed.

4.3 Pre-Fabrication and Installation of Piping

The Contractor's scope of work includes the following activities of on-plot piping inside NIMR Production Station (NRPS) that needs to be carried out during Shut down.

- Pre-Fabrication and supply in accordance with the drawings listed in Document Control Index attached with Appendix-1 and standards listed in Section 11.
- Testing of the spools.
- Installation of spools as indicated in the above drawings.
- Provision of temporary supports, if any applicable for Long Spools or Short spools shall be provided wherever necessary.

4.4 Tie-in schedule

Tie-in of the existing lines and the new flanged spool pipes shall be done as per drawings PEFS, Construction piping Plans, Isometric drawings and tie-in schedule.

4.5 Non Destructive Testing of Piping

Prefabrication, welding and NDT of spools shall be carried out in accordance with PDO SP-1173 and SP-1176. Non-destructive examination shall be carried out in accordance with SP-1176.

4.6 Coating & Painting of Piping

External Painting and internal coating shall be carried out in accordance with SP-1246 (part 1 to part 5).

4.7 Bolt Torquing and tensioning

Bolt torquing and tensioning shall be carried out in accordance with SP-2020. When the bolt tightening procedure is completed, to prevent corrosion a liberal coating of grease should be applied to the nuts up to the back of the flange, and to the stud ends protruding from the nuts. Bolt Tension Certificate (Appendix 8) to be prepared and included in final test pack.

4.8 Flushing & Hydro Testing of Piping

The Design Pressure of the piping scope of work is 9550 Kpa (g) at 82°C. The Design Temperature is 5°C (Lower) and 60°C (Upper).

Hydro testing of the piping shall be carried out in accordance with SP-2051.

After Flushing, a preliminary leak testing (Nitrogen/Pneumatic) shall be carried out at a very low pressure (less than 200 kPa) for gross leak identification prior to a hydrostatic test in accordance with Section 5.2.5 of SP-2051, if required.

All piping shall be pressure tested in accordance with SP-2051, Section 5.0, to the pressure indicated on the isometric.



All equipment, consumables and fittings required for flushing and testing, including test medium shall be supplied by the Contractor. At the end of hydro testing, the Contractor shall make sure that the new pipe work is free of water and the water is disposed in an environmentally friendly way without spillage.

The Contractor shall supply temporary gaskets for testing the piping. High point vents and low point drains are already shown in the isometric drawings. However the Contractor shall review the same and if any additional vents and drains are required based on the Contractor's testing program, they shall be included in the Contractor's scope, including the supply of required material.

The quality of test water shall be in accordance with Appendix A of SP-2051. The Company's approval will be required for using any other test medium.

4.9 Leak Testing

A Nitrogen leak test shall be carried out at a design pressure followed with Bubble test, in accordance with SP-2051.

5.0 ELECTRICAL

5.1 GENERAL

Electrical scope of work includes the following activities in accordance with the details indicated in the drawings. All materials required to complete the work as indicated in MTO shall be supplied by WPAI. However the materials which are not identified specifically but required for satisfactory completion of these activities are deemed to be included in the scope.

- Provide power supply to LV Distribution board G-6951 located in sludge pit area.
- Provide power supply to new sludge oil Transfer pump P-48357/48358, 48359/48360 and flow meters.
- Provide lighting and small power requirement for the new pump shed etc.
- Provide power supply to flood lights.
- LV Cable laying & terminations
- Earthing and bonding system of the entire new installations.

Contractor shall take necessary precautions while carrying out the construction, since the new equipment are to be installed in the existing 'live' facilities. Contractor should follow the permit to work (PTW) system.

Competent Electrical Person (CEP) & Senior Authorised Electrical Person (SAEP) should be made available by the contractor.

5.2 EQUIPMENT INSTALLATION:

- Installation, testing & Pre-commissioning of the following ,company procured equipment to feed power supply to LV distribution board ,sludge transfer pump and dosing pump (The contractor shall provide installation materials required for the new equipment).
 - Installation of 415V Junction box 48-JB-001, Refer drg. NIM-4-6411-001.
 - 415V LV Distribution Board. Refer drg. NIM-4-6411-001.
 - Sludge oil Transfer pump motors P-48357/48358, Oxygen scavenger dosing pump P-48359/48360, Refer drg. NIM-4-6411-001& NIM-4-6416-003.
 - Installation of flood light poles. Refer drg. NIM-4-6416-003 & NIM-4-6412-001 DQ.



5.3 CABLE LAYING & TERMINATIONS

Laying & Termination of LV power & control cables through underground cable trenches between existing feeder pillar substation MDB-1 & New LV distribution board as detailed in cable trench layout & section drawings NIM-4-6416-001, NIM-4-6416-002 & NIM-4-6416-003. Refer civil construction scope of work for excavation & back filling of cable trenches. The materials required for cable installation in the underground trench shall be supplied and installed in accordance with the Company standard drawings. Existing cable route shall be identified and pipe sleeves at road crossings for the new cables shall be provided.

Cable rising from underground trench to the panels shall be installed by providing required cable support. These cables shall be protected by PVC pipes. The terminations shall be carried out with cable termination kits, reference shall be made to the equipment terminal details in the equipment vendor drawings for the requirement of lugs.

Contractor shall check the drum length of the cables and supply if any cable joint required for the new cables. Cable loop shall be provided at the cable straight through joint (5m loop). Loop shall be provided within the trench. Concrete cable markers shall be supplied & installed by contractor along with the cable trenches in accordance with PDO standard drawing STD-4-0106-001.

The complete approval procedure for cable jointers and terminators used on this project including all testing and certification shall be in accordance with the Company standards and procedures as per specification SP-1099.

Contractor shall follow cable route & section drawings for identification of no. of cables running through each section of the cable trenches. Laying and termination of cables include the following:

- LV cables from LV switchboard MDB-1, located in the existing feeder pillar Substation-5 to new LV distribution board G-6951. Refer NIM-4-6411-001.
- LV cables from LV distribution board G-6951 to Sludge oil Transfer pump motors P-48357/48358, Oxygen scavenger dosing pump P-48359/48360, Refer drg. NIM-4-6411-001& NIM-4-6416-003.
- LV cables from LV distribution board G-6951 to pump shed lighting, pump shed socket outlet for auxiliary.
- Laying of 4Cx10sq.mm. XLPE/SWA/PVC cable for flood lighting through underground cable trench between LV distribution board G-6951 to lighting junction boxes and further cabling to fixtures Refer drg. NIM-4-6416-003 & NIM-4-6412-001 DQ
- The cables shall be laid directly buried in the underground trench as indicated in cable routing/cable trench/cable tray layout drawings.
- Refer cable schedule drawing no. NIM-4-6413-001-DQ for LV Power cable terminations and for control cable terminations refer control wiring diagrams NIM-4-6420-001-DQ & NIM-4-6421-001-DQ. Contractor shall provide additional wiring within the panels as indicated in the interconnection drawings to carryout minor wiring modification required for the project.

5.4 EARTHING

Earthing and bonding system of the entire new installations including supply and installation of new earth pit, earth busbar, interconnection of new equipment with earth grid, new earthing ring, interconnection of new earthing ring with existing earth grid, etc. as per company std drawings and as detailed in earthing layout drawings NIM-4-6418-001-DQ. The contractor shall refer the equipment vendor drawings while terminating the earthing conductors. The scope also includes earthing of supporting steel structures at various locations as per PDO Specification SP-1109. The contractor shall supply all the necessary hardware required for the earthing installation.



Where the screens of the cables are used for earthing, these shall be sleeved with green/yellow PVC sleeves, the supply of the same and other earthing accessories which are not listed in the MTO is included in the contractor's scope.

5.5 LV SWITCHBOARD COMPONENTS

Existing spare feeders available in the LV switchboard MDB-1 shall be used to provide power supply for the new LV distribution board. The contractor shall install Loose electrical components (supplied as project materials) in the existing spare feeder of LV switchboards with required name plate tags as indicated in the single line diagrams and subsequently testing of the complete draw out shall be carried out.

5.6 WINPCS

WinPCS package is prepared for this project. Contractor shall include for completion of data required for WinPCS, under their scope of work.

Contractor to comply with PDO Procedure PR-1169 Initial Start Up Procedure, where relevant to the scope of work, the key elements as highlighted below, but not limited to the following:-

Windows based Project Completion and Certification System, i.e. WinPCS, is mandatory for all PDO construction/commissioning contracts. As such, it is to be used also for this project. WinPCS is used to control and monitor the mechanical completion, pre-commissioning, commissioning and hand-over of this project against the components introduced (or modified) in the design phase by the Design Consultant. It improves and maintains the quality, consistency and completeness of construction, pre-commissioning and commissioning. It also facilitates consistent progress monitoring and reporting from construction to commissioning, and provides a tool for the communication and management of engineering queries and punch-list items. Implementation of this WinPCS shall be in line with PR-1561 WinPCS Procedure.

Each component/item is assigned the required, WinPCS generated, mechanical completion and commission check sheets is issued to construction contractor as separate document.

Commissioning plan which follows the Index in Appendix 1 of PR-1169, with the necessary input from production support team and site commissioning engineer, is issued separately. Prior to start of construction, the Project Engineer shall coordinate the refinement of the commissioning plan to include step-by-step commissioning procedures. Each component/item identified shall be installed and commissioned as per the relevant PDO/project standards and specifications and verified against the applicable WinPCS check sheets.

Throughout the construction, pre-commissioning and commissioning phases, WinPCS check-sheets shall be completed at site by the construction contractor and/or commissioning engineer, as applicable, and their status shall be entered regularly (at most weekly) into the system by the Contractor's WinPCS coordinator to enable actual progress to be monitored.

A structured and sequential handover from each phase to the next, using WinPCS generated checksheets and handover certificates, in line with Section 2.4 of PR-1169, shall be carried out as follows:-

Prior to Pre-commissioning activities the Construction Co-ordinator with the discipline engineers should ensure that the construction check sheets and construction handover certificates have all been completed and their status updated in the WinPCS database by the Contractor.

Prior to Commissioning activities commencing, the Commissioning Engineer with the discipline engineers should ensure that the pre-commissioning check sheets and handover certificates have all been completed and their status updated in the WinPCS database by the Contractor.

Prior to system handover to operations, the Commissioning Engineer shall coordinate with both the Construction Coordinator and Project Engineer to ensure that the system acceptance certificate and associated system exception list are compiled and signed by Delivery Team Leader.

Construction, commissioning and final handover certificates will be generated through WinPCS and will be available from the WinPCS coordinator/construction supervisor/commissioning engineer on completion/acceptance of all 'A' punch list items and the required WinPCS check sheets. Punch or exception list items fall into two categories, as follows:-



A category : Items that must be completed before handover can proceed

B category: Items that will not affect the safe progression of commissioning activities but shall be completed before Full Acceptance

5.7 PRE-COMMISSIONING & TESTING

The contractor's scope includes testing, pre-commissioning and assistance during commissioning for the modified plant sections. The contractor shall test and pre-commission the complete installation in accordance with the requirements of Company Specifications.

The contractor shall be responsible for maintaining complete documentation of all tests carried out and these shall be submitted to the Company upon completion of pre-commissioning activities. The Company Site Representative shall approve the format for the test packages.

The contractor shall ensure that all the work carried out by him is free from defects. The contractor shall rectify any defects found during testing and commissioning immediately.

5.8 TIE-IN AND SHUTDOWN REQUIREMENTS

The construction contractor shall follow/maintain his schedule in accordance with the planned shutdown of the facilities. The contractor shall liaise with Company construction supervisor for shutdown requirement.

The contractor shall submit a detailed construction/demolition procedure to Company Site Representative for approval from Company 'Operations' Group.

5.9 MATERIALS

5.10 PROJECT MATERIALS

WPAI procured materials as per the drawing control index NIM-1-2635-400-DQ, Appendix-1.

Other materials which are not listed above but are required for the completion of the Work in accordance with the specifications and drawings (inclusive of consumable) are to be procured separately by site intend as per the contract norms.

All materials shall be in accordance with the Company standards and specifications. Where material in accordance with Company standards and specifications is not available, the contractor shall propose equivalent alternatives for Company approval.

5.11 REMOVED MATERIALS

All the removed materials shall remain the property of the Company and the contractor shall not use these materials under any circumstances. The contractor shall remove, load and transport the redundant materials, from the work site to Company designated stores in accordance with the instructions of the Company Site Representative.

5.12 DRAWINGS AND DOCUMENTATION

5.13 CONSTRUCTION DRAWINGS

The Work shall be carried out in accordance with referred standard drawings and the construction drawings listed under Document Control Index as Appendix-1. This includes vendor packages listed separately as Appendix-2.

Any detail of work not indicated in the drawings but obviously necessary for a good and proper workman-like construction shall be deemed to be part of the Work and as such shall be included in the contractor's Scope of work. The contractor shall notify the Contractor of such discrepancies or any other ambiguity, prior to the start of fabrication/construction to allow the Contractor to detail and specify requirements.



5.14 AS-BUILT DRAWINGS

The contractor Scope of Work includes provision to the Contractor of two sets of marked up "As-Built" prints. These prints shall be submitted for Company approval one week after the completion date. Any subsequent modifications shall be marked separately.

5.15 CODES AND STANDARDS

The contractor shall execute the work in accordance with Company codes and standards. The order of precedence shall be as follows:

- Decrees and Laws of the Sultanate of Oman.
- Specifications (SPs)
- SIPM Design and Engineering Practices (DEPs).
- International Standards.
- Vendor Procedures.

Where conflicts arise within codes and standards, the contractor shall seek a ruling from the Company through the Company Site Representative.

No deviation from codes and standards will be permitted without prior written approval from the Company.

The Codes and Standards listed below are deemed to be the most relevant.

6.0 CONTROL & AUTOMATION

The Instrumentation scope of work includes installation, calibration, testing, loop checking and pre-commissioning of complete instrumentation system as required for the completion of On-Plot Header Replacement Project.

The Scope of Work covers construction activities for Control & Automation works in accordance with the approved drawings, specifications and requirements laid down in the EM contract C31/0606. The Scope of Work as a minimum, shall include, but is not limited to the following:

- Calibration, Fabrication & Instrument installation.
- Field Multicore and Branch Cable Laying
- Continuity & Loop Check
- Supply of all equipment, tools and tackles for fabrication and construction
- All C&A works in the Control Room as per requirements of this project based on the Approved for Construction Drawings/documents.
- Preparation of as-built (red line) mark-ups.
- Loop Check Support
- Pre-commissioning
- Commissioning Assistance

The following sections describe the overall scope only and the actual extent of work shall be as per the construction drawings listed in document control index attached as Appendix-1.

Document Control Index (DCI) or Master Document Index (MDI) for C&A works is included in this document for reference as Appendix 1 and the MTO for reference is attached as Appendix-II. DCI is a



dynamic list and is subject to change. All construction drawing are issued to site for construction. Revision numbers, wherever shown, against Drawings and documents in this document need not be the latest. Refer Latest Revisions of drawings and documents and DCI.

While executing, in case of any doubt, technical queries shall be raised to coast engineering department.

7.0 PRE-COMMISSIONING & TESTING

The Contractor's scope includes testing, pre-commissioning and assistance during commissioning for the modified plant sections. The Contractor shall test and pre-commission the complete installation in accordance with the requirements of Company Specifications SP-2051 and DEP 62.10.08.11, Nov 03 (Inspection & Functional testing of Instrument)

The Contractor shall be responsible for maintaining complete documentation of all tests carried out and these shall be submitted to the Company upon completion of pre-commissioning activities. The Company Site Representative shall approve the format for the test packages.

The Contractor shall ensure that all the work carried out by him is free from defects. Contractor shall rectify any defects found during testing and commissioning immediately.

8.0 DRAWINGS AND DOCUMENTATION

8.1 Construction Drawings

The Work shall be carried out in accordance with referred standard drawings and the construction drawings listed under Document Control Index as Appendix-1.

Any detail of work not indicated in the drawings but obviously necessary for a good and proper workman-like construction shall be deemed to be part of the Work and as such shall be included in the Contractor's Scope of work. The Contractor shall notify the Company of such discrepancies or any other ambiguity, prior to the start of fabrication/construction to allow the Company to detail and specify requirements.

8.2 As-Built Drawings

The Contractor Scope of Work includes provision to the Company of two sets of marked up "As-Built" prints. These prints shall be submitted for Company approval one week after the completion date before commissioning. Any subsequent modifications shall be marked separately. All the As-built drawings shall be Auto CAD & submitted as per company procedure. WinPcs update shall be done on daily basis during precommissioning and commissioning.

9.0 CODES AND STANDARDS

The Contractor shall execute the work in accordance with Company codes and standards. The order of precedence shall be as follows:

- Decrees and Laws of the Sultanate of Oman.
- PDO Engineering Reference Documents (ERDs), Specifications (SPs)
- SIPM Design and Engineering Practices (DEPs).
- International Standards.
- Vendor Procedures.

Where conflicts arise within codes and standards, the Contractor shall seek a ruling from the Company through the Company Site Representative.

No deviation from codes and standards will be permitted without prior written approval from the Company.



The Codes and Standards listed below are deemed to be the most relevant for respective disciplines.

9.1 Control & Automation

DEP62.10.08.11 GEN Inspection & Functional Testing of Instruments.

DEP62.37.10.12 GEN Instrument Installation Procedure.

DEP32.37.00.33 PDO Mounting Of Plant Instruments.

9.2 Mechanical Engineering:

PDO-ERD-26-02 Construction specification for Oil, Gas and utility Facilities

ERD-43-15 (Nov '98 Specification of Polyethylene Liners in Carbon Steel Flow lines and Pipelines.

SP-1166 Specification For Identification Of On-Plot Pipe Work.

SP-1171 Specification for Quality Assurance of Design, Construction and Engineering Works.

SP-1173 Specification for welding of on-plot CRA pipe work (Amendments/Supplements to ASME B31.3)

SP-1176 Non Destructive Examination (Amendments / Supplements to ASME BPV Section V).

SP-1187 Application and Selection of Standard Pipe Supports

SP-1239 Specification for Lifting Equipment and Lifting Operations.

SP – 1246 (Part 1 to 5) Specification for Painting and coating for Oil & Gas Production facilities

SP-2020 Specification for Flange connections: Bolt Torquing and Tensioning.

SP-2051 Specification for flushing, pressure testing, pickling, sensitive leak testing of mechanical equipment & Piping.

PR-1272 Standard welding procedure qualification records for on-plot pipe work.

DEP 31.38.01.31 Shop and Field Fabrication of Piping.

DEP 31.38.01.15 Piping Classes – Exploration and Production

9.3 Civil Engineering

PDO STANDARDS	
GU-628	Guide to civil & Buildings standard drawings
GU-629	Guidelines for Application and Selection of Standard Pipe Supports
GU-631	Guide line for Sunshade – Spec, Design requirement & Std. dwgs.



<u>SP-1187</u>	<u>Specification for Application and Selection of Standard Pipe Supports</u>
<u>SP-1275</u>	<u>Specification & criteria for Design of Civil & Building works</u>
<u>SP-1281</u>	<u>Engineering Specification for Road works</u>
<u>SP-1284</u>	<u>Specification for Sign & Sign boards – Standard sign catalogue</u>
<u>SP-1297</u>	<u>Specification for Civil & Building Construction- Excavation & Earthworks</u>
SHELL GROUP STANDARDS	
DEP 34.00.01.30	Structural Design & Engineering
DEP 34.13.20.31	Road paving, surfacing, slope protection & Fencing
DEP 34.19.20.31	Reinforced Concrete Structures
DEP 34.28.00.31	Steel Structures
INTERNATIONAL CODES & STANDARDS	
BS 5950	Structural Use of Steel Work in Building
BS 8110	Structural Use of Concrete

ELECTRICAL ENGINEERING Standards and Specifications :

PDO-SP-1099	Electrical Installation Practice
PDO-SP-1103	Electrical Engineering Guidelines Amends/Supplement to DEP 33.64.10.10
PDO-SP-1104	Electrical Safety Rules
PDO-SP-1105	Electrical Standard Drawings list
PDO-SP-1107	Electrical Protection systems
PDO-SP-1108	Electrical Safety Operation Procedures
PDO-SP-1109	Specification for Earthing and bonding.
PDO-SP-1100	Specification for Testing & Commissioning of Electrical Equipment
PDO-SP-1171	Specification for Quality assurance of Design, Construction and Engineering works
DEP 33.64.10.10	Electrical Engineering Guidelines

DEP 63.10.08.11 Field Commissioning & Maintenance of
Electrical Installations & Equipment.



APPENDIX - 1

DOCUMENT CONTROL INDEX

Control & Automation

Item#	Document No	Description	Rev#
1	NIM-5-4736-DQ	Cable Block Diagram	A
2	NIM-5-4737-DQ	MTO for Installation Items	A
3	NIM-5-4738-DQ	Instrument Impulse lines & Electropneumatic Hook-Up.	A
4	NIM-5-4739-DQ	Instrument Name Plate	A
5	NIM-5-4740-001-DQ	Instrument Location Layout	A
6	NIM-5-4741-001-DQ	Trenches of Instrument Cables	A
7	NIM-5-4742-DQ	ICTD Junction Box	A
8	NIM-5-4743-DQ	Instrument Eng. Data Sheets	A
9	NIM-5-4744-DQ	Trip & Alarm Settings	A
10	NIM-5-4745-001-DQ	Instrument loop Diagram	0
11	NIM-5-5001-001-DQ	Trenches of Instrument Cables	A
12	NIM-5-5005-001	Cause & Effect Diagrams	B
13	NIM-5-5005-002	Cause & Effect Diagrams	A
14	NIM-5-5005-007	Cause & Effect Diagrams	A
15	NIM-5-5014-001-DQ	Instrument Location Layout	A
16	NIM-5-5015-001-DQ	Instrument Location Layout	A
17	NIM-5-5016-001-DQ	Instrument Location Layout	A
18	NIM-5-5016-002-DQ	Instrument Location Layout	A
19	NIM-5-5043-DQ	ICTD Junction Box	A
20	NIM-5-5044-DQ	Inst. Cable Schedule	A
21	NIM-5-5047-001-DQ	Control Room Equipment Layout	A
22	NIM-5-5065-DQ	Trip & Alarm Settings	A
23	NIM-5-5271-DQ	Instrument Eng. Data Sheets	A
24	NIM-5-5588-DQ	SGS Functional Logic Diagram	0
25	NIM-5-5589-DQ	ICTD Signal Distribution Cabinet	A
26	NIM-5-5591-DQ	ICTD System Cable	A
27	NIM-5-5594-DQ	DCS loop Diagram	A
28	NIM-5-5596-DQ	SGS loop Diagram	A
29	NIM-5-6079-DQ	DCS Functional Logic Diagram	0



30	NIM-5-6531-DQ	Functional Logic Diagram-Sludge Pit	0
31	PAIP00405/IO/5001	Instrument I/O List	A

ELECTRICAL

Item#	Document No	Description	Rev#
1	NIM-4-2801-DQ	415V SLD main distribution board, MDB-1	B
2	NIM-4-2815-002-DQ	SLD OF MDB-1	A
3	NIM-4-2817-001-DQ	Cable layout and DB location	A
4	NIM-4-6411-001-DQ	415V SLD PDB	B
5	NIM-4-6412-001-DQ	Schematic lighting diagram	B
6	NIM-4-6413-001-DQ	LV Cable schedule cover sheet	B
7	NIM-4-6413-002-DQ	LV Cable schedule Index sheet	B
8	NIM-4-6413-003-DQ	LV Cable schedule	B
9	NIM-4-6415-001-DQ	Overall cable route layout	A
10	NIM-4-6415-002-DQ	Cable route layout at sludge pit area	A
11	NIM-4-6416-001-DQ	Overall cable trench layout	A
12	NIM-4-6416-002-DQ	Cable trench layout SWTP	A
13	NIM-4-6416-003-DQ	Cable trench layout at sludge pit area	A
14	NIM-4-6417-001-DQ	Cable trench layout sections	A
15	NIM-4-6418-001-DQ	Earthing layout at sludge pit area	A
16	NIM-4-6420-001-DQ	Electrical control diagram LV motor above 5.5Kw.	A
17	NIM-4-6421-001-DQ	Electrical control diagram LV motor below 5.5Kw.	A
31	PAIP00405/MTO/401	Electrical bulk MTO	B



APPENDIX – 2

MATERIALS LIST



PAIP00405- Nimr Sludge Pit Up gradation

MTO- Electrical

The preliminary material take off (MTO), Bill of Quantities (BOQ) and quantity in BOQ or MTO provided with tender package shall not be considered for cost estimation. The MTO and BOQ provided with tender do not necessarily contain all the items or material required to complete the scope. The preliminary material take off (MTO), Bill of Quantities (BOQ) and quantity in BOQ or MTO provided with tender package are prepared prior to freezing the design and are preliminary.

approval shall be taken from Design Engineer prior to bidding, order placement and manufacturing.

Serial Number	Type	SAP #	MESC #	WPAI Spec #	AVME #	Description	UOM	Total Quantity	Rev #	Additional Qty. to be Procured	Remarks
	Power DB					415V, 125A, 3Ph+N, 50Hz, 10kA for 1 Sec. Outdoor Distribution Board	Each	1	Rev. A		PAIP00405/RQ/401
1	Cable: LV	1000047762	68.44.14.459.1		4.15.1	LV Cable: 4Cx240 sq.mm, 600/1000V, XLPE/SWA/PVC Copper cable	Metre	1800	Rev. A		500mts/Drum size
2	Cable: LV	1000395309	--		4.15.1	LV Cable: 4Cx50 sq.mm, 600/1000V, XLPE/SWA/PVC Copper cable	Metre	50	Rev. A		
3	Cable: LV	1000047742	68.44.14.331.1		4.15.1	LV Cable: 3Cx16 sq.mm, 600/1000V, XLPE/SWA/PVC Copper cable	Metre	350	Rev. A		
4	Cable: LV	1000047741	68.44.14.309.1		4.15.1	LV Cable: 3Cx10 sq.mm, 600/1000V, XLPE/SWA/PVC Copper cable	Metre	1400	Rev. A	Cable shall be supplied in two lengths (700 mts) only.	
5	Cable: LV	1000047740	68.44.14.307.1		4.15.1	LV Cable: 3Cx6 sq.mm, 600/1000V, XLPE/SWA/PVC Copper cable	Metre	150	Rev. A		
6	Cable: LV	1000395303	--		4.15.1	LV Cable: 2Cx10 sq.mm, 600/1000V, Flexible PVC Copper cable	Metre	50	Rev. A		
7	Cable: LV	1000047735	68.44.14.201.9		4.15.1	LV Cable: 2Cx6 sq.mm, 600/1000V, XLPE/SWA/PVC Copper cable	Metre	300	Rev. A		
8	Cable: LV	1000047763	68.44.14.703.1		4.15.1	LV Cable: 7Cx2.5 sq.mm, 600/1000V, XLPE/SWA/PVC Copper cable	Metre	600	Rev. A		
9	Cable: LV	1000047751	68.44.14.403.1		4.15.1	LV Cable: 4Cx2.5 sq.mm, 600/1000V, XLPE/SWA/PVC Copper cable	Metre	300	Rev. A		
10	Cable: LV	1000047738	68.44.14.303.1		4.15.1	LV Cable: 3Cx2.5 sq.mm, 600/1000V, XLPE/SWA/PVC Copper cable	Metre	100	Rev. A		
11	Cable Joint	1000754004	--		4.16.1	Cable Jointing Kit suitable for 4Cx240 sq.mm, 600/1000V, XLPE/SWA/PVC Copper cable	Each	8	Rev. A		
12	Cable Gland	1000048326	68.80.58.744.1		4.16.5	Cable Gland suitable for 4CX240 sq.mm Cable (M75)	Each	3	Rev. A		
13	Cable Gland	1000048322	68.80.58.736.1		4.16.5	Cable Gland suitable for 4Cx50 sq.mm Cable (M32)	Each	3	Rev. A		
14	Cable Gland	1000048321	68.80.58.734.1		4.16.5	Cable Gland suitable for 3Cx16 sq.mm Cable (M25)	Each	6	Rev. A		
15	Cable Gland	1000048321	68.80.58.734.1		4.16.5	Cable Gland suitable for 3Cx10 sq.mm Cable (M25)	Each	20	Rev. A		
16	Cable Gland	1000048320	68.80.58.732.1		4.16.5	Cable Gland suitable for 3Cx6 sq.mm Cable (M20)	Each	10	Rev. A		
17	Cable Gland	1000048320	68.80.58.732.1		4.16.5	Cable Gland suitable for 2Cx10 sq.mm Cable (M20)	Each	4	Rev. A		
18	Cable Gland	1000048320	68.80.58.732.1		4.16.5	Cable Gland suitable for 2Cx6 sq.mm Cable (M20)	Each	6	Rev. A		
19	Cable Gland	1000048320	68.80.58.732.1		4.16.5	Cable Gland suitable for 7Cx2.5 sq.mm Cable (M20)	Each	10	Rev. A		
20	Cable Gland	1000048320	68.80.58.732.1		4.16.5	Cable Gland suitable for 4Cx2.5 sq.mm Cable (M20)	Each	20	Rev. A		
21	Cable Gland	1000048320	68.80.58.732.1		4.16.5	Cable Gland suitable for 3Cx2.5 sq.mm Cable (M20)	Each	40	Rev. A		
22	Lock Nut	1000048282	68.80.58.090.9		4.16.5	Lock Nut suitable for M75 Gland	Each	3	Rev. A		
23	Lock Nut	1000048278	68.80.58.076.9		4.16.5	Lock Nut suitable for M32 Gland	Each	3	Rev. A		
24	Lock Nut	1000048277	68.80.58.072.9		4.16.5	Lock Nut suitable for M25 Gland	Each	26	Rev. A		
25	Lock Nut	1000048276	68.80.58.068.9		4.16.5	Lock Nut suitable for M20 Gland	Each	90	Rev. A		

Project Number: PAIP00405
WBS Number: NIM.IN.09.011

WorleyParsons Arabian Industries JV
Material Take Off

Project Title: Nimr Sludge Pit System Upgrade
Disc:Electrical
MTO Rev # :A

Serial Number	Type	SAP #	MESC #	WPAI Spec #	AVME #	Description	UOM	Total Quantity	Rev #	Additional Qty. to be Procured	Remarks
26	PVC Shroud	1000048262	68.80.56.924.9		4.16.5	PVC Shroud type-F suitable for M75 Gland	Each	3	Rev. A		
27	PVC Shroud	1000048258	68.80.56.916.9		4.16.5	PVC Shroud type-C suitable for M32 Gland	Each	3	Rev. A		
28	PVC Shroud	1000048257	68.80.56.914.9		4.16.5	PVC Shroud type-B suitable for M25 Gland	Each	26	Rev. A		
29	PVC Shroud	1000048256	68.80.56.912.9		4.16.5	PVC Shroud type-A suitable for M20 Gland	Each	90	Rev. A		
30	Earth Tag	1000255978	--		4.16.5	Earth Tag suitable for M75 Gland	Each	3	Rev. A		
31	Earth Tag	1000223714	--		4.16.5	Earth Tag suitable for M32 Gland	Each	3	Rev. A		
32	Earth Tag	1000223710	--		4.16.5	Earth Tag suitable for M25 Gland	Each	26	Rev. A		
33	Earth Tag	1000223708	--		4.16.5	Earth Tag suitable for M20 Gland	Each	90	Rev. A		
34	Cable Lug	1000048099	--		4.16.1	Cable Lug suitable for 240 sq.mm Cable	Each	10	Rev. A		
35	Cable Lug	1000048085	--		4.16.1	Cable Lug suitable for 50 sq.mm Cable	Each	10	Rev. A		
36	Cable Lug	1000048084	--		4.16.1	Cable Lug suitable for 16 sq.mm Cable	Each	20	Rev. A		
37	Cable Lug	1000048083	--		4.16.1	Cable Lug suitable for 10 sq.mm Cable	Each	100	Rev. A		
38	Cable Lug	1000048081	--		4.16.1	Cable Lug suitable for 6 sq.mm Cable	Each	40	Rev. A		
39	Cable Lug	1000048080	--		4.16.1	Cable Lug suitable for 2.5 sq.mm Cable	Each	150	Rev. A		
40	Cable Acces.	1000048555	68.85.12.419.1		4.16.1	Electrical Insulation Tape Yellow, 6 Metre/Roll	Roll	20	Rev. A		
41	Cable Acces.	--	--		4.16.1	Pin type terminal blocks & Ferrules	Pkt	A/R	Rev. A		
42	Trench	1000047983	68.76.81.106.9		4.16.3	Underground Cable Tiles size 1000mm x 240mm x 6mm thick	Each	2700	Rev. A		
43	Trench	1000048548	68.85.12.356.9		4.16.3	Underground Warning Tape 150mm width, 365mts/Roll	Metre	2700	Rev. A		
44	Trench	1000048104	68.79.02.006.9		4.16.3	Plain Lead Strip Underground Cable Nos. 19mm x 1.6mm x 300mm Long, 11 Metre/Roll	Roll	10	Rev. A		
45	Trench	1000075844	--		4.16.3	LV Cable Route Marker	Each	25	Rev. A		
46	Trench	1000048205	--		4.16.3	100mm Dia uPVC Pipe	Metre	60	Rev. A		
47	Trench	--	--		4.16.3	150mm Dia uPVC Pipe	Metre	20	Rev. A		
						CABLE MARKER FOR ABOVE GROUND CABLE AS PER (STD-4-0108-001-4-E)					
48	Cable Acces.	1000521146	--		4.16.3	Cable Tie, Black, Nylon, 368 x 3.6mm	Pocket	2	Rev. A		
49	Cable Acces.	1000535192	--		4.16.3	4mm wide Nylon strapping Hellermann TY4-S1	Pocket	2	Rev. A		
50	Cable Acces.	--	--		4.16.3	Arrowtag Hellermann type AT3	Pocket	A/R	Rev. A		
51	Cable Acces.	--	--		4.16.3	Ovalgrip Marker Hellermann type H085	Pocket	A/R	Rev. A		
52	Cable Tray	1000069935	--		4.20.5	75mm wide heavy duty return flange G.I. Cable Tray	Metre	25	Rev. A		
53	Cable Tray	1000069990	--		4.20.5	Ventilated cover for 75mm wide Cable Tray	Metre	25	Rev. A		
54	Cable Tray	1000223944	--		4.20.5	Cable Tie 240mm Length	Pocket	2	Rev. A		
55	Cable Tray	--	--		4.20.5	Nut, Bolt & Clamps for fixing Trays	Each	A/R	Rev. A		
56	Other	--	--		4.20.5	G.I. Trunking 75mm x 75mm	Metre	50	Rev. A		

Serial Number	Type	SAP #	MESC #	WPAI Spec #	AVME #	Description	UOM	Total Quantity	Rev #	Additional Qty. to be Procured	Remarks
57	Other	--	--		4.20.5	20x20 Unistrut G.I. Slot Type / 12 Metre Length	Each	A/R	Rev. A		
58	Other	--	--		4.20.5	M6x30 Bolt (Bolt Head Half Round)	Each	A/R	Rev. A		
59	Other	--	--		4.20.5	M6 Spring Nut	Each	A/R	Rev. A		
60	Other	--	--		4.20.5	M25 PVC Gland	Each	A/R	Rev. A		
61	Earthing	1000047626	68.14.07.382.1		4.17.1	1Cx25 sq.mm Y/G Earth Cable	Metre	200	Rev. A		
62	Earthing	1000047627	68.14.07.392.1		4.17.1	1Cx70 sq.mm Y/G Earth Cable	Metre	2800	Rev. A		
63	Earthing	1000048060	68.78.90.426.1		4.17.1	Branch Connector suitable for 70/70 sq.mm	Each	10	Rev. A		
64	Earthing	1000048059	68.78.90.422.1		4.17.1	Branch Connector suitable for 70/25 sq.mm	Each	20	Rev. A		
65	Earthing	1000780669	--		4.17.1	Earthing Terminal Lugs 1Cx70 sq.mm Cable (Y/G)	Each	10	Rev. A		
66	Earthing	1000780666	--		4.17.1	Earthing Terminal Lugs 1Cx25 sq.mm Cable (Y/G)	Each	20	Rev. A		
67	Earthing	1000047994	68.77.02.126.9		4.17.1	Earth Boss	Each	20	Rev. A		
68	Earthing	1000048555	68.85.12.419.1		4.16.1	Electrical Insulation Tape Yellow, 6 Metre/Roll	Roll	2	Rev. A		
						STEEL EARTH PIT AS PER DRG, (STD-4-0310-001-4-F)					
69	Earthing	1000048666	68.89.20.148.9		4.17.1	Earth Inspection Pit, Steel housing & Cover	Each	8	Rev. A		
70	Earthing	1000707169	--		4.17.1	Extensible earth rod,Dia 15mm x LG 1220mm	Each	104	Rev. A		
71	Earthing	1000707154	--		4.17.1	Coupling screw,p-bz outer thread for 15mm	Each	96	Rev. A		
72	Earthing	1000707153	--		4.17.1	Steel driving cap,hardened ,allow	Each	8	Rev. A		
73	Earthing	1000707170	--		4.17.1	Tips, Hardened steel for 15mm driving tip	Each	8	Rev. A		
74	Earthing	1000047990	68.77.02.078.1		4.17.1	70 sq.mm two way through clamp	Each	8	Rev. A		
75	Earthing	1000048060	68.78.90.426.1		4.17.1	Branch connector 70/70 sq.mm	Each	8	Rev. A		
76	Earthing	1000047627	68.14.07.392.1		4.17.1	1C x 70 sq.mm Y/G Cable	Metre	120	Rev. A		
77	Earthing	--	--		4.17.1	Marconite	Pocket	80	Rev. A		
						EARTHING BUSBAR AS PER DRG, (STD-4-0303-001-4-D)					
78	Earthing	1000045040	67.28.36.188.1		4.17.1	950mm x 50mm x 10mm thick copper bar	Each	3	Rev. A		
79	Earthing	1000062976	81.26.25.112.1		4.17.1	M10 X 100mm Long rawlbolt or equal	Each	6	Rev. A		
80	Earthing	1000062970	81.04.62.188.1		4.17.1	M10 x 40mm Long brass nut and bolt	Each	60	Rev. A		
81	Earthing	--	81.78.06.160.1		4.17.1	M10 Brass washer	Each	60	Rev. A		
82	Earthing	1000524103	74.13.08.026.1		4.17.1	25mm Dia galvanised line pipe	Metre	1.5	Rev. A		
83	Earthing	1000780666	--		4.17.1	Cable Lugs 1Cx25 sq.mm Cable (Y/G)	Each	60	Rev. A		
84	Earthing	1000780669	--		4.17.1	Cable Lugs 1Cx70 sq.mm Cable (Y/G)	Each	6	Rev. A		
						EARTHING DETAILS GATE & FENCE AS PER DRG, (STD-4-0306-001-4-D)					
85	Earthing	1000069880	68.01.23.052.9		4.17.1	Flexible Braid Jumper Burndy Type BG-12	Each	16	Rev. A		
86	Earthing	1000047993	68.77.02.106.9		4.17.1	Burndy Type GK 1826 earth clamp	Each	8	Rev. A		
87	Earthing	1000973324	74.86.05.215.1		4.17.1	25mm Heavy gauge PVC Pipe	Metre	4	Rev. A		
88	Earthing	1000049087	70.32.65.025.1		4.17.1	25mm Saddle	Each	8	Rev. A		
89	Earthing	1000048059	68.78.90.422.1		4.17.1	70/25 sq.mm branch connector	Each	8	Rev. A		

Serial Number	Type	SAP #	MESC #	WPAI Spec #	AVME #	Description	UOM	Total Quantity	Rev #	Additional Qty. to be Procured	Remarks
90	Earthing	1000047626	68.14.07.382.1		4.17.1	1Cx25sq.mm Y/G Earth cable	Metre	24	Rev. A		
91	Earthing	1000047994	68.77.02.126.9		4.17.1	Earth Boss	Each	16	Rev. A		
92	Earthing	1000063796	81.41.17.018.1		4.17.1	M10 Carbon Steel Nut	Each	16	Rev. A		
						EARTHING DETAILS FENCE POST AS PER DRG, (STD-4-0308-001-4-D)		50			
93	Earthing	1000973325	68.77.02.106.1		4.17.1	Burndy Type GK 1826 earth clamp	Each	50	Rev. A		
94	Earthing	1000973324	74.86.05.215.1		4.17.1	25mm Heavy Gauge PVC Pipe	Each	25	Rev. A		
95	Earthing	1000048059	68.78.90.422.1		4.17.1	70/25 sq.mm branch connector	Metre	50	Rev. A		
96	Earthing	1000049087	70.32.65.025.1		4.17.1	25mm Saddle	Each	50	Rev. A		
97	Earthing	1000047626	68.14.07.382.1		4.17.1	1Cx25sq.mm Y/G Earth cable	Each	150	Rev. A		
98	Earthing	1000047994	68.77.02.126.9		4.17.1	Earth Boss	Each	50	Rev. A		
99	Earthing	1000063796	81.41.17.018.1		4.17.1	M10 Carbon Steel Nut	Each	50	Rev. A		
107	Earthing	1000062587	78.39.10.104.1		4.17.1	12mm Round MS Bar	Metre	50	Rev. A		
108	Junction Box	--	--		4.16.6	Electrical Junction Box consists of 8 nos of 240 sq.mm terminal blocks, 8 nos of 50 sq.mm terminal blocks & 1x70 sq.mm + 2x25 sq.mm earth terminal blocks suitable for Hazardous area	Each	1	Rev. A		PAIP00405/RQ/402
109	Junction Box	1000396451	--		4.16.6	Electrical Junction Box consists of 8 nos of 6 sq.mm terminal blocks, 8 nos of 2.5 sq.mm terminal blocks & 1x25 sq.mm + 3x2.5 sq.mm earth terminal blocks suitable for Hazardous area	Each	10	Rev. A		
110	Lighting Pole	1000048607	--		4.19.9	Flood Lighting Pole as Drg. STD-4-0203-001, 10M, Height Stepped Steel pole	Each	8	Rev. A		
111	Lighting Pole		--		4.19.5	Lighting Pole Type-5 as Drg. STD-4-0207-002	Each	2	Rev. A		
112	Lighting	1090000515	--		4.19.9	Flood Light Crossarm for 2-Way flood light bracket as Drg. STD-4-0205-001	Each	8	Rev. A		
113	Lighting	1000326313	69.61..22.250.9		4.19.5	250W Floodlight fitting complete with control gear and p.f improvement capacitor with H.P Sodium vapour lamp	Each	16	Rev. A		
114	Lighting	1090003156	--		4.19.5	2x36W Flourescent Light fittings, EEXe IP-55, normal type, Pole mounted	Each	2	Rev. A		
115	Socket Outlet	1000069601	--		4.11.7	240V 16A 2Pole+PE socket outlet suitable for Hazardous area	Each	1	Rev. A		
116	RCU	1000046062	67.92.61.132.1		4.11.3	Remote control unit 50/1A CT Operated 0-50A Ammeter	Each	2	Rev. A		
117	RCU	1000070070	67.92.61.104.1		4.11.3	Remote control unit 5/1A direct Ammeter 0-5A (RCU shall be suitable for 7Cx2.5 sq.mm Incoming cable & 3Cx2.5 sq.mm Outgoing cable) including 2 nos of M20 glands.	Each	2	Rev. A		
						INSTALLATION MATERIALS FOR RCU AS PER DRG STD-4-0109-001-4-D					
118	Access	1000052011	74086.05.345.9		4.20	50mm Heavy Gauge PVC Pipe	Metre	2	Rev. A		
119	Access	1000052014	74.86.05.570.9		4.20	110mm Heavy Gauge PVC Pipe	Metre	2	Rev. A		
120	Access	1000145612	78.47.31.053.1		4.20	100mm x 50mm x 6mm MS Channel	Metre	8	Rev. A		
121	Access	1000542348	--		4.20	Galvanised Cable Saddle, 20mm DIA	Each	16	Rev. A		
122	Access	1000062976	81.26.25.112.1		4.20	M10 x 100mm Expanding Bolt	Each	8	Rev. A		
123	Access	1000062606	78.43.30.116.1		4.20	6mm MS Plate, size 300mm x 300mm	Each	4	Rev. A		

Project Number: PAIP00405
WBS Number: NIM.IN.09.011

WorleyParsons Arabian Industries JV
Material Take Off

Project Title: Nimr Sludge Pit System Upgrade
Disc:Electrical
MTO Rev # :A

Serial Number	Type	SAP #	MESC #	WPAI Spec #	AVME #	Description	UOM	Total Quantity	Rev #	Additional Qty. to be Procured	Remarks
124	Cathodic Protection		--				Set	10	Rev. A		

PAIP00405- Nimr Sludge Pit Up gradation

MTO- Pipeline



PIPELINE BULK MATERIAL TAKE OFF (MTO) - SUMMARY [FINAL]

WORLEYPARSONS - ARABIAN INDUSTRIES JV

Job/ Project No: PAIP00405 Project Title: NIMR SLUDGE PITS SYSTEMS UPGRADE-FEED/DD Client Ref: C.OM.NIM.IN.09.011 MTO Document No: NIM-3-2134-001-DQ						Location/ Area: NSPS+NRPS PDO Project Code: DQ [For Main project] Scope of MTO : <u>ON-PLOT/OFF-PLOT</u> (Under B31.4 Code Break Limit) MTO Rev No/Date: A / 17-JUL-2011									
SL/ NO.	Material Reqn. & Spec'n (MRS) document Number	SAP / MESC Number	Applicable Piping Class	Line-Item Description	Material with Specification and Grade	Schedule/WT / Rating	Size 1	Size 2	Required Qty.	With Contgy. Qty.	Qty. Ordered before / Qty. In Stock	Qty. to be Ordered [Note-2]	Surpluss(+) Less(-)	Scope of Supply	
1	1000671556	NON-MESC.	300#	PIPE: SOUR, CS, BW, HFW CS, BARE, SHALL BE IN ACCORDANCE WITH DEP 31.40.20.37.GEN., SOUR FOR A/G APPLICATIONS.	ISO 3183-3 Gr. L290	5.6 mm W.T.	150		3090	3650	-	-		By PDO (from Ex-stock)	
2	1000671556	NON MESC	300#	PIPE: SOUR, CS, BW, HFW. CS, BARE, SHALL BE IN ACCORDANCE WITH DEP 31.40.20.37.GEN., SOUR FOR B/G APPLICATIONS.	ISO 3183-3 Gr. L 290	5.6 mm W.T.	150		352	425	-	-		By PDO (from Ex-stock)	
3	PAIP00405/RQ/6002 (L/I#001)	NON-MESC.	300#	BARRED TEE: EQUAL, BW, SOUR, CS, BEVELLED ENDS, TO BE IN ACORD. WITH DEP 31.40.21.30.GEN.& REF. SPEC'N FOR MORE DETAILS.	ISO 15590-2 Gr. L290 (EQUIVALENT TO MSS SP75 WPHY 42)	5.6 mm W.T. (at ends)	150		2	2	-	2	-	By PDO	
4	PAIP00405/RQ/6004 (L/I#001)	NON-MESC.	300#	BRANCH FITTING (BROB): BRANCH OUTLET/WELDOLET, BW, CS, AS PER DEP 31.40.21.30.GEN. & MSS SP 97 AND REF. SPEC'N FOR MORE DETAILS.	ISO 15590-2 Gr. L290 (EQUIVALENT TO MSS SP 75 WPHY 42)	W.T.5.6 x S80 (at ends)	150	50	45	52	-	52	-	By PDO	
5	PAIP00405/RQ/6003 (L/I#001)	NON-MESC.	300#	FLANGE: CL 300#, WNRF, SOUR, FORGED, BARE, SEAL FACE 3.2-6.4 RA, AS PER DEP.31.40.21.34 AND REF. SPEC'N FOR MORE DETAILS.	ISO 15590-3 Gr. L290 (EQUIVALENT TO ASTM A694 Gr. F42)	300#	150		56	64	-	64	-	By PDO	
6	PAIP00405/RQ/6003 (L/I#002)	NON-MESC.	300#	FLANGE: CL 300#, WNRF, SOUR, FORGED, BARE, SEAL FACE 3.2-6.4 RA, AS PER DEP.31.40.21.34 AND REF. SPEC'N FOR MORE DETAILS.	ISO 15590-3 Gr. L290 (EQUIVALENT TO ASTM A694 Gr. F42)	300#	50		45	52	-	52	-	By PDO	
7	PAIP00405/RQ/6007 (L/I#001)	NON-MESC.	300#	BALL VALVE FB FLGD.	REF. REQ'N & SPEC'N	300#	150		4	4	-	4	-	By PDO	
8	PAIP00405/RQ/6009	NON-MESC.	300#	THERMAL EXPANSION RELIEF VALVE FLGD. (48-RV-0396,0397,0398)	REF. REQ'N & SPEC'N	150# X 300#	25	50	3	3	-	3	-	By PDO	
9	PAIP00405/RQ/6008	NON-MESC.	300#	SLIMLINE VALVE: 2" X 2", CL 300#, SBB, MODULAR TYPE, FB, BOTH END FLANGED RF, NACE MR-0175/ISO 15156.	REF. REQ'N & SPEC'N	300#	50	50	6	6	-	6	-	By PDO	
10	PAIP00405/RQ/6005	NON-MESC.	300#	PIG SIGNALLERS: NON-INTRUSIVE TYPE, CLAMP ON/ STRAP-ON TYPE CONN, TO BE INSTALLED ON PIG TRAP & PIPELINE. (48-XI-2338,48-XI-2339,48-XI-2340 & 48-XI-2341)	REF. REQ'N & SPEC'N	300#	150		4	4	-	4	-	By PDO	



PIPELINE BULK MATERIAL TAKE OFF (MTO) - SUMMARY [FINAL]

WORLEYPARSONS - ARABIAN INDUSTRIES JV

Job/ Project No:	PAIP00405	Location/ Area:	NSPS+NRPS
Project Title:	NIMR SLUDGE PITS SYSTEMS UPGRADE-FEED/DD	PDO Project Code:	DQ [For Main project]
Client Ref:	C.OM.NIM.IN.09.011	Scope of MTO :	ON-PLOT/OFF-PLOT (Under B31.4 Code Break Limit)
MTO Document No:	NIM-3-2134-001-DQ	MTO Rev No/Date:	A / 17-JUL-2011

SL/ NO.	Material Reqn. & Spec'n (MRS) document Number	SAP / MESC Number	Applicable Piping Class	Line-Item Description	Material with Specification and Grade	Schedule/WT / Rating	Size 1	Size 2	Required Qty.	With Contgy. Qty.	Qty. Ordered before / Qty. in Stock	Qty. to be Ordered [Note-2]	Surplus(+) Less(-)	Scope of Supply
11	PAIP00405/RQ/6006	NON-MESC.	300#	PIG TRAPS - LAUNCHER (A-48305); CL 300# Ø 8" x 6", WITH END CLOSURE AND PIG LOADING SYSTEM	REF. REQ'N & SPEC'N	-	200	150	1	1	-	1	-	By PDO
12	PAIP00405/RQ/6006	NON-MESC.	300#	PIG TRAPS - RECEIVER (A-48306); CL 300# Ø 8" x 6", WITH END CLOSURE AND PIG LOADING SYSTEM.	REF. REQ'N & SPEC'N	-	200	150	1	1	-	1	-	By PDO
13	PAIP00405/RQ/6010	NON-MESC.	300#	HOPE-LINER	REF. REQ'N & SPEC'N	BY-VENDOR	150		3615	4280	-	4280	-	By Contr
14	1000201043	8546034401	300#	INSULATING GASKET	GRE G10	300#	150		2	2	-	2	-	By Contr
15	1000200929	8546033951	300#	INSULATING GASKET	GRE G10	S80S/300#	50		12	12	-	12	-	By Contr
16	1000063473 (NOTE-4)	8138662731	31440	STUD BOLT WITH NUTS (8 No's/JT)	ASTM A193-B7M/A194-2HM	300#	0.625	100	96	144	-	144	-	By Contr
17	1000063494 (NOTE-4)	8138663351	31440	STUD BOLT WITH NUTS (12 No's/JT)	ASTM A193-B7M/A194-2HM	300#	0.75	140	24	36	-	36	-	By Contr
18	1000063496 (NOTE-4)	8138663371	31440	STUD BOLT WITH NUTS (12 No's/JT)	ASTM A193-B7M/A194-2HM	300#	0.75	150	120	180	-	180	-	By Contr
19	1000063497 (NOTE-4)	8138663381	31440	STUD BOLT WITH NUTS (12 No's/JT)	ASTM A193-B7M/A194-2HM	300#	0.75	160	24	36	-	36	-	By Contr
20	1000063500 (NOTE-4)	8138663411	31440	STUD BOLT WITH NUTS (12 No's/JT)	ASTM A193-B7M/A194-2HM	300#	0.75	180	264	396	-	396	-	By Contr

Prepared by:

Checked by :

Approved by :

Date:

Date:

Date:

Revision details:

The Revised Line-items including " Quantity to be Ordered" are indicated in **ITALIC BOLD BLUE FONTS** with **YELLOW Highlight** (S/N # 4,5,6 & 20) as part of Rev.-A.

NOTES:

- Pipe Quantity's are in meters and for all other item's Quantity's are in numbers.
- The Line-items and quantities indicated in this MTO are preliminary based on PEFS package prior to AFC issue and this MTO is issued for the purpose of enquiry/procurement by PDO or by Construction contractor. However, the final required line-items and quantities for the project will be issued along with AFC Piping GAD package at a later stage.
- Stopaq wrap tape, Pipeline Marker's, Name plates and any other materials which is not indicated in this MTO required for the successful completion of the project shall be estimated and supplied by the Construction contractor.
- Length of Stud bolts to be confirmed upon the receipt of Retainer Ring dimensions for all the PE/ROTO-Lined pipe spools/joints prior to the placement of order.

APPROVED FOR CONSTRUCTION

**PIPELINE BULK MATERIAL TAKE OFF (MTO) - SUMMARY [FINAL]**

WORLEYPARSONS - ARABIAN INDUSTRIES JV

Job/ Project No:	PAIP00405	Location/ Area:	NSPS+NRPS
Project Title:	NIMR SLUDGE PITS SYSTEMS UPGRADE-FEED/DD	PDO Project Code:	DQ [For Main project]
Client Ref:	C.OM.NIM.IN.09.011	Scope of MTO :	ON-PLOT/OFF-PLOT (Under B31.3 Code Break Limit)
MTO Document No:	NIM-3-2135-001-DQ	MTO Rev No/Date:	A / 17-JUL-2011

SL/ NO.	Material Reqn. & Spec'n (MRS) document Number	SAP / MESC Number	Applicable Piping Class	Line-Item Description	Material with Specification and Grade	Schedule/WT / Rating	Size 1	Size 2	Required Qty.	With Contgy. Qty.	Qty. Ordered before / Qty. in Stock	Qty. to be Ordered [Note-2]	Surplus(+/-) Less(-)	Scope of Supply
1	1000051896	7436330181	33421	PIPE	ASTM A312-TP316L	S 40S	15		43.0	54.0	-	54.0	-	By Cont'r
2	1000051711	7430030711	31440	PIPE	ASTM A106-B	S80	50		80.5	96.0	-	96.0	-	By Cont'r
3	1000051902	7436330571	33421	PIPE	ASTM A312-TP316L	S 10S	50		4.5	6.0	-	6.0	-	By Cont'r
4	1000051718	7430031491	31440	PIPE	ASTM A106-B	S40	100		41.5	54	-	54	-	By Cont'r
5	1000051722	7430032111	31440	PIPE	ASTM A106-B	S40	150		32.0	42.0	-	42.0	-	By Cont'r
6	1000052982	7630426081	31440	ELBOW 90DEG BW	ASTM A234-WPB	S80	50		45	54	-	54	-	By Cont'r
7	1000052968	7630426451	31440	ELBOW 90DEG BW	ASTM A234-WPB	S40	100		10	12	-	12	-	By Cont'r
8	1000052973	7630426651	31440	ELBOW 90DEG BW	ASTM A234-WPB	S40	150		2	2	-	2	-	By Cont'r
9	1000053750	7630816081	31440	EQUAL TEE BW	ASTM A234-WPB	S80	50		13	16	-	16	-	By Cont'r
10	1000069003	7630881571	31440	REDUCING TEE BW	ASTM A234-WPB	S40 x S80	100	50	17	20	-	20	-	By Cont'r
11	1000074733	7630881891	31440	REDUCING TEE BW	ASTM A234-WPB	S40 x S40	150	100	2	2	-	2	-	By Cont'r
12	PAIP00405/RQ/6004	NON-MESC.	3000#	CAP THREADED (FNPT)	ASTM A182 F316, MSS SP 75	3000#	15		45	72	-	72	-	By Cont'r
13	1000071043	7630672661	11440	REDUCER ECC.BW	ASTM A234-WPB	S40 x S80	100	50	1	1	-	1	-	By Cont'r
14	1000055288	7633705791	33421	REDUCER CONC.BW	ASTM A403-WP316L	S10S x S40S	25	15	45	52	-	52	-	By Cont'r
15	1000055295	7633706341	33421	REDUCER CONC.BW	ASTM A403-WP316L	S 10S x S 10S	50	25	50	58	-	58	-	By Cont'r
16	1000057461	7679010641	31440	BRANCH OUTLET BW	ASTM A105	S40 x S80	150	50	8	10	-	10	-	By Cont'r
17	1000057154	7665804021	33421	WELD NECK FLANGE RF	ASTM A182-F316	S 40S	15		90	104	-	104	-	By Cont'r
18	1000057141	7665794061	33421	WELD NECK FLANGE RF	ASTM A182-F316	S 10S	25		5	6	-	6	-	By Cont'r
19	1000056463	7662783601	11440	WELD NECK FLANGE RF	ASTM A105	S80	50		16	19	-	19	-	By Cont'r
20	1000056500	7662786101	31440	WELD NECK FLANGE RF	ASTM A105	S80	50		124	149	-	149	-	By Cont'r
21	1000057143	7665794101	33421	WELD NECK FLANGE RF	ASTM A182-F316	S 10S	50		50	58	-	58	-	By Cont'r
22	1000056452	7662783141	11440	WELD NECK FLANGE RF	ASTM A105	S40	100		6	7	-	7	-	By Cont'r
23	1000056486	7662785641	31440	WELD NECK FLANGE RF	ASTM A105	S40	100		30	36	-	36	-	By Cont'r



PIPELINE BULK MATERIAL TAKE OFF (MTO) - SUMMARY [FINAL]

WORLEYPARSONS - ARABIAN INDUSTRIES JV

Job/ Project No: PAIP00405 Project Title: NIMR SLUDGE PITS SYSTEMS UPGRADE-FEED/DD Client Ref: C.OM.NIM.IN.09.011 MTO Document No: NIM-3-2135-001-DQ						Location/ Area: NSPS+NRPS PDO Project Code: DQ [For Main project] Scope of MTO : <u>ON-PLOT/OFF-PLOT</u> (Under B31.3 Code Break Limit) MTO Rev No/Date: A / 17-JUL-2011								
SL/ NO.	Material Reqn. & Spec'n (MRS) document Number	SAP / MESC Number	Applicable Piping Class	Line-Item Description	Material with Specification and Grade	Schedule/WT / Rating	Size 1	Size 2	Required Qty.	With Contgy. Qty.	Qty. Ordered before / Qty. in Stock	Qty. to be Ordered [Note-2]	Surplus(+) Less(-)	Scope of Supply
24	1000056487	7662785661	31440	WELD NECK FLANGE RF	ASTM A105	S40	150		19	23	-	23	-	By Cont'r
25	1000056181	7662110701	11440	BLIND FLANGE	ASTM A105	150#	50		1	1	-	1	-	By Cont'r
26	1000056198	7662111201	31440	BLIND FLANGE	ASTM A105	300#	50		12	14	-	14	-	By Cont'r
27	1000056200	7662111241	31440	BLIND FLANGE	ASTM A105	300#	100		2	2	-	2	-	By Cont'r
28	1000059283	7688370501	31440	SPECTACLE BLIND	ASTM A516-60/65/70	300#	50		3	4	-	4	-	By Cont'r
29	1000059285	7688370541	31440	SPECTACLE BLIND	ASTM A516-60/65/70	300#	100		2	2	-	2	-	By Cont'r
30	1000064408	8541364041	33421	GASKET SPIRAL WOUND	AISI 316, graphite filled CS centring-/SS inner ring	300#	15		92	184	-	184	-	By Cont'r
31	1000064410	8541364081	33421	GASKET SPIRAL WOUND	AISI 316, graphite filled CS centring-/SS inner ring	300#	25		5	10	-	10	-	By Cont'r
32	1000064370	8541363141	11440	GASKET SPIRAL WOUND	AISI 316, graphite filled CS centring-/SS inner ring	150#	50		4	8	-	8	-	By Cont'r
33	1000064412	8541364141	31440	GASKET SPIRAL WOUND	AISI 316, graphite filled CS centring-/SS inner ring	300#	50		1	2	-	2	-	By Cont'r
34	1000064372	8541363201	11440	GASKET SPIRAL WOUND	AISI 316, graphite filled CS centring-/SS inner ring	150#	100		2	4	-	4	-	By Cont'r
35	1000206450	8546030661	150#	INSULATING GASKET	GRE G10	S80-150#	50		11	11	-	11	-	By Cont'r
36	1000200927	8546033911	300#	INSULATING GASKET	GRE G10	S10S/300#	50		47	47	-	47	-	By Cont'r
37	1000200952	8546033961	300#	INSULATING GASKET	GRE G10	S80-300#	50		12	12	-	12	-	By Cont'r
38	1000206503	8546030941	150#	INSULATING GASKET	GRE G10	S40-150#	100		1	1	-	1	-	By Cont'r
39	1000200951	8546033941	300#	INSULATING GASKET	GRE G10	S40/300#	100		4	4	-	4	-	By Cont'r
40	-	7703450081	13842	BALL VALVE FLOAT RB FLGD	Body: ASTM A182-F55/A890-6A Trim: Super Duplex, PTFE	150#	50		2	2	-	2	-	By Cont'r
41	-	7703453581	33842	BALL VALVE FLOAT RB FLGD	Body: ASTM A182-F55/A890-6A Trim: Super Duplex, PTFE	300#	50		24	24	-	24	-	By Cont'r
42	-	7703660621	33842	BALL VALVE TRUNN RB FLGD	Body: ASTM A182-F55/A890-6A Trim: Super Duplex, filled PTFE	300#	100		4	4	-	4	-	By Cont'r
43	-	7733430531	33842	GLOBE VALVE FLGD	Body: ASTM A182-F55/A890-6A Trim: Super Duplex	300#	15		46	51	-	51	-	By Cont'r
44	-	7733430581	33842	GLOBE VALVE FLGD	Body: ASTM A182-F55/A890-6A Trim: Super Duplex	300#	50		3	3	-	3	-	By Cont'r
45	-	7713420081	13842	CHECK VALVE FLGD	Body: ASTM A182-F55/A890-6A Trim: Super Duplex	150#	50		2	2	-	2	-	By Cont'r



PIPELINE BULK MATERIAL TAKE OFF (MTO) - SUMMARY [FINAL]

WORLEYPARSONS - ARABIAN INDUSTRIES JV

Job/ Project No:	PAIP00405	Location/ Area:	NSPS+NRPS
Project Title:	NIMR SLUDGE PITS SYSTEMS UPGRADE-FEED/DD	PDO Project Code:	DQ [For Main project]
Client Ref:	C.OM.NIM.IN.09.011	Scope of MTO :	<u>ON-PLOT/OFF-PLOT</u> (Under B31.3 Code Break Limit)
MTO Document No:	NIM-3-2135-001-DQ	MTO Rev No/Date:	A / 17-JUL-2011

SL/ NO.	Material Reqn. & Spec'n (MRS) document Number	SAP / MESO Number	Applicable Piping Class	Line-Item Description	Material with Specification and Grade	Schedule/WT / Rating	Size 1	Size 2	Required Qty.	With Contgy. Qty.	Qty. Ordered before / Qty. in Stock	Qty. to be Ordered [Note-2]	Surplus(+) Less(-)	Scope of Supply
46	-	7713420581	33842	CHECK VALVE FLGD	Body: ASTM A182-F55/A890-6A Trim: Super Duplex	300#	50		4	4	-	4	-	By Cont'r
47	PAIP00405/RQ/6009	NON-MESC.	300#	THERMAL EXPANSION RELIEF VALVE, FLGD. (48-RV-0547, 48-RV-0548)	REF. REQ'N & SPEC'N	300#	25	50	2	2	-	2	-	By Cont'r
48	1000063457 (NOTE-3)	8138661551	33421	STUD BOLT WITH NUTS (4 No's/JT)	ASTM A193-B7M/A194-2HM	300#	0.5	70	360	540	-	540	-	By Cont'r
49	1000063469 (NOTE-3)	8138662691	33421	STUD BOLT WITH NUTS (4 No's/JT)	ASTM A193-B7M/A 194-2HM	300#	0.625	80	12	18	-	18	-	By Cont'r
50	1000063471 (NOTE-3)	8138662711	31440	STUD BOLT WITH NUTS (8 No's/JT)	ASTM A193-B7M/A194-2HM	300#	0.625	90	24	36	-	36	-	By Cont'r
51	1000063473 (NOTE-3)	8138662731	31440	STUD BOLT WITH NUTS (8 No's/JT)	ASTM A193-B7M/A194-2HM	300#	0.625	100	1008	1512	-	1512	-	By Cont'r
52	1000063474 (NOTE-3)	8138662741	31440	STUD BOLT WITH NUTS (8 No's/JT)	ASTM A193-B7M/A194-2HM	300#	0.625	110	312	468	-	468	-	By Cont'r
53	1000063475 (NOTE-3)	8138662761	31440	STUD BOLT WITH NUTS (8 No's/JT)	ASTM A193-B7M/A194-2HM	300#	0.625	120	24	36	-	36	-	By Cont'r
54	1000063483 (NOTE-3)	8138663341	31440	STUD BOLT WITH NUTS (8 No's/JT)	ASTM A193-B7M/A194-2HM	300#	0.75	130	8	12	-	12	-	By Cont'r
55	1000063494 (NOTE-3)	8138663351	31440	STUD BOLT WITH NUTS (8 No's/JT)	ASTM A193-B7M/A194-2HM	300#	0.75	140	144	216	-	216	-	By Cont'r
56	1000063496 (NOTE-3)	8138663371	31440	STUD BOLT WITH NUTS (8 No's/JT)	ASTM A193-B7M/A194-2HM	300#	0.75	150	92	138	-	138	-	By Cont'r
57	1000063497 (NOTE-3)	8138663381	31440	STUD BOLT WITH NUTS (12 No's/JT)	ASTM A193-B7M/A194-2HM	300#	0.75	160	44	66	-	66	-	By Cont'r
58	PAIP00405/RQ/6013	7353160449	150#	ELAFLEX COUPLING	CS	150#	100		1	1	-	1	-	By Cont'r

Prepared by:

Checked by :

Approved by :

Date:

Date:

Date:

Revision details:

The Revised Line-items including "Quantity to be Ordered" are indicated in **ITALIC BOLD BLUE FONTS** with **YELLOW Highlight** (S/N # 1,12,14,15,17,21,30,36,43,48 & 51) as part of Rev.-A.

NOTES:

- Pipe Quantity's are in meters and for all other item's Quantity's are in numbers.
- The Line-items and quantities indicated in this MTO are preliminary based on PEFS package prior to AFC issue and this MTO is issued for the purpose of enquiry/procurement by PDO or by Construction contractor. However, the final required line-items and quantities for the project will be issued along with AFC Piping GAD package at a later stage.
- Length of Stud bolts to be confirmed upon the receipt of Retainer Ring dimensions for all the PE/ROTO-Lined pipe spools/joints prior to the placement of order.

APPROVED FOR CONSTRUCTION

PAIP00405- Nimr Sludge Pit Up gradation

MTO- C&A

Sl. No.	ITEM	SYMBOL	DATE	AVG END CLASS	DESCRIPTION	MAT SPECIFICATION	SIZE	SIZE 2	UNIT	QTY	MINIMUM CERT. REQ.
1	302	1000049076	70.13.04.025.1		HEAVY GAUGE CONDUIT	GALV. STEEL	25mm Dia		Mtrs	15.00	
2	L	1000047736	XX.XX.XX.XXX.X		CABLE XLPEI-MS-SWA-PVCS, BLACK		2 x 2.5 mm ²		Mtrs	250.00	
3	O	1000405299	XX.XX.XX.XXX.X		CABLE XLPEI-MS-SWA-PVCS, BLACK		2 x 2 x 1.13 mm		Mtrs	1000.00	
4	P	1000405297	XX.XX.XX.XXX.X	37.020	CBL ELEC ARM FIRE 24V 10PAIR 0.5MM2		10 x 2 x 0.8 mm		Mtrs	1300.00	BS5308, PART 1, TYPE2
5	R	-	XX.XX.XX.XXX.X		CABLE SHRINK ON SLEEVE (BLUE)	POLYOLEFIN	19 ~ 6 mm		-	NOTE-1	
6	X	1000048276	68.80.58.068.1		LOCK NUT	BRASS	M20		Pcs	30.00	
7	Y	1000048277	68.80.58.072.9	37.110	NUT LCK HEX BRASS MTR 25MM	BRASS	M25		Pcs	12.00	BS3643
8	AA	1000048319	68.80.58.730.1		CABLE GLAND 501/453-0	BRASS	M20		Pcs	53.00	
9	AB	1000048321	68.80.58.734.1	37.110	GLND CBL W/FLMPROF PVC SWA BS6121/25	BRASS	M25		Pcs	12.00	BS6121, TYPE E1 WF
10	AD	1000048327	68.80.58.802.9		GLND CBL ADPT 1/2"NPT 20MM	BRASS	1/2" NPTxM20		Pcs	8.00	
11	AP	1000211202	74.13.10.069.9		PIPE MET API 5L-B 40 DN50	CARBON STEEL	2"		Mtrs	17.00	
12	AQ	10000211233	74.13.12.103.9		PIPE MET API 5L-B 40 DN80	CARBON STEEL	3"		Pcs	3.00	
13	BP	1000106870	76.30.15.052.1		CAP PIPE BW WPB 80 DN50	CARBON STEEL	2"		Pcs	7.00	
14	BQ	1000053436	76.30.72.235.1		REC BW WPB 40 DN80X50	CARBON STEEL	3" x 2"		Pcs	3.00	
15	CC	1000055943	76.39.27.152.9	37.320	CONN TUBE CPT MAL 316 316 1/2X1/2"	AISI 316	1/2" NPT x 1/2" OD		Pcs	3.00	
16	CF	1000056003	76.39.67.040.1	37.320	PLUG TUB CPT 316 1/4IN	AISI 316	1/4" NPT		Pcs	22.00	
17	CJ	1000062573	78.39.02.121.1		FLAT BAR (6Mtrs LONG)	MILD STEEL	50 x 6 mm		Pcs	2.00	
18	CL	1000062605	78.43.30.108.1		STEEL PLATE (2000x1000x3)	MILD STEEL	3mm THICK		Pcs	1.00	
19	CM	1000062606	78.43.30.116.1		SHT PLT SLD MET 2000X1000 6MM	MILD STEEL	6 mm THK		Pcs	1.00	
20	CN	1000062608	78.43.30.124.1		SHT PLT SLD MET 2000X1000 10MM	MILD STEEL	10 mm THK		Pcs	1.00	
21	CQ	1000062629	78.47.01.352.1		ANGL MTL EQ STL 6M L50X50X6MM	MILD STEEL	50 x 50 x 6 mm		Pcs	3.00	
22	CR	1000051996	74.48.50.073.9	37.310	TUBE MET INSTR 1/2IN 18SWG 0.048IN	AISI 316	1/2" OD		Mtrs	5.00	
23	CY	1000062961	81.01.77.192.1		BLT HEX CL.8.8 COARSE 60MM M10	CARBON STEEL	M10 x 60 mm		Pcs	5.00	
24	DA	1000062977	81.26.25.133.1		BLT FND CL.4.6 MC 110MM M12	CARBON STEEL	M12 x 110 mm		Pcs	20.00	
25	DH	1000063819	81.41.77.018.1		NUT MTR CL.8 HEX ISO 724 M10	CARBON STEEL	M10		Pcs	5.00	
26	DU	1000062984	81.26.86.022.9		U-BOLT FOR 1/2" PIPE C/W NUTS & SPRING WASHER	AISI 316	M8		Pcs	16.00	
27	DV	1000062987	81.26.86.040.9		U-BOLT DN50	AISI 316	M10		Pcs	41.00	
28	EA	1000048204	68.80.50.942.9		CABLE TIES 12/BLACK		4x140 mm		-	NOTE-1	
29	EB	1000048103	68.79.02.004.9		CARRIER STRIP BLACK 7 DIGITS				-	NOTE-1	
30	EC	1000048115	68.79.02.004.9		CABLE MARKER TYPE KS		80		-	NOTE-1	
31	ED	1000062537	68.79.02.018.1		PLAIN STRIP		250x19x1.6 mm		-	NOTE-1	
32	EE	1000048112	68.79.02.018.1		CORE MARKER MODLE ZS-5		D=1.5-2.0 mm		-	NOTE-1	
33	EK	1000047959	68.76.54.004.9		CABLE CHANNEL 2M LONG	GI	100 mm WIDE		Mtrs	100.00	BS2989, GROUP2, CLASS-E
34	EO	1000047964	68.76.54.052.9		CABLE CHANNEL BEND 90 DEG.	GI	100 mm WIDE		Pcs	50.00	BS2989, GROUP2, CLASS-E
35	ES	1000047982	68.76.81.024.9		CABLE TILE		1000x244x6 mm		Pcs	250.00	
36					NAME PLATE (AS PER NAME PLATE DETAILS)		(TYPE A & B)		Pcs	NOTE-2	
37					PRESSURE TRANSMITTER	NOTE-3	-		Pcs	1.00	
38					PRESSURE GAUGE	NOTE-3	-		Pcs	9.00	
39					DIFFERENTIAL PRESSURE TRANSMITTER	NOTE-3	-		Pcs	3.00	
40					RADR LEVEL TRANSMITTER	NOTE-3	-		Pcs	4.00	
41					TEMPERATURE TRANSMITTER	NOTE-3	-		Pcs	1.00	
42					ULTRASONG FLOW METER (STRAP-ON TYPE)	NOTE-3	-		Pcs	1.00	
43					PNEUMATIC On-Off VALVE, RB, 6", 300#	NOTE-3	-		Pcs	1.00	
44		1000039291	60.04.69.302.9		PUSH BUTTON, EFS-110		-		Pcs	5.00	
45					HEAT DETECTOR	NOTE-3	-		Pcs	2.00	
46					LEVEL GAUGE	NOTE-3	-		Pcs	1.00	
47					HOOTER (AUDIBLE ALARM)	NOTE-3	-		Pcs	1.00	
48		1000047918	68.76.40.014.9		JUNCTION BOX EEX II T6		20 TERMINALS		Pcs	3.00	
50					RTU WITH RADIO MODULE	NOTE-4					
51					GATEWAY	NOTE-4					
NOTE -1 : QUANTITIES TO BE DETERMINED AND MATERIAL TO BE SUPPLIED BY CONSTRUCTION CONTRACTOR.											
NOTE -2 : REFER DRAWING No. NIM -5-4739-DQ-4											
NOTE -3 : AS PER SPECIFICATION PREPARED UNDER THIS PROJECT.											
NOTE -4 : FREE ISSUE BY PDO											

PAIP00405- Nimr Sludge Pit Up gradation

MTO- Mechanical

Job Number : PAIP00405

Bulk Summary Doc. No. : NIM-3-2145-001-DQ

Job Title : Nimr Sludge Pits System upgrade - FED & DD

MTO Rev. No. : A

Area : NIMR

Contingency Status: Final

Date: 30-MAY-11

Sr.No	SAP/Req. Number	MESC Number	Class	Item Description	Material	Schedule/W Rating	Size 1	Size 2	Required Quantity	Quantity with Contingen	Stock Quantit	Total Requisition Quant	Material to be Procure	Surplus Material
1	1000051514	7413080181	18011	Pipe	API 5L-B (galvanised)	S80	15	0	0.5	6	0	6	0	0
2	1000051518	7413080281	18011	Pipe	API 5L-B (galvanised)	S80	25	0	0.5	6	0	6	0	0
3	1000051700	7430030201	31440	Pipe	ASTM A106-B	S160	15	0	4	6	0	6	0	0
4	1000051711	7430030711	31440	Pipe	ASTM A106-B	S80	50	0	168.7	198	0	228	0	30
5	1000051715	7430031091	11440	Pipe	ASTM A106-B	S80	80	0	7	12	0	6	6	0
6	1000051718	7430031491	11440	Pipe	ASTM A106-B	S40	100	0	92.5	108	0	138	0	30
7	1000051722	7430032111	31440X	Pipe	ASTM A106-B	S 40	150	0	298.5	348	0	282	66	0
8	1000051781	7430050281	11412	Pipe	ASTM A106-B	S80	20	0	1.5	6	0	0	6	0
9	1000072413	7430053731	11412	Pipe	ASTM A106-B	S20	350	0	16	18	0	18	0	0
10	1000051896	7436330181	33411	Pipe	ASTM A312-TP316L	S40S	15	0	0	0	0	6	0	6
11	1000051897	7436330261	33411	Pipe	ASTM A312-TP316L	S40S	20	0	0.5	6	0	24	0	18
12	1000051898	7436330331	33421	Pipe	ASTM A312-TP316L	S10S	25	0	0	0	0	6	0	6
13	1000051902	7436330571	13411	Pipe	ASTM A312-TP316L	S10S	50	0	1	6	0	12	0	6
14	1000052326	7606280161	18011	Coupling Thrd	ASTM A234-WPB (galvanised)	S80	25	0	1	1	0	1	0	0
15	1000052340	7606390081	18011	Elbow 90 Deg Thrd	ASTM A234-WPB (galvanised)	S80	15	0	0	0	0	2	0	2
16	1000052400	7606660081	18011	Plug Npt	ASTM A234-WPB (galvanised)	S80	15	0	1	1	0	1	0	0
17	1000052433	7606850341	18011	Tee Reducing Thrd	ASTM A234-WPB (galvanised)	S80 x S80	25	15	1	1	0	1	0	0
18	1000052451	7606910161	18011	Union Thrd	ASTM A234-WPB (galvanised)	S80	25	0	1	1	0	1	0	0
19	1000124172	7629461921	11412	Reducer Conc.Bw	ASTM A234-WPB	S40 x S80	50	20	1	1	0	0	1	0
20	1000052727	7630346081	31440X	Elbow 45 Deg Bw	ASTM A234-WPB	S 80	50	0	2	2	0	2	0	0
21	1000052737	7630346651	31440X	Elbow 45 Deg Bw	ASTM A234-WPB	S 40	150	0	5	6	0	0	6	0
22	1000052870	7630405741	11412	Elbow 90 Deg Bw	ASTM A234-WPB	S80	20	0	2	2	0	0	2	0
23	1000052951	7630425721	31440X	Elbow 90 Deg Bw	ASTM A234-WPB	S 160	15	0	37	43	0	11	32	0
24	1000052962	7630426081	31440	Elbow 90 Deg Bw	ASTM A234-WPB	S80	50	0	35	40	0	49	0	9
25	1000052966	7630426281	11440	Elbow 90 Deg Bw	ASTM A234-WPB	S80	80	0	4	5	0	5	0	0
26	1000052968	7630426451	11440	Elbow 90 Deg Bw	ASTM A234-WPB	S40	100	0	12	14	0	17	0	3
27	1000052973	7630426651	31440X	Elbow 90 Deg Bw	ASTM A234-WPB	S 40	150	0	33	38	0	35	3	0
28	1000053081	7630662371	11440	Reducer Conc.Bw	ASTM A234-WPB	S80 x S80	80	50	1	1	0	1	0	0
29	1000053100	7630663051	31440X	Reducer Conc.Bw	ASTM A234-WPB	S 40 x S 40	150	100	1	1	0	1	0	0
30	1000070912	7630671411	31440	Reducer Ecc.Bw	ASTM A234-WPB	S160 x S160	20	15	1	1	0	1	0	0
31	1000070920	7630671931	31440	Reducer Ecc.Bw	ASTM A234-WPB	S80 x S160	50	20	1	1	0	1	0	0
32	1000053750	7630816081	31440	Equal Tee Bw	ASTM A234-WPB	S80	50	0	10	12	0	14	0	2
33	1000053754	7630816281	11440	Equal Tee Bw	ASTM A234-WPB	S80	80	0	2	2	0	2	0	0
34	1000053756	7630816451	11440	Equal Tee Bw	ASTM A234-WPB	S40	100	0	1	1	0	1	0	0
35	1000053760	7630816651	31440X	Equal Tee Bw	ASTM A234-WPB	S 40	150	0	4	5	0	5	0	0
36	1000069003	7630881571	11440	Tee Reducing Bw	ASTM A234-WPB	S40 x S80	100	50	2	2	0	10	0	8
37	1000074733	7630881891	31440X	Tee Reducing Bw	ASTM A234-WPB	S 40 x S 40	150	100	1	1	0	1	0	0

38	1000055078	7633412861	33421 Elbow 90 Deg Bw	ASTM A403-WP316L	S40S	15	0	0	0	0	5	0	5	
39	1000055079	7633412961	33411 Elbow 90 Deg Bw	ASTM A403-WP316L	S40S	20	0	0	0	0	5	0	5	
40	1000055085	7633413341	13411 Elbow 90 Deg Bw	ASTM A403-WP316L	S10S	50	0	0	0	0	10	0	10	
41	1000055295	7633706341	33421 Reducer Conc.Bw	ASTM A403-WP316L	S10S× S10S	50	25	0	0	0	2	0	2	
42	1000055560	7633856181	33411 Tee Reducing Bw	ASTM A403-WP316L	S40S× S40S	20	15	1	1	0	2	0	1	
43	1000056181	7662110701	11440 Blind Flange	ASTM A105	150#	50	0	4	5	0	4	1	0	
44	1000056182	7662110721	11440 Blind Flange	ASTM A105	150#	80	0	1	1	0	1	0	0	
45	1000056183	7662110741	11440 Blind Flange	ASTM A105	150#	100	0	1	1	0	0	1	0	
46	1000056198	7662111201	31440X Blind Flange	ASTM A105	300#	50	0	12	14	0	14	0	0	
47	1000056200	7662111241	31440X Blind Flange	ASTM A105	300#	100	0	0	0	0	1	0	1	
48	1000056201	7662111261	31440X Blind Flange	ASTM A105	300#	150	0	1	1	0	0	1	0	
49	1000056309	7662203201	31440X Lap Joint Flange	ASTM A105	300#	50	0	1	1	0	1	0	0	
50	1000056452	7662783141	11440 Weld Neck Rf Flange	ASTM A105	S40	150#	100	0	7	8	0	8	0	0
51	1000056463	7662783601	11440 Weld Neck Rf Flange	ASTM A105	S80	150#	50	0	17	20	0	25	0	5
52	1000056464	7662783621	11440 Weld Neck Rf Flange	ASTM A105	S80	150#	80	0	5	6	0	6	0	0
53	1000056486	7662785641	31440X Weld Neck Rf Flange	ASTM A105	S 40	300#	100	0	1	1	0	18	0	17
54	1000056487	7662785661	31440X Weld Neck Rf Flange	ASTM A105	S 40	300#	150	0	153	176	0	132	44	0
55	1000056500	7662786101	31440X Weld Neck Rf Flange	ASTM A105	S 80	300#	50	0	94	108	0	158	0	50
56	1000056510	7662786521	31440 Weld Neck Rf Flange	ASTM A105	S160	300#	15	0	28	32	0	7	25	0
57	1000056994	7665104121	33411 Blind Flange	ASTM A182-F316	300#	15	0	1	1	0	2	0	1	
58	1000056995	7665104141	33411 Blind Flange	ASTM A182-F316	300#	20	0	1	1	0	1	0	0	
59	1000057118	7665792101	13411 Weld Neck Rf Flange	ASTM A182-F316	S10S	150#	50	0	0	0	0	4	0	4
60	1000057141	7665794061	33421 Weld Neck Rf Flange	ASTM A182-F316	S10S	300#	25	0	0	0	0	2	0	2
61	1000057143	7665794101	33421 Weld Neck Rf Flange	ASTM A182-F316	S10S	300#	50	0	4	5	0	2	3	0
62	1000057154	7665804021	33411 Weld Neck Rf Flange	ASTM A182-F316	S40S	300#	15	0	1	1	0	5	0	4
63	1000057155	7665804041	33411 Weld Neck Rf Flange	ASTM A182-F316	S40S	300#	20	0	2	2	0	10	0	8
64	1000057461	7679010641	31440X Branch Outlet Bw	ASTM A105	S 40 x S 80	150	50	29	33	0	30	3	0	
65	1000058020	7680371211	31440X Branch Fitting Flgd	ASTM A105	S 160	300#	600	15	18	20	0	7	13	0
66	1000173022	7683385621	31440X Thermowell	ASTM B564 UNS N04400	150# / 250C	50	255	1	1	0	1	0	0	
67	1000072195	7688370101	11440 Spectacle Blind	ASTM A516-60/65/70	150#	50	0	2	2	0	2	0	0	
68	1000070269	7688370141	11440 Spectacle Blind	ASTM A516-60/65/70	150#	100	0	2	2	0	2	0	0	
69	1000071500	7688370201	11440 Spectacle Blind	ASTM A516-60/65/70	150#	250	0	2	2	0	2	0	0	
70	1000059283	7688370501	31440X Spectacle Blind	ASTM A516-60/65/70	300#	50	0	7	8	0	6	2	0	
71	1000059285	7688370541	31440X Spectacle Blind	ASTM A516-60/65/70	300#	100	0	0	0	0	1	0	1	
72	1000059286	7688370561	31440X Spectacle Blind	ASTM A516-60/65/70	300#	150	0	8	9	0	10	0	1	
73		7700250081	11440 Ball Valve RB Flgd.	Body: ASTM A105/A216-WCB/WCC Trim: AISI 316, PTFE	150#	50	0	3	3	0	4	0	1	
74		7700250101	11440 Ball Valve RB Flgd.	Body: ASTM A105/A216-WCB/WCC Trim: AISI 316, PTFE	150#	80	0	1	1	0	1	0	0	
75		7700250121	11440 Ball Valve RB Flgd.	Body: ASTM A105/A216-WCB/WCC Trim: AISI 316, PTFE	150#	100	0	2	2	0	2	0	0	
76 RQ/3008	NON MESC	31440X Ball Valve 14313 RB F	Body: ASTM A182 F55 UNS N32760/A995 Grade 6A Trim: SDSS, PTFE	300#	100	0	0	0	0	0	2	0	2	
77		7703260081	13411 Ball Valve RB Flgd.	Body: ASTM A182-F316/A351-CF8M Trim: AISI 316, PTFE	150#	50	0	0	0	0	1	0	1	
78 RQ/3008	NON MESC	11440X Ball Valve RB Flgd.	Body: ASTM A182 F55 UNS N32760/A995 Grade 6A Trim: SDSS, PTFE	150#	50	0	2	2	2	0	2	0	0	
79 RQ/3008	NON MESC	31440X Ball Valve 14313 RB F	Body: ASTM A182 F55 UNS N32760/A995 Grade 6A Trim: SDSS, PTFE	300#	50	0	25	28	0	0	34	0	6	

80	RQ/3008	NON MESC	31440X	Ball Valve	14313	FB Fl Body: ASTM A182 F55 UNS N32760/A995 Grade 6A Trim: SDSS, PTFE		300#	150	0		9	10	0	12	0	2
81	RQ/3008	NON MESC	11440X	Ball Valve	14313	FB Fl Body: ASTM A105/A216 WCB/WCC WITH ALLOY 625 CLAD Trim: SDSS, PTFE		150#	250	0		1	1	0	1	0	0
82	RQ/3011	NON MESC	31440X	Globe Valve	Flgd	Body: ASTM A182 F55 UNS N32760/A995 Grade 6A Trim: SDSS, PTFE		300#	50	0		0	0	0	1	0	1
83		7707031531	18011	Ball Valve	Float RB Th	ASTM B148-UNS C95400,TRIM:ALUMINIUM BRONZE,PTFE		800#	15	0		1	1	0	1	0	0
84	RQ/3009	NON MESC	31440X	Check Valve	Flgd	Body: ASTM A182 F55 UNS N32760/A995 Grade 6A Trim: SDSS, PTFE		300#	50	0		5	6	0	6	0	0
85	RQ/3009	NON MESC	31440X	Check Valve	Flgd	Body: ASTM A182 F55 UNS N32760/A995 Grade 6A Trim: SDSS, PTFE		300#	150	0		3	3	0	4	0	1
86	1090000348	7710050081	11440	Check Valve	Flgd	Body: ASTM A105/A216-WCB/WCC Trim: AISI 316, Stellite 6		150#	50	0		1	1	0	1	0	0
87		7713193541	33411	Check Valve	Flgd	Body: ASTM A182-F316/A351-CF8M Trim: AISI 316, Stellite 6		300#	20	0		1	1	0	2	0	1
88	RQ/3005	NON MESC	31440X	Modular Constr.	SBBV	Body: ASTM A182 F55 UNS N32760/A995 Grade 6A Trim: SDSS, PTFE		300#	50	50		11	11	0	10	1	0
89		7723033531	33411	Gate Valve	Flgd	Body: ASTM A182-F316/A351-CF8M Trim: AISI 316, Stellite 6		300#	15	0		1	1	0	2	0	1
90		7723033541	33411	Gate Valve	Flgd	Body: ASTM A182-F316/A351-CF8M Trim: AISI 316, Stellite 6		300#	20	0		1	1	0	2	0	1
91		7730053531	31440X	Globe Valve	Flgd	Body: ASTM A182 F55 UNS N32760/A995 Grade 6A Trim: SDSS, PTFE		300#	15	0		11	12	0	8	4	0
92	1000063033	8138611551	33411	Stud Bolt with Nuts		ASTM A193-B7/A194-2H			0.5	70		8	10	0	24	0	14
93	1000063047	8138612691	33411	Stud Bolt with Nuts		ASTM A193-B7/A194-2H			0.63	80		16	20	0	60	0	40
94	1000063457	8138661551	31440	Stud Bolt with Nuts		ASTM A193-B7M/A194-2HM			0.5	70		160	208	0	84	124	0
95	1000063471	8138662711	11440	Stud Bolt with Nuts		ASTM A193-B7M/A194-2HM			0.63	90		40	52	0	96	0	44
96	1000063473	8138662731	11440	Stud Bolt with Nuts		ASTM A193-B7M/A194-2HM			0.63	100		656	852	0	1332	0	480
97	1000063474	8138662741	31440X	Stud Bolt with Nuts		ASTM A193-B7M/A194-2HM			0.63	110		152	197	0	96	101	0
98	1000063477	8138662781	31440X	Stud Bolt with Nuts		ASTM A193-B7M/A194-2HM			0.63	130		64	83	0	36	47	0
99	1000063494	8138663351	31440X	Stud Bolt with Nuts		ASTM A193-B7M/A194-2HM			0.75	140		0	0	0	96	0	96
100	1000063496	8138663371	31440X	Stud Bolt with Nuts		ASTM A193-B7M/A194-2HM			0.75	150		1032	1341	0	252	1089	0
101		8138663401	31440X	Stud Bolt with Nuts		ASTM A193-B7M/A194-2HM			0.75	170		108	140	0	18	122	0
102	1000064370	8541363141	13411	Gasket Spiral Wound		AISI 316, graphite filled CS centring-/SS inner ring		150#	50	0		14	28	0	40	0	12
103	1000064371	8541363181	11440	Gasket Spiral Wound		AISI 316, graphite filled CS centring-/SS inner ring		150#	80	0		4	8	0	8	0	0
104	1000064372	8541363201	11440	Gasket Spiral Wound		AISI 316, graphite filled CS centring-/SS inner ring		150#	100	0		8	16	0	14	2	0
105	1000064375	8541363281	11440	Gasket Spiral Wound		AISI 316, graphite filled CS centring-/SS inner ring		150#	250	0		2	4	0	4	0	0
106	1000064390	8541363701	31440X	Gasket Spiral Wound		AISI 316, graphite filled CS centring-/SS inner ring		300#	100	0		0	0	0	2	0	2
107	1000064391	8541363741	31440X	Gasket Spiral Wound		AISI 316, graphite filled CS centring-/SS inner ring		300#	150	0		6	12	0	20	0	8
108	1000064408	8541364041	31440X	Gasket Spiral Wound		AISI 316, graphite filled CS centring-/SS inner ring		300#	15	0		44	88	0	36	52	0
109	1000064409	8541364061	33411	Gasket Spiral Wound		AISI 316, graphite filled CS centring-/SS inner ring		300#	20	0		4	8	0	20	0	12
110	1000064410	8541364081	33421	Gasket Spiral Wound		AISI 316, graphite filled CS centring-/SS inner ring		300#	25	0		0	0	0	4	0	4
111	1000064412	8541364141	33421	Gasket Spiral Wound		AISI 316, graphite filled CS centring-/SS inner ring		300#	50	0		38	76	0	72	4	0
112	1000206450	8546030661	11440	Insulating Gasket		GRE G10 - Mylar	S80	150#	50	0		2	2	0	2	0	0
113	1000206482	8546030821	11440	Insulating Gasket		GRE G10 - Mylar	S80	150#	80	0		2	2	0	0	2	0
114	RQ/3002	NON MESC	31440X	Basket Strainer		Body: ASTM A105/A216-WCB/WCC Internal glass flake coating Trim: 25% Cr Duplex		300#	150	0		2	2	0	2	0	0
115	RQ/3007	NON MESC	31440X	Chemical Injection Qui		Body: ASTM A182 F55 UNS N32760/A995 Grade 6A Trim: SDSS, PTFE		300#	50	0		2	2	0	2	0	0
116	RQ/3013	NON MESC	13411	Elaflex Coupling		STAINLESS STEEL		150#	50	0		0	0	0	1	0	1

Civil Drawings

PAIP00405- Nimr Sludge Pit Up gradation.

PAIP00405

NIMR- SLUDGE PITS SYSTEMS UPGRADE

PROJECT - PAIP00405

CIVIL DRAWINGS - HOLD LIST:-

S. No.	ITEM	Piping GA Ref. Dwg. No.	REASON
	In Launcher Area		
1	2 Platforms coming on Existing Sludge pit.	NIM-3-2140-001-DQ & NIM-3-2142-001-DQ.	Pending pump support finalisation.
2	Monorail & its foundation.	NIM-3-2140-001-DQ & NIM-3-2142-001-DQ.	Pending Pump capacity.
3	Valve pit.	NIM-3-2141-001-DQ.	Size & location pending.
4	A48309 - Oxygen Scavenger Skid Foundation.	NIM-3-2141-001-DQ.	Pending vendor data finalisation.
5	Sunshade & IPS/UDB Foundation.	NIM-1-3710-001-DQ.	Pending vendor data finalisation.
6	PS 26 & 27 - Civil Dwg no. NIM-2-1842-032-DQ. PS 28 - Dwg no. NIM-2-1842-044-DQ. PS 33 - Dwg no. NIM-2-1842-052-DQ. PS 34 & 35 - Dwg no. NIM-2-1842-053-DQ.	NIM-3-2140-001-DQ & NIM-3-2142-001-DQ.	Elevation pending from vendor.



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Discipline Code: Civil				Current Revision Detail			Earlier Revision Detail		
Item#	Document No	Size	Description:	Rev#	Date:	Status:	Rev#	Date:	Status:
1	NIM-1-2635-200-DQ	A4	Drawing Control Index	A	27-FEB-11	AFC	0	26-FEB-11	IFC
2	NIM-2-0992-001-DQ	A1	FOUNDATION LOCATION PLAN	A	27-FEB-11	AFC	0	26-FEB-11	IFC
3	NIM-2-1841-001-DQ	A3	GENERAL NOTES - CONCRETE	A	27-FEB-11	AFC	0	26-FEB-11	IFC
4	NIM-2-1841-002-DQ	A3	GENERAL NOTES - STEEL	A	27-FEB-11	AFC	0	26-FEB-11	IFC
5	NIM-2-1841-003-DQ	A3	TYPICAL STAIR AND HANDRAILING	A	27-FEB-11	AFC	0	26-FEB-11	IFC
6	NIM-2-1841-004-DQ	A3	TYPICAL GRATING AND TREAD DETAILS	A	27-FEB-11	AFC	0	26-FEB-11	IFC
7	NIM-2-1841-005-DQ	A3	STANDARD BAR SHAPE CODES	A	27-FEB-11	AFC	0	26-FEB-11	IFC
8	NIM-2-1842-001-DQ	A3	PIPE SUPPORTS (LAUNCHER) INDEX SHEET	A	27-FEB-11	AFC	0	26-FEB-11	IFC
9	NIM-2-1842-002-DQ	A3	PIPE SUPPORTS	A	27-FEB-11	AFC	0	26-FEB-11	IFC
10	NIM-2-1842-003-DQ	A3	PIPE SUPPORTS-FOUNDATION DETAILS	A	27-FEB-11	AFC	0	26-FEB-11	IFC
11	NIM-2-1842-004-DQ	A4	BBS	A	27-FEB-11	AFC	0	26-FEB-11	IFC
12	NIM-2-1842-005-DQ	A3	PIPE SUPPORTS	A	27-FEB-11	AFC	0	26-FEB-11	IFC
13	NIM-2-1842-006-DQ	A3	PIPE SUPPORTS-FOUNDATION DETAILS	A	27-FEB-11	AFC	0	26-FEB-11	IFC
14	NIM-2-1842-007-DQ	A4	BBS	A	27-FEB-11	AFC	0	26-FEB-11	IFC
15	NIM-2-1842-008-DQ	A3	PIPE SUPPORTS	A	27-FEB-11	AFC	0	26-FEB-11	IFC
16	NIM-2-1842-009-DQ	A3	PIPE SUPPORTS-FOUNDATION DETAILS	A	27-FEB-11	AFC	0	26-FEB-11	IFC
17	NIM-2-1842-010-DQ	A4	BBS	A	27-FEB-11	AFC	0	26-FEB-11	IFC
18	NIM-2-1842-011-DQ	A3	PIPE SUPPORTS	A	27-FEB-11	AFC	0	26-FEB-11	IFC
19	NIM-2-1842-012-DQ	A3	PIPE SUPPORTS	A	27-FEB-11	AFC	0	26-FEB-11	IFC
20	NIM-2-1842-013-DQ	A3	PIPE SUPPORTS	A	27-FEB-11	AFC	0	26-FEB-11	IFC
21	NIM-2-1842-014-DQ	A3	PIPE SUPPORTS	A	27-FEB-11	AFC	0	26-FEB-11	IFC
22	NIM-2-1842-015-DQ	A3	PIPE SUPPORTS	A	27-FEB-11	AFC	0	26-FEB-11	IFC
23	NIM-2-1842-016-DQ	A3	PIPE SUPPORTS	A	27-FEB-11	AFC	0	26-FEB-11	IFC
24	NIM-2-1842-017-DQ	A3	PIPE SUPPORTS -'U' BOLT	A	27-FEB-11	AFC	0	26-FEB-11	IFC
25	NIM-2-1842-018-DQ	A3	PIPE SUPPORTS - PIPE GUIDE DETAILS	A	27-FEB-11	AFC	0	26-FEB-11	IFC
26	NIM-2-1842-020-DQ	A3	PIPE SUPPORTS-SLEEPER DETAILS	A	27-FEB-11	AFC	0	26-FEB-11	IFC
27	NIM-2-1842-021-DQ	A4	BBS	A	27-FEB-11	AFC	0	26-FEB-11	IFC
28	NIM-2-1842-022-DQ	A3	PIPE SUPPORTS-SLEEPER DETAILS	A	27-FEB-11	AFC	0	26-FEB-11	IFC
29	NIM-2-1842-023-DQ	A4	BBS	A	27-FEB-11	AFC	0	26-FEB-11	IFC



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Item#	Document No	Size	Description:	Rev#	Date:	Status:	Rev#	Date:	Status:
30	NIM-2-1842-024-DQ	A3	PIPE SUPPORTS-SLEEPER DETAILS	A	27-FEB-11	AFC	0	26-FEB-11	IFC
31	NIM-2-1842-025-DQ	A4	BBS	A	27-FEB-11	AFC	0	26-FEB-11	IFC
32	NIM-2-1842-026-DQ	A3	PIPE SUPPORTS-SLEEPER DETAILS	A	27-FEB-11	AFC	0	26-FEB-11	IFC
33	NIM-2-1842-027-DQ	A4	BBS	A	27-FEB-11	AFC	0	26-FEB-11	IFC
34	NIM-2-1842-028-DQ	A3	PIPE SUPPORTS (LAUNCHER) INDEX SHEET	A	27-FEB-11	AFC	0	26-FEB-11	IFC
35	NIM-2-1842-029-DQ	A3	PIPE SUPPORTS	A	27-FEB-11	AFC	0	26-FEB-11	IFC
36	NIM-2-1842-030-DQ	A3	PIPE SUPPORTS-FOUNDATION DETAILS	A	27-FEB-11	AFC	0	26-FEB-11	IFC
37	NIM-2-1842-031-DQ	A4	BBS	A	27-FEB-11	AFC	0	26-FEB-11	IFC
38	NIM-2-1842-032-DQ	A3	PIPE SUPPORTS	A	27-FEB-11	AFC	0	26-FEB-11	IFC
39	NIM-2-1842-033-DQ	A3	PIPE SUPPORTS	A	27-FEB-11	AFC	0	26-FEB-11	IFC
40	NIM-2-1842-034-DQ	A3	PIPE SUPPORTS	A	27-FEB-11	AFC	0	26-FEB-11	IFC
41	NIM-2-1842-035-DQ	A3	PIPE SUPPORTS - FOUNDATION DETAILS	A	27-FEB-11	AFC	0	26-FEB-11	IFC
42	NIM-2-1842-036-DQ	A4	BBS	A	27-FEB-11	AFC	0	26-FEB-11	IFC
43	NIM-2-1842-037-DQ	A3	PIPE SUPPORTS	A	27-FEB-11	AFC	0	26-FEB-11	IFC
44	NIM-2-1842-038-DQ	A3	PIPE SUPPORTS	A	27-FEB-11	AFC	0	26-FEB-11	IFC
45	NIM-2-1842-039-DQ	A3	PIPE SUPPORTS	A	27-FEB-11	AFC	0	26-FEB-11	IFC
46	NIM-2-1842-040-DQ	A3	PIPE SUPPORTS-FOUNDATION DETAILS	A	27-FEB-11	AFC	0	26-FEB-11	IFC
47	NIM-2-1842-041-DQ	A4	BBS	A	27-FEB-11	AFC	0	26-FEB-11	IFC
48	NIM-2-1842-042-DQ	A3	PIPE SUPPORTS	A	27-FEB-11	AFC	0	26-FEB-11	IFC
49	NIM-2-1842-043-DQ	A3	PIPE SUPPORTS	A	27-FEB-11	AFC	0	26-FEB-11	IFC
50	NIM-2-1842-044-DQ	A3	PIPE SUPPORTS	A	27-FEB-11	AFC	0	26-FEB-11	IFC
51	NIM-2-1842-045-DQ	A3	PIPE SUPPORTS-FOUNDATION DETAILS	A	27-FEB-11	AFC	0	26-FEB-11	IFC
52	NIM-2-1842-046-DQ	A4	BBS	A	27-FEB-11	AFC	0	26-FEB-11	IFC
53	NIM-2-1842-047-DQ	A3	PIPE SUPPORTS	A	27-FEB-11	AFC	0	26-FEB-11	IFC
54	NIM-2-1842-048-DQ	A3	PIPE SUPPORTS	A	27-FEB-11	AFC	0	26-FEB-11	IFC
55	NIM-2-1842-049-DQ	A3	PIPE SUPPORTS-FOUNDATION DETAILS	A	27-FEB-11	AFC	0	26-FEB-11	IFC
56	NIM-2-1842-050-DQ	A4	BBS	A	27-FEB-11	AFC	0	26-FEB-11	IFC
57	NIM-2-1842-051-DQ	A3	PIPE SUPPORTS	A	27-FEB-11	AFC	0	26-FEB-11	IFC
58	NIM-2-1842-052-DQ	A3	PIPE SUPPORTS	A	27-FEB-11	AFC	0	26-FEB-11	IFC



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59	NIM-2-1842-053-DQ	A3	PIPE SUPPORTS	A	27-FEB-11	AFC	0	26-FEB-11	IFC
60	NIM-2-1842-054-DQ	A3	PIPE SUPPORTS	A	27-FEB-11	AFC	0	26-FEB-11	IFC
61	NIM-2-1842-055-DQ	A3	PIPE SUPPORTS	A	27-FEB-11	AFC	0	26-FEB-11	IFC
62	NIM-2-1842-056-DQ	A3	PIPE SUPPORTS-FOUNDATION DETAILS	A	27-FEB-11	AFC	0	26-FEB-11	IFC
63	NIM-2-1842-057-DQ	A4	BBS	A	27-FEB-11	AFC	0	26-FEB-11	IFC
64	NIM-2-1842-058-DQ	A3	PIPE SUPPORTS	A	27-FEB-11	AFC	0	26-FEB-11	IFC
65	NIM-2-1842-059-DQ	A3	PIPE SUPPORTS	A	27-FEB-11	AFC	0	26-FEB-11	IFC
66	NIM-2-1842-060-DQ	A3	PIPE SUPPORTS	A	27-FEB-11	AFC	0	26-FEB-11	IFC
67	NIM-2-1842-061-DQ	A3	PIPE SUPPORTS	A	27-FEB-11	AFC	0	26-FEB-11	IFC
68	NIM-2-1842-062-DQ	A3	PIPE SUPPORTS-FOUNDATION DETAILS	A	27-FEB-11	AFC	0	26-FEB-11	IFC
69	NIM-2-1842-063-DQ	A4	BBS	A	27-FEB-11	AFC	0	26-FEB-11	IFC
70	NIM-2-1842-064-DQ	A3	PIPE SUPPORTS - 'U' BOLT DETAILS	A	27-FEB-11	AFC	0	26-FEB-11	IFC
71	NIM-2-1842-065-DQ	A3	PIPE SUPPORTS PIPE CLAMP WITH SHOW AND LINE STOP DETAILS	A	27-FEB-11	AFC	0	26-FEB-11	IFC
72	NIM-2-1842-066-DQ	A3	PIPE SUPPORTS PIPE GUIDE DETAILS	A	27-FEB-11	AFC	0	26-FEB-11	IFC
73	NIM-2-1842-067-DQ	A3	PIPE SUPPORTS LINE STOP DETAILS	A	27-FEB-11	AFC	0	26-FEB-11	IFC
74	NIM-2-1842-068-DQ	A3	PIPE SUPPORTS PIPE SHOE DETAILS	A	27-FEB-11	AFC	0	26-FEB-11	IFC
75	NIM-2-1842-069-DQ	A3	PIPE SUPPORTS PIPE SHOE GUIDE DETAILS	A	27-FEB-11	AFC	0	26-FEB-11	IFC
76	NIM-2-1842-070-DQ	A3	PIPE SUPPORTS PIPE CLIP (HEAVY) DETAILS	A	27-FEB-11	AFC	0	26-FEB-11	IFC
77	NIM-2-1843-001-DQ	A3	CIVIL DETAILS SPILL PIT & HARD STRAND	A	27-FEB-11	AFC	0	26-FEB-11	IFC
78	NIM-2-1844-001-DQ	A1	STRUCTURAL STEEL DETAILS PLATFORM MK'D P1	A	27-FEB-11	AFC	0	26-FEB-11	IFC
79	NIM-2-1844-002-DQ	A3	CIVIL DETAILS PLATFORM FOUNDATION MK'D PF1	A	27-FEB-11	AFC	0	26-FEB-11	IFC
80	NIM-2-1844-003-DQ	A4	BBS	A	27-FEB-11	AFC	0	26-FEB-11	IFC
81	NIM-2-1844-004-DQ	A3	CIVIL DETAILS STAIR FOUNDATION MK'D SF1	A	27-FEB-11	AFC	0	26-FEB-11	IFC
82	NIM-2-1844-005-DQ	A4	BBS	A	27-FEB-11	AFC	0	26-FEB-11	IFC
83	NIM-2-1844-006-DQ	A3	STRUCTURAL STEEL DETAILS CROSS OVER-CO1	A	27-FEB-11	AFC	0	26-FEB-11	IFC
84	NIM-2-1844-007-DQ	A1	STRUCTURAL STEEL DETAILS CROSS OVER MK'D-CO2	A	27-FEB-11	AFC	0	26-FEB-11	IFC
85	NIM-2-1844-008-DQ	A3	CIVIL DETAILS CROSS OVER FOUNDATION MK'D CF2	A	27-FEB-11	AFC	0	26-FEB-11	IFC
86	NIM-2-1844-009-DQ	A4	BBS	A	27-FEB-11	AFC	0	26-FEB-11	IFC



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Item#	Document No	Size	Description:	Rev#	Date:	Status:	Rev#	Date:	Status:
87	NIM-2-1844-010-DQ	A1	STRUCTURAL STEEL DETAILS PLATFORM MK'D P1&P2	A	27-FEB-11	AFC	0	26-FEB-11	IFC
88	NIM-2-1844-011-DQ	A3	CIVIL DETAILS FOUNDATION DETAILS MK'D PF1	A	27-FEB-11	AFC	0	26-FEB-11	IFC
89	NIM-2-1844-012-DQ	A4	BBS	A	27-FEB-11	AFC	0	26-FEB-11	IFC
90	NIM-2-1844-013-DQ	A3	CIVIL DETAILS STAIR FOUNDATION MK'D SF1	A	27-FEB-11	AFC	0	26-FEB-11	IFC
91	NIM-2-1844-014-DQ	A4	BBS	A	27-FEB-11	AFC	0	26-FEB-11	IFC
92	NIM-2-1845-001-DQ	A1	CONCRETE STRUCTURE G.A. & REINFT. DET'S. FOR ROA	A	27-FEB-11	AFC	0	26-FEB-11	IFC
			CULVERT No.5						
93	NIM-2-1845-002-DQ	A4	BBS	A	27-FEB-11	AFC	0	26-FEB-11	IFC
94	NIM-2-1845-003-DQ	A1	CONCRETE STRUCTURE G.A. & REINFT. DET'S. FOR ROA	A	27-FEB-11	AFC	0	26-FEB-11	IFC
			CULVERT No.2A						
95	NIM-2-1845-004-DQ	A4	BBS	A	27-FEB-11	AFC	0	26-FEB-11	IFC
96	NIM-2-1845-005-DQ	A1	LAYOUT G.A. OF CULVERT No.1	A	27-FEB-11	AFC	0	26-FEB-11	IFC
97	NIM-2-1845-006-DQ	A1	CONCRETE STRUCTURE G.A. & REINFT. DET'S. FOR ROA	A	27-FEB-11	AFC	0	26-FEB-11	IFC
			CULVERT No.1						
98	NIM-2-1845-007-DQ	A4	BBS	A	27-FEB-11	AFC	0	26-FEB-11	IFC
99	NIM-2-1845-008-DQ	A1	LAYOUT G.A. OF CULVERT No.2	A	27-FEB-11	AFC	0	26-FEB-11	IFC
100	NIM-2-1845-009-DQ	A1	CONCRETE STRUCTURE G.A. & REINFT. DET'S. FOR ROA	A	27-FEB-11	AFC	0	26-FEB-11	IFC
			CULVERT No.2						
101	NIM-2-1845-010-DQ	A4	BBS	A	27-FEB-11	AFC	0	26-FEB-11	IFC
102	NIM-2-1845-011-DQ	A1	LAYOUT G.A. OF CULVERT No.3 & 4	A	27-FEB-11	AFC	0	26-FEB-11	IFC
103	NIM-2-1845-012-DQ	A1	CONCRETE STRUCTURE G.A. & REINFT. DET'S. FOR ROA	A	27-FEB-11	AFC	0	26-FEB-11	IFC
			CULVERT No.3 & 4.						
104	NIM-2-1845-013-DQ	A4	BBS	A	27-FEB-11	AFC	0	26-FEB-11	IFC
105	NIM-2-1846-001-DQ	A3	CIVIL DETAILS BENCH MARK DETAILS MK'D BM 1	A	27-FEB-11	AFC	0	26-FEB-11	IFC
106	NIM-2-1846-002-DQ	A1	CIVIL DETAILS WINDSOCK DETAILS	A	27-FEB-11	AFC	0	26-FEB-11	IFC
107	NIM-2-5166-001-DQ	A1	FOUNDATION LAYOUT	A	27-FEB-11	AFC	0	26-FEB-11	IFC
108	NIM-2-5167-001-DQ	A1	FOUNDATION LAYOUT	A	27-FEB-11	AFC	0	26-FEB-11	IFC
109	NIM-2-5210-001-DQ	A1	FOUNDATION LAYOUT	A	27-FEB-11	AFC	0	26-FEB-11	IFC
110	NIM-2-5604-001-DQ	A1	FOUNDATION LAYOUT	A	27-FEB-11	AFC	0	26-FEB-11	IFC
111	NIM-2-5604-005-DQ	A1	FOUNDATION LAYOUT	A	27-FEB-11	AFC	0	26-FEB-11	IFC



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Item#	Document No	Size	Description:	Rev#	Date:	Status:	Rev#	Date:	Status:
112	NIM-2-5771-001-DQ	A3	GENERAL NOTES - CONCRETE	A	27-FEB-11	AFC	0	26-FEB-11	IFC
113	NIM-2-5771-002-DQ	A3	GENERAL NOTES - STEEL	A	27-FEB-11	AFC	0	26-FEB-11	IFC
114	NIM-2-5771-003-DQ	A3	TYPICAL STAIR AND HANDRAILING	A	27-FEB-11	AFC	0	26-FEB-11	IFC
115	NIM-2-5771-004-DQ	A3	TYPICAL GRATING AND TREAD DETAILS	A	27-FEB-11	AFC	0	26-FEB-11	IFC
116	NIM-2-5771-005-DQ	A3	STANDARD BAR SHAPE CODES	A	27-FEB-11	AFC	0	26-FEB-11	IFC
117	NIM-2-5771-006-DQ	A3	TYPICAL LADDER DETAILS (FRONT ENTRY)	A	27-FEB-11	AFC	0	26-FEB-11	IFC
118	NIM-2-5772-001-DQ	A3	PIPE SUPPORTS (RECEIVER) INDEX SHEET	A	27-FEB-11	AFC	0	26-FEB-11	IFC
119	NIM-2-5772-002-DQ	A3	PIPE SUPPORTS (RECEIVER) INDEX SHEET	A	27-FEB-11	AFC	0	26-FEB-11	IFC
120	NIM-2-5772-003-DQ	A3	PIPE SUPPORTS	A	27-FEB-11	AFC	0	26-FEB-11	IFC
121	NIM-2-5772-004-DQ	A3	PIPE SUPPORTS-FOUNDATION DETAILS	A	27-FEB-11	AFC	0	26-FEB-11	IFC
122	NIM-2-5772-005-DQ	A4	BBS	A	27-FEB-11	AFC	0	26-FEB-11	IFC
123	NIM-2-5772-006-DQ	A3	PIPE SUPPORTS	A	27-FEB-11	AFC	0	26-FEB-11	IFC
124	NIM-2-5772-007-DQ	A3	PIPE SUPPORTS	A	27-FEB-11	AFC	0	26-FEB-11	IFC
125	NIM-2-5772-008-DQ	A3	PIPE SUPPORTS	A	27-FEB-11	AFC	0	26-FEB-11	IFC
126	NIM-2-5772-009-DQ	A3	PIPE SUPPORTS	A	27-FEB-11	AFC	0	26-FEB-11	IFC
127	NIM-2-5772-010-DQ	A3	PIPE SUPPORTS-FOUNDATION DETAILS	A	27-FEB-11	AFC	0	26-FEB-11	IFC
128	NIM-2-5772-011-DQ	A4	BBS	A	27-FEB-11	AFC	0	26-FEB-11	IFC
129	NIM-2-5772-012-DQ	A3	PIPE SUPPORTS	A	27-FEB-11	AFC	0	26-FEB-11	IFC
130	NIM-2-5772-013-DQ	A3	PIPE SUPPORTS	A	27-FEB-11	AFC	0	26-FEB-11	IFC
131	NIM-2-5772-014-DQ	A3	PIPE SUPPORTS	A	27-FEB-11	AFC	0	26-FEB-11	IFC
132	NIM-2-5772-015-DQ	A3	PIPE SUPPORTS	A	27-FEB-11	AFC	0	26-FEB-11	IFC
133	NIM-2-5772-016-DQ	A3	PIPE SUPPORTS	A	27-FEB-11	AFC	0	26-FEB-11	IFC
134	NIM-2-5772-017-DQ	A3	PIPE SUPPORTS	A	27-FEB-11	AFC	0	26-FEB-11	IFC
135	NIM-2-5772-018-DQ	A4	BBS	A	27-FEB-11	AFC	0	26-FEB-11	IFC
136	NIM-2-5772-019-DQ	A3	PIPE SUPPORTS	A	27-FEB-11	AFC	0	26-FEB-11	IFC
137	NIM-2-5772-020-DQ	A3	PIPE SUPPORTS	A	27-FEB-11	AFC	0	26-FEB-11	IFC
138	NIM-2-5772-021-DQ	A3	PIPE SUPPORTS	A	27-FEB-11	AFC	0	26-FEB-11	IFC
139	NIM-2-5772-022-DQ	A3	PIPE SUPPORTS	A	27-FEB-11	AFC	0	26-FEB-11	IFC
140	NIM-2-5772-023-DQ	A3	PIPE SUPPORTS	A	27-FEB-11	AFC	0	26-FEB-11	IFC



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Client : Petroleum Development Oman LLC (PDO)

Index Doc. No.:

Job No. : PAIP00405

Phase: DD

Job Title : Nimr Sludge Pits System upgrade - FED & DD

Discipline Code: Civil				Current Revision Detail			Earlier Revision Detail		
Item#	Document No	Size	Description:	Rev#	Date:	Status:	Rev#	Date:	Status:
141	NIM-2-5772-024-DQ	A3	PIPE SUPPORTS-SLEEPER DETAILS	A	27-FEB-11	AFC	0	26-FEB-11	IFC
142	NIM-2-5772-025-DQ	A4	BBS	A	27-FEB-11	AFC	0	26-FEB-11	IFC
143	NIM-2-5772-026-DQ	A3	PIPE SUPPORTS-SLEEPER DETAILS	A	27-FEB-11	AFC	0	26-FEB-11	IFC
144	NIM-2-5772-027-DQ	A4	BBS	A	27-FEB-11	AFDD	0	26-FEB-11	IFC
145	NIM-2-5772-028-DQ	A3	PIPE SUPPORTS-SLEEPER DETAILS	A	27-FEB-11	AFC	0	26-FEB-11	IFC
146	NIM-2-5772-029-DQ	A4	BBS	A	27-FEB-11	AFC	0	26-FEB-11	IFC
147	NIM-2-5772-030-DQ	A3	PIPE SUPPORTS-SLEEPER DETAILS	A	27-FEB-11	AFC	0	26-FEB-11	IFC
148	NIM-2-5772-031-DQ	A4	BBS	A	27-FEB-11	AFC	0	26-FEB-11	IFC
149	NIM-2-5772-032-DQ	A3	PIPE SUPPORTS (RECEIVER) INDEX SHEET	A	27-FEB-11	AFC	0	26-FEB-11	IFC
150	NIM-2-5772-033-DQ	A3	PIPE SUPPORTS	A	27-FEB-11	AFC	0	26-FEB-11	IFC
151	NIM-2-5772-034-DQ	A3	PIPE SUPPORTS-FOUNDATION DETAILS	A	27-FEB-11	AFC	0	26-FEB-11	IFC
152	NIM-2-5772-035-DQ	A4	BBS	A	27-FEB-11	AFC	0	26-FEB-11	IFC
153	NIM-2-5772-036-DQ	A3	PIPE SUPPORTS	A	27-FEB-11	AFC	0	26-FEB-11	IFC
154	NIM-2-5772-037-DQ	A3	PIPE SUPPORTS-FOUNDATION DETAILS	A	27-FEB-11	AFC	0	26-FEB-11	IFC
155	NIM-2-5772-038-DQ	A4	BBS	A	27-FEB-11	AFC	0	26-FEB-11	IFC
156	NIM-2-5772-039-DQ	A3	PIPE SUPPORTS	A	27-FEB-11	AFC	0	26-FEB-11	IFC
157	NIM-2-5772-040-DQ	A3	PIPE SUPPORTS-FOUNDATION DETAILS	A	27-FEB-11	AFC	0	26-FEB-11	IFC
158	NIM-2-5772-041-DQ	A4	BBS	A	27-FEB-11	AFC	0	26-FEB-11	IFC
159	NIM-2-5772-042-DQ	A3	PIPE SUPPORTS	A	27-FEB-11	AFC	0	26-FEB-11	IFC
160	NIM-2-5772-043-DQ	A3	PIPE SUPPORTS-FOUNDATION DETAILS	A	27-FEB-11	AFC	0	26-FEB-11	IFC
161	NIM-2-5772-044-DQ	A4	BBS	A	27-FEB-11	AFC	0	26-FEB-11	IFC
162	NIM-2-5772-045-DQ	A3	PIPE SUPPORTS	A	27-FEB-11	AFC	0	26-FEB-11	IFC
163	NIM-2-5772-046-DQ	A3	PIPE SUPPORTS	A	27-FEB-11	AFC	0	26-FEB-11	IFC
164	NIM-2-5772-047-DQ	A3	PIPE SUPPORTS-TRUNNION	A	27-FEB-11	AFC	0	26-FEB-11	IFC
165	NIM-2-5772-048-DQ	A3	PIPE SUPPORTS	A	27-FEB-11	AFC	0	26-FEB-11	IFC
166	NIM-2-5772-049-DQ	A3	PIPE SUPPORTS-FOUNDATION DETAILS	A	27-FEB-11	AFC	0	26-FEB-11	IFC
167	NIM-2-5772-050-DQ	A4	BBS	A	27-FEB-11	AFC	0	26-FEB-11	IFC
168	NIM-2-5772-051-DQ	A3	PIPE SUPPORTS	A	27-FEB-11	AFC	0	26-FEB-11	IFC
169	NIM-2-5772-052-DQ	A3	PIPE SUPPORTS	A	27-FEB-11	AFC	0	26-FEB-11	IFC



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Client : Petroleum Development Oman LLC (PDO)



Index Doc. No.:

Job No. : PAIP00405

Phase: DD

Job Title : Nimr Sludge Pits System upgrade - FED & DD

Discipline Code: Civil				Current Revision Detail			Earlier Revision Detail		
Item#	Document No	Size	Description:	Rev#	Date:	Status:	Rev#	Date:	Status:
170	NIM-2-5772-053-DQ	A3	PIPE SUPPORTS-SLEEPER DETAILS	A	27-FEB-11	AFC	0	26-FEB-11	IFC
171	NIM-2-5772-054-DQ	A3	BBS	A	27-FEB-11	AFC	0	26-FEB-11	IFC
172	NIM-2-5772-055-DQ	A3	PIPE SUPPORTS 'U' BOLT(PIPE NOT GRIPPED)	A	27-FEB-11	AFC	0	26-FEB-11	IFC
173	NIM-2-5773-001-DQ	A3	CIVIL DETAILS SPILL PIT & HARD STRAND	A	27-FEB-11	AFC	0	26-FEB-11	IFC
174	NIM-2-5774-001-DQ	A1	CIVIL DETAILS DRAIN PIT	A	27-FEB-11	AFC	0	26-FEB-11	IFC
175	NIM-2-5774-002-DQ	A4	BBS	A	27-FEB-11	AFC	0	26-FEB-11	IFC
176	NIM-2-5774-003-DQ	A1	CIVIL DETAILS FLANGE PIT	A	27-FEB-11	AFC	0	26-FEB-11	IFC
177	NIM-2-5774-004-DQ	A3	CIVIL DETAILS HARD STAND	A	27-FEB-11	AFC	0	26-FEB-11	IFC
178	NIM-2-5774-005-DQ	A1	CIVIL DETAILS FLANGE PIT	A	27-FEB-11	AFC	0	26-FEB-11	IFC
179	NIM-2-5774-006-DQ	A3	CIVIL DETAILS COLLECTION PIT	A	27-FEB-11	AFC	0	26-FEB-11	IFC
180	NIM-2-5775-001-DQ	A1	STRUCTURAL STEEL DETAILS PLATFORM MK'D P1	A	27-FEB-11	AFC	0	26-FEB-11	IFC
181	NIM-2-5775-002-DQ	A3	CIVIL DETAILS PLATFORM FOUNDATION MK'D PF1	A	27-FEB-11	AFC	0	26-FEB-11	IFC
182	NIM-2-5775-003-DQ	A4	BBS	A	27-FEB-11	AFC	0	26-FEB-11	IFC
183	NIM-2-5775-004-DQ	A3	CIVIL DETAILS STAIR FOUNDATION MK'D SF1	A	27-FEB-11	AFC	0	26-FEB-11	IFC
184	NIM-2-5775-005-DQ	A4	BBS	A	27-FEB-11	AFC	0	26-FEB-11	IFC
185	NIM-2-5775-006-DQ	A1	STRUCTURAL STEEL DETAILS PLATFORM MK'D P1	A	27-FEB-11	AFC	0	26-FEB-11	IFC
186	NIM-2-5775-007-DQ	A3	CIVIL DETAILS FOUNDATION DETAILS MK'D PF1	A	27-FEB-11	AFC	0	26-FEB-11	IFC
187	NIM-2-5775-008-DQ	A4	BBS	A	27-FEB-11	AFC	0	26-FEB-11	IFC
188	NIM-2-5775-009-DQ	A1	STRUCTURAL STEEL DETAILS PLATFORM MK'D P2	A	27-FEB-11	AFC	0	26-FEB-11	IFC
189	NIM-2-5775-010-DQ	A3	CIVIL DETAILS STAIR FOUNDATION MK'D SF1	A	27-FEB-11	AFC	0	26-FEB-11	IFC
190	NIM-2-5775-011-DQ	A4	BBS	A	27-FEB-11	AFC	0	26-FEB-11	IFC

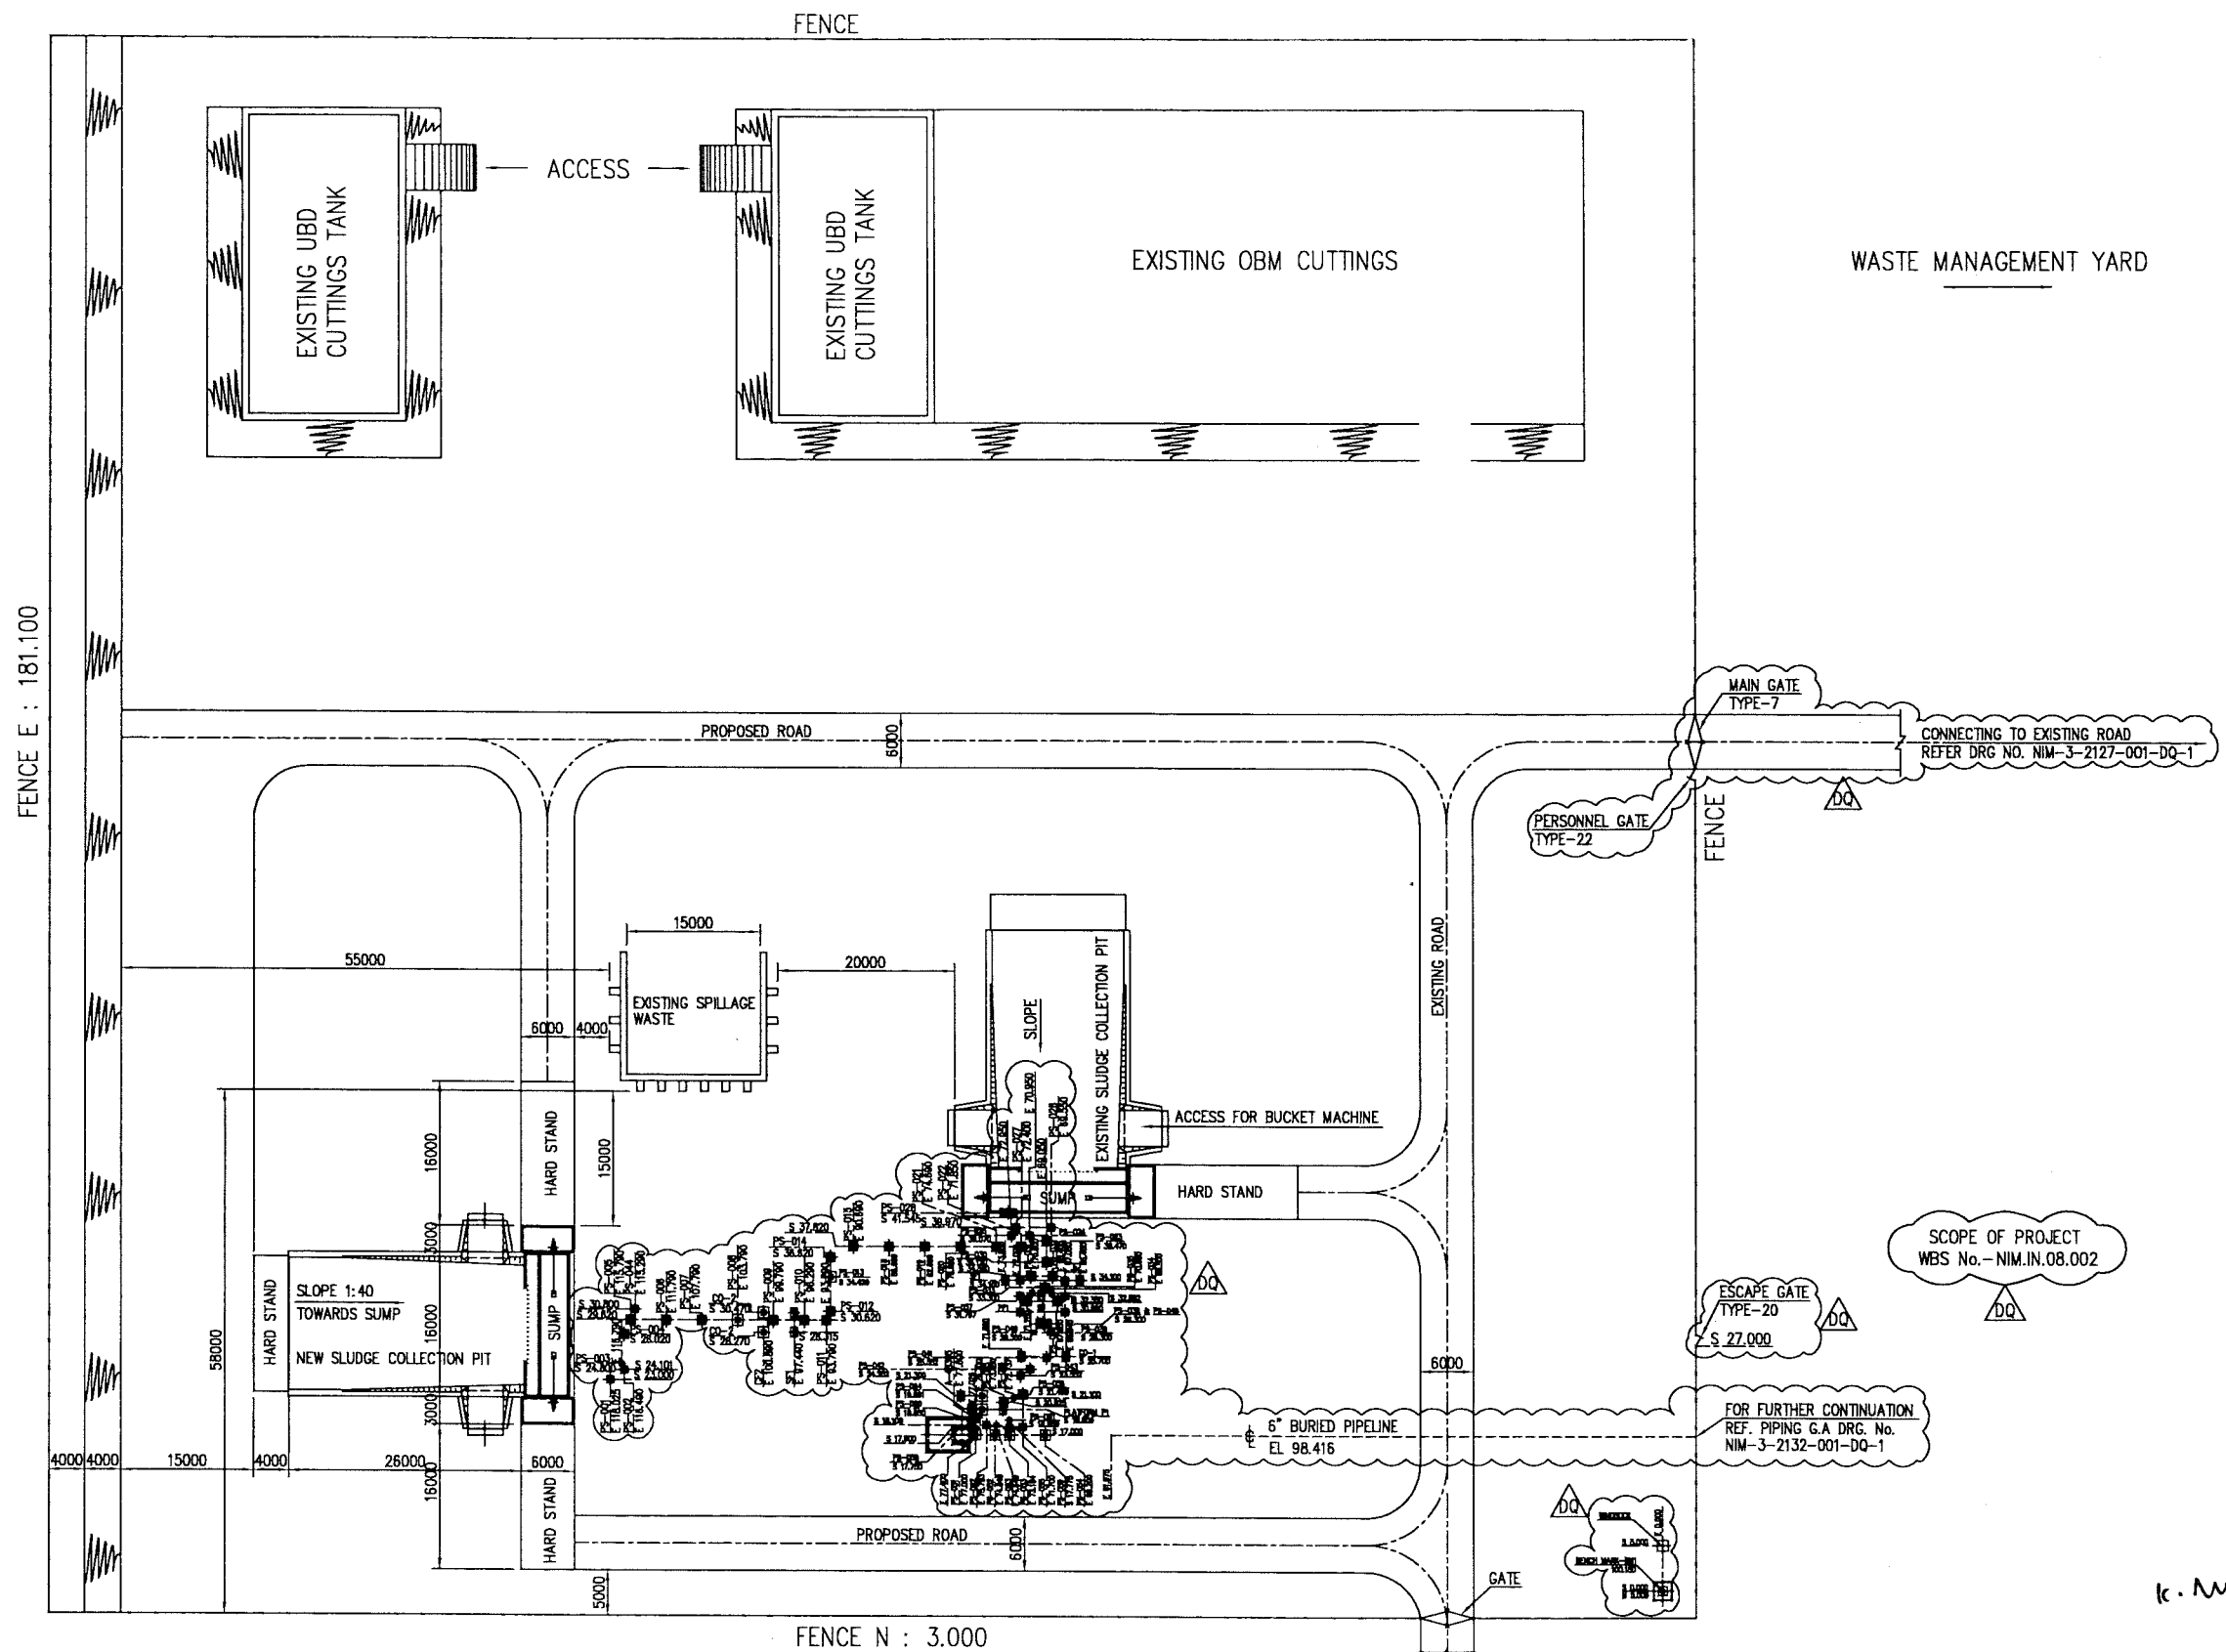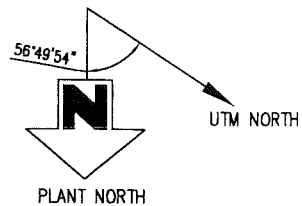

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T A 2

APPROVED FOR
CONSTRUCTION

ESCAPE GATE TYPE-20	STD	2	1625	020	1
WIND SOCK DETAIL	NIM	2	1846	002	DQ 1
BENCH MARK DETAIL	NIM	2	1846	001	DQ 3
STAIR FDN. SF1	NIM	2	1844	004	DQ 3
PLATFORM FDN. PF1	NIM	2	1844	002	DQ 3
PERSONNEL GATE TYPE-22	STD	2	1625	022	3
MAIN GATE TYPE-7	STD	2	1625	007	3
HARD STAND PIG LAUNCHER	NIM	2	1843	001	DQ 3
PIPE SUPPORTS INDEX SHEET	NIM	2	1842	001	DQ 3
SLUDGE COLLECTION FACILITY, G.A. & DETAILS.	NIM	2	0993	001	1

2. GRADE ELEVATION 100.000 m. IS EQUAL TO EL HOLD ABOVE M.S.L.
1. ALL DIMENSIONS ARE IN MILLIMETERS.

NOTES

REFERENCE DRAWINGS

MASTER DRAWING REVISION

IN CASE OF DEVIATIONS MARKED UP PRINT SHALL BE SENT TO COASTAL DESIGN OFFICE

REV	DATE	DESIGNED BY	CHECKED	DESCRIPTION	WBS NO	PROJ. ENCL.	SIGNATURE
A	27.02.11	GCS	20	APPROVED FOR CONSTRUCTION		IN.09.01	OSE/28N
O	28.02.11	GCS	KBR	ISSUED FOR COMMENTS		IN.09.01	OSE/28N
PROJECT DRAWING REVISION							
IN CASE OF DEVIATIONS A MARKED UP PRINT SHALL BE SENT TO THE PROJECT ENGINEER							
AREA	NIMR			NO. 16	شركة تنمية نفط عمان		
SUB AREA	CONTR. IND. & RES. AREA			NO. 16	Petrochem Development Oman		
DRWG TYPE	FOUNDATION LOCATION PLAN			NO. 16	NIM 2 0992 001 DQ 1 A		
DESCRIPTION	NEW SLUDGE COLLECTION PIT SITUATED IN WASTE MANAGEMENT YARD			NO. 16	NIM 2 0992 001 DQ 1 A		

1.0 GENERAL NOTES

- 1.1 ALL WORK SHALL BE CARRIED OUT IN ACCORDANCE WITH CONSTRUCTION CONTRACT AND / OR CIVIL AND BUILDING CONSTRUCTION SPECIFICATIONS SP-1279 AND GUIDE TO CONCRETE CONSTRUCTION SP-1282.
- 1.2 ALL DIMENSIONS ARE IN MILLIMETERS EXCEPT FOR PIPE SIZES WHICH ARE SHOWN IN INCHES.
- 1.3 ALL ELEVATIONS ARE IN METERS AND RELATED TO DATUM ELEVATION OF 100.000

2.0 EXCAVATION, TRENCHING AND BACKFILL

- 2.1 BACKFILL FOR FOUNDATIONS, WALLS, TRENCHES AND SITE GRADING SHALL BE PLACED IN EVEN LAYERS (SUCH THAT COMPACTED THICKNESS DOES NOT EXCEED 150mm) AND THE FULL WIDTH OF THE FORMATION. THE FILL SHALL BE GRADED AS SHOWN BELOW.

BS SEIVE SIZE	% PASSING BY WEIGHT
50.00 mm	100%
9.50 mm	60%-100%
5.00 mm	50%-85%
2.00 mm	40%-70%
425 μ m	25%-45%
75 μ m	8%-15%

ALL FILL MATERIAL INCLUDING SUBGRADE AND VERGES SHALL BE COMPACTED TO 95% OF THE MAXIMUM DRY DENSITY OBTAINED IN THE MODIFIED AASHTO COMPACTION TEST.

- 2.2 ALL UNDERGROUND CABLES EXCEPT EARTHING CABLES SHALL BE LAID AT A MINIMUM DEPTH OF 600mm.
- 2.3 INSTRUMENTATION CABLES SHALL NOT BE LAID IN THE SAME TRENCH WITH POWER AND LIGHTING CABLES.
- 2.4 ALL BURIED CABLES SHALL BE LAID IN SUCH A WAY THAT THE FILLING MATERIAL WITHIN 100mm FROM THE CABLES SHALL BE FREE OF STONES OR OTHER MATERIALS WHICH MAY DAMAGE THE CABLES. SUITABLE FILL, SUCH AS CLEAN SMALL-GRAINED SAND SHALL BE USED FOR THIS PURPOSE. THE CABLES SHALL BE PROTECTED BY SUITABLE SLABS OR TILES WHICH SHALL FORM A CONTINUOUS BUT REMOVABLE COVERING 200mm ABOVE THE HIGHEST CABLE.
- 2.5 WHERE CROSSING OF INSTRUMENTATION WITH POWER AND LIGHTING CABLES IS UNAVOIDABLE, INSTRUMENTATION CABLE SHALL BE LAID ABOVE AND SHALL BE KEPT AT A MINIMUM DISTANCE OF 750mm FROM POWER AND LIGHTING CABLES.

3.0 FOUNDATION WORKS

- 3.1 THE FOUNDATIONS FOR BUILDINGS, EQUIPMENT, STEEL STRUCTURES AND PIPE SUPPORTS WHEREVER SPECIFIED ON DRAWINGS SHALL BE LAID ON 2 COATS OF FOSROC'S 'NITOCOTE PE 135' GLASS MAT SPREAD OVER BLINDING CONCRETE. THE SIDES AND TOP OF CONCRETE FOUNDATION IN CONTACT WITH SOIL AND UPTO 250mm ABOVE GRADE SHALL BE APPLIED WITH FOSROC'S 'NITOCOTE PE 135' IN 2 COATS WITH EACH COAT MEASURING 600 MICRON THICKNESS. WHILE THE FIRST COAT IS STILL WET, APPLY 120-150 gsm GLASS MAT ON THE SURFACE AND ROLL OVER TO ENSURE THE MAT IS FULLY EMBEDDED. MASTER SEAL 550 MANUFACTURED BY DEGUSSA OR ANY OTHER PDO APPROVED EQUIVALENT IN PLACE OF 'NITOCOTE PE 135'. APPLICATION SHALL BE AS PER RESPECTIVE MANUFACTURER'S INSTRUCTIONS.
- 3.2 BEFORE POURING CONCRETE, THE FIELD SHALL MAKE PROVISION FOR THE INSTALLATION OF ALL UNDERGROUND SERVICES AFFECTED BY THE FOUNDATIONS.
- 3.3 BEFORE CASTING FOUNDATIONS, ANY IMMEDIATE OR ADJACENT AREAS OF DISTURBED OR SOFT SOIL MUST BE REMOVED AND REPLACED WITH MASS CONCRETE OF GRADE 10.
- 3.4 ALL EXPOSED PORTIONS OF FOUNDATION CONCRETE AND INSIDE SURFACES OF RCC PITS, WHEREVER NOT SPECIFICALLY SPECIFIED, SHALL BE COATED WITH 'FOSROC DEKGUARD S' OR EQUIVALENT.

4.0 CONCRETE


- 4.1 ALL CONCRETE WORK SHALL BE CARRIED OUT IN ACCORDANCE WITH CODE OF PRACTICE FOR THE STRUCTURAL USE OF CONCRETE: BS 8110 INCLUDING ALL RELATED CODES FOR PLACING, MIXING, CURING AND TESTING.
- 4.2 A LAYER OF BLINDING CONCRETE 50mm THK SHALL BE PLACED UNDER ALL FOUNDATIONS. BLINDING CONCRETE SHALL HAVE A CHARACTERISTIC STRENGTH OF 10 N/mm² AT 28 DAYS.
- 4.3 ALL CONCRETE WITH THE EXCEPTION OF BLINDING CONCRETE SHALL OF GRADE AS SPECIFIED IN THE RESPECTIVE DETAILED DRAWINGS AND SHALL NOT BE LOWER THAN GRADE 35 CONCRETE WITH 'CORTEC MCI 2005' CORROSION INHIBITOR AT A RATE OF 0.6 lit/m³ OR EQUIVALENT. MIXING SHALL BE AS PER MANUFACTURER INSTRUCTIONS.
- 4.4 FOR ALL CONCRETE WORKS, ORDINARY PORTLAND CEMENT TO BS EN 197 SHALL BE USED, UNLESS OTHERWISE SPECIFIED.
MAXIMUM FREE WATER CEMENT RATIO SHALL BE 0.45
MINIMUM CEMENT CONTENT FOR 20mm AGGREGATE SHALL BE 370 kg/m³.
FOR 40mm AGGREGATE SHALL BE 340 kg/m³.

- 4.5 ALL EDGES OF EXPOSED AND BURIED CONCRETE MEMBERS SHALL HAVE CHAMFER OF APPROXIMATELY 25mm.
- 4.6 HOT-ROLLED DEFORMED HIGH-YIELD BARS GRADE 460 WITH A SPECIFIED CHARACTERISTIC STRENGTH OF 460 N/mm² SHALL BE USED AS REINFORCEMENT FOR ALL CONCRETE WORKS. HOT-ROLLED MILD STEEL BARS GRADE 250 WITH A SPECIFIED CHARACTERISTIC STRENGTH OF 250 N/mm² SHALL BE USED WHERE SPECIFIED.
- 4.7 NOMINAL COVER TO ALL REINFORCEMENT (INCLUDING LINKS) UNLESS SPECIFIED OTHERWISE SHALL BE
 - 1) FOUNDATIONS, COLUMNS, BEAMS, SLABS AND WALLS IN CONTACT WITH SOIL OR EXPOSED TO WEATHER. - 50 mm
 - 2) COLUMNS, BEAMS AND WALLS NEITHER IN CONTACT WITH SOIL NOR EXPOSED TO WEATHER. - 40 mm
 - 3) BUILDING FLOOR SLABS & ROOF SLABS - 25 mm
- 4.8 UNLESS NOTED OTHERWISE ON THE DRAWING FOLLOWING MINIMUM LAP LENGTHS SHALL BE USED.

SIZE	LAP LENGTH*
T8	450
T10	550
T12	650
T16	850
T20	1050
T25	1300
T32	1650

* - SPECIFIED TO THE NEAREST 25 mm.

- 4.9 LEGEND FOR REINFORCEMENT OF HOT-ROLLED MILD STEEL AND HOT ROLLED DEFORMED HIGH YIELD STRESS BARS.

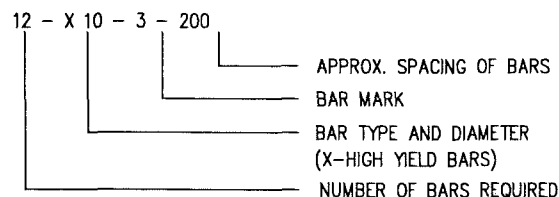

5.0 ANCHOR BOLTS

- 5.1 ALL ANCHOR BOLTS AND NUTS SHALL CONFORM TO A 307-B OR DIN 267 4.6 OR BS 970 070 M20 UNLESS SPECIFIED OTHERWISE. ALL WASHERS SHALL BE ACCORDING TO BS 4320. ALL THREADING SHALL BE ISO METRIC THREAD CONFORMING TO BS 3643.
- 5.2 ALL PROJECTIONS OF HOLDING DOWN BOLTS (ANCHOR BOLTS) ARE TAKEN FROM TOP OF ROUGH CONCRETE.
- 5.3 STYROPOR OR SIMILAR APPROVED MATERIAL FOR FORMING THE (ANCHOR) BOLT POCKETS SHALL BE SECURED AGAINST ANY MOVEMENT DURING CONSTRUCTION AND REMOVED AS SOON AS THE CONCRETE IS SET.

6.0 GROUTING

- 6.1 ALL GROUTING REQUIRES PRIOR APPROVAL BY ENGINEER BEFORE GROUTING. THE SURFACE SHALL BE CLEANED AND SOAKED WITH WATER.
- 6.2 GROUT MORTAR SHALL CONSIST OF ONE PART OF ORDINARY PORTLAND CEMENT AND TWO PARTS OF SAND WITH WATER CEMENT RATIO NOT EXCEEDING 0.4.
- 6.3 GROUT MORTAR SHALL HAVE A MINIMUM COMPRESSIVE STRENGTH OF 40 N/mm².
- 6.4 WHERE REQUIRED AND INDICATED ON THE DRAWINGS, A NON-SHRINK GROUT SHALL BE PREPARED AND APPLIED STRICTLY IN ACCORDANCE WITH THE MANUFACTURER'S INSTRUCTIONS.

LEGEND

	ROCK FILL
	WELL GRADED COMPACTED SAND
	BLINDING LAYER 50 mm THK.
	STYROFOM OR OTHER INSULATING MATERIAL
	FIBRE MAT OR BUILDING PAPER
	SLOPE
	CHEQUER PLATE
	GRATING
	HOLE
	POCKET OR RECESS
	ELECTRICAL TRENCHES
	INSTRUMENT TRENCHES
	ELEVATION
	FENCE
	GRADE
	ANCHOR BOLT
	PIPE OR SLEEVE
	CONSTRUCTION JOINT
	WATERSTOP
	SPAN DIRECTION
	MATERIAL ITEM

ABBREVIATIONS

AB	DENOTES	ANCHOR BOLTS
ALT		ALTERNATE
APPROX		APPROXIMATE
BTF		BOTTOM FACE
BOC		BOTTOM OF CONCRETE
BOS		BOTTOM OF STEEL
CL		CENTRE LINE
CTC		CENTRE TO CENTRE
CONC		CONCRETE
DIA		DIAMETER
DWG / DRG		DRAWING
EF		EACH FACE
EL / ELEV		ELEVATION
ES		EVENLY SPACED
FF		FAR FACE
FFL		FINISHED FLOOR LEVEL
FP		FIXED POINT
FDN / FOUND		FOUNDATION
GRD		GRADE LEVEL
GL		GROUND LEVEL
HP		HIGH POINT
ID		INSIDE DIAMETER
LG		LONG OR LENGTH
LP		LOW POINT
MK		MARK
MKD		MARKED
NF		NEAR FACE
Ø		DIAMETER

ABBREVIATIONS

OD	OUTSIDE DIAMETER
PTFE	POLYTETRAFLUORETHYLENE
RAD	RADIUS
REV	REVISION
SCHED	SCHEDULE
SECT/SEC	SECTION
SP	SLIDING POINT
STGD	STAGGERED
TF	TOP FACE
TOC	TOP OF CONCRETE
TOG	TOP OF GRATING
TORC	TOP OF ROUGH CONCRETE
TOS	TOP OF STEEL
TYP	TYPICAL

APPROVED FOR CONSTRUCTION

REV	DATE	DRAWN BY	TEAML	J.ENG.	CHECKED	DESCRIPTION	WBS No.	PROJ. ENG.	SIGNATURE
A	27.02.11	GCS	RE	PS		APPROVED FOR CONSTRUCTION	IN.09.011	OSE/28N	
O	26.02.11	GCS	KBR	GSB		ISSUED FOR COMMENTS	IN.09.011	OSE/28N	
PROJECT DRAWING REVISION									
IN CASE OF DEVIATIONS A MARKED UP PRINT SHALL BE SENT TO THE PROJECT ENGINEER									
AREA : NIMR							SCALE : — CAD DRAWING		
SUB AREA : NIMR SLUDGE PIT SYSTEMS							No. 16		
DRWG. TYPE : CONCRETE STRUCTURE							DRWG		
DESCRIPTION : GENERAL NOTES, LEGEND AND ABBREVIATIONS							AREA CODE		
							ENG SECT		
							SERIAL NUMBER		
							SHEET		
							PROJ CODE		
							DWG SIZE		
							REV.		
							NO		
							NIM 2 1841 001 DQ		
							3 A		

ورلي بارسونز - الصناعات العربية (محاصة)
WorleyParsons - Arabian Industries (JV)

CONTRACT NO.: C31/0606 PROJ. NO.: PAIP00405

1.0 GENERAL NOTES.

- 1.1 ALL WORKS SHALL BE CARRIED OUT IN ACCORDANCE WITH CONSTRUCTION CONTRACT AND / OR CONSTRUCTION SPECIFICATION SP-1279.
- 1.2 ALL DIMENSIONS ARE IN MILLIMETRES EXCEPT FOR PIPE SIZES WHICH ARE SHOWN IN INCHES.
- 1.3 ALL ELEVATIONS ARE IN METERS AND RELATED TO DATUM ELEVATION OF 100.000

2.0 STRUCTURAL STEEL MATERIAL

- 2.1 STEEL STRUCTURE SHALL BE FABRICATED IN ACCORDANCE WITH GOOD WORKING PRACTICE, MATERIALS, WORKMANSHIP AND TESTING GENERALLY SHALL COMPLY WITH BS 5950 PART-1,2000.
- 2.2 STRUCTURAL STEEL SHALL COMPLY WITH THE FOLLOWING MATERIAL REQUIREMENT. GRADE S275 JR COMPLYING WITH BS EN 10025 PART 1 & 3.
- 2.3 STRUCTURAL STEEL SHALL COMPLY WITH THE REQUIREMENT OF BS 5950, PART-1, IN ADDITION STRUCTURAL STEEL HOT ROLLED SECTIONS SHALL COMPLY WITH THE REQUIREMENTS OF BS 4 PART-1,1993 AND PART-2,1969 AND FOR ANGLES BS EN 10056-1:1999 (METRIC DIMENSIONS). PIPES USED FOR STRUCTURAL PURPOSE SHALL COMPLY WITH ASTM A 106 GRADE B, OR AS SPECIFIED ON THE DRAWINGS.

3.0 BOLTING

- 3.1 BOLTS AND NUTS SHALL HAVE ISO - METRIC COARSE THREAD.
- 3.2 MILD STEEL BOLTS, NUTS AND WASHERS SHALL COMPLY WITH THE REQUIREMENT OF BS 5950 PART-1, BS 4190 AND BS 4320.
- 3.3 WASHERS ARE TO BE PROVIDED UNDER ALL NUTS ON BEVELLED SURFACES SQUARE TAPER WASHERS OF 5 mm MEAN THICKNESS SHALL BE PROVIDED UNDER NUT OR HEAD AS APPROPRIATE.

4.0 WELDING

- 4.1 WELDING USED IN THE FABRICATION WORK IS TO BE BY THE METALLIC ARC PROCESS USING ELECTRODES COMPLYING WITH THE REQUIREMENTS OF BS 639. THE WHOLE OF THE WORK IS TO BE IN ACCORDANCE WITH THE REQUIREMENTS LAID DOWN IN BS 5950 AND 5135.
- 4.2 THE ENDS OF ALL STANCHIONS AND POSTS TOGETHER WITH GUSSETS WHERE PRESENT AND ALREADY WELDED ON, SHALL BE MACHINED SO THAT THE WHOLE AREA IS IN DIRECT CONTACT WITH THE BASE, BEARING OR CAP PLATE, SUCH PLATES BEING TRULY AT RIGHT ANGLES TO THE STANCHION AXIS OR AS OTHERWISE SPECIFIED ON THE DRAWING.
- 4.3 MINIMUM SIZE OF WELD SHALL BE 6 mm UNLESS SPECIFIED.

5.0 FLOORING AND GRATING

- 5.1 STAIR TREADS SHALL BE OF HOT DIP GALVANIZED GRATING.
- 5.2 SOLID FLOORING SHALL BE MADE OF TEAR PLATE (DURBAR OR EQUIVALENT).
- 5.3 CHEQUERED PLATE SHALL NOT BE USED FOR PLATFORMS IN OIL AND GAS PROCESSING PLANTS. HOWEVER CHEQUERED PLATE FLOORING IS PERMITTED TO BE USED AS TRENCH COVERING WITHIN CONTROL BUILDINGS AND ELECTRICAL SUBSTATIONS.
- 5.4 FOR OPEN FLOORING GALVANISED GRATING SHALL BE USED. THE MAIN BARS OF THE GRATING SHALL BE 25x5mm MINIMUM AT A CENTRE LINE SPACING OF 33 mm. LATERAL RESTRAINT SHALL BE PROVIDED BY 6 mm SQUARE TRANSVERSE BARS AT A SPACING OF 33 mm, WELDED INTO THE UPPER EDGE OF THE MAIN BARS. FIXING MATERIAL SHALL BE HOT DIP GALVANIZED TO BS EN ISO 1461:1999

6.0 ERECTION

- 6.1 ERECTION ON CONCRETE FOUNDATION SHALL NOT COMMENCE WITHIN 7 DAYS OF POURING THE CONCRETE FOUNDATIONS AND ONLY IF THE CONCRETE HAS ACQUIRED SUFFICIENT STRENGTH.
- 6.2 THE CONTRACTOR SHALL PROPERLY ALIGN EACH PART OF THE STRUCTURE BEFORE MAKING THE FIELD CONNECTIONS.
- 6.3 THE CONTRACTOR SHALL ENTIRELY BE RESPONSIBLE FOR THE STABILITY OF THE STEELWORK DURING ERECTION AND HE SHALL ARRANGE FOR ALL TEMPORARY GUYING, BRACING AND SUPPORTS TOGETHER WITH ANY ADDITIONAL TACK BOLTS NECESSARY FOR THE STABILITY OF THE STEELWORK UNTIL FINAL BOLTING UP.
- 6.4 THE STEELWORK SHALL BE ACCURATELY ERECTED WITHIN THE FOLLOWING TOLERANCE.

SETTING OUT-PLAN DIMENSIONS } $\pm 10\text{mm}$ OVERALL BUILDING BUT NOT MORE THAN $\pm 5\text{mm}$ IN ANY ONE 5 METER BAY

LEVELS-FOR STANCHIONS AND COLUMN BASE PLATES. } $\pm 5\text{mm}$

PLUMB OF STANCHIONS, POSTS, ETC } 0.1 % OF HEIGHT, BUT NOT MORE THAN $\pm 5\text{ mm}$ OVERALL

STRAIGHTNESS OR BOW OR OUT OF SQUARENESS OF SECTIONS AFTER ERECTION. } NOT MORE THAN THE ROLLING TOLERANCES AS GIVEN IN BS 5950 PART 2:2001

7.0 HOT-DIP GALVANIZING

- 7.1 THE SURFACE OF ALL STEEL DESCRIBED AS GALVANISED ARE TO BE THOROUGHLY AND EVENLY COATED. THE AVERAGE WEIGHT OF THE ZINC LAYER SHALL BE 610g/m^2 OF GALVANIZED SURFACE.
- 7.2 ALL DAMAGED GALVANIZED SURFACES AND ALL EDGES EXPOSED BY CUTTING AFTER GALVANIZING SHALL BE TREATED WITH TWO COATS OF ZINC PAINT SPRAYED IN ACCORDANCE WITH BS EN ISO 1461-1999.

8.0 CORROSION PROTECTION

- 8.1 CORROSION PROTECTION FOR STRUCTURAL STEEL SHALL BE IN ACCORDANCE WITH CONSTRUCTION SPECIFICATION SP-1279 PART N CIVIL AND BUILDING CONSTRUCTION SPECIFICATION, PAINTING AND DECORATING. FOR ALL STEEL STRUCTURES WITHIN OIL & GAS PLANT SHALL BE AS PER SP-1246.

9.0 EARTHING CONNECTIONS

- 9.1 PROVIDE EARTHING BOSS FOR ALL COLUMNS AND STAIR STRINGERS RESTING ON GROUND / FOUNDATIONS. THE EARTHING BOSS DETAILS SHALL CONFIRM TO DRG No. STD-4-0305-01- -4


LEGEND

	TEAR PLATE
	GRATING
	HOLE
	POCKET OR RECESS
	ELEVATION
	FENCE
	GRADE
	ANCHOR-BOLT
	PIPE OR SLEEVE
	MATERIAL ITEM
	FILLET WELD-WELD SIZE
	FIELD WELD
	WELD ALL ROUND
	FULL PENETRATION WELD TYPE GROVE BEVEL WELD.
	GRATING SPAN


ABBREVIATIONS

AB	DENOTES	ANCHOR BOLTS	M 20	METRIC BOLT AND DIAMETER
ALT		ALTERNATE	MKD	MARKED
BOS		BOTTOM OF STEEL	NF	NEAR FACE
BF		BOTH FACES	\varnothing	DIAMETER
ϕ		CENTRE LINE	\square / SQ	SQUARE
CTC		CENTRE TO CENTRE	OD	OUTSIDE DIAMETER
CONC		CONCRETE	PLT	PLATE
DIA		DIAMETER	PTFE	POLYTETRAFLUORETHYLENE
DWG / DRG		DRAWING	PS	PIPE SUPPORT
DET		DETAIL	RAD	RADIUS
EL / ELEV		ELEVATION	REQD	REQUIRED
FF		FAR FACE	REF	REFER
FP		FIXED POINT	SCHED	SCHEDULE
FDN / FOUND		FOUNDATION	SECT / SEC	SECTION
GALV		GALVANIZED	SP	SLIDING POINT
HSFG BOLTS		HIGH STRENGTH FRICTION GRIP BOLTS	STGD	STAGGERED
HSB		HIGH STRENGTH BOLT (A325 OR EQUIVALENT)	THK	THICK
ID		INSIDE DIAMETER	TOG	TOP OF GRATING
LG		LONG OR LENGTH	TOS	TOP OF STEEL
			TYP	TYPICAL
			WP	WORKING POINT


APPROVED FOR
CONSTRUCTION

A	27.02.11	GCS	PR	✓	APPROVED FOR CONSTRUCTION	IN.09.011	OSE/28N			
O	26.02.11	GCS	KBR	GSB	ISSUED FOR COMMENTS	IN.09.011	OSE/28N			
REV	DATE	DRAWN BY	TEAM L	J.ENG.	DESCRIPTION	WBS No.	PROJ. ENG.	SIGNATURE		
				CHECKED				P D O APPROVAL		
PROJECT DRAWING REVISION										
IN CASE OF DEVIATIONS A MARKED UP PRINT SHALL BE SENT TO THE PROJECT ENGINEER										
AREA : NIMR						SCALE : — CAD DRAWING 0 1 2 3 4 5 6 7				
SUB AREA : NIMR SLUDGE PIT SYSTEMS						No. 16	 شركة تنمية نفط عُمان Petrolium Development Oman			
DRWG. TYPE : STEEL STRUCTURE						DRWG AREA ENG SERIAL SHEET PROJ DWG REV. CODE CODE SECT NUMBER CODE SIZE SIZE				
DESCRIPTION : GENERAL NOTES, LEGEND AND ABBREVIATIONS						NO	NIM	2	1841 002 DQ	3 A

	ورلي بارسونز - الصناعات العربية (محاصة) WorleyParsons - Arabian Industries (JV)
CONTRACT NO.: C31/0606	PROJ. NO.: PAIP00405

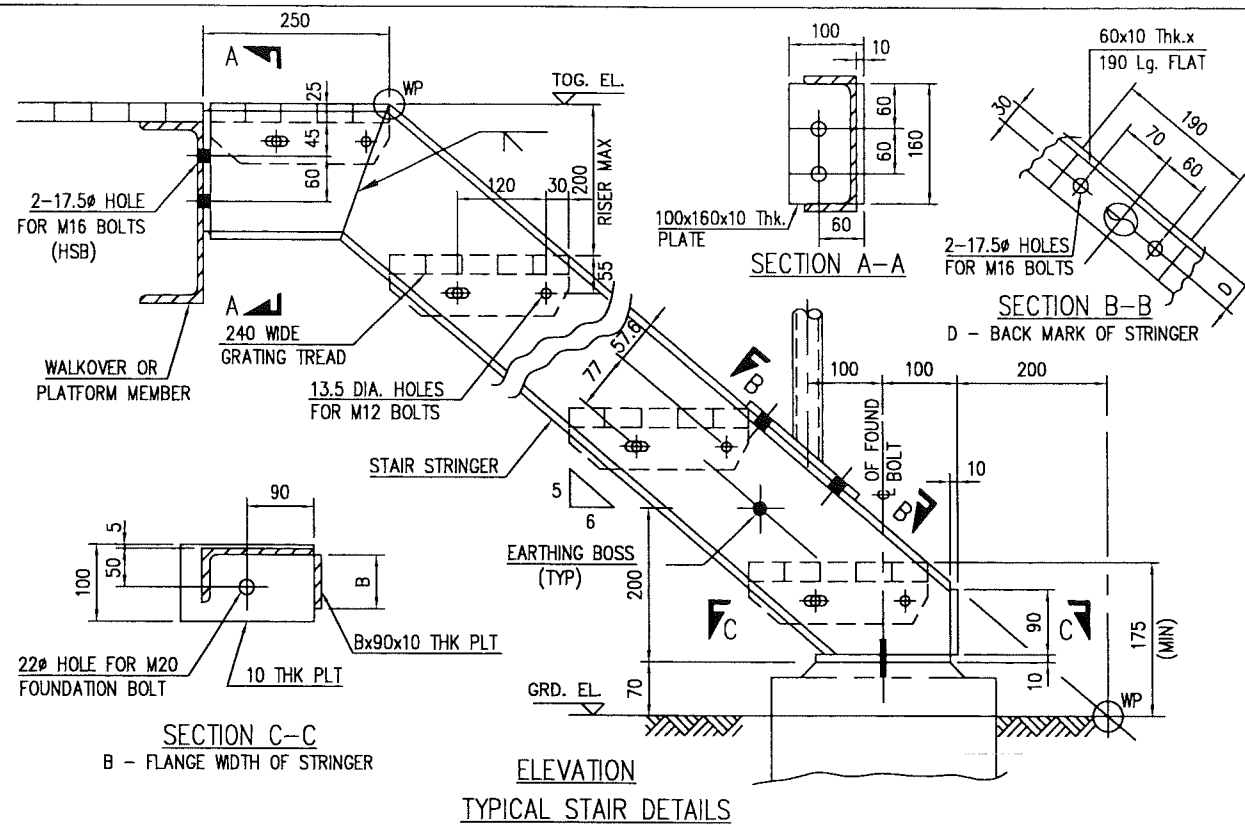


TYPICAL STAIR DETAILS

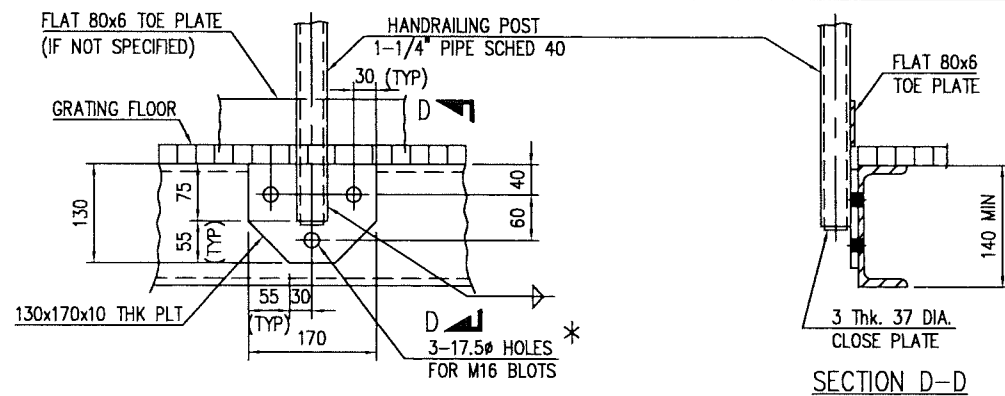

TYPICAL HANDRAILING CONNECTION

TYPE - A

* - OMIT THIRD BOLT AT THE BOTTOM WHERE NOT POSSIBLE

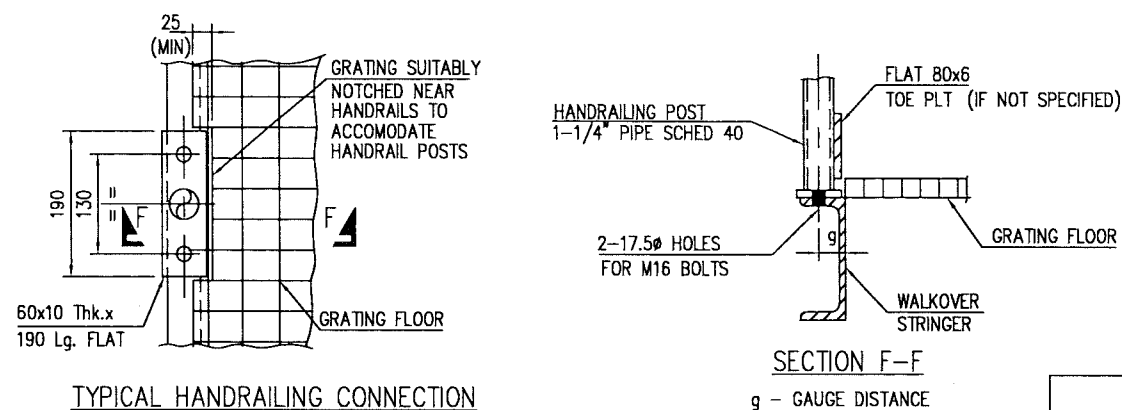

TYPICAL HANDRAILING CONNECTION

TYPE - C

NOTES

- THE DETAILS SHOWN ON THIS DRAWING IS ONLY TYPICAL HOWEVER DETAIL DRAWING FOR ALL STAIRS AND HANDRAILING TO THE EXACT LOCATION REQUIRED SHALL BE DRAWN OUT BASED ON THESE DETAILS


REFERENCE DRAWINGS

- FOR GENERAL NOTES, LEGEND AND ABBREVIATIONS. --- NIM -2-1841-002-CN-3
- EARTHING BOSS --- STD -4-0305-001-00-4




ورلي بارسونز - الصناعات العربية (محصاة)
WorleyParsons - Arabian Industries (JV)

CONTRACT NO.: C31/0606 PROJ. NO.: PAIP00405

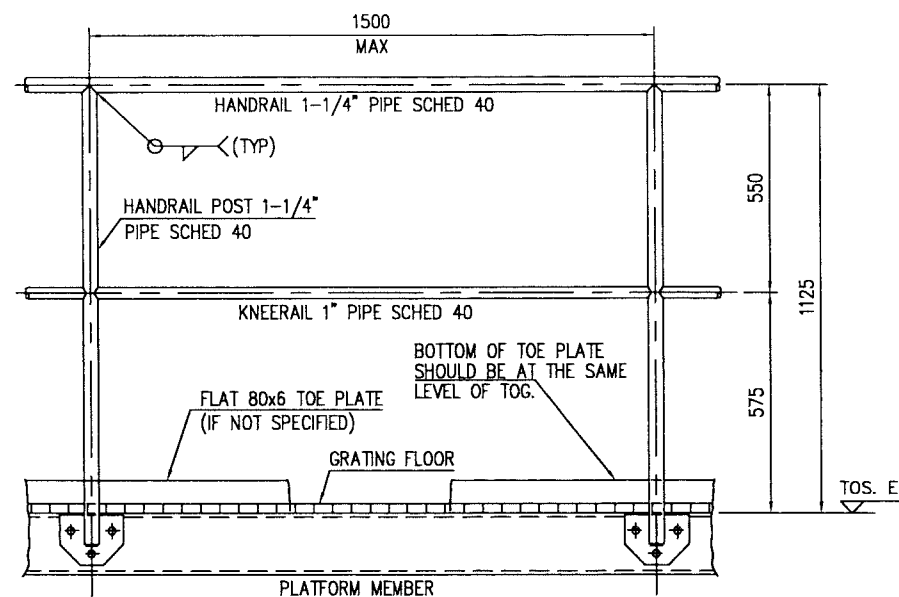


TYPICAL HANDRAILING DETAIL

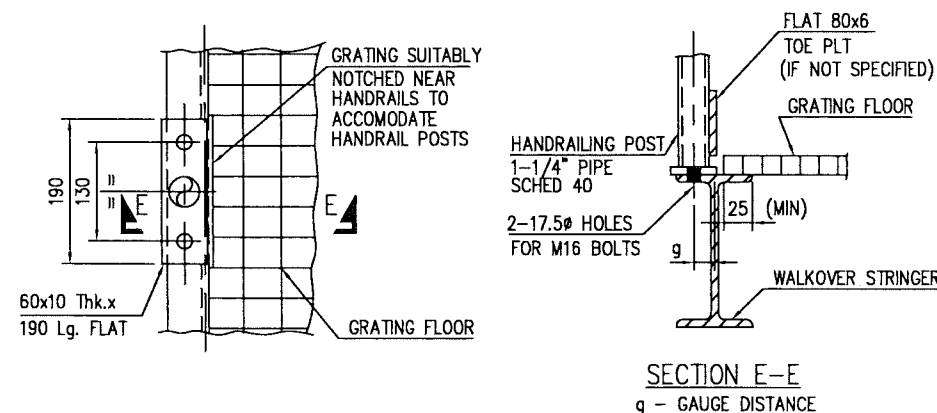


TYPICAL HANDRAILING CONNECTION

TYPE - B

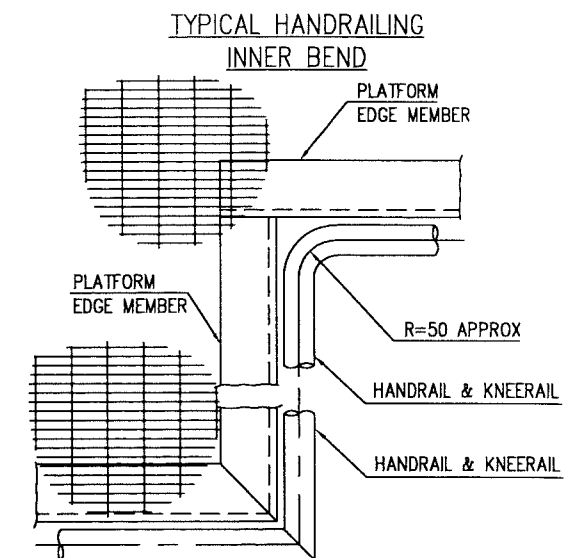

TYPICAL HANDRAILING
OUTER BEND

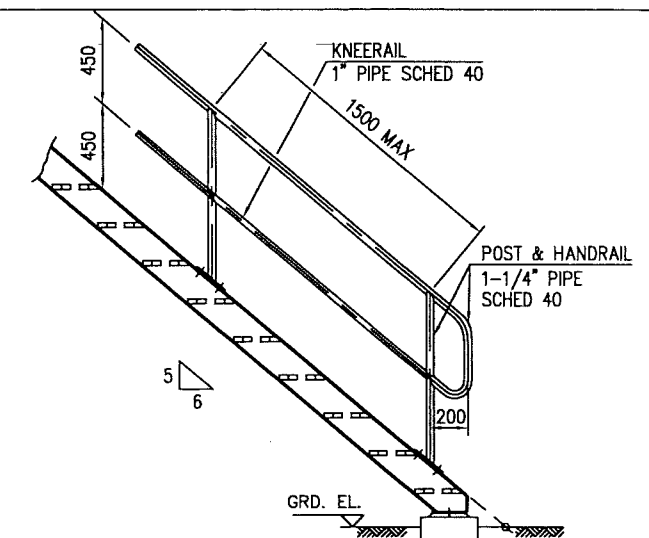

TYPICAL STAIR HANDRAILING DETAIL

ic. Number
7A2

APPROVED FOR
CONSTRUCTION

REV	DATE	DRAWN BY	CHECKED	DESCRIPTION	WBS No.	PROJ. ENG.	SIGNATURE
A	27.02.11	GCS	RE	APPROVED FOR CONSTRUCTION	IN.09.011	OSE/28N	
O	26.02.11	GCS	KBR	ISSUED FOR COMMENTS	IN.09.011	OSE/28N	

PROJECT DRAWING REVISION
IN CASE OF DEVIATIONS A MARKED UP PRINT SHALL BE SENT TO THE PROJECT ENGINEER



AREA : NIMR
SCALE : 1:1
CAD DRAWING

SUB AREA : NIMR SLUDGE PIT SYSTEMS NO. 16


DRWG. TYPE : STRUCTURAL STEEL DETAILS

DESCRIPTION : TYPICAL STAIR AND HANDRAILING

NO NIM 2 1841 003 DQ 3 A

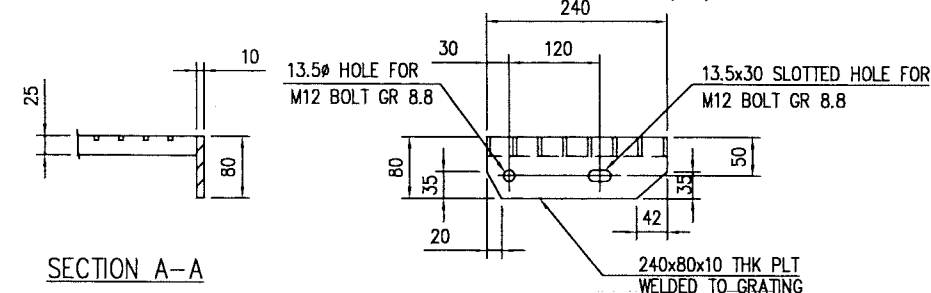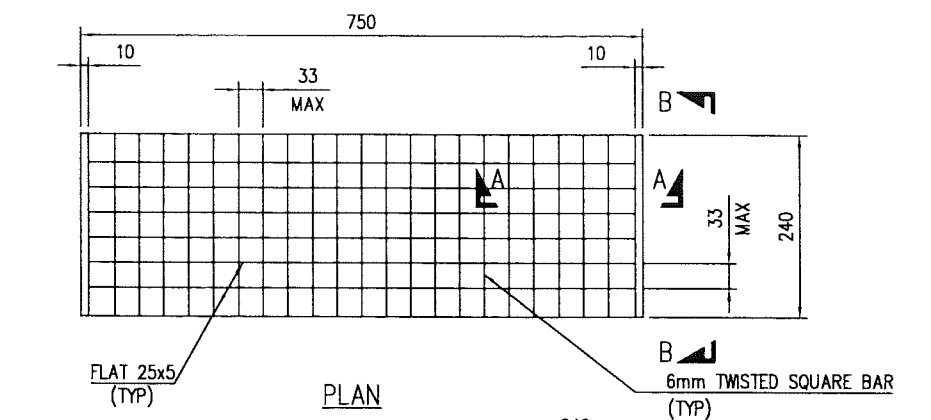


TYPICAL GRATING TREAD

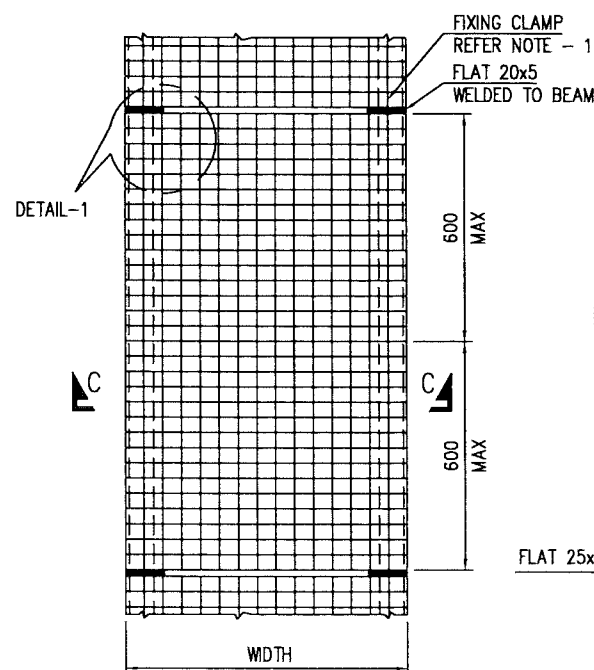


PLAN


TYPICAL WALKWAY GRATING

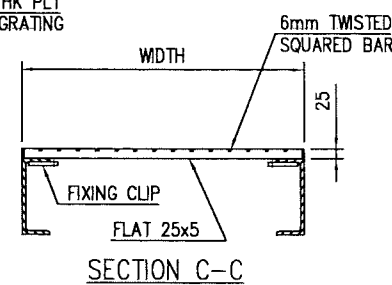

DETAIL-1

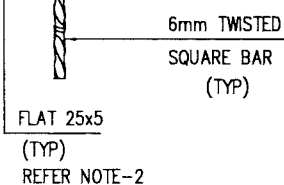


FLAT 20x5-100 LG WELDED TO BEAM

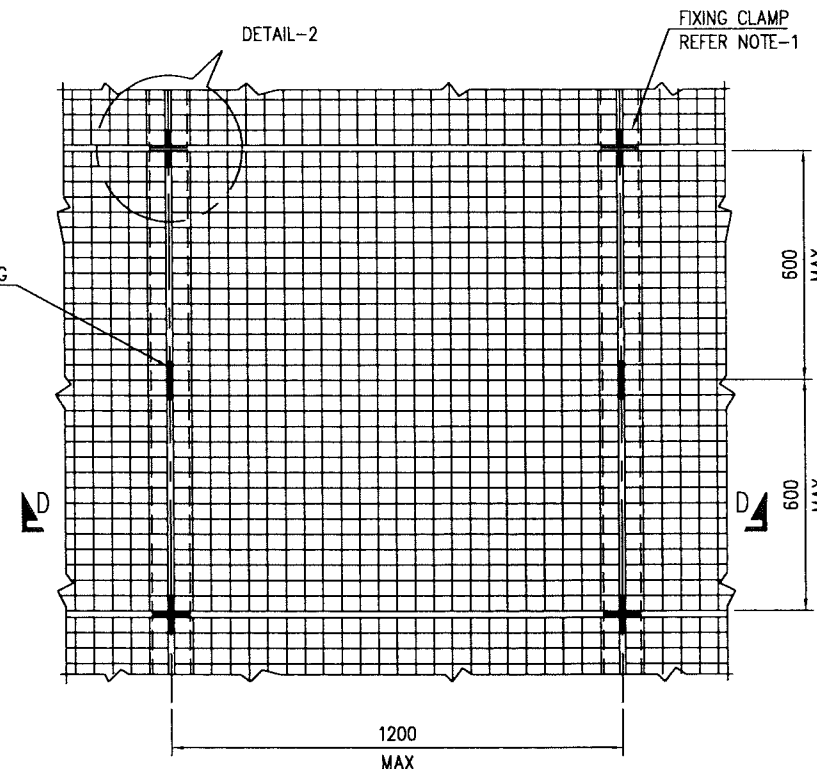


PLAN

TYPICAL PLATFORM GRATING

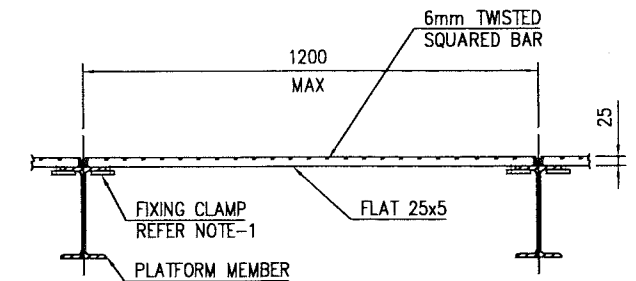

SECTION D-D

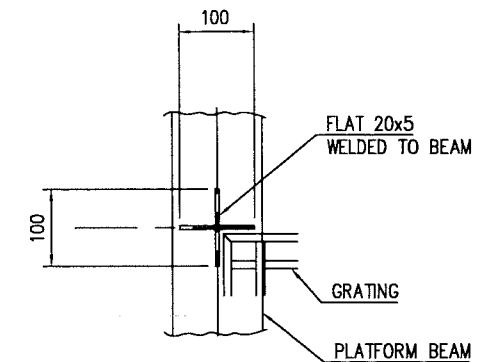

DETAIL-2

APPROVED FOR CONSTRUCTION

REV	DATE	DRAWN BY	TEAM	J.ENG.	CHECKED	DESCRIPTION	WBS No.	PROJ. ENG.	SIGNATURE
A	27.02.11	GCS	RR	Y.		APPROVED FOR CONSTRUCTION	IN.09.011	OSE/28N	
O	26.02.11	GCS	KBR	GSB		ISSUED FOR COMMENTS	IN.09.011	OSE/28N	

PROJECT DRAWING REVISION
IN CASE OF DEVIATIONS A MARKED UP PRINT SHALL BE SENT TO THE PROJECT ENGINEER

AREA : NIMR

SUB AREA : NIMR SLUDGE PIT SYSTEMS No. 16

DRWG. TYPE : STRUCTURAL STEEL DETAILS

DESCRIPTION : TYPICAL GRATING AND TREAD DETAILS

SCALE : NTS CAD DRAWING

DRWG. AREA ENG SERIAL SHEET PROJ DWG REV.
NO CODE SECT NUMBER NUMBER CODE SIZE SIZE

NIM 2 1841 004 DQ 3 A

NOTES

1. EACH GRATING PANEL TO BE FIXED TO FLOOR BEAMS BY MEANS OF ATLEAST 4 CLAMPS (IN CASE OF VERY LARGE PANELS MIN 4 CLAMPS/m²) GALVANISED.
2. AFTER COMPLETION OF GRATING PANELS & GRATING TREADS TO BE HOT DIP GALVANISED (610 g/m²)

REFERENCE DRAWINGS

1. FOR GENERAL NOTES, LEGEND AND ABBREVIATIONS. — NIM -2-1841-002-CN-3

WorleyParsons - Arabian Industries (JV)

CONTRACT NO.: C31/0606 PROJ. NO.: PAIP00405

BAR SHAPE CODES

00 L = A	01 L = A, STOCK LENGTHS	11 $A \geq B \geq P$ $L = A+B-0.5r-d$	12 $A \geq B \geq P \geq (R+5d)$ $L = A+B-0.43R-1.2d$	13 $A \geq C \geq P \geq (B/2+5d)$ $B \geq 2r+2d$ $L = A+0.57B+C-1.5d$	14 $A \geq C \geq P$ $L = A+C-4d$	15 $A \geq C \geq P$ $L = A+C$	21 $A \geq C \geq P$ $L = A+B+C-r-2d$	22 $C \geq 2r+2d$ $A \geq D \geq P \geq (C/2+5d)$ $L = A+B+C+D-1.5r-3d$	23 $A \geq C \geq P$ $L = A+B+C-r-2d$	24 $L = A+B+C$
25 $A \geq B \geq P$ $L = A+B+E$	26 $D \geq 2d$ $A \geq C \geq P$ $L = A+B+C$	27 $A \geq C \geq P$ $L = A+B+C-0.5r-d$	28 $C \geq P$ $L = A+B+C-0.5r-d$	29 $A \geq C \geq P$ $L = A+B+C-r-2d$	31 $A \geq D \geq P$ $L = A+B+C+D-1.5r-3d$	32 $A \geq D \geq P$ $L = A+B+C+D-1.5r-3d$	33 $A \geq 12d+30mm$ $B \geq 2r+2d$ $C \geq P, B/2+5d$ $L = 2A+1.7B+2C-4d$	34 $A \geq E \geq P$ $L = A+B+C+E-0.5r-d$	35 $A \geq E \geq P$ $L = A+B+C+E-0.5r-d$	36 $A \geq D \geq P$ $L = A+B+C+D-r-2d$
41 $A \geq E \geq P$ $L = A+B+C+D+E-2r-4d$	44 $A \geq E \geq P$ $L = A+B+C+D+E-2r-4d$	46 $D \geq 2d$ $A \geq E \geq P$ $L = A+B+C+E$	47 $P \leq C \leq A$ $L = 2A+B+Max(21d, 240)$	51 $A \geq B \geq P$ $L = 2(A+B)+max(16d, 160)$	56 $E \geq F \geq P$ $L = A+B+C+D+2E-2.5r-5d$	63 $C \geq D \geq P$ $L = 2A+3B+max(14d, 150)$	64 $A \geq F \geq P$ $L = A+B+C+2D+E+F-3r-5d$	67 $L = A$	75 $B = LAP$ $L = 3.14 * (A-d)+B$	77 $C = NO. OF TURNS$ $(IF B \leq A/5) L = C * 3.14 * (A-d)$ $(IF B > A/5) L = C * ((3.14 * (A-d))^2 + B^2)^{0.5}$
98 $C \geq D \geq P$ $L = A+B+C+D-2r-4d$	99a $C \geq P$ $B \geq 2r+2d$ $L = A+1.14B+2C-3.2d$	99b $A \geq P$ $L = A+B+C+E$	99c $A \geq C \geq P$ $L = A+C+(3.14 * R/2)$	99d $A \geq P$ $L = 2(A+B+D)+E-r-2d$	99e $A \geq P$ $L = A+B+C+D-r-2d$	99f $A \geq E \geq P$ $L = A+B+C+E-r-2d$	99g $A \geq P$ $L = 2(A+B+C)+D-r-2d$	99h $A \geq P$ $L = A+B+C+500-r-2d$	99j $A \geq P$ $L = 2A+B+C-0.5r-d$	99k $A \geq P$ $L = 2(A+B)+C-r-2d$
99m $D \geq 2d$ $A \geq E \geq P$ $L = A+B+C+E$	99n $A \geq E \geq P$ $L = A+B+C+E-0.5r-d$	99p $A \geq P$ $L = A+B+C+E$	99q $A \geq C \geq P$ $L = A+B+C-r-2d$	99r $A \geq C \geq P$ $L = A+B+C-r-2d$	99s $A \geq B \geq P$ $L = A+B-0.5r-d$	99t $L = 4A+16d$	99u $A \geq D \geq P$ $L = A+B+C+D-1.5r-3d$			

BAR SIZE d	r	MINIMUM END PROJECTION - P		OVERALL DIM X TWO BENDS	SKETCH
		$\geq 150^*$ (min 5d Straight)	$< 150^*$ (min 10d Straight)		
6	12	110 ^d	110 ^d	60	 $X = 6d+2r$
8	16	115 ^d	115 ^d	80	
10	20	120 ^d	130	100	
12	24	125 ^d	160	120	
16	32	130	210	160	
20	70	190	290	260	
25	87	240	365	325	
32	112	305	465	420	
40	140	380	580	520	
50	175	475	725	650	

a - THE MINIMUM END PROJECTIONS FOR SMALLER BARS IS GOVERNED BY THE PRACTICALITIES OF BENDING BARS.

NOTES:

1. THE STEEL REINFORCEMENT GRADE SHALL CONFORM TO BS 4449.
2. THE BAR SHAPE CODES SHALL BE IN ACCORDANCE WITH BS 8666 :2005 UNLESS NOTED OTHERWISE.


WorleyParsons - Arabian Industries (JV)
 CONTRACT NO.: C31/0606 PROJ. NO.: PAIP00405

APPROVED FOR CONSTRUCTION


REV	DATE	DRAWN BY	CHECKED	DESCRIPTION	WBS No.	PROJ. ENG.	SIGNATURE
A	27.02.11	GCS	RB	APPROVED FOR CONSTRUCTION	IN.09.011	OSE/28N	
O	26.02.11	GCS	KBR	ISSUED FOR COMMENTS	IN.09.011	OSE/28N	

PROJECT DRAWING REVISION
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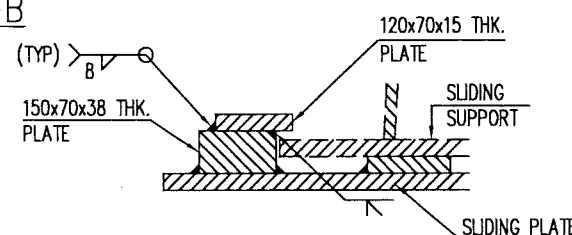
AREA	: NIMR	SCALE	: 1:100	CAD DRAWING
SUB AREA	: NIMR SLUDGE PIT SYSTEMS	NO.	16	
DRWG. TYPE	: STANDARD BAR SHAPE CODES	DRWG	AREA CODE	ENG SECT
DESCRIPTION	: STANDARD BAR SHAPE CODES	SERIAL NUMBER	SHEET	PROJ CODE
		NO	NIM 2 1841 005 DQ	3 A

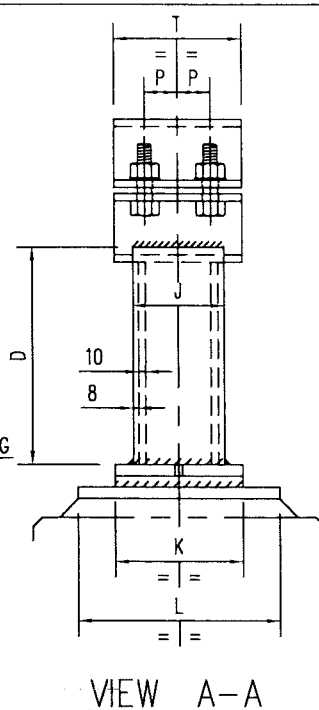

ELEVATION

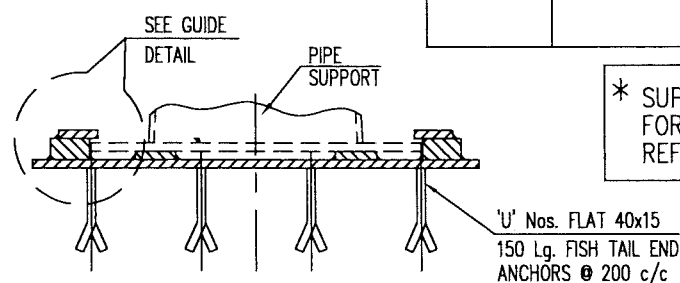

SECTION C-C



GUIDE DETAIL

DIM	SIZE	PIPE				BARREL		
	4"	6"	8"	10"	6"	8"	10"	
	A	59	86	112	138	86	112	138
	B	10	10	15	15	10	15	15
	C	327	325	327	300	300	300	300
	D	283	289	292	273	264	265	273
	E	10	10	10	10	10	10	10
	F	135	165	185	255	165	185	255
	G	345	375	395	465	375	395	465
	H	555	585	605	675	585	605	675
	J	125	125	150	150	125	150	150
	K	175	175	200	200	175	200	200
	L	275	275	275	325	275	275	325
	M	75	115	150	190	115	150	190
	N	285	290	293	275	265	266	275
	P	45	45	50	50	45	50	50
	Q	108	136	162	195	136	162	195
	R	146	174	200	220	174	200	220
	S	55	82	107	135	82	107	130
	T	175	175	200	200	175	200	200
	U	3	3	3	3	3	3	3
	V	M16x60	M20x80	M20x80	M20x80	M20x80	M20x80	M20x80
	Nos. REQD.	-	2	-	-	-	-	-

SIZE DIM	PIPE / BARREL			
	12"	14"	16"	18"
A	164	180	205	231
B	15	15	15	15
C	300	300	300	300
D	280	283	290	299
E	10	10	10	10
F	310	325	390	425
G	520	535	600	635
H	730	745	810	845
J	150	175	175	175
K	200	250	250	250
L	325	350	350	350
M	225	245	280	320
N	283	286	295	303
P	50	60	60	60
Q	220	235	265	290
R	245	260	295	320
S	162	177	202	228
T	200	250	250	250
U	4	4	4	4
V	M20x80	M20x80	M20x80	M20x80
Nos. REQD.	-	-	-	-

M.T.O.			
DESCRIPTION	QUANTITY	UNITS	SAP No.
15x40 FLAT	1.80	m	1000132300
15x75 FLAT	1.10	m	1000132319
10 Thk. PLATE	0.66	m ²	1000062608
15 Thk. PLATE	0.85	m ²	1000080265
38 Thk. PLATE	0.09	m ²	1000122732
M16-60 Lg. BOLT WITH NUT & WASHER	—	PC	N.A.
M20-80 Lg. BOLT WITH NUT & WASHER	8	PC	N.A.

lc. Murrey,
7/12

APPROVED FOR
CONSTRUCTION

A	27.02.11	GCS	RB	W	APPROVED FOR CONSTRUCTION	IN.09.011	OSE/28N		
O	26.02.11	GCS	KBR	GSB	ISSUED FOR COMMENTS	IN.09.011	OSE/28N		
g	REV	DATE	DRAWN BY	TEAM L.	J. ENG.	DESCRIPTION	WBS No.	PROJ. ENG.	SIGNATURE
				CHECKED				P D O APPROVAL	

PROJECT DRAWING REVISION	
NO.	DESCRIPTION
1	1.00
2	2.00
3	3.00
4	4.00
5	5.00
6	6.00
7	7.00
8	8.00
9	9.00
10	10.00
11	11.00
12	12.00
13	13.00
14	14.00
15	15.00
16	16.00
17	17.00
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92	92.00
93	93.00
94	94.00
95	95.00
96	96.00
97	97.00
98	98.00
99	99.00
100	100.00

IN CASE OF DEVIATIONS A MARKED UP PRINT SHALL BE SENT TO THE PROJECT ENGINEER.

1. ALL DIMENSIONS ARE IN MILLIMETRES.
2. ALL ELEVATIONS & CO-ORDINATES ARE IN METRES.
3. ALL STEEL WORK TO BS EN 10025 GRADE S275 JR.
4. ALL CONNECTIONS TO BE MADE USING 8mm CFW.
5. ALL STEEL WORK TO RECEIVE CORROSION PROTECTION IN ACCORDANCE WITH DOCUMENT No. SP-1246-2

—		—				—
DESCRIPTION	AREA	S	SERIAL	SH.	P	S
	DRAWING NUMBER					

NOTES

REFERENCE DRAWINGS

AREA : NIMR

SUB AREA : NIMR SLUDGE PIT SYSTEMS NO. 16

DRWG. TYPE	: PIPE SUPPORTS
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DESCRIPTION	PS-051, 052, 053 & 054
-------------	------------------------





SCALE : NTS CAD DRAWING



شركة تنمية نفط عُمان

Petroleum Development Oman

DRWG	AREA CODE	ENG SECT	SERIAL NUMBER	SHEET	PROJ CODE	DWG SIZE	REV.
NO	NIM	2	1842	002	DQ	3	A

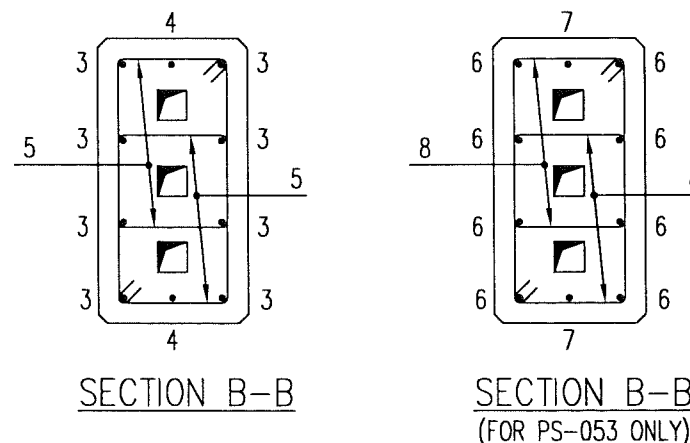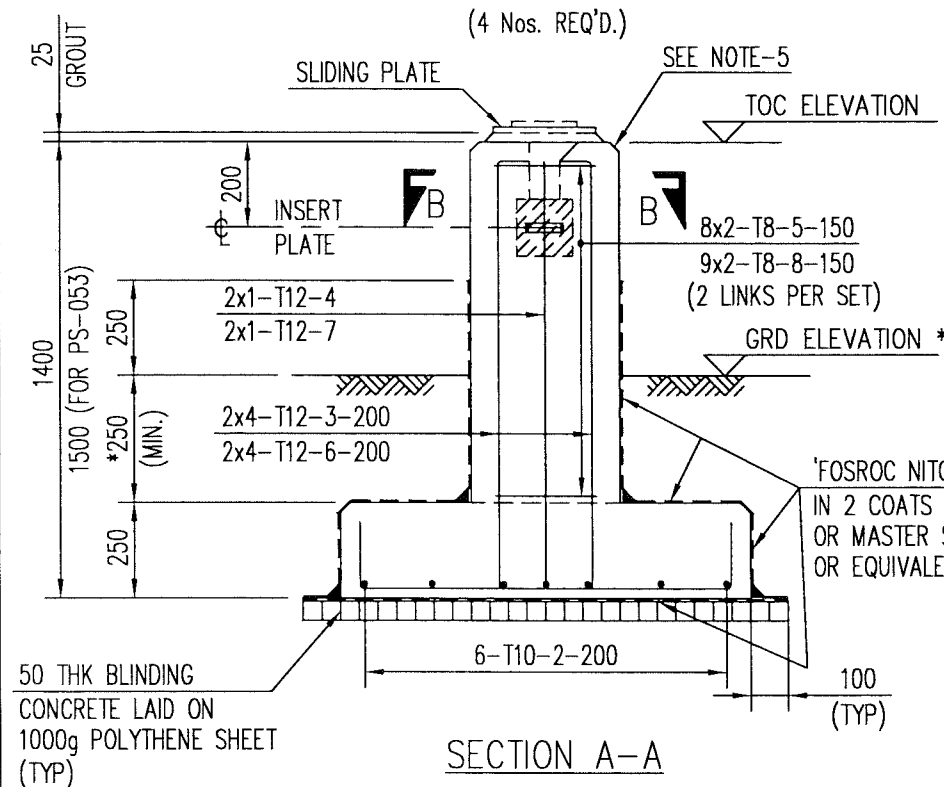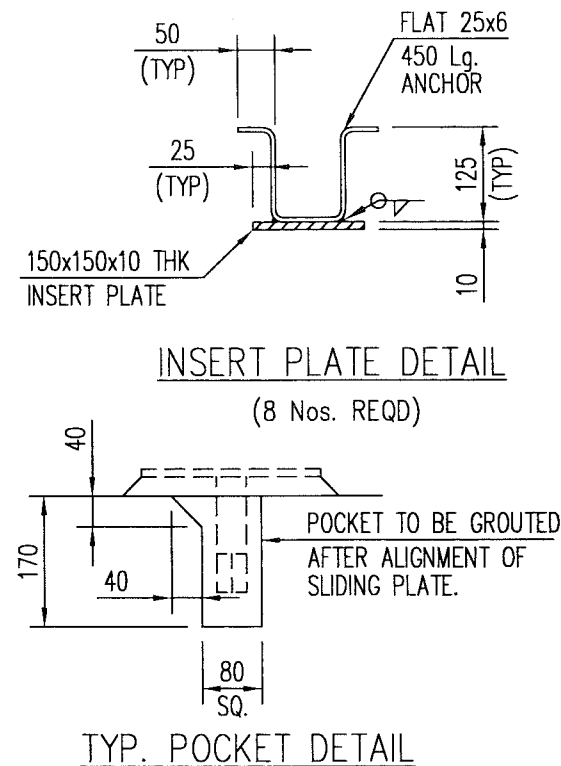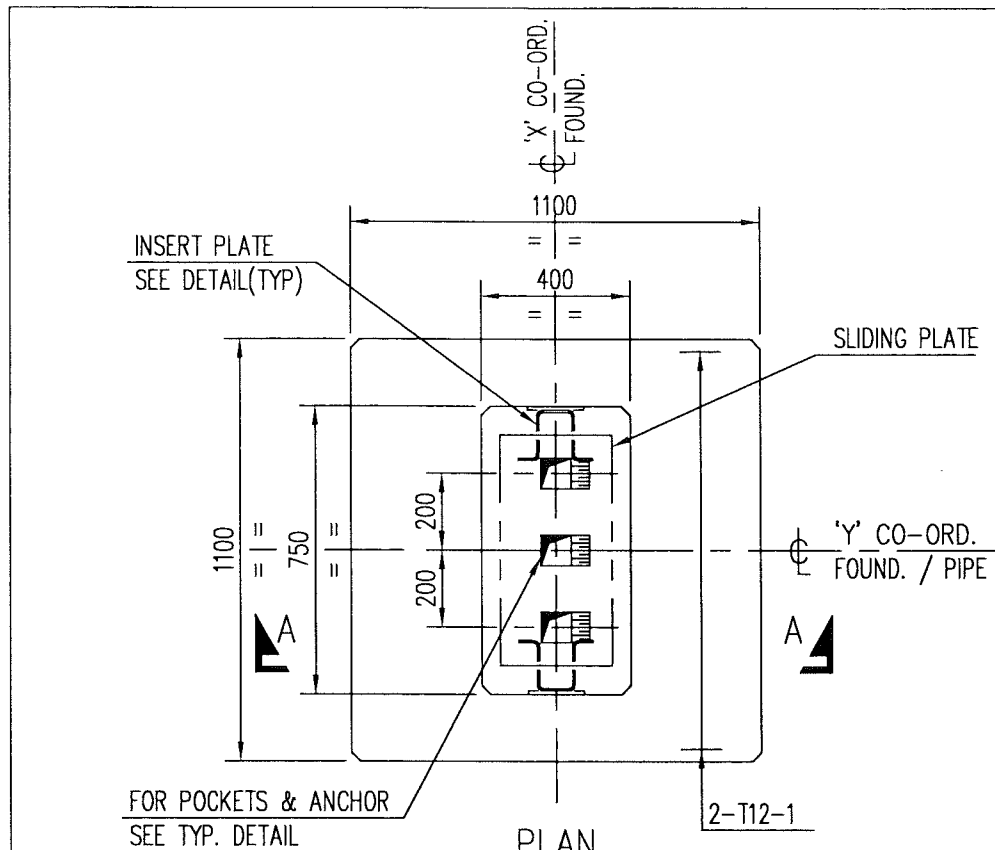

M.T.O.			
DESCRIPTION	QUANTITY	UNITS	SAP No.
BLINDING CONCRETE	0.34	m ³	N.A.
CONCRETE GRADE 35	2.63	m ³	N.A.
CEMENT SAND GROUT	32.35	dm ³	N.A.
PROTECTION COATING	23.50	m ²	N.A.
REINFORCEMENT STEEL	144.19	kgs	N.A.
10 THK PLATE	0.20	m ²	1000062608
FLAT 25x6	3.60	m	1000062571
1000g POLYTHENE SHEET	6.80	m ²	N.A.


PIPE SUPPORT	REFERENCE DRAWINGS	* GRD. ELEVATION	TOC ELEVATION	C CO-ORDINATES	
				'X'	'Y'
PS-051 **	NIM-2-0992-001-DQ-1	100.000	100.774	E 77.000	S 17.000
PS-052 **			100.776	E 74.848	S 17.000
PS-053			100.742	E 73.184	S 17.000
PS-054			100.742	E 69.200	S 17.000

NOTE: * DENOTES, SINCE GRADE ELEVATION VARIES, CONTRACTOR TO VERIFY ELEVATIONS AND DIMENSIONS AT SITE, PRIOR TO FABRICATION/CONSTRUCTION/INSTALLATION.

** TOC ELEVATION SHALL BE CHANGE ACCORDING TO VENDOR DETAIL

APPROVED FOR CONSTRUCTION

CONCRETE GRADE-35

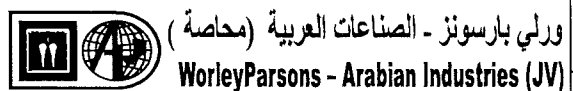

CONTRACT NO.: C31/0606 PROJ. NO.: PAIP00405

REV	DATE	DRAWN BY	CHECKED	DESCRIPTION	WBS No.	PROJ. ENG.	SIGNATURE
A	27.02.11	GCS	RB	APPROVED FOR CONSTRUCTION	IN.09.011	OSE/28N	
0	26.02.11	GCS	KBR	ISSUED FOR COMMENTS	IN.09.011	OSE/28N	

PROJECT DRAWING REVISION IN CASE OF DEVIATIONS A MARKED UP PRINT SHALL BE SENT TO THE PROJECT ENGINEER

AREA	: NIMR	SCALE : 1:20	CAD DRAWING
SUB AREA	: NIMR SLUDGE PIT SYSTEMS	NO. 16	
DRWG. TYPE	: PIPE SUPPORTS-FOUNDATION DETAILS		
DESCRIPTION	: PS-051 TO 054		
DRWG	AREA CODE	ENG SECT	SERIAL NUMBER
NO	NIM 2 1842 003 DQ 3 A		

- ALL DIMENSIONS ARE IN MILLIMETRES AND ELEVATIONS IN METRES.
- CONCRETE TO BS 8110, GRADE 35 FOR REINFORCED CONCRETE, GRADE 10 FOR BLINDING CONCRETE USING OPC.
- 50mm COVER TO REINFORCEMENT, REINFORCEMENT TO BS 4449.
- ALL CONCRETE SURFACES IN CONTACT WITH SOIL AND TOP OF BLINDING CONCRETE SHALL BE TREATED WITH THREE COATS OF "FOSROC NITOCOTE PE135" WITH A DFT OF 600 MICRONS OR EQUIVALENT APPROVED.
- ALL EXPOSED CONCRETE SURFACES SHALL BE TREATED WITH TWO COATS OF "FOSROC DEKGUARD S" WITH A DFT OF 350 MICRONS OR ANY OTHER APPROVED EQUIVALENT.
- PIPE SUPPORTS-INDEX SHEET REFER DRG. No. NIM-2-1842-001-DQ-3
- FOR BAR BENDING SCHEDULE REFER DRG. No. NIM-2-1842-004-DQ-3

NOTES/REFERENCE DRAWINGS

BAR BENDING SCHEDULE

JOB NO.: PAIP00238
PART ID.: PRODUCTION STATION
PS-051 TO 054

Document No.: NIM-2-1842-004-DQ-4

Revision No.: A

Prepared by: GCS

Checked by: PNG

Date: 27.02.11

REF. DWG NO.: NIM-2-1842-003-DQ-3

Total MTO for Rebars.

Dia. Of Bar	T6	T8	T10	T12	T16	T20	T25	T32
Length of Bar (m)		110.55	30.60	91.00				
Weight (Kgs)		44.22	18.98	80.99				

Total Weight (Kgs)

144.190

[illegible]

1c. Murex
TA2


This schedule complies with BS 8666 : 2005

All dimensions are in mm


Refer to Bar shape Code drawing

* Specified in multiples of 5 mm


† Specified in multiples of 25 mm

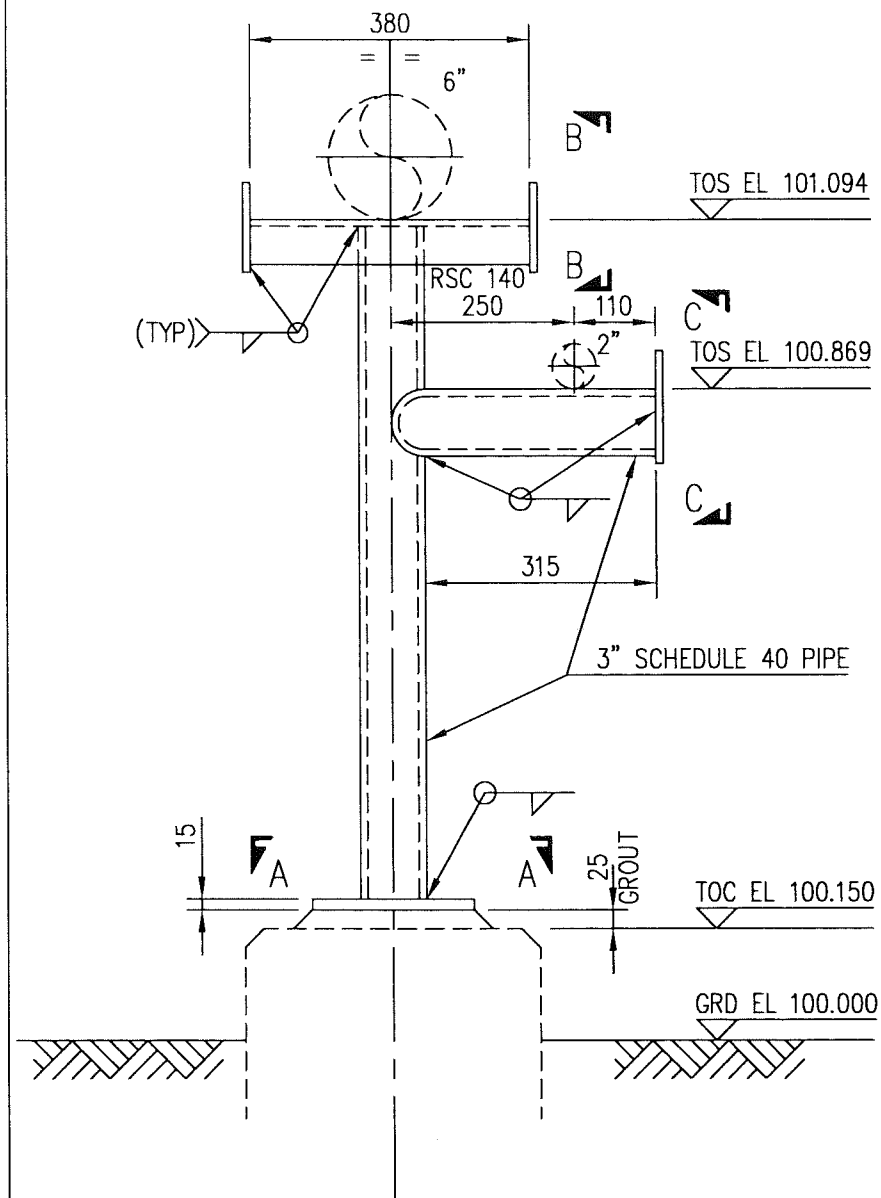


ELEVATION

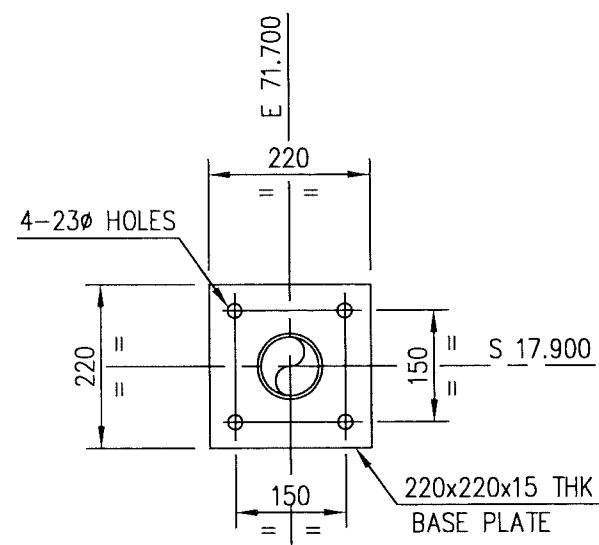

SECTION A - A

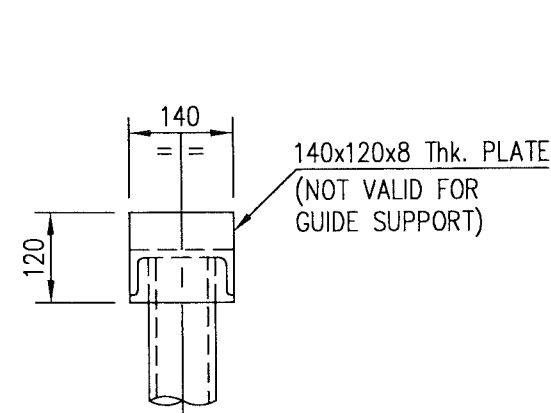

ELEVATION B - B

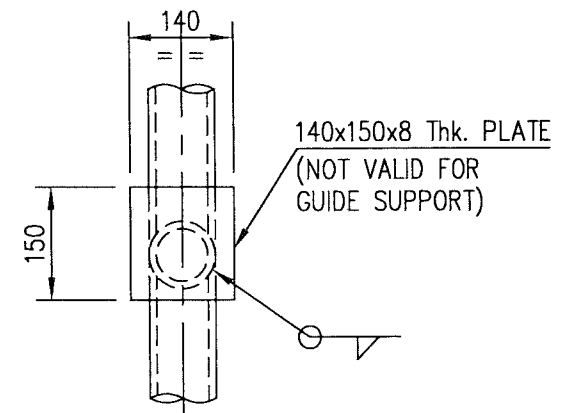


ELEVATION C - C

M T O			
DESCRIPTION	QUANTITY	UNITS	SAP No.
3" SCHEDULE 40 PIPE	1.22	m	1000051540
RSC 140	0.40	m	1000080366
15 THK PLATE	0.05	m ²	1000080265
8 THK PLATE	0.04	m ²	1000062607

NOTE: * DENOTES, SINCE GRADE ELEVATION VARIES, CONTRACTOR TO VERIFY ELEVATIONS AND DIMENSIONS AT SITE, PRIOR TO FABRICATION/CONSTRUCTION/INSTALLATION.

APPROVED FOR
CONSTRUCTION

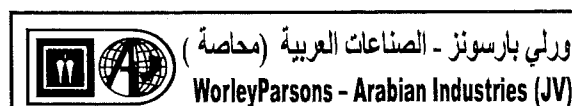

CONTRACT NO.: C31/0606 PROJ. NO.: PAIP00405

REV	DATE	DRAWN BY	CHECKED	DESCRIPTION	WBS No.	PROJ. ENG.	SIGNATURE
A	27.02.11	GCS	KBR	APPROVED FOR CONSTRUCTION	IN.09.011	OSE/28N	
O	26.02.11	GCS	KBR	ISSUED FOR COMMENTS	IN.09.011	OSE/28N	

PROJECT DRAWING REVISION
IN CASE OF DEVIATIONS A MARKED UP PRINT SHALL BE SENT TO THE PROJECT ENGINEER

- ALL DIMENSIONS ARE IN MILLIMETRES.
- ALL ELEVATIONS & CO-ORDINATES ARE IN METRES.
- ALL STEEL WORK TO BS EN 10025 GRADE S275 JR
- PIPE SECTION TO API 5L GR B.
- ALL CONNECTIONS TO BE MADE USING 5mm CFW.
- ALL STEEL WORK TO RECEIVE CORROSION PROTECTION IN ACCORDANCE WITH DOCUMENT No. SP-1246-2

NOTES

REFERENCE DRAWINGS

AREA : NIMR

SUB AREA : NIMR SLUDGE PIT SYSTEMS No. 16


DRWG. TYPE : PIPE SUPPORTS

DESCRIPTION : PS-055

SCALE : 1:20 CAD DRAWING

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Petroleum Development Oman

DRWG	AREA CODE	ENG SECT	SERIAL NUMBER	SHEET	PROJ CODE	DWG SIZE	REV.
NO	NIM	2	1842	005	DQ	3	A

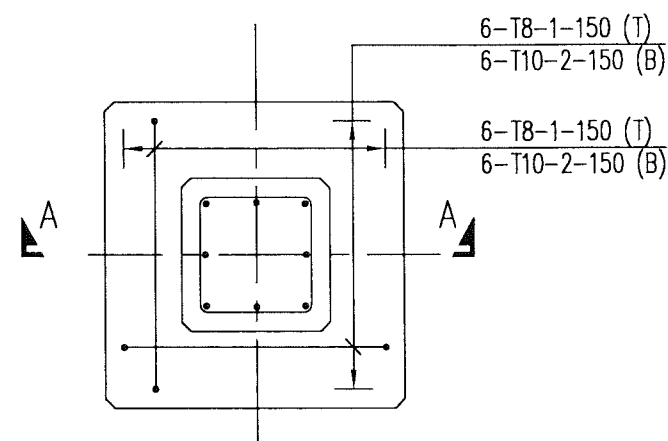

PLAN
(5 Nos. REQD)

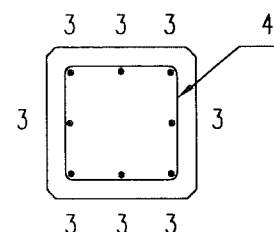


Diagram of a square with side length 5. Inside it is a smaller square with side length 5. The distance between the sides of the two squares is 5.

SECTION B - B
(FOR PS-065)

NOTE: * DENOTES, SINCE GRADE ELEVATION VARIES, CONTRACTOR TO VERIFY ELEVATIONS AND DIMENSIONS AT SITE, PRIOR TO FABRICATION/CONSTRUCTION/INSTALLATION.

1c. Miners
T A?

APPROVED FOR
CONSTRUCTION

	A	27.02.11	GCS	<i>[Signature]</i>	<i>[Signature]</i>	APPROVED FOR CONSTRUCTION	IN.09.011	OSE/28N	
	O	26.02.11	GCS	KBR	GSB	ISSUED FOR COMMENTS	IN.09.011	OSE/28N	
	REV	DATE	DRAWN BY	TEAML.	J.ENG.	DESCRIPTION	WBS No.	PROJ. ENG.	SIGNATURE
				CHECKED				P D O APPROVAL	

 وورلي بارسونز - الصناعات العربية (مخاصة)
WorleyParsons - Arabian Industries (JV)

PROJECT DRAWING REVISION

IN CASE OF DEVIATIONS A MARKED UP PRINT SHALL BE SENT TO THE PROJECT ENGINEER

- AREA : NIMR

SUB AREA : NIMR SLUDGE PIT SYSTEMS NO. 16

DRWG. TYPE : PIPE SUPPORTS—FOUNDATION DETAILS

DESCRIPTION	PS-055, 059, 062, 064 & 065
-------------	-----------------------------


SCALE : 1:20 CAD DRAWING



شركة تنمية نفط عُمان
Petrolium Development Oman

DRWG	AREA CODE	ENG SECT	SERIAL NUMBER	SHEET	PROJ CODE	DWG SIZE	REV
NO	NIM	2	1842	006	DQ	3	A

NOTES/REFERENCE DRAWINGS

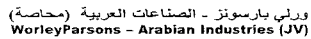

BAR BENDING SCHEDULE

JOB NO.: PAIP00238
PART ID.: PRODUCTION STATION
 PS-055,059,062,064 & 065

Document No.: NIM-2-1842-007-DQ-4

Revision No.: A

Prepared by: GCS

Checked by: PNG

Date: 27.02.11

REF. DWG NO.: NIM-2-1842-006-DQ-3

Total MTO for Rebars.

Dia. Of Bar	T6	T8	T10	T12	T16	T20	T25	T32
Length of Bar (m)		78.88	55.50	31.00				
Weight (Kgs)		31.55	34.41	27.59				

Total Weight (Kgs)

93,550

1c. Nurses
7A2

[illegible]



This schedule complies with BS 8666 : 2005

All dimensions are in mm.


Refer to Bar shape Code drawing

* Specified in multiples of 5 mm


† Specified in multiples of 25 mm

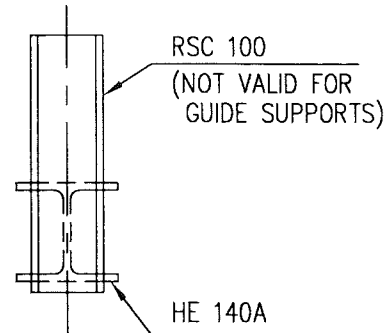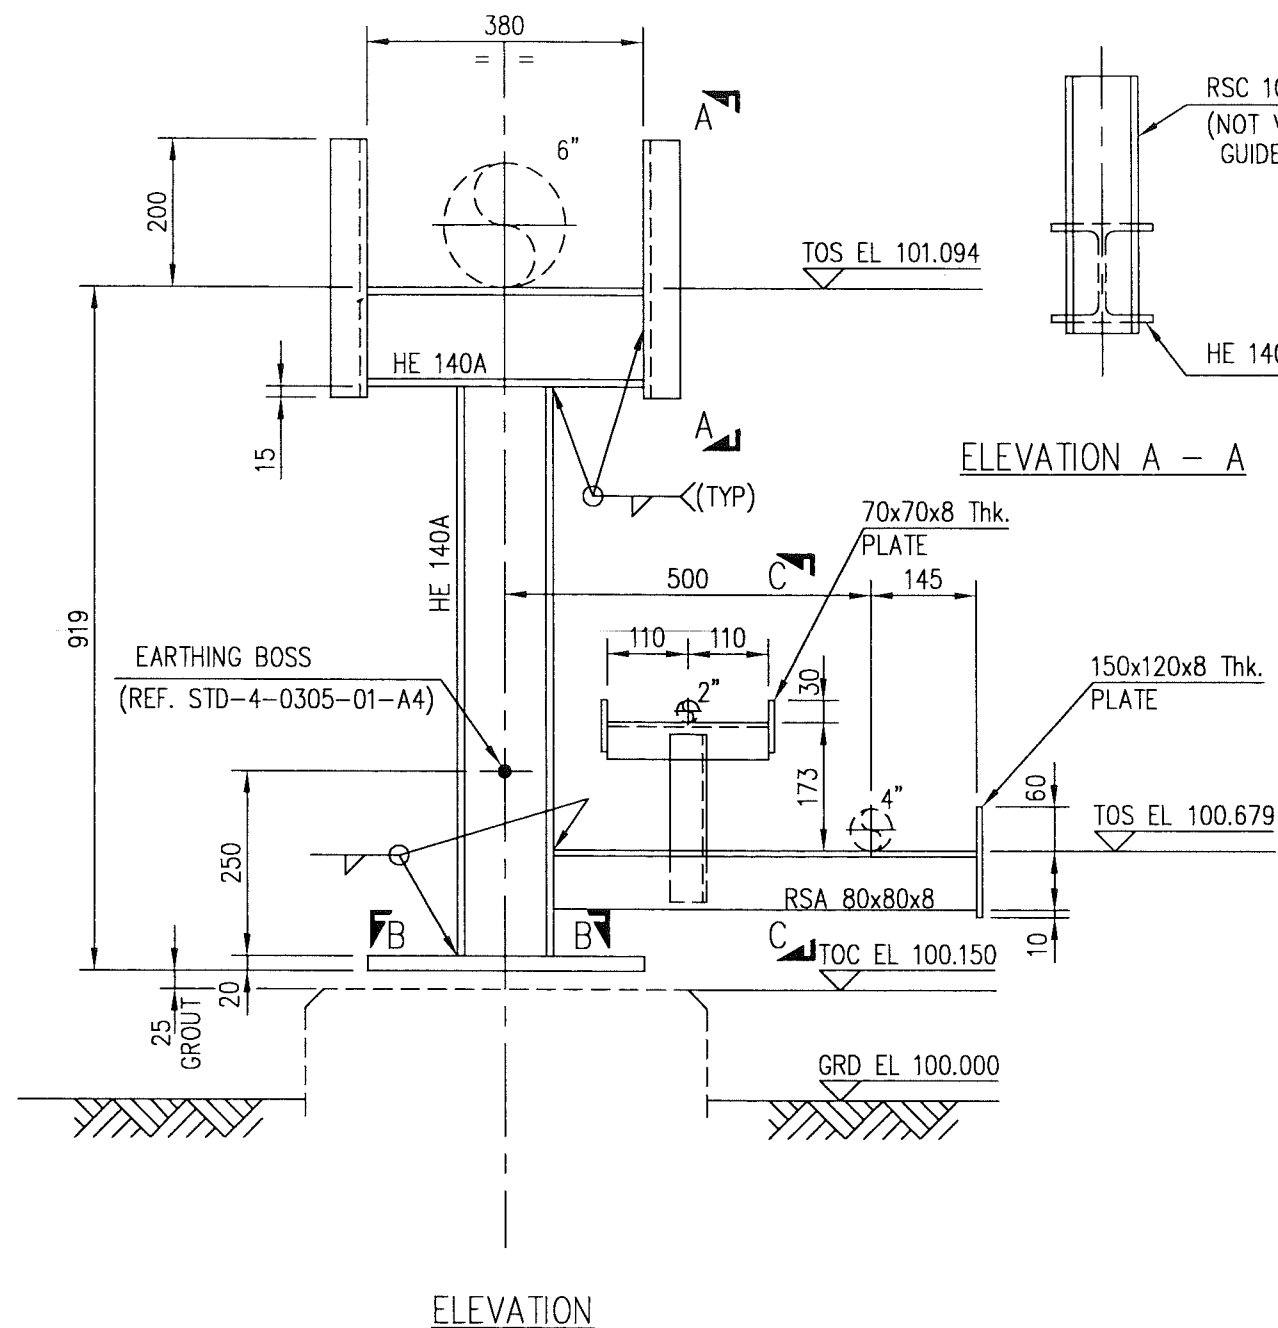

ELEVATION A - A

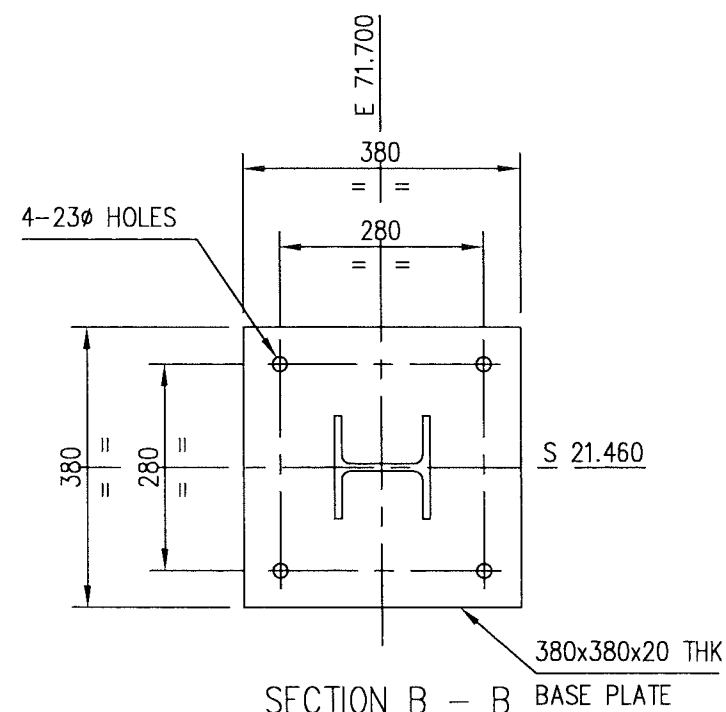

SECTION B - B

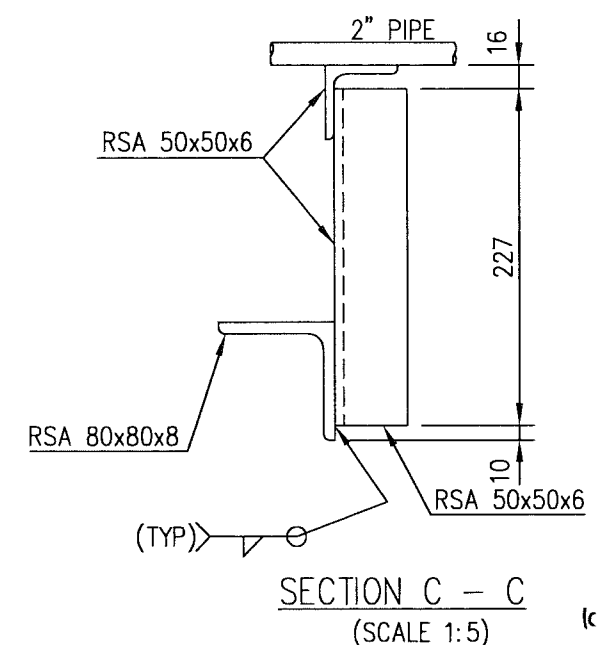

SECTION C - C
(SCALE 1:5)

APPROVED FOR
CONSTRUCTION



CONTRACT NO.: C31/0606 PROJ. NO.: PAIP00405

- ALL DIMENSIONS ARE IN MILLIMETRES.
- ALL ELEVATIONS & CO-ORDINATES ARE IN METRES.
- ALL STEEL WORK TO BS EN 10025 GRADE S275 JR.
- ALL CONNECTIONS TO BE MADE USING 6mm CFW.
- ALL STEEL WORK TO RECEIVE CORROSION PROTECTION IN ACCORDANCE WITH DOCUMENT No. SP-1246-2

NOTES





REFERENCE DRAWINGS

REV	DATE	DRAWN BY	TEAM	J.ENG.	CHECKED	DESCRIPTION	WBS No.	PROJ. ENG.	SIGNATURE
A	27.02.11	GCS	RB	Y		APPROVED FOR CONSTRUCTION	IN.09.011	OSE/28N	
O	26.02.11	GCS	KBR	GSB		ISSUED FOR COMMENTS	IN.09.011	OSE/28N	

PROJECT DRAWING REVISION
IN CASE OF DEVIATIONS A MARKED UP PRINT SHALL BE SENT TO THE PROJECT ENGINEER

AREA : NIMR
SUB AREA : NIMR SLUDGE PIT SYSTEMS No. 16
DRWG. TYPE : PIPE SUPPORTS
DESCRIPTION : PS-056

SCALE : 1:20	CAD DRAWING
0 1 2 3 4 5 6 7	
شركة تنمية نفط عمان	Petroleum Development Oman
DRWG	AREA
ENG	SECT
SERIAL	NUMBER
SHEET	PROJ
CODE	DWG
NO	SIZE
NIM	2
1842	008
DQ	3
A	

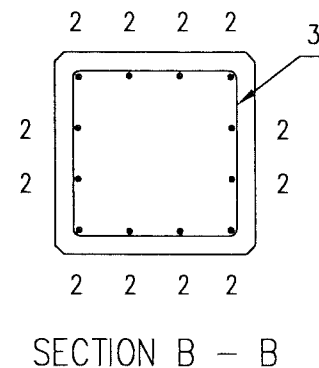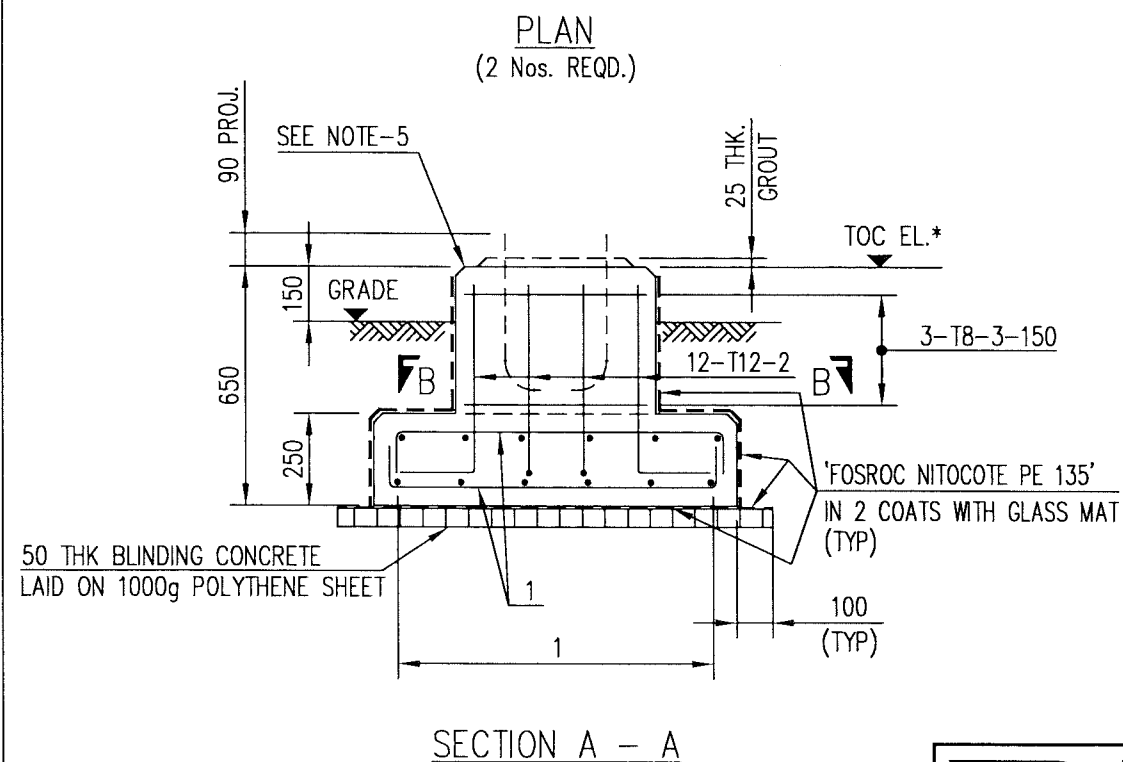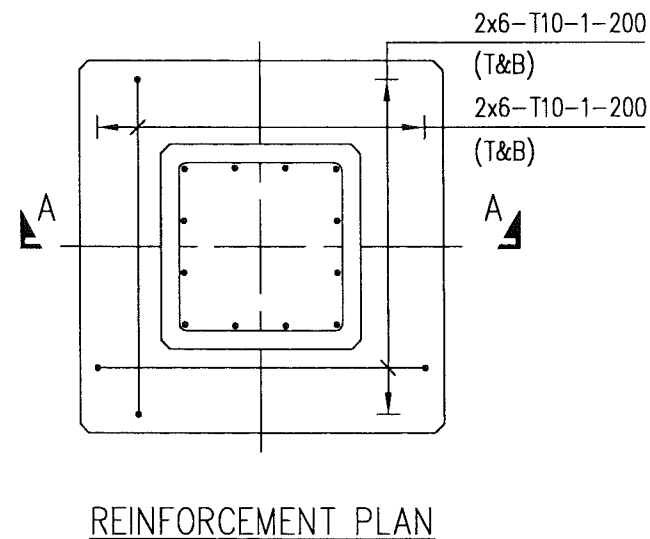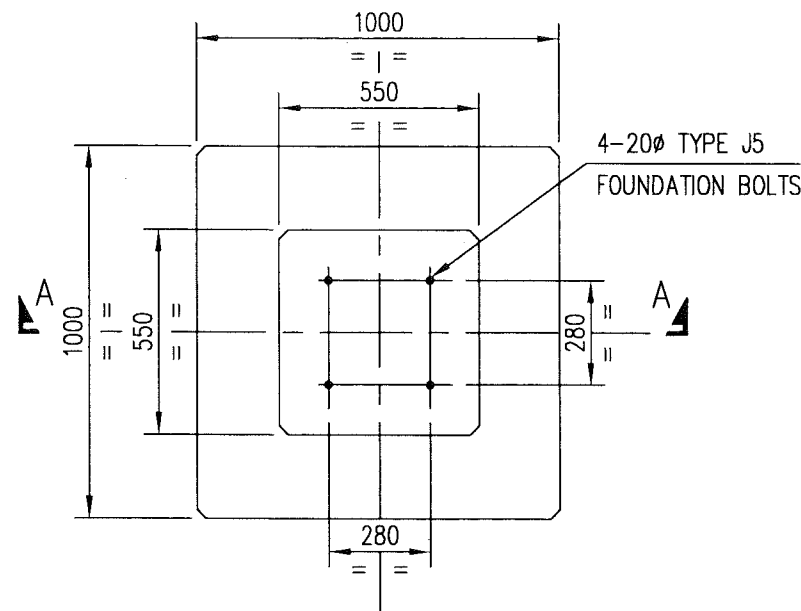[illegible]

NOTE: * DENOTES, SINCE GRADE ELEVATION VARIES, CONTRACTOR TO VERIFY ELEVATIONS AND DIMENSIONS AT SITE, PRIOR TO FABRICATION/CONSTRUCTION/INSTALLATION.

M T O			
DESCRIPTION	QUANTITY	UNITS	SAP No.
BLINDING CONCRETE GRADE 10	0.15	m ³	N.A.
CONCRETE GRADE 35	0.742	m ³	N.A.
CEMENT SAND GROUT	10.52	lit	N.A.
REINFORCEMENT STEEL	53.71	Kg	N.A.
PROTECTIVE COATING	8.06	m ²	N.A.
20ø FOUNDATION BOLT TYPE – J5	8	PCS	N.A.
POLYTHENE SHEET	2.90	PCS	N.A.

APPROVED FOR
CONSTRUCTION

A	27.02.11	GCS	PB	J.S.	APPROVED FOR CONSTRUCTION	IN.09.011	OSE/28N	
O	26.02.11	GCS	KBR	GSB	ISSUED FOR COMMENTS	IN.09.011	OSE/28N	
REV	DATE	DRAWN BY	TEAML	J.ENG.	DESCRIPTION	WBS No.	PROJ. ENG.	SIGNATURE
			CHECKED				P D O APPROVAL	

[THIS DRAWING IS BASED ON P.D.O. DRG. No.
STD-2-3903-001-A3-E - TYPE 903]

1. ALL DIMENSIONS ARE IN MILLIMETRES AND ELEVATIONS IN METRES.
2. CONCRETE TO BS 8110, GRADE 35 FOR REINFORCED CONCRETE, GRADE 10 FOR BLINDING CONCRETE USING OPC.
3. 50mm COVER TO REINFORCEMENT, REINFORCEMENT TO BS 4449.
4. ALL EDGES SHALL HAVE A CHAMFER OF APPROX. 25mm.
5. ALL EXPOSED CONCRETE SURFACES SHALL BE TREATED WITH TWO COATS OF "FOSROC DEKGUARD S" WITH A DFT OF 350 MICRONS OR ANY OTHER APPROVED EQUIVALENT.
6. FOUNDATION BOLTS REFER DRG. No. STD-2-3950-001-A3
7. FOR BAR BENDING SCHEDULE REFER DRG. No. NIM-2-1842-010-DQ-3

  **ورلي بارسونز - الصناعات العربية (محاصة)**
WorleyParsons - Arabian Industries (JV)

CONTRACT NO.: C31/0606	PROJ. NO.: PAIP00405
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IN CASE OF DEVIATIONS A MARKED UP PRINT SHALL BE SENT TO THE PROJECT ENGINEER

AREA : NIMR

SUB AREA : NIMR SLUDGE PIT SYSTEMS NO. 16

DRWG. TYPE : PIPE SUPPORTS—FOUNDATION DETAILS

DESCRIPTION : PS-056 & PS-060

SCALE : 1:20 CAD DRAWING



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Petroleum Development Oman

DRWG	AREA CODE	ENG SECT	SERIAL NUMBER	SHEET	PROJ CODE	DWG SIZE	REV.
NO	NIM	2	1842 009	DQ	3	A	

BAR BENDING SCHEDULE

JOB NO.: PAIP00238
PART ID.: PRODUCTION STATION
PS-056 & 060

Document No.: NIM-2-1842-010-DQ-4

Revision No.: A

Prepared by: GCS

Checked by: PNG

Date: 27.02.11

REF. DWG NO.: NIM-2-1842-009-DQ-3

Total MTO for Rebars.

Dia. Of Bar	T6	T8	T10	T12	T16	T20	T25	T32
Length of Bar (m)		11.85	54.00	17.40				
Weight (Kgs)		4.74	33.48	15.49				

Total Weight (Kgs)

53,710

[illegible]

This schedule complies with BS 8666 : 2005

All dimensions are in mm


Refer to Bar shape Code drawing

* Specified in multiples of 5 mm

† Specified in multiples of 25 mm



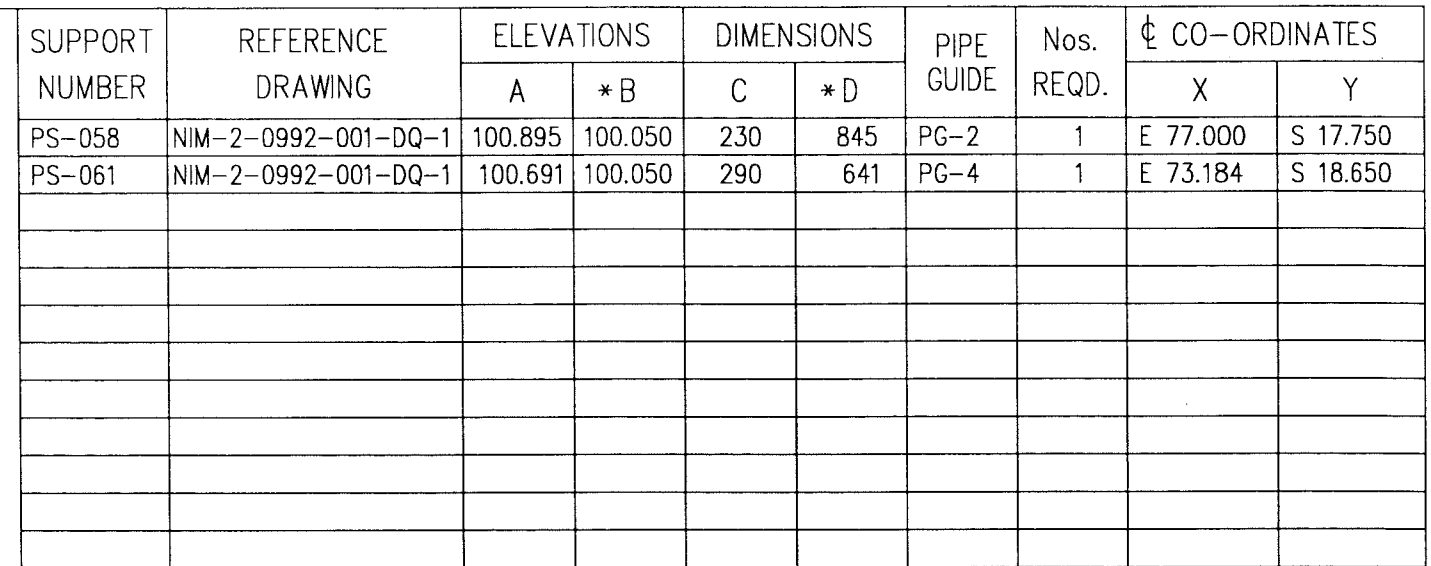

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


M T O			
DESCRIPTION	QUANTITY	UNITS	SAP No.
3" SCHEDULE 40 PIPE	2.10	m	1000051540
3 THK PLATE	0.01	m ²	1000062605
RSC 140	0.52	m	1000080366
A 193 MESH FABRIC	1.28	m ²	1000062697
BLINDING CONCRETE	0.05	m ³	N.A.
CONCRETE GRADE 35	0.20	m ³	N.A.
1000g POLYTHENE SHEET	0.98	m ²	N.A.
PROTECTIVE COATING	3.50	m ²	N.A.


APPROVED FOR
CONSTRUCTION

-  ورلي بارسونز - الصناعات العربية (محصاة)
WorleyParsons - Arabian Industries (JV)


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O	26.02.11	GCS	KBR	GSB	ISSUED FOR COMMENTS	IN.09.011	OSE/28N	
REV	DATE	DRAWN BY	TEAML.	J.ENG.	DESCRIPTION	WBS No.	PROJ. ENG.	SIGNATURE
			CHECKED				P D O APPROVAL	

3	AREA : NIMR		SCALE : 1:20		CAD DRAWING							
	SUB AREA : NIMR SLUDGE PIT SYSTEMS		NO. 16		 شركة تنمية نفط عُمان Petroleum Development Oman							
S	DRWG. TYPE : PIPE SUPPORTS				DRWG	AREA CODE	ENG SECT	SERIAL NUMBER	SHEET	PROJ CODE	DRWG SIZE	REV.
	DESCRIPTION : PS-058 & 061				NO	NIM	2	1842	012	DQ	3	A


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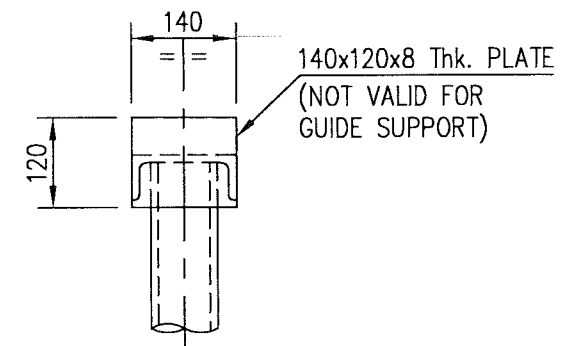
ELEVATION

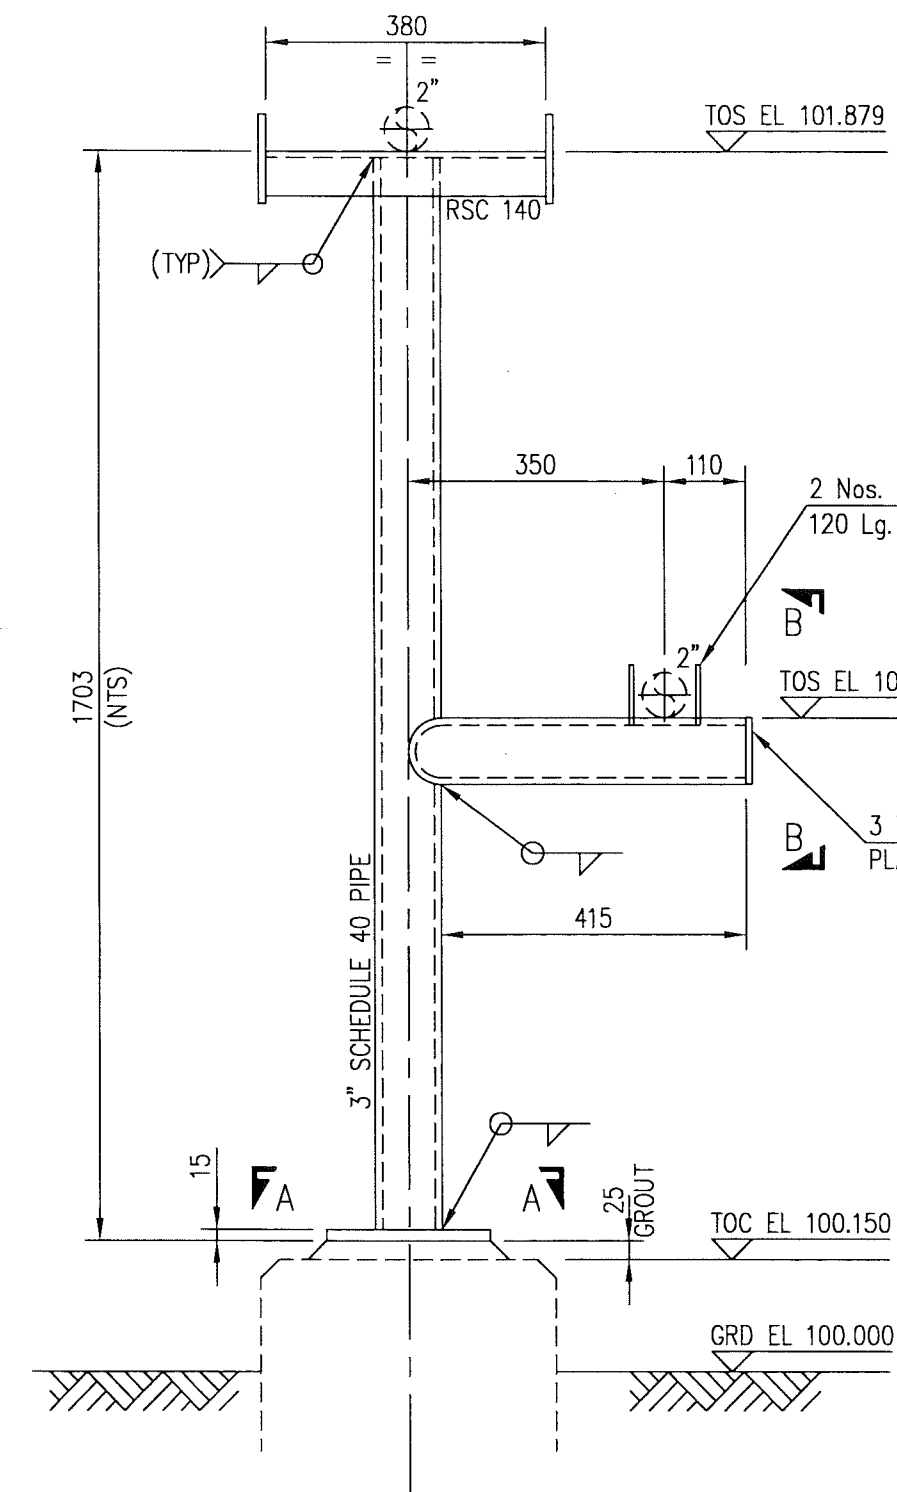

SECTION A - A

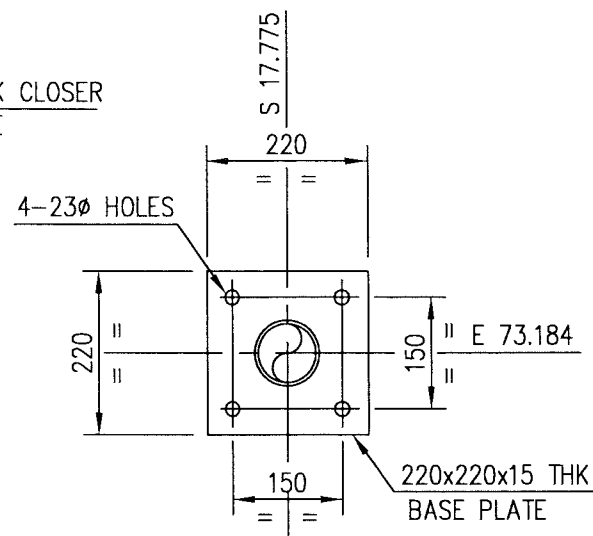

ELEVATION B - B

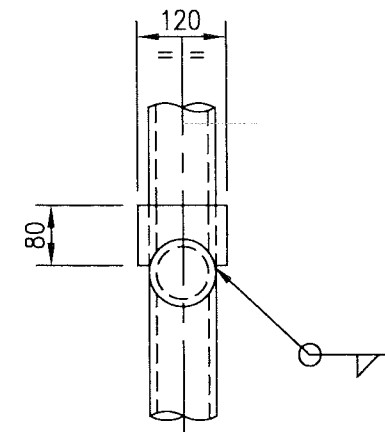

ELEVATION C - C

M T O			
DESCRIPTION	QUANTITY	UNITS	SAP No.
3" SCHEDULE 40 PIPE	1.70	m	1000051540
RSC 140	0.40	m	1000080366
15 THK PLATE	0.05	m ²	1000080265
8 THK PLATE	0.04	m ²	1000062607
FLAT 80x6	0.24	m	1000062576
3 THK CLOSER PLATE	0.06	m ²	1000062605

NOTE: * DENOTES, SINCE GRADE ELEVATION VARIES, CONTRACTOR TO VERIFY ELEVATIONS AND DIMENSIONS AT SITE, PRIOR TO FABRICATION/CONSTRUCTION/INSTALLATION.

APPROVED FOR CONSTRUCTION



CONTRACT NO.: C31/0606 PROJ. NO.: PAIP00405

REV	DATE	DRAWN BY	TEAM	J.ENG.	DESCRIPTION	WBS No.	PROJ. ENG.	SIGNATURE
A	27.02.11	GCS	RB	Y	APPROVED FOR CONSTRUCTION	IN.09.011	OSE/28N	
O	26.02.11	GCS	KBR	GSB	ISSUED FOR COMMENTS	IN.09.011	OSE/28N	

PROJECT DRAWING REVISION
IN CASE OF DEVIATIONS A MARKED UP PRINT SHALL BE SENT TO THE PROJECT ENGINEER

- ALL DIMENSIONS ARE IN MILLIMETRES.
- ALL ELEVATIONS & CO-ORDINATES ARE IN METRES.
- ALL STEEL WORK TO BS EN 10025 GRADE S275 JR
- PIPE SECTION TO API 5L GR B.
- ALL CONNECTIONS TO BE MADE USING 5mm CFW.
- ALL STEEL WORK TO RECEIVE CORROSION PROTECTION IN ACCORDANCE WITH DOCUMENT No. SP-1246-2



NOTES

PIPE GUIDE DETAILS	NIM	2	1842	018	DQ	3
DESCRIPTION	AREA	S	SERIAL	SH.	P	S

REFERENCE DRAWINGS

AREA : NIMR	SCALE : 1:20	CAD DRAWING
SUB AREA : NIMR SLUDGE PIT SYSTEMS	No. 16	
DRWG. TYPE : PIPE SUPPORTS		
DESCRIPTION : PS-059		


DRWG	AREA	ENG	SERIAL	SHEET	PROJ	REV.
NO	NIM	2	1842	013	DQ	3

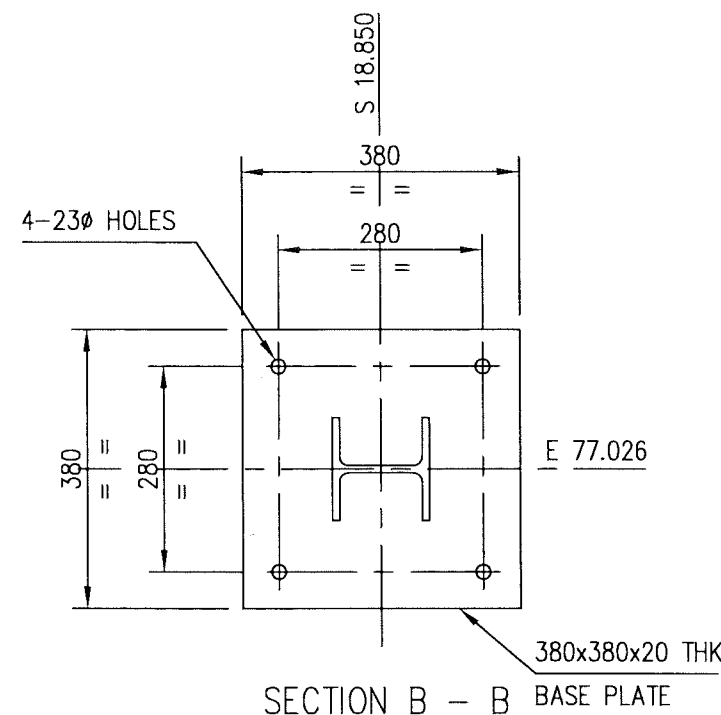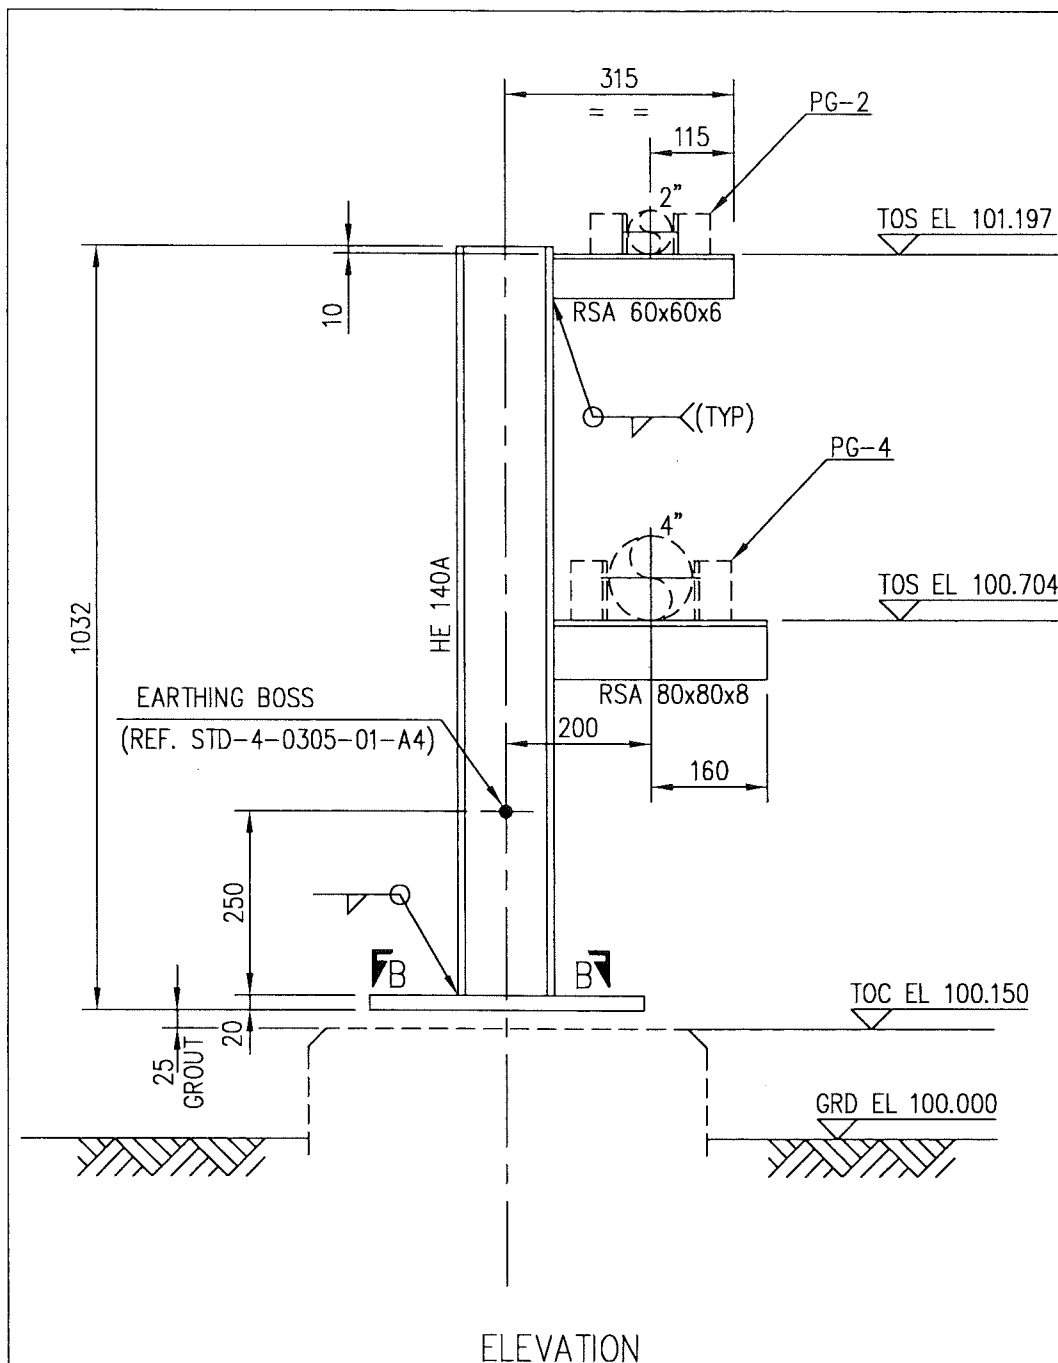

M.T.O.			
DESCRIPTION	QUANTITY	UNITS	SAP No.
HE 140 A	1.02	m	1000080438
RSA 80x80x8	0.30	m	1000062630
RSA 60x60x6	0.25	m	1000080320
20 THK PLATE	0.15	m ²	1000062610
EARTHING BOSS	1	PCS	N.A.

NOTE: * DENOTES, SINCE GRADE ELEVATION VARIES, CONTRACTOR TO VERIFY ELEVATIONS AND DIMENSIONS AT SITE, PRIOR TO FABRICATION/CONSTRUCTION/INSTALLATION.

APPROVED FOR
CONSTRUCTION

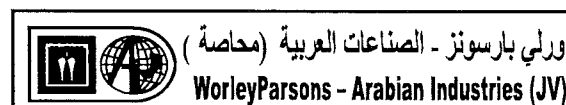

CONTRACT NO. : C31/0606 PROJ. NO. : PAIP00405

- ALL DIMENSIONS ARE IN MILLIMETRES.
- ALL ELEVATIONS & CO-ORDINATES ARE IN METRES.
- ALL STEEL WORK TO BS EN 10025 GRADE S275 JR.
- ALL CONNECTIONS TO BE MADE USING 6mm CFW.
- ALL STEEL WORK TO RECEIVE CORROSION PROTECTION IN ACCORDANCE WITH DOCUMENT No. SP-1246-2

PIPE GUIDE DETAILS					
DESCRIPTION	AREA	S	SERIAL	SH.	P
DRAWING NUMBER					

NOTES


REFERENCE DRAWINGS

REV	DATE	DRAWN BY	TEAM	J.ENG.	CHECKED	DESCRIPTION	WBS No.	PROJ. ENG.	SIGNATURE
A	27.02.11	GCS	RB	Y		APPROVED FOR CONSTRUCTION	IN.09.011	OSE/28N	
O	26.02.11	GCS	KBR	GSB		ISSUED FOR COMMENTS	IN.09.011	OSE/28N	

PROJECT DRAWING REVISION
IN CASE OF DEVIATIONS A MARKED UP PRINT SHALL BE SENT TO THE PROJECT ENGINEER

AREA : NIMR
SUB AREA : NIMR SLUDGE PIT SYSTEMS No. 16
DRWG. TYPE : PIPE SUPPORTS
DESCRIPTION : PS-060

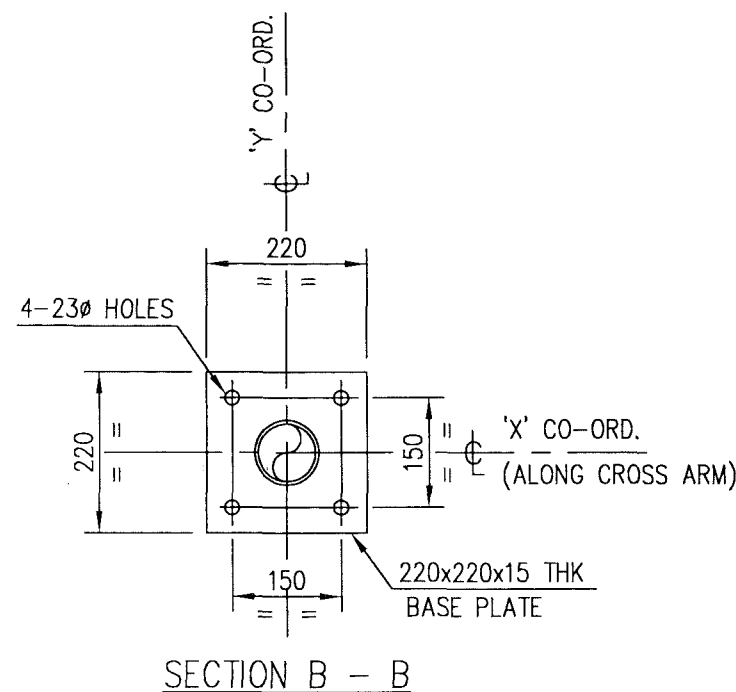

SCALE : 1:20 CAD DRAWING						
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شركة تنمية نفط عُمان Petroleum Development Oman						
DRWG	AREA CODE	ENG SECT	SERIAL NUMBER	SHEET	PROJ CODE	REV.
NO	NIM	2	1842	014	DQ	3 A





NOTE: ✱ DENOTES, SINCE GRADE ELEVATION VARIES, CONTRACTOR TO VERIFY ELEVATIONS AND DIMENSIONS AT SITE, PRIOR TO FABRICATION/CONSTRUCTION/INSTALLATION.


APPROVED FOR
CONSTRUCTION


	A	27.02.11	GCS			APPROVED FOR CONSTRUCTION	IN.09.011	OSE/28N	
	O	26.02.11	GCS	KBR	GSB	ISSUED FOR COMMENTS	IN.09.011	OSE/28N	
	REV	DATE	DRAWN BY	TEAM L.	J. ENG.	DESCRIPTION	WBS No.	PROJ. ENG.	SIGNATURE
				CHECKED				P D O APPROVAL	



 (محاصة) وولي پارسونز - الصناعات العربية
WorleyParsons - Arabian Industries (JV)
 CONTRACT NO. : **C31/0606** PROJ. NO. : **PAIP00405**

1. ALL DIMENSIONS ARE IN MILLIMETRES.	PIPE GUIDE DETAILS		NIM	2	1842	018	DQ	3
2. ALL ELEVATIONS & CO-ORDINATES ARE IN METRES.								
3. ALL STEEL WORK TO BS EN 10025 GRADE S275 JR								
4. PIPE SECTION TO API 5L GR B.								
5. ALL CONNECTIONS TO BE MADE USING 5mm CFW.								
6. ALL STEEL WORK TO RECEIVE CORROSION PROTECTION IN ACCORDANCE WITH DOCUMENT No. SP-1246-2	DESCRIPTION		AREA	S	SERIAL	SH.	P	S
			DRAWING NUMBER					
NOTES	REFERENCE DRAWINGS							

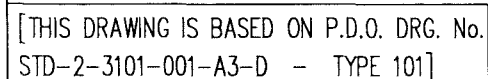
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IN CASE OF DEVIATIONS A MARKED UP PRINT SHALL BE SENT TO THE PROJECT ENGINEER														
3	AREA : NIMR						SCALE : 1: 20 0 1 2 3 4 5 6 7  CAD DRAWING							
	SUB AREA : NIMR SLUDGE PIT SYSTEMS					NO. 16	 شركة تنمية نفط عُمان Petroroleum Development Oman							
S	DRWG. TYPE : PIPE SUPPORTS						DRWG	AREA CODE	ENG SECT	SERIAL NUMBER	SHEET	PROJ CODE	DWG SIZE	REV.
	DESCRIPTION : PS-062, 064 & 065						NO	NIM	2	1842	015	DQ	3	A



-  ورلي بارسونز - الصناعات العربية (مخاصة)
WorleyParsons - Arabian Industries (JV)

	A	27.02.11	GCS	BB	YJ	APPROVED FOR CONSTRUCTION	IN.09.011	OSE/28N	
	O	26.02.11	GCS	KBR	GSB	ISSUED FOR COMMENTS	IN.09.011	OSE/28N	
	REV	DATE	DRAWN BY	TEAM L.	J.ENG.	DESCRIPTION	WBS No.	PROJ. ENG.	SIGNATURE
				CHECKED				P D O APPROVAL	

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
ELEVATION

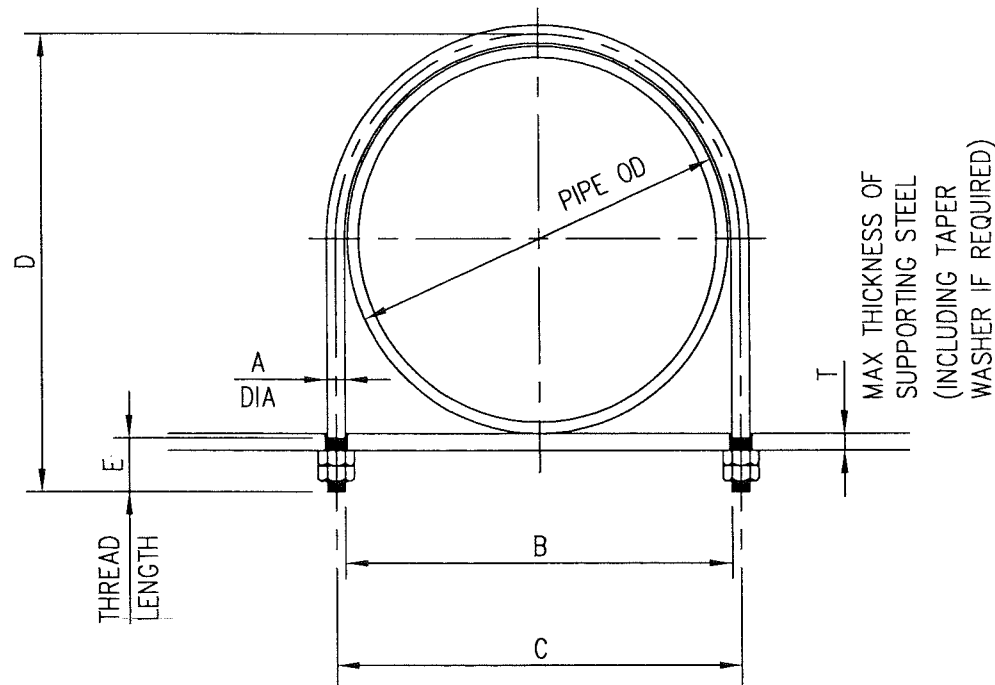PIPE GUIDE DESIGNATION	NOMINAL PIPE SIZE		PIPE OD	DIMENSIONS						Nos. REQD.
	INCHES	MM		A	B	C	D	E	T	
UG-0.5	1/2"	15	21.3	8	22	30	50	25	10	-
UG-0.75	3/4"	20	26.7	8	27	35	60	25	10	-
UG-1	1"	25	33.4	8	37	45	65	25	10	-
UG-1.5	1 1/2"	40	48.3	10	50	60	90	35	16	-
UG-2	2"	50	60.3	10	65	75	100	35	16	1
UG-3	3"	80	88.9	16	89	105	150	50	19	-
UG-4	4"	100	114.3	16	119	135	175	50	19	-
UG-6	6"	150	168.3	20	170	190	235	55	19	-
UG-8	8"	200	219.1	20	225	245	295	60	19	-
UG-10	10"	250	273.0	20	280	300	350	60	22	-
UG-12	12"	300	323.9	20	330	350	400	60	22	-
UG-14	14"	350	355.6	24	361	385	440	65	22	-
UG-16	16"	400	406.4	24	411	435	490	65	22	-
UG-18	18"	450	457.0	24	461	485	540	70	22	-
UG-20	20"	500	508.0	24	516	540	590	70	22	-
UG-24	24"	600	610.0	24	616	640	700	70	22	-
UG-28	28"	700	711.2	24	711	735	800	70	22	-
UG-30	30"	750	762.0	24	766	790	850	70	22	-

MATERIAL GUIDE					
BAR		NUTS		LOCKNUTS	
SIZE	SAP NO No.	SIZE	SAP NO:	SIZE	SAP No.
8	1000080335	M8	1000063795	M8	1000080222
10	1000062586	M10	1000063796	M10	1000063819
16	1000062588	M16	1000063798	M16	1000063820
20	N.A.	M20	1000063799	M20	1000063821
24	N.A.	M24	1000120055	M24	1000120066

APPROVED FOR CONSTRUCTION

[THIS DRAWING IS BASED ON P.D.O. DRG. No. STD-2-3817-001-A3-D - TYPE 817]


ورلي بارسونز - الصناعات العربية (محاصة)
WorleyParsons - Arabian Industries (JV)
 CONTRACT NO.: C31/0606 PROJ. NO.: PAIP00405

REV	DATE	DRAWN BY	TEAM L	J.ENG.	CHECKED	DESCRIPTION	WBS No.	PROJ. ENG.	SIGNATURE
A	27.02.11	GCS	RB	YB		APPROVED FOR CONSTRUCTION	IN.09.011	OSE/28N	
O	26.02.11	GCS	KBR	GSB		ISSUED FOR COMMENTS	IN.09.011	OSE/28N	


PROJECT DRAWING REVISION
IN CASE OF DEVIATIONS A MARKED UP PRINT SHALL BE SENT TO THE PROJECT ENGINEER

- ALL DIMENSIONS ARE IN MILLIMETRES.
 - EACH BOLT TO BE SUPPLIED WITH 2 NUTS & 2 LOCKNUTS.
 - MATERIAL-BOLTS TO BS EN 10025 GR S275 JR NUTS TO ISO 898/11 GR 8
 - U-BOLT CORROSION PROTECTION SHALL COMPLY WITH SP-1246-2
- NOTES

DESCRIPTION	AREA	S	SERIAL	SH.	P	S
DRAWING NUMBER						
REFERENCE DRAWINGS						

AREA	: NIMR	
SUB AREA	: NIMR SLUDGE PIT SYSTEMS	No. 16
DRWG. TYPE	: PIPE SUPPORTS	
DESCRIPTION	: 'U' BOLT (PIPE GRIPPED) DETAILS	

SCALE : —
 0 1 2 3 4 5 6 7
شركة تنمية نفط عمان
 Petroleum Development Oman
 DRWG AREA ENG SERIAL SHEET PROJ DWG REV.
 CODE CODE SECT NUMBER NUMBER CODE SIZE
 NO NIM 2 1842 017 DQ 3 A

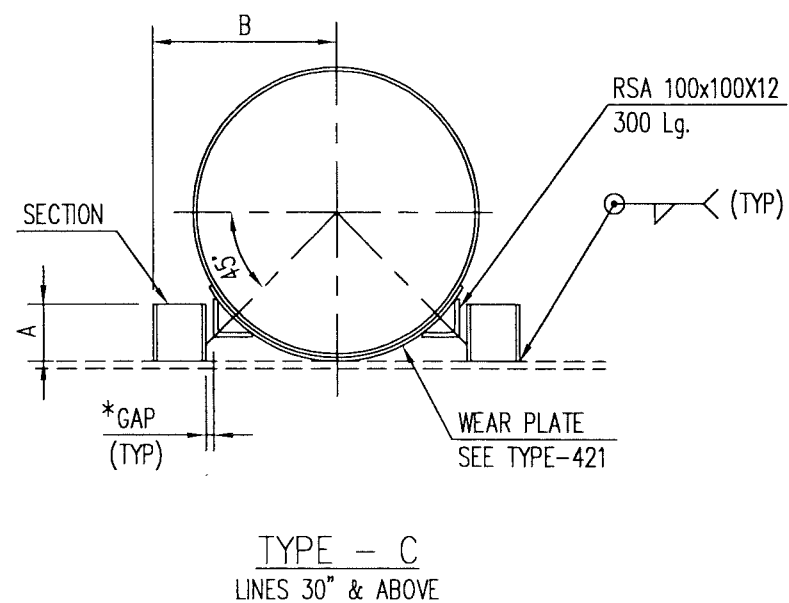



FOR LOCATION REFER PIPING GA.

M T O

DESCRIPTION	QUANTITY	UNITS	SAP No.
RSC 160	—	m	1000062643
RSC 140	—	m	1000080366
RSC 100	—	m	1000145612
RSA 100x100x12	—	m	1000142036
RSA 50x50x6	26.72	m	1000062629

APPROVED FOR
CONSTRUCTION

	A	27.02.11	GCS			APPROVED FOR CONSTRUCTION	IN.09.011	OSE/28N	
	O	26.02.11	GCS	KBR	GSB	ISSUED FOR COMMENTS	IN.09.011	OSE/28N	
9	REV	DATE	DRAWN BY	TEAML.	J.ENG.	DESCRIPTION	WBS No.	PROJ. ENG.	SIGNATURE
				CHECKED				P D O APPROVAL	


 ورلي بارسونز - الصناعات العربية (محاصة)
WorleyParsons - Arabian Industries (JV)
 CONTRACT NO.: **C31/0606** PROJ. NO.: **PAIP00405**

DESCRIPTION	AREA	S	SERIAL	SH.	P	
	DRAWING NUMBER					


REFERENCE DRAWINGS

PROJECT DRAWING REVISION	
IN CASE OF DEVIATIONS A MARKED UP PRINT SHALL BE SENT TO THE PROJECT ENGINEER	

DESCRIPTION	: PIPE GUIDE DETAILS
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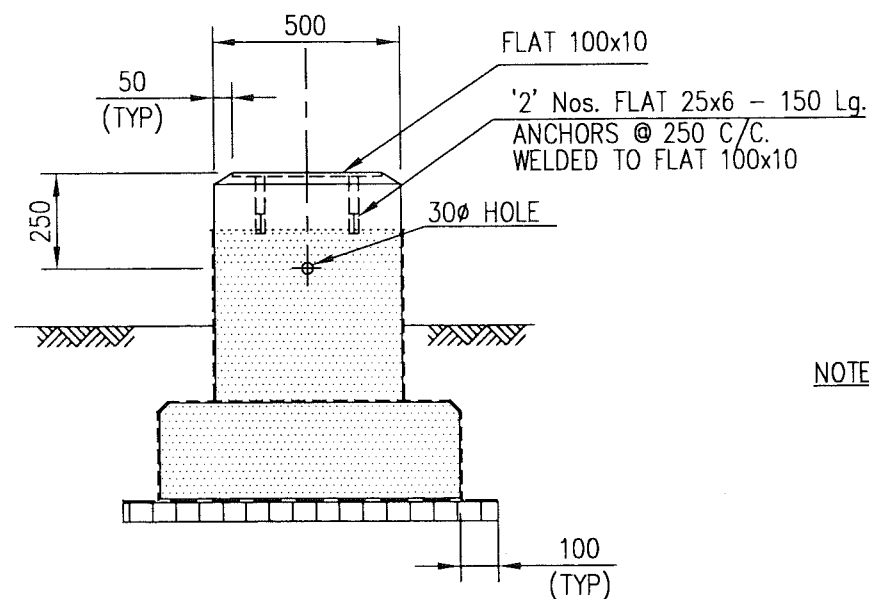
 **شركة تنمية نفط عُمان**
Petro Development Oman

DRWG	AREA CODE	ENG SECT	SERIAL NUMBER	SHEET	PROJ CODE	DWG SIZE	REV.
NO	NIM	2	1842	018	DQ	3	A

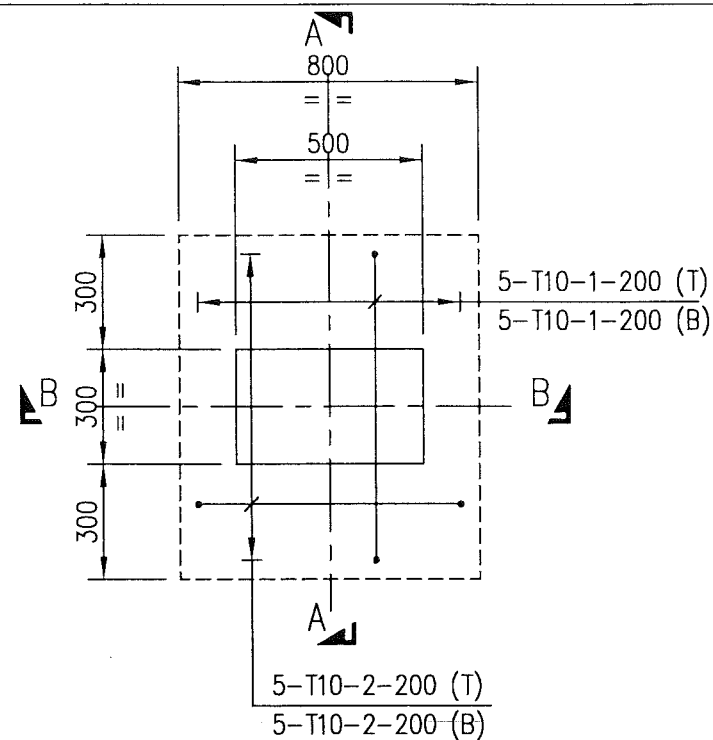

SL-001
(222 Nos. REQD)


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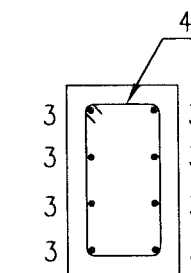
SECTION B-B

NOTE: * DENOTES, SINCE GRADE ELEVATION VARIES, CONTRACTOR TO VERIFY ELEVATIONS AND DIMENSIONS AT SITE, PRIOR TO FABRICATION/CONSTRUCTION/INSTALLATION.

M T O			
DESCRIPTION	QUANTITY	UNITS	SAP No.
BLINDING CONCRETE	12.21	m ³	N.A.
CONCRETE GRADE 35	61.61	m ³	N.A.
REINFORCEMENT STEEL	5144.30	Kg	N.A.
FLAT 100x10	88.80	m	1000062581
FLAT 25x6	66.60	m	1000062571
PROTECTIVE COATING	737.05	m ²	N.A.
1000g POLYTHENE SHEET	244.20	m ²	N.A.



SECTION A-A

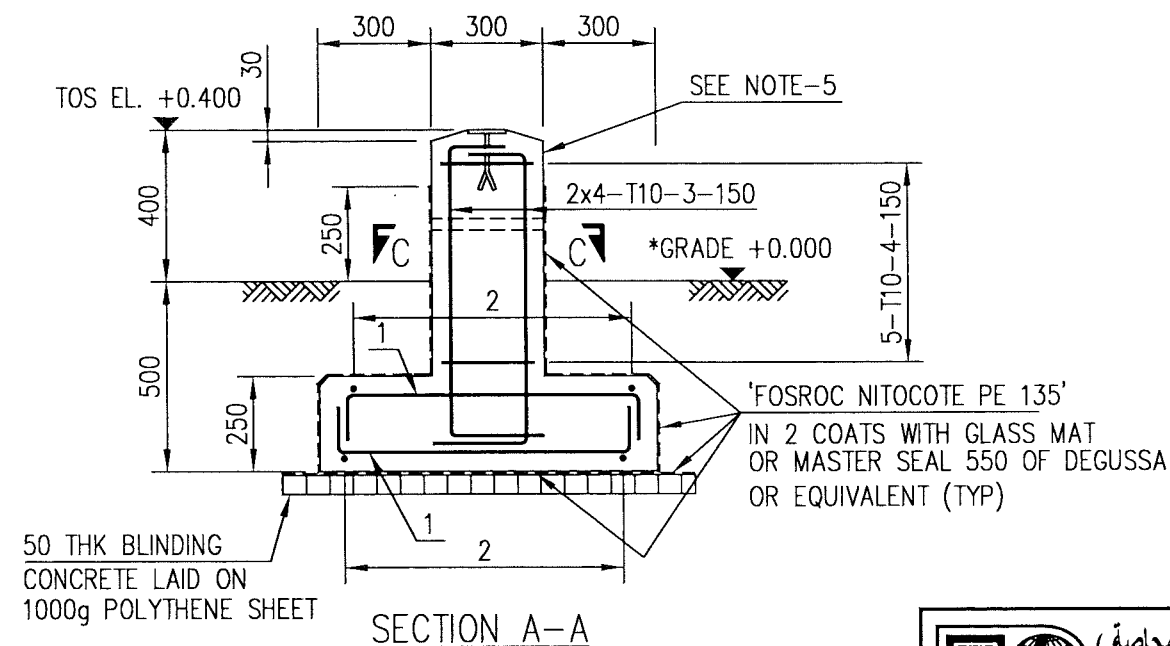

SECTION C-C

APPROVED FOR
CONSTRUCTION


ورلي بارسونز - الصناعات العربية (محاصة)
WorleyParsons - Arabian Industries (JV)
 CONTRACT NO. : C31/0606 PROJ. NO. : PAIP00405

REV	DATE	DRAWN BY	CHECKED	DESCRIPTION	WBS No.	PROJ. ENG.	SIGNATURE
A	27.02.11	GCS	RR	APPROVED FOR CONSTRUCTION	IN.09.011	OSE/28N	
O	26.02.11	JRP	KBR	ISSUED FOR COMMENTS	IN.09.011	OSE/28N	

PROJECT DRAWING REVISION
IN CASE OF DEVIATIONS A MARKED UP PRINT SHALL BE SENT TO THE PROJECT ENGINEER

- ALL DIMENSIONS ARE IN MILLIMETRES AND ELEVATIONS IN METRES.
- CONCRETE TO BS 8110, GRADE 35 FOR REINFORCED CONCRETE, GRADE 10 FOR BLINDING CONCRETE USING OPC.
- 50mm COVER TO REINFORCEMENT, REINFORCEMENT TO BS 4449.
- TANGS WELDED TO WEAR PLATE USING 6mm CFW. AND EXPOSED STEEL WORK TO BE PAINTED IN ACC. WITH SP-1246-2
- ALL EXPOSED CONCRETE SURFACES SHALL BE TREATED WITH TWO COATS OF "FOSROC DEKGUARD S" WITH A DFT OF 350 MICRONS OR ANY OTHER APPROVED EQUIVALENT.
- FOR BAR BENDING SCHEDULE REFER DRG. No. NIM-2-1842-021-DQ-4



NOTES/REFERENCE DRAWINGS

AREA	: NIMR	SCALE : 1:20	CAD DRAWING
SUB AREA	: NIMR SLUDGE PIT SYSTEM UPGRADE	No. 16	
DRWG. TYPE	: PIPE SUPPORTS-SLEEPER DETAILS		
DESCRIPTION	: SL-001		

DRWG	AREA CODE	ENG SECT	SERIAL NUMBER	SHEET	PROJ CODE	DWG SIZE	REV.

BAR BENDING SCHEDULE

JOB NO.: PAIP00405
PART ID.: PRODUCTION STATION
SL-001

Document No.: NIM-2-1842-021-DQ-4
Revision No.: A
Prepared by: GCS
Checked by: PNG 
Date: 27.02.11 

REF. DWG NO.: NIM-2-1842-020-DQ-3

Total MTO for Rebars.

Dia. Of Bar	T6	T8	T10	T12	T16	T20	T25	T32
Length of Bar (m)			8297.25					
Weight (Kgs)			5144.30					

Total Weight (Kgs)

5144.300

k. Nummer
-A2

[illegible]

This schedule complies with BS 8666 : 2005

All dimensions are in mm

Refer to Bar shape Code drawing

* Specified in multiples of 5 mm

† Specified in multiples of 25 mm

BAR BENDING SCHEDULE

JOB NO.: PAIP00405
PART ID.: PRODUCTION STATION
SL-002

Document No.: NIM-2-1842-023-DQ-4

Revision No.: A

Prepared by: GCS

Checked by: PNG

Date: 27.02.11

REF. DWG NO.: NIM-2-1842-022-DQ-3

Total MTO for Rebars.

Dia. Of Bar	T6	T8	T10	T12	T16	T20	T25	T32
Length of Bar (m)			3252.15					
Weight (Kgs)			2016.34					

Q. No.	Q. No.	Q. No.	Q. No.	Q. No.
Total Weight (Kgs)				

2016.340

1c. Nunnery
-A2

[illegible]


This schedule complies with BS 8666 : 2005

All dimensions are in mm

Refer to Bar shape Code drawing

* Specified in multiples of 5 mm


† Specified in multiples of 25 mm

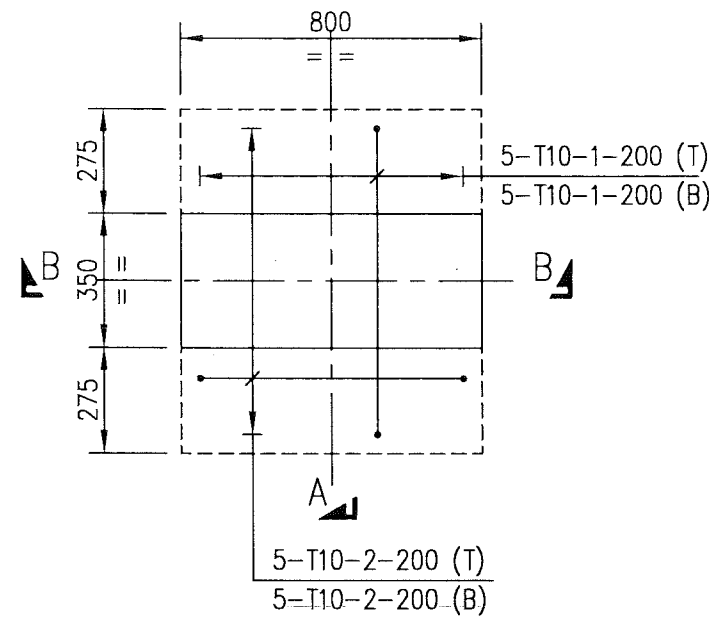


SLG-001

(90 Nos. REQD)


(FOR LOCATION REFER PIPING G.A. DRG NO. NIM-3-2126-001 TO 013-DQ-1)

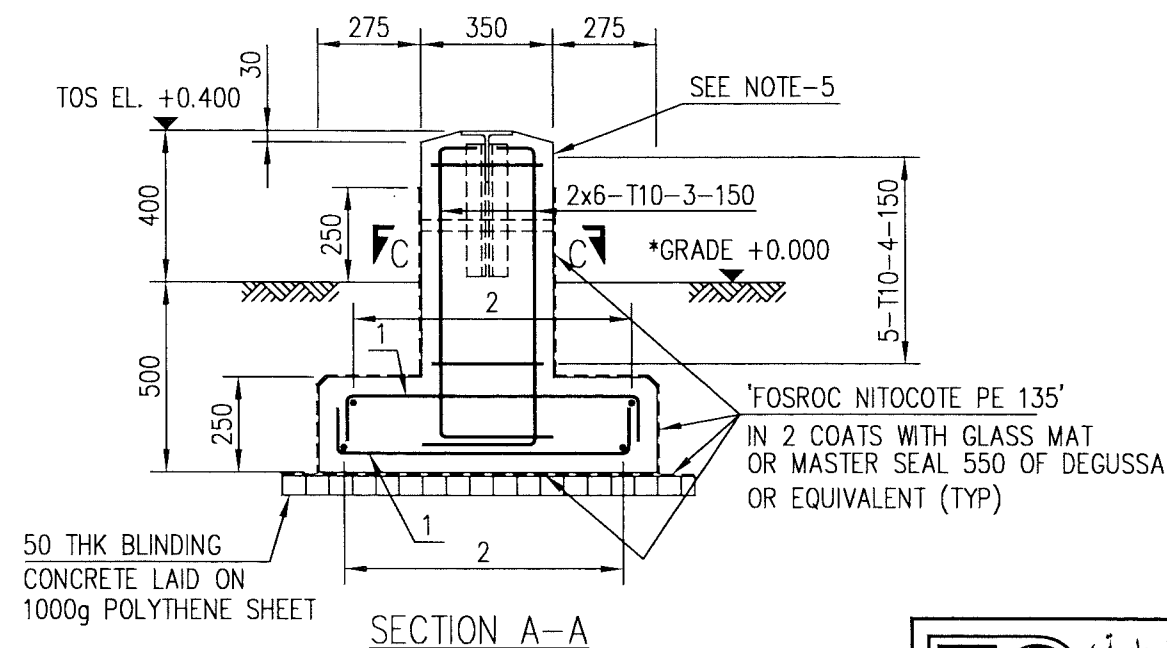


SECTION A-A

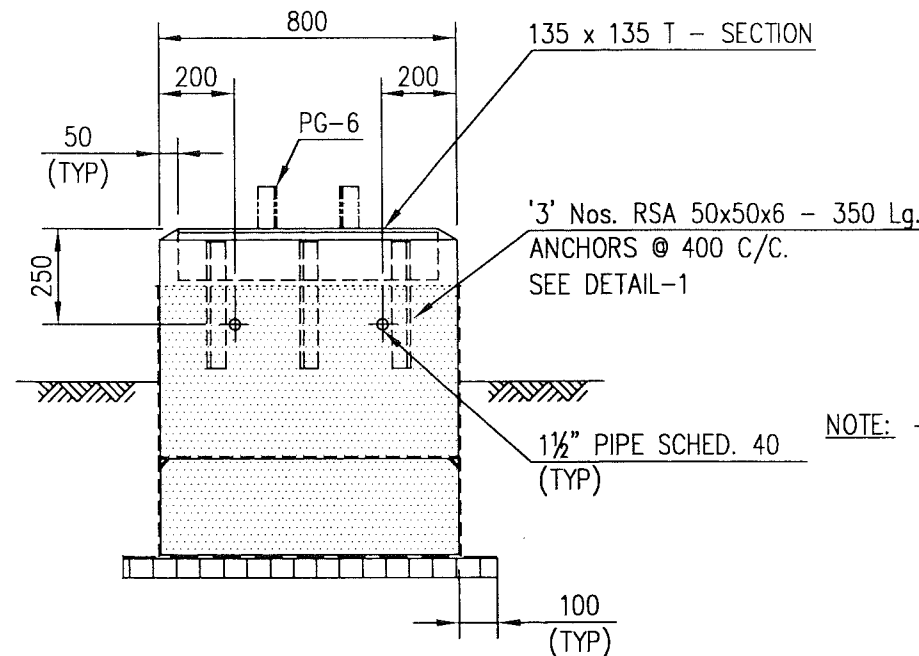

SECTION B-B

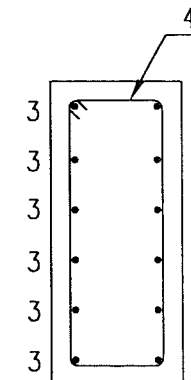

SECTION C-C

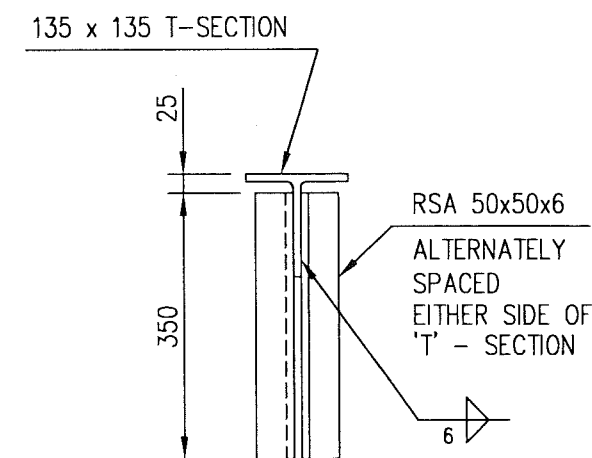

'T' - FIXING DETAIL
DETAIL-1

M T O			
DESCRIPTION	QUANTITY	UNITS	SAP No.
BLINDING CONCRETE	5.00	m ³	N.A.
CONCRETE GRADE 35	32.60	m ³	N.A.
REINFORCEMENT STEEL	2526.35	Kg	N.A.
'T' 135 x 135	63.00	m	N.A.
RSA 50x50x6	94.50	m	1000062629
1-1/2" PIPE SCHED. 40	63.00	m	1000069240
PROTECTIVE COATING	318.60	m ²	N.A.
1000g POLYTHENE SHEET	99.00	m ²	N.A.

NOTE: * DENOTES, SINCE GRADE ELEVATION VARIES, CONTRACTOR TO VERIFY ELEVATIONS AND DIMENSIONS AT SITE, PRIOR TO FABRICATION/CONSTRUCTION/INSTALLATION.

APPROVED FOR
CONSTRUCTION

ورلي بارسونز - الصناعات العربية (محصاة)
WorleyParsons - Arabian Industries (JV)
 CONTRACT NO. : C31/0606 PROJ. NO. : PAIP00405

REV	DATE	DRAWN BY	TEAM	J.ENG.	CHECKED	DESCRIPTION	WBS No.	PROJ. ENG.	SIGNATURE
A	27.02.11	GCS	RB	Y		APPROVED FOR CONSTRUCTION	IN.09.011	OSE/28N	
O	26.02.11	JRP	KBR	GSB		ISSUED FOR COMMENTS	IN.09.011	OSE/28N	

PROJECT DRAWING REVISION
IN CASE OF DEVIATIONS A MARKED UP PRINT SHALL BE SENT TO THE PROJECT ENGINEER

- ALL DIMENSIONS ARE IN MILLIMETRES AND ELEVATIONS IN METRES.
- CONCRETE TO BS 8110, GRADE 35 FOR REINFORCED CONCRETE, GRADE 10 FOR BLINDING CONCRETE USING OPC.
- 50mm COVER TO REINFORCEMENT, REINFORCEMENT TO BS 4449.
- TANGS WELDED TO WEAR PLATE USING 6mm CFW. AND EXPOSED STEEL WORK TO BE PAINTED IN ACC. WITH SP-1246-2
- ALL EXPOSED CONCRETE SURFACES SHALL BE TREATED WITH TWO COATS OF "FOSROC DEKGUARD S" WITH A DFT OF 350 MICRONS OR ANY OTHER APPROVED EQUIVALENT.
- FOR BAR BENDING SCHEDULE REFER DRG. No. NIM-2-1842-025-DQ-4
- PIPE GUIDE DETAILS REFER DRG NO. NIM-2-1842-018-DQ-3

NOTES/REFERENCE DRAWINGS

AREA	: NIMR	SCALE	: 1:20	CAD DRAWING
SUB AREA	: NIMR SLUDGE PIT SYSTEM UPGRADE	No.	16	
DRWG. TYPE	: PIPE SUPPORTS-SLEEPER DETAILS			
DESCRIPTION	: SLG-001			

شركة تنمية نفط عمان Petroleum Development Oman						
DRWG	AREA CODE	ENG SECT	SERIAL NUMBER	SHEET	PROJ CODE	DWG SIZE
NO	NIM	2	1842	024	DQ	3

BAR BENDING SCHEDULE

JOB NO.: PAIP00405
PART ID.: PRODUCTION STATION
SLG-001

Document No.: NIM-2-1842-025-DQ-4

Revision No.: A

Prepared by: GCS

Checked by: PNG

Date: 27.02.11

REF. DWG NO.: NIM-2-1842-024-DQ-3

Total MTO for Rebars.

Dia. Of Bar	T6	T8	T10	T12	T16	T20	T25	T32
Length of Bar (m)			4074.75					
Weight (Kgs)			2526.35					

Total Weight (Kgs)

2526.350

1c. Miners
7A2

[illegible]


This schedule complies with BS 8666 : 2005

All dimensions are in mm

Refer to Bar shape Code drawing

* Specified in multiples of 5 mm

† Specified in multiples of 25 mm

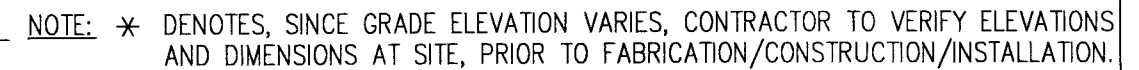

BAR BENDING SCHEDULE

JOB NO.: PAIP00405
PART ID.: PRODUCTION STATION
SLG-002

Document No.: NIM-2-1842-027-DQ-4

Revision No.: A

Prepared by: GCS

Checked by: PNG

Date: 27.02.11

REF. DWG NO.: NIM-2-1842-026-DO-3

Total MTO for Rebars.

Dia. Of Bar	T6	T8	T10	T12	T16	T20	T25	T32
Length of Bar (m)			1411.90					
Weight (Kgs)			875.38					

Total Weight (Kgs)

875.380

K. NARAYAN
-A2

[illegible]

This schedule complies with BS 8666 : 2005

All dimensions are in mm

Refer to Bar shape Code drawing

* Specified in multiples of 5 mm


† Specified in multiples of 25 mm

PIPE SUPPORT/ SLEEPER NUMBER	REFERENCE DRAWINGS			REMARKS
	STEELWORK DETAILS	SLEEPER/FOUNDATION DETAILS	LOCATION PLAN	
PS-001	NIM-2-1842-029-DQ-3	NIM-2-1842-062-DQ-3	NIM-2-0992-001-DQ-1	LAUNCHER AREA
PS-002	NIM-2-1842-029-DQ-3	NIM-2-1842-062-DQ-3		
PS-003	NIM-2-1842-033-DQ-3	-		
PS-004	NIM-2-1842-034-DQ-3	NIM-2-1842-035-DQ-3		
PS-005	NIM-2-1842-037-DQ-3			
PS-006	NIM-2-1842-038-DQ-3			
PS-007	NIM-2-1842-038-DQ-3			
PS-008	NIM-2-1842-039-DQ-3	NIM-2-1842-040-DQ-3		
PS-009	NIM-2-1842-038-DQ-3	NIM-2-1842-035-DQ-3		
PS-010				
PS-011				
PS-012				
PS-013	NIM-2-1842-039-DQ-3	NIM-2-1842-040-DQ-3		
PS-014	NIM-2-1842-038-DQ-3	NIM-2-1842-035-DQ-3		
PS-015	NIM-2-1842-038-DQ-3	NIM-2-1842-035-DQ-3		
PS-016	NIM-2-1842-042-DQ-3	-	NIM-3-2141-001-DQ-1	
PS-017	NIM-2-1842-042-DQ-3	-	NIM-3-2141-001-DQ-1	
PS-018	NIM-2-1842-038-DQ-3	NIM-2-1842-035-DQ-3	NIM-2-0992-001-DQ-1	
PS-019				
PS-020				
PS-021				
PS-022				
PS-023				
PS-024	NIM-2-1842-043-DQ-3	NIM-2-1842-030-DQ-3		
PS-025	NIM-2-1842-043-DQ-3			
PS-026	NIM-2-1842-032-DQ-3			
PS-027	NIM-2-1842-032-DQ-3			
PS-028	NIM-2-1842-044-DQ-3	NIM-2-1842-045-DQ-3		
PS-029	NIM-2-1842-047-DQ-3	-	NIM-3-2140-001-DQ-1	
PS-030	NIM-2-1842-048-DQ-3	NIM-2-1842-049-DQ-3	NIM-2-0992-001-DQ-1	
PS-031	NIM-2-1842-051-DQ-3	NIM-2-1842-049-DQ-3	NIM-2-0992-001-DQ-1	

PIPE SUPPORT/ SLEEPER NUMBER	REFERENCE DRAWINGS			REMARKS
	STEELWORK DETAILS	SLEEPER/FOUNDATION DETAILS	LOCATION PLAN	
PS-032	NIM-2-1842-051-DQ-3	NIM-2-1842-049-DQ-3	NIM-2-0992-001-DQ-1	
PS-033	NIM-2-1842-052-DQ-3	NIM-2-1842-049-DQ-3		
PS-034	NIM-2-1842-053-DQ-3	-		
PS-035	NIM-2-1842-053-DQ-3	-		
PS-036	NIM-2-1842-054-DQ-3	NIM-2-1842-049-DQ-3		
PS-037	NIM-2-1842-054-DQ-3	NIM-2-1842-049-DQ-3		
PS-038	NIM-2-1842-055-DQ-3	NIM-2-1842-056-DQ-3		
PS-039	NIM-2-1842-058-DQ-3	-		
PS-040	NIM-2-1842-058-DQ-3	-		
PS-041	NIM-2-1842-059-DQ-3	NIM-2-1842-030-DQ-3		
PS-042	NIM-2-1842-060-DQ-3			
PS-043	NIM-2-1842-061-DQ-3			
PS-044	NIM-2-1842-032-DQ-3			
PS-045	NIM-2-1842-047-DQ-3	-	NIM-3-2142-001-DQ-1	
PS-046	NIM-2-1842-055-DQ-3	NIM-2-1842-056-DQ-3	NIM-2-0992-001-DQ-1	
U BOLT DET.	NIM-2-1842-064-DQ-3			
PIPE CLAMP/SHOE & LINE STOP DETAILS	NIM-2-1842-065-DQ-3			
PIPE GUIDE DET.	NIM-2-1842-066-DQ-3			
LINE STOP DET.	NIM-2-1842-067-DQ-3			
PIPE SHOE DET.	NIM-2-1842-068-DQ-3			
SHOE GUIDE DET.	NIM-2-1842-069-DQ-3			
PIPE CLAMP DET.	NIM-2-1842-070-DQ-3			

APPROVED FOR
CONSTRUCTION




REV	DATE	DRAWN BY	TEAML.	J.ENG.	CHECKED	DESCRIPTION	WBS No.	PROJ. ENG.	SIGNATURE
A	27.02.11	GCS	RB	J		APPROVED FOR CONSTRUCTION	IN.09.011	OSE/28N	
O	26.02.11	JRP	KBR	GSB		ISSUED FOR COMMENTS	IN.09.011	OSE/28N	

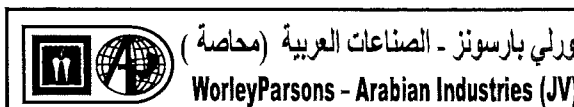

CONTRACT NO.: C31/0606 PROJ. NO.: PAIP00405

1. CONTRACTOR SHALL REFER PIPING PLAN ,PRIOR TO FABRICATION, INSTALLATION OF PIPE SUPPORTS									
NOTES		REFERENCE DRAWINGS							

PROJECT DRAWING REVISION									
IN CASE OF DEVIATIONS A MARKED UP PRINT SHALL BE SENT TO THE PROJECT ENGINEER									
AREA : NIMR		SUB AREA : NIMR SLUDGE PIT SYSTEMS		DRWG. TYPE : PIPE SUPPORTS (LAUNCHER)		DESCRIPTION : INDEX SHEETS		NO. 16	
SCALE : NTS		CAD DRAWING		DRWG		AREA CODE		ENG SECT	
NO		NIM 2 1842 028 DQ		3		A			

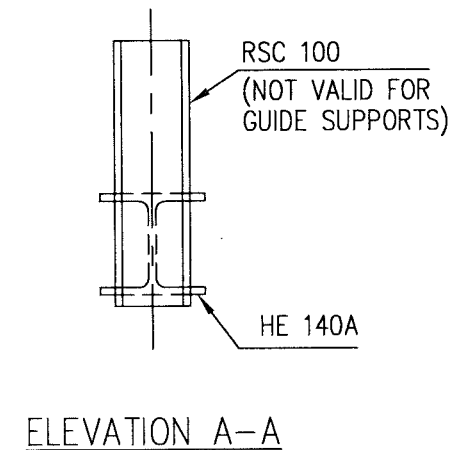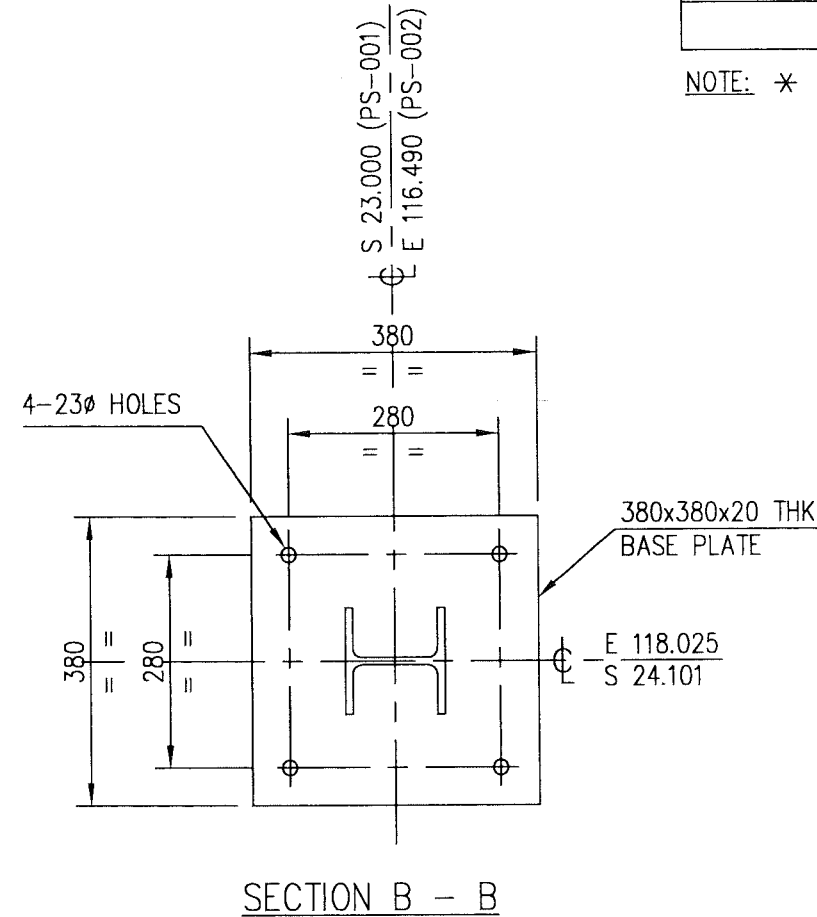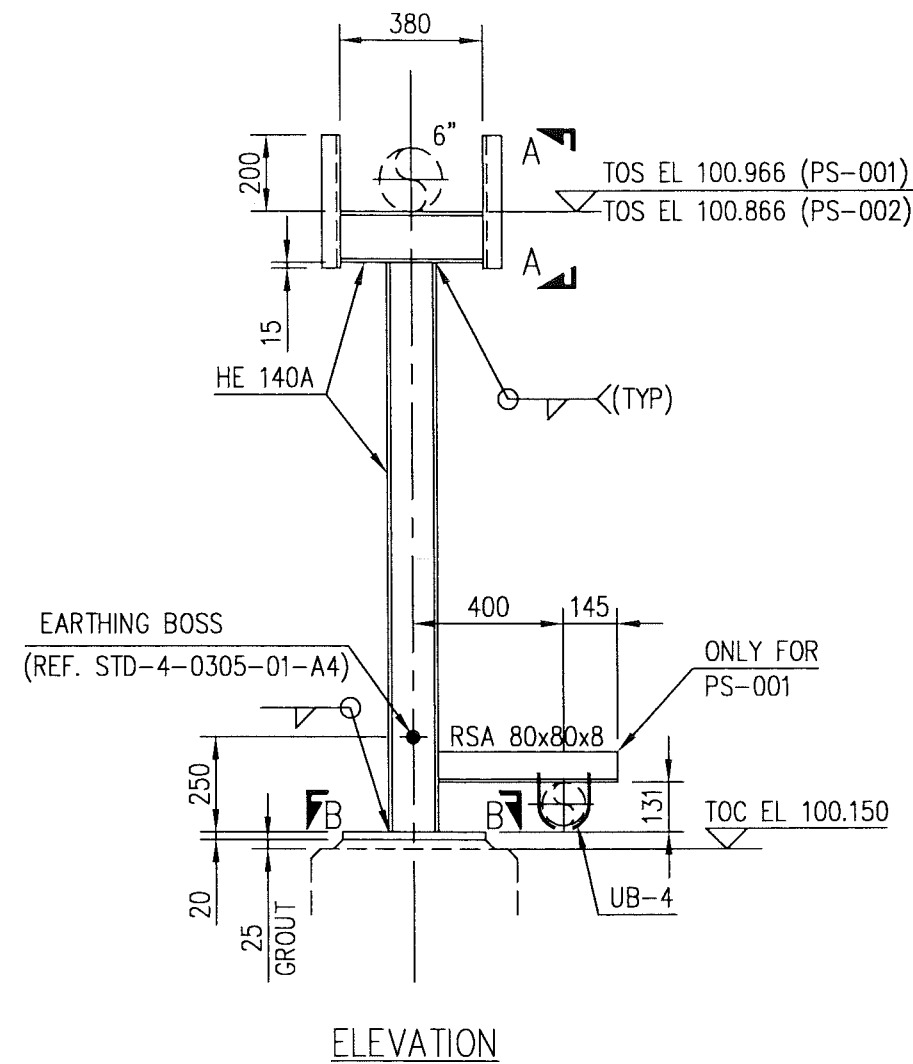

NOTE: * DENOTES, SINCE GRADE ELEVATION VARIES, CONTRACTOR TO VERIFY ELEVATIONS AND DIMENSIONS AT SITE, PRIOR TO FABRICATION/CONSTRUCTION/INSTALLATION.

APPROVED FOR
CONSTRUCTION



CONTRACT NO.: C31/0606 PROJ. NO.: PAIP00405

REV	DATE	DRAWN BY	TEAM	J.ENG.	CHECKED	DESCRIPTION	WBS No.	PROJ. ENG.	SIGNATURE
A	27.02.11	GCS	RB	J		APPROVED FOR CONSTRUCTION	IN.09.011	OSE/28N	
O	26.02.11	JRP	KBR	GSB		ISSUED FOR COMMENTS	IN.09.011	OSE/28N	

PROJECT DRAWING REVISION
IN CASE OF DEVIATIONS A MARKED UP PRINT SHALL BE SENT TO THE PROJECT ENGINEER

- ALL DIMENSIONS ARE IN MILLIMETRES.
- ALL ELEVATIONS & CO-ORDINATES ARE IN METRES.
- ALL STEEL WORK TO BS EN 10025 GRADE S275 JR
- PIPE SECTION TO API 5L GR B.
- ALL CONNECTIONS TO BE MADE USING 5mm CFW.
- ALL STEEL WORK TO RECEIVE CORROSION PROTECTION IN ACCORDANCE WITH DOCUMENT No. SP-1246-2

DESCRIPTION	AREA	S	SERIAL	SH.	P	S
FOUNDATION DETAILS	NIM	2	1842	062	DQ	3
'U' BOLT (PIPE NOT GRIPPED)	NIM	2	1842	064	DQ	3
LINE STOPER	NIM	2	1842	065	DQ	3

NOTES


REFERENCE DRAWINGS

AREA	: NIMR
SUB AREA	: NIMR SLUDGE PIT SYSTEMS No. 16
DRWG. TYPE	: PIPE SUPPORTS
DESCRIPTION	: PS-001 & 002


SCALE : 1:20 CAD DRAWING

شركة تنمية نفط عمان
Petrochem Development Oman


DRWG	AREA CODE	ENG SECT	SERIAL NUMBER	SHEET	PROJ CODE	DWG SIZE	REV.
NO	NIM	2	1842	029	DQ	3	A

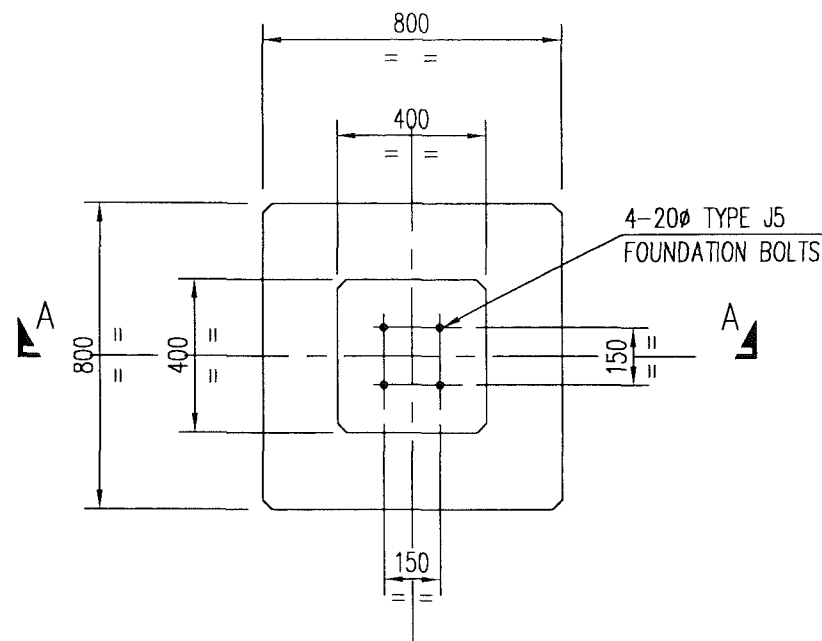


PLAN
(8 Nos. REQD)

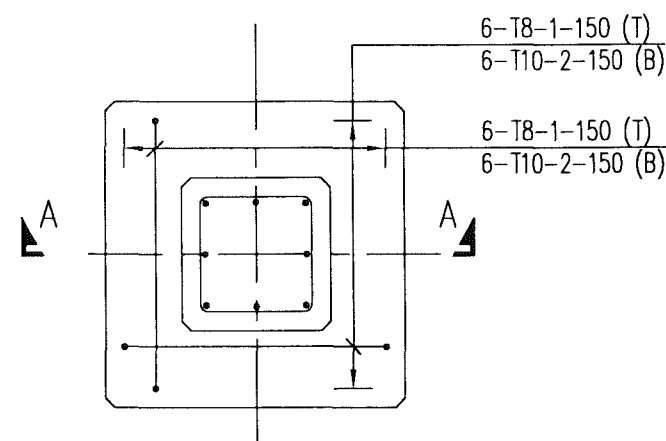

REINFORCEMENT PLAN

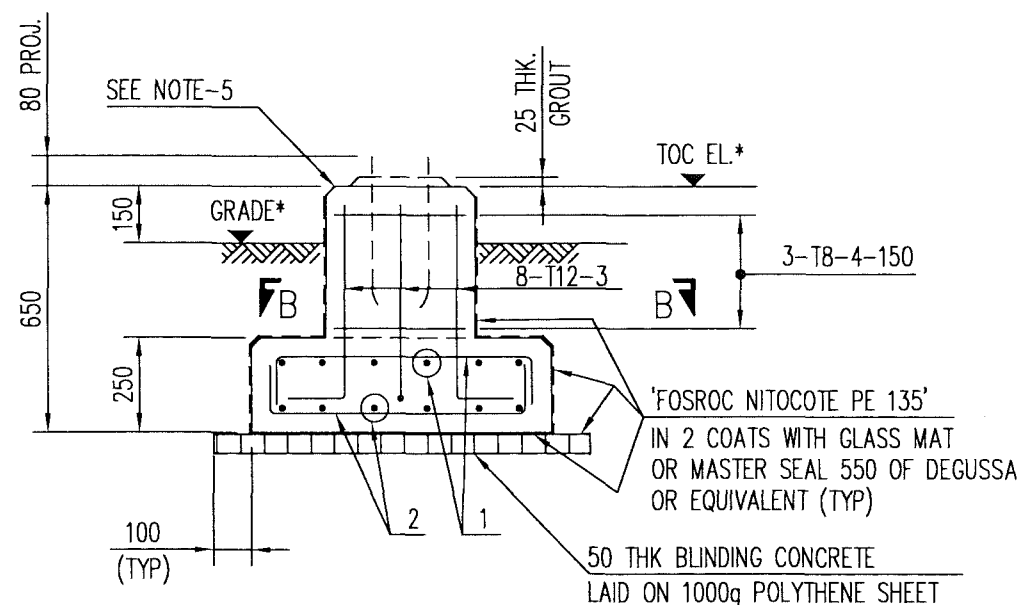

SECTION A - A

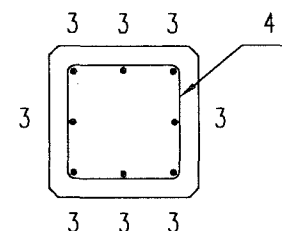

SECTION B - B

FOUNDATION DESIGNATION	REFERENCE DRAWING	NUMBERS REQUIRED	* TOC EL.
PS-024	NIM-2-0992-001-DQ-1	1	100.150
PS-025			
PS-026			
PS-027			
PS-041			
PS-042			
PS-043			
PS-044			

NOTE: * DENOTES, SINCE GRADE ELEVATION VARIES, CONTRACTOR TO VERIFY ELEVATIONS AND DIMENSIONS AT SITE, PRIOR TO FABRICATION/CONSTRUCTION/INSTALLATION.

M T O			
DESCRIPTION	QUANTITY	UNITS	SAP No.
BLINDING CONCRETE GRADE 10	0.40	m ³	N.A.
CONCRETE GRADE 35	1.80	m ³	N.A.
CEMENT SAND GROUT	21.30	lit	N.A.
REINFORCEMENT STEEL	145.10	Kg	N.A.
PROTECTIVE COATING	23.40	m ²	N.A.
20mm FOUNDATION BOLT TYPE - J5	32	PCS	N.A.
1000g POLYTHENE SHEET	8.00	m ²	N.A.

K. Al-Nasser
T.A.2

APPROVED FOR
CONSTRUCTION

[THIS DRAWING IS BASED ON P.D.O. DRG. No. STD-2-3901-001-A3-D - TYPE 901]

- ALL DIMENSIONS ARE IN MILLIMETRES AND ELEVATIONS IN METRES.
- CONCRETE TO BS 8110, GRADE 35 FOR REINFORCED CONCRETE, GRADE 10 FOR BLINDING CONCRETE USING OPC.
- 50mm COVER TO REINFORCEMENT, REINFORCEMENT TO BS 4449.
- ALL EDGES SHALL HAVE A CHAMFER OF APPROX. 25mm.
- ALL EXPOSED CONCRETE SURFACES SHALL BE TREATED WITH TWO COATS OF "FOSROC DEKGUARD S" WITH A DFT OF 350 MICRONS OR ANY OTHER APPROVED EQUIVALENT.
- FOUNDATION BOLTS REFER DRG. No. STD-2-3950-001-A3
- FOR BAR BENDING SCHEDULE REFER DRG. No. NIM-2-1842-031-DQ-4

NOTES/REFERENCE DRAWINGS




CONTRACT NO.: C31/0606 PROJ. NO.: PAIP00405

REV	DATE	DRAWN BY	TEAM L.	J. ENG.	CHECKED	DESCRIPTION	WBS No.	PROJ. ENG.	SIGNATURE
A	27.02.11	GCS	RB	✓		APPROVED FOR CONSTRUCTION	IN.09.011	OSE/28N	
O	26.02.11	JRP	KBR	GSB		ISSUED FOR COMMENTS	IN.09.011	OSE/28N	


PROJECT DRAWING REVISION
IN CASE OF DEVIATIONS A MARKED UP PRINT SHALL BE SENT TO THE PROJECT ENGINEER

AREA	NIMR		SCALE: 1:20	CAD DRAWING		
SUB AREA	NIMR SLUDGE PIT SYSTEMS		NO. 16			
DRWG. TYPE	PIPE SUPPORTS-FOUNDATION DETAILS					
DESCRIPTION	PS-024 TO 027, 041 TO 044					
DRWG	AREA CODE	ENG SECT	SERIAL NUMBER	SHEET	PROJ CODE	DWG SIZE
NO	NIM	2	1842	030	DQ	3 A

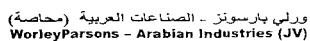

BAR BENDING SCHEDULE

JOB NO.: PAIP00405
PART ID.: NIMR SLUDGE PIT SYSTEM UPGRADE
 PS-024 TO 027 & 041 TO 044

Document No.: NIM-2-1842-031-DQ-4
Revision No.: A
Prepared by: JRP
Checked by: PNG 
Date: 27.02.11

REF. DWG NO.: NIM-2-1842-030-DQ-3

Total MTO for Rebars.

Dia. Of Bar	T6	T8	T10	T12	T16	T20	T25	T32
Length of Bar (m)		121.80	88.80	46.40				
Weight (Kgs)		48.72	55.06	41.30				

Total Weight (Kgs)

145 080

1c. Minerals
-TA2

[illegible]


This schedule complies with BS 8666 : 2005

All dimensions are in mm


Refer to Bar shape Code drawing

* Specified in multiples of 5 mm

† Specified in multiples of 25 mm

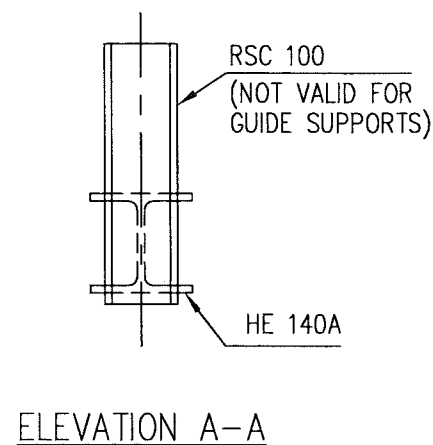

NOTE: ✕ DENOTES, SINCE GRADE ELEVATION VARIES, CONTRACTOR TO VERIFY ELEVATIONS AND DIMENSIONS AT SITE, PRIOR TO FABRICATION/CONSTRUCTION/INSTALLATION.

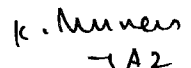


APPROVED FOR
CONSTRUCTION


A	27.02.11	GCS	<i>RB</i>	<i>Y</i>	APPROVED FOR CONSTRUCTION	IN.09.011	OSE/28N		
O	26.02.11	JRP	KBR	GSB	ISSUED FOR COMMENTS	IN.09.011	OSE/28N		
J -	REV	DATE	DRAWN BY	TEAML.	J.ENG.	DESCRIPTION	WBS No.	PROJ. ENG.	SIGNATURE
				CHECKED				P D O APPROVAL	

PROJECT DRAWING REVISION


IN CASE OF DEVIATIONS A MARKED UP PRINT SHALL BE SENT TO THE PROJECT ENGINEER

1. ALL DIMENSIONS ARE IN MILLIMETRES. 2. ALL ELEVATIONS & CO-ORDINATES ARE IN METRES. 3. ALL STEEL WORK TO BS EN 10025 GRADE S275 JR. 4. ALL CONNECTIONS TO BE MADE USING 6mm CFW. 5. ALL STEEL WORK TO RECEIVE CORROSION PROTECTION IN ACCORDANCE WITH DOCUMENT No. SP-1246-2	PIPE SUPPORT-INDEX SHEET	NIM	2	1842	028	DQ	3
	FOUNDATION DETAILS	NIM	2	1842	035	DQ	3
	'U' BOLT (PIPE NOT GRIPPED)	NIM	2	1842	064	DQ	3
	DESCRIPTION	AREA	S	SERIAL	SH.	P	S
	DRAWING NUMBER						
NOTES	REFERENCE DRAWINGS						


IN CASE OF DEVIATIONS A MARKED UP PRINT SHALL BE SENT TO THE PROJECT ENGINEER												
3	AREA : NIMR					SCALE : NTS		CAD DRAWING				
3						0 1 2 3 4 5 6 7						
3	SUB AREA : NIMR SLUDGE PIT SYSTEM UPGRADE					No. 16		<div><div>شركة تنمية نفط عُمان</div><div>Petroroleum Development Oman</div></div>				
S	DRWG.TYPE : PIPE SUPPORTS					<div><div>DRWG</div><div>AREA CODE</div><div>ENG SECT</div><div>SERIAL NUMBER</div><div>SHEET</div><div>PROJ CODE</div><div>DWG SIZE</div><div>REV.</div></div>						
	DESCRIPTION : PS-004					<div><div>NO</div><div>NIM</div><div>2</div><div>1842034</div><div>DQ</div><div>3</div><div>A</div></div>						

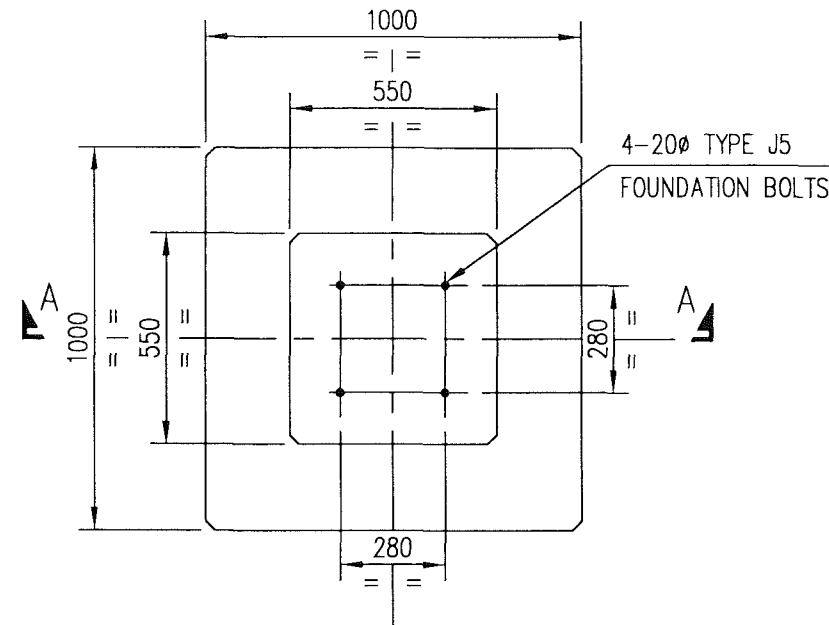


PLAN
(16 Nos. REQD.)

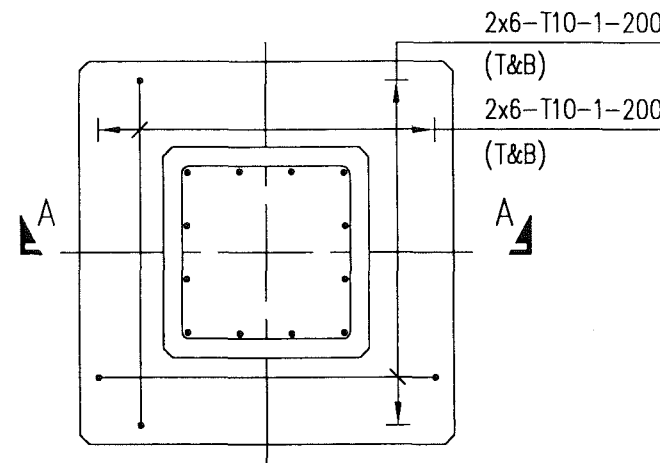

REINFORCEMENT PLAN

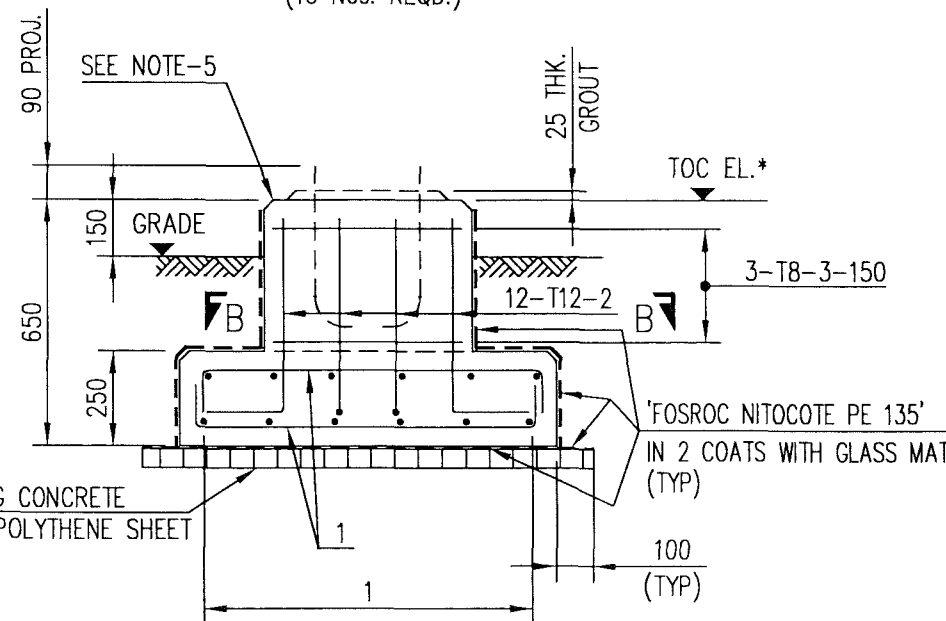

SECTION A - A

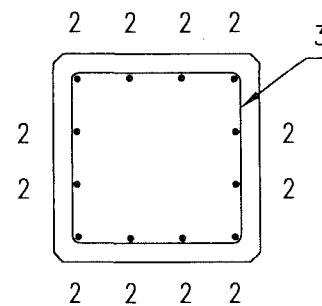

SECTION B - B

FOUNDATION DESIGNATION	REFERENCE DRAWING	NUMBERS REQUIRED	*TOC EL.
PS-004	NIM-2-0992-001-DQ-1	1	100.150
PS-005			
PS-006			
PS-007			
PS-009			
PS-010			
PS-011			
PS-012			
PS-014			
PS-015			
PS-018			
PS-019			
PS-020			
PS-021			
PS-022			
PS-023			

NOTE: * DENOTES, SINCE GRADE ELEVATION VARIES, CONTRACTOR TO VERIFY ELEVATIONS AND DIMENSIONS AT SITE, PRIOR TO FABRICATION/CONSTRUCTION/INSTALLATION.

M T O			
DESCRIPTION	QUANTITY	UNITS	SAP No.
BLINDING CONCRETE GRADE 10	1.15	m ³	N.A.
CONCRETE GRADE 35	5.94	m ³	N.A.
CEMENT SAND GROUT	84.18	lit	N.A.
REINFORCEMENT STEEL	429.65	Kg	N.A.
PROTECTIVE COATING	64.30	m ²	N.A.
200 FOUNDATION BOLT TYPE - J5	64	PCS	N.A.
1000g POLYTHENE SHEET	23.00	m ²	N.A.

APPROVED FOR
CONSTRUCTION

[THIS DRAWING IS BASED ON P.D.O. DRG. No. STD-2-3903-001-A3-E - TYPE 903]

- ALL DIMENSIONS ARE IN MILLIMETRES AND ELEVATIONS IN METRES.
- CONCRETE TO BS 8110, GRADE 35 FOR REINFORCED CONCRETE, GRADE 10 FOR BLINDING CONCRETE USING OPC.
- 50mm COVER TO REINFORCEMENT, REINFORCEMENT TO BS 4449.
- ALL EDGES SHALL HAVE A CHAMFER OF APPROX. 25mm.
- ALL EXPOSED CONCRETE SURFACES SHALL BE TREATED WITH TWO COATS OF "FOSROC DEKGUARD S" WITH A DFT OF 350 MICRONS OR ANY OTHER APPROVED EQUIVALENT.
- FOUNDATION BOLTS REFER DRG. No. STD-2-3950-001-A3
- FOR BAR BENDING SCHEDULE REFER DRG. No. NIM-2-1842-036-DQ-4

NOTES/REFERENCE DRAWINGS

WorleyParsons - Arabian Industries (JV)
 CONTRACT NO.: C31/0606 PROJ. NO.: PAIP00405

REV	DATE	DRAWN BY	TEAM L.	J. ENG.	CHECKED	DESCRIPTION	WBS No.	PROJ. ENG.	SIGNATURE
A	27.02.11	GCS	BB	GSB		APPROVED FOR CONSTRUCTION	IN.09.011	OSE/28N	
O	26.02.11	JRP	KBR	GSB		ISSUED FOR COMMENTS	IN.09.011	OSE/28N	

PROJECT DRAWING REVISION
IN CASE OF DEVIATIONS A MARKED UP PRINT SHALL BE SENT TO THE PROJECT ENGINEER

AREA	: NIMR		SCALE : 1:20	CAD DRAWING			
SUB AREA	: NIMR SLUDGE PIT SYSTEMS		NO. 16				
DRWG. TYPE	: PIPE SUPPORTS-FOUNDATION DETAILS			DRWG	AREA CODE	ENG SECT	SERIAL NUMBER
DESCRIPTION	: PS-004 TO 007, 009 TO 012, 014, 015 & 018 TO 023			SHEET	PROJ CODE	DWG SIZE	REV.
				NO	NIM 2 1842 035 DQ	3	A

BAR BENDING SCHEDULE

JOB NO.: PAIP00405
PART ID.: NIMR SLUDGE PIT SYSTEM UPGRADE
PS-004 TO 007,009 TO 012,014,
015 & 018 TO 023

REF. DWG NO.: NIM-2-1842-035-DQ-3

Document No.: NIM-2-1842-036-DQ-4

Revision No.: A

Prepared by: JRP

Checked by: PNG

Date: 27.02.11

Total MTO for Rebars.

Dia. Of Bar	T6	T8	T10	T12	T16	T20	T25	T32
Length of Bar (m)		94.80	432.00	139.20				
Weight (Kgs)		37.92	267.84	123.89				

Total Weight (Kgs)

429.650

10. Number
T A 2

[illegible]




This schedule complies with BS 8666 : 2005

All dimensions are in mm

Refer to Bar shape Code drawing

* Specified in multiples of 5 mm

† Specified in multiples of 25 mm

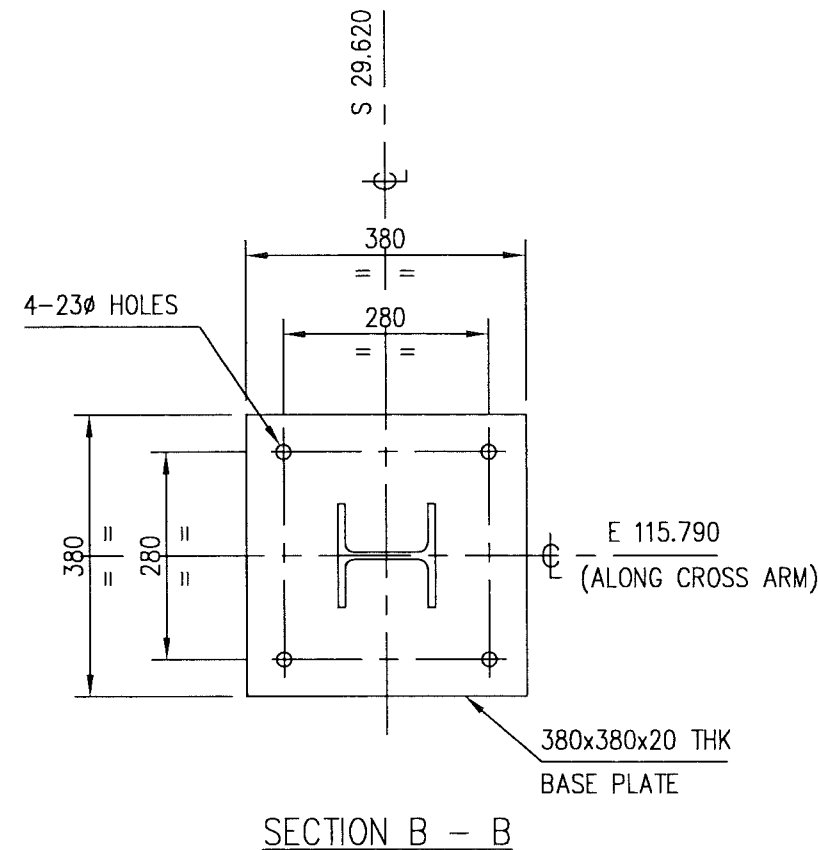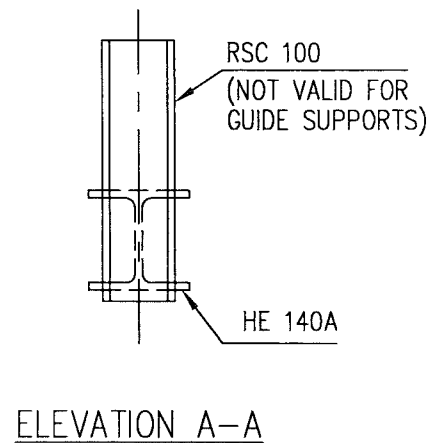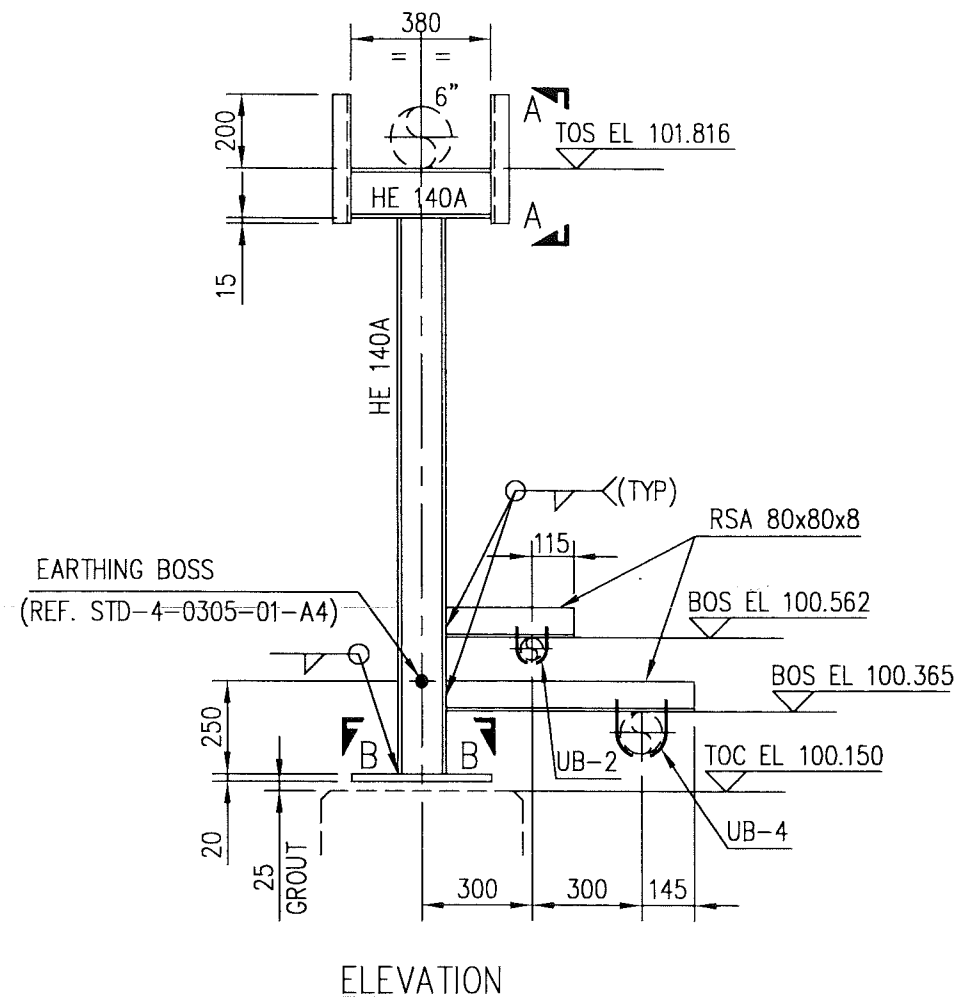

M T O			
DESCRIPTION	QUANTITY	UNITS	SAP No.
HE 140A	1.90	m	1000080438
RSC 100	0.70	m	1000145612
RSA 80x80x8	1.05	m	100062630
20 THK PLATE	0.15	m ²	1000062610
EARTHING BOSS	1	PCS	N.A.

NOTE: ✕ DENOTES, SINCE GRADE ELEVATION VARIES, CONTRACTOR TO VERIFY ELEVATIONS AND DIMENSIONS AT SITE, PRIOR TO FABRICATION/CONSTRUCTION/INSTALLATION.


APPROVED FOR
CONSTRUCTION




CONTRACT NO.: C31/0606 PROJ. NO.: PAIP00405

NOTES	1. ALL DIMENSIONS ARE IN MILLIMETRES.	PIPE SUPPORT-INDEX SHEET	NIM	2	1842	028	DQ	3
	2. ALL ELEVATIONS & CO-ORDINATES ARE IN METRES.	FOUNDATION DETAILS	NIM	2	1842	035	DQ	3
	3. ALL STEEL WORK TO BS EN 10025 GRADE S275 JR.	'U' BOLT (PIPE NOT GRIPPED)	NIM	2	1842	064	DQ	3
	4. ALL CONNECTIONS TO BE MADE USING 6mm CFW.							
	5. ALL STEEL WORK TO RECEIVE CORROSION PROTECTION IN ACCORDANCE WITH DOCUMENT No. SP-1246-2							
REFERENCE DRAWINGS			DESCRIPTION	AREA	S	SERIAL	SH.	P
			DRAWING NUMBER					

REV	DATE	DRAWN BY	CHECKED	DESCRIPTION	WBS No.	PROJ. ENG.	SIGNATURE
A	27.02.11	GCS	RB	APPROVED FOR CONSTRUCTION	IN.09.011	OSE/2BN	
O	26.02.11	JRP	KBR	ISSUED FOR COMMENTS	IN.09.011	OSE/2BN	
PROJECT DRAWING REVISION							
IN CASE OF DEVIATIONS A MARKED UP PRINT SHALL BE SENT TO THE PROJECT ENGINEER							
AREA : NIMR				SCALE : NTS CAD DRAWING			
SUB AREA : NIMR SLUDGE PIT SYSTEM UPGRADE				No. 16			
DRWG. TYPE : PIPE SUPPORTS				DESCRIPTION : PS-005			
				NO NIM 2 1842 037 DQ 3 A			

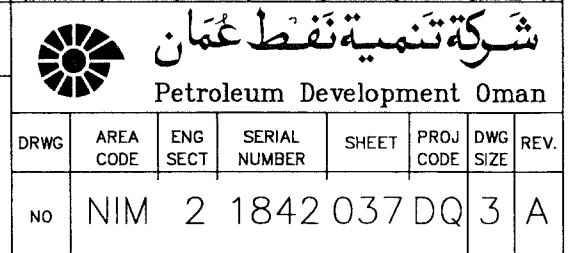

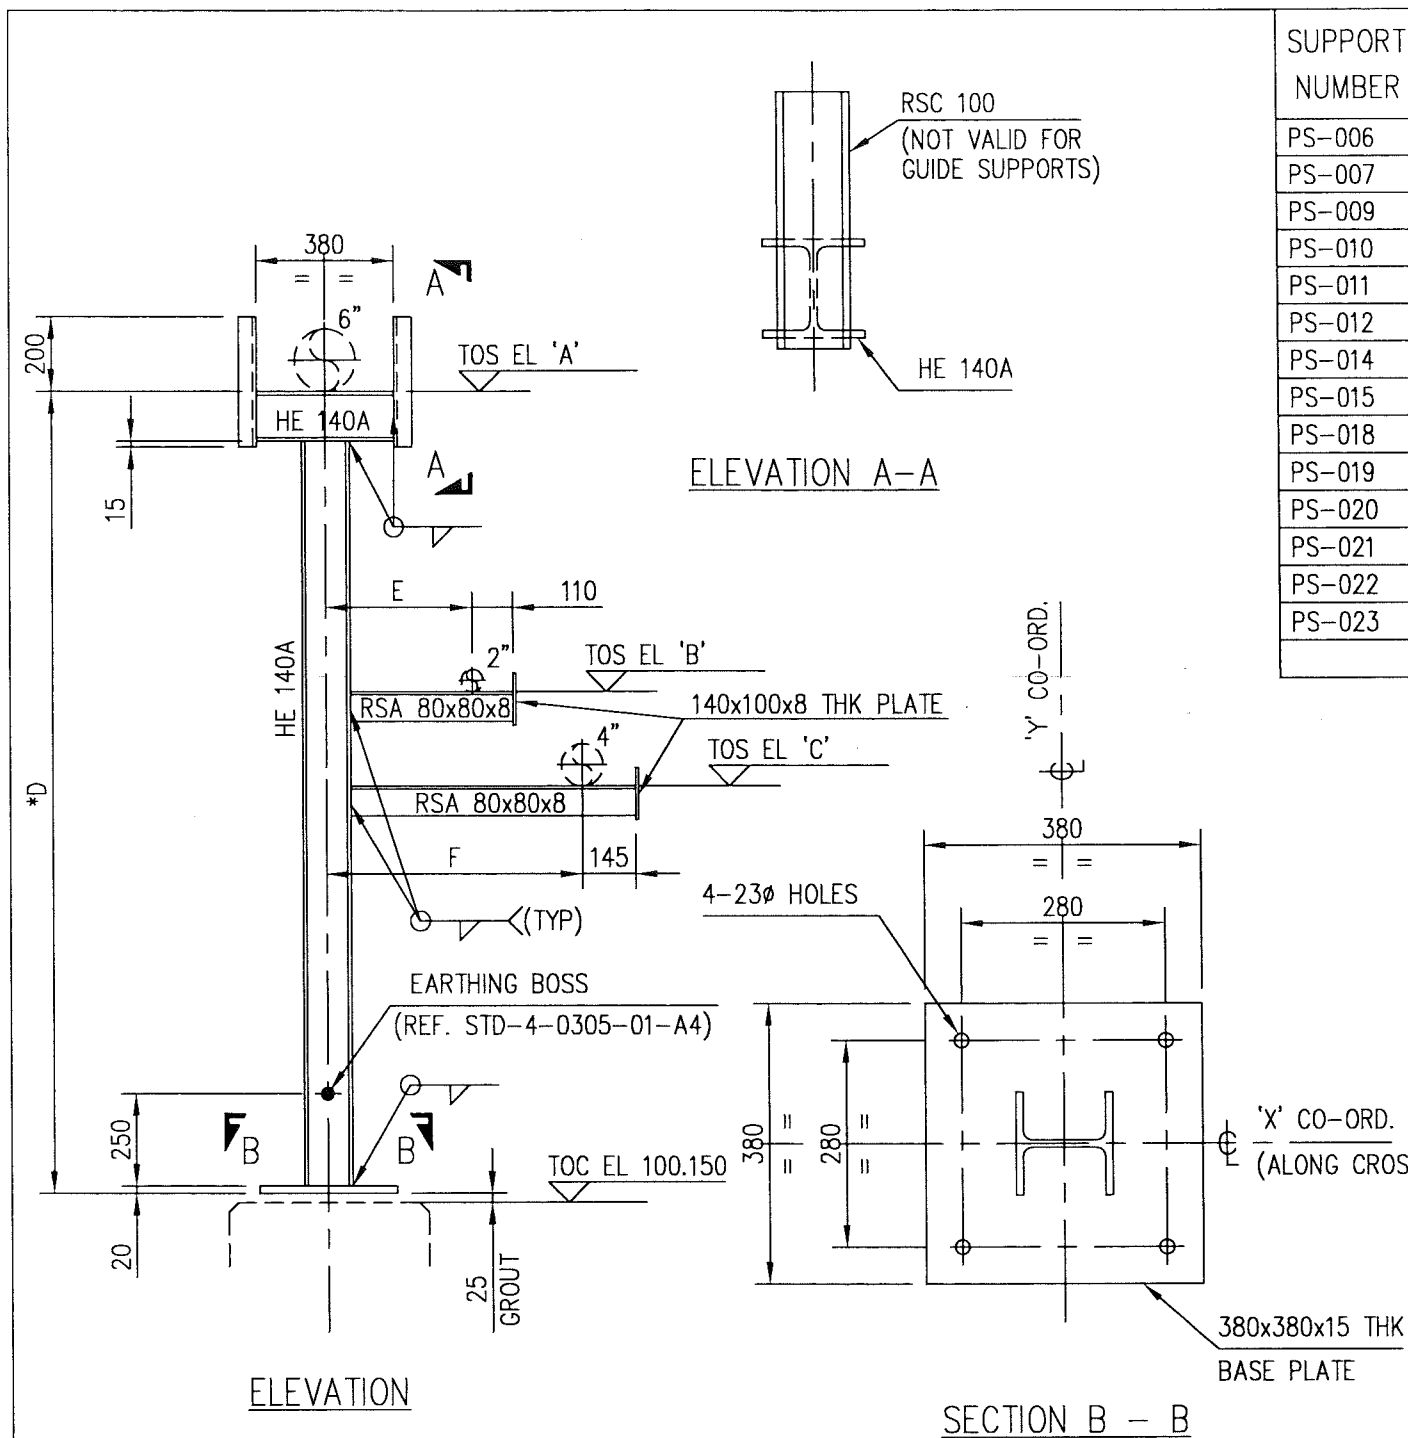

SUPPORT NUMBER	REFERENCE DRAWING	ELEVATIONS			DIMENSION			PIPE GUIDE	Nos. REQD.	CO-ORDINATES	
		A	* B	C	* D	E	F			X	Y
PS-006	NIM-2-0992-001-DQ-1	101.816	100.520	100.270	1641	300	600	PG-2	1	E 111.790	S 29.620
PS-007			100.540	100.290				-		E 107.790	
PS-009			100.580	100.330				-		E 99.790	
PS-010			100.598	100.348				PG-2		E 96.290	
PS-011			100.611	100.361				-		E 93.790	
PS-012			100.620	100.374				-		S 30.620	E 93.290
PS-014			100.651	100.405				-		S 36.620	E 93.290
PS-015			100.668	100.418		400	700	-		E 90.690	S 37.820
PS-018			100.688	100.438				PG-2,6		E 86.690	
PS-019			100.708	100.458				-		E 82.690	
PS-020			100.728	100.478				2,4 & 6		E 78.690	
PS-021			100.748	100.498				-		E 74.690	
PS-022			100.762	100.512				-		E 71.850	
PS-023			100.769	100.515				-		S 38.470	E 69.050

NOTE: * DENOTES, SINCE GRADE ELEVATION VARIES, CONTRACTOR TO VERIFY ELEVATIONS AND DIMENSIONS AT SITE, PRIOR TO FABRICATION/CONSTRUCTION/INSTALLATION.

M T O			
DESCRIPTION	QUANTITY	UNITS	SAP No.
HE 140A	26.15	m	1000080438
RSC 100	8.40	m	1000145612
RSA 80x80x8	16.00	m	100062630
8 THK PLATE	0.40	m ²	1000062607
20 THK PLATE	2.02	m ²	1000062610
EARTHING BOSS	14	PCS	N.A.

APPROVED FOR CONSTRUCTION


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A	27.02.11	GCS	RB	APPROVED FOR CONSTRUCTION	IN.09.011	OSE/28N	
O	26.02.11	JRP	KBR	ISSUED FOR COMMENTS	IN.09.011	OSE/28N	



CONTRACT NO.: C31/0606 PROJ. NO.: PAIP00405

1. ALL DIMENSIONS ARE IN MILLIMETRES.	PIPE SUPPORT-INDEX SHEET	NIM	2	1842	028	DQ	3
2. ALL ELEVATIONS & CO-ORDINATES ARE IN METRES.	FOUNDATION DETAILS	NIM	2	1842	035	DQ	3
3. ALL STEEL WORK TO BS EN 10025 GRADE S275 JR.	PIPE GUIDE DETAILS	NIM	2	1842	066	DQ	3
4. ALL CONNECTIONS TO BE MADE USING 6mm CFW.							
5. ALL STEEL WORK TO RECEIVE CORROSION PROTECTION IN ACCORDANCE WITH DOCUMENT No. SP-1246-2							
NOTES	DESCRIPTION	AREA	S	SERIAL	SH.	P	S
	DRAWING NUMBER						
	REFERENCE DRAWINGS						

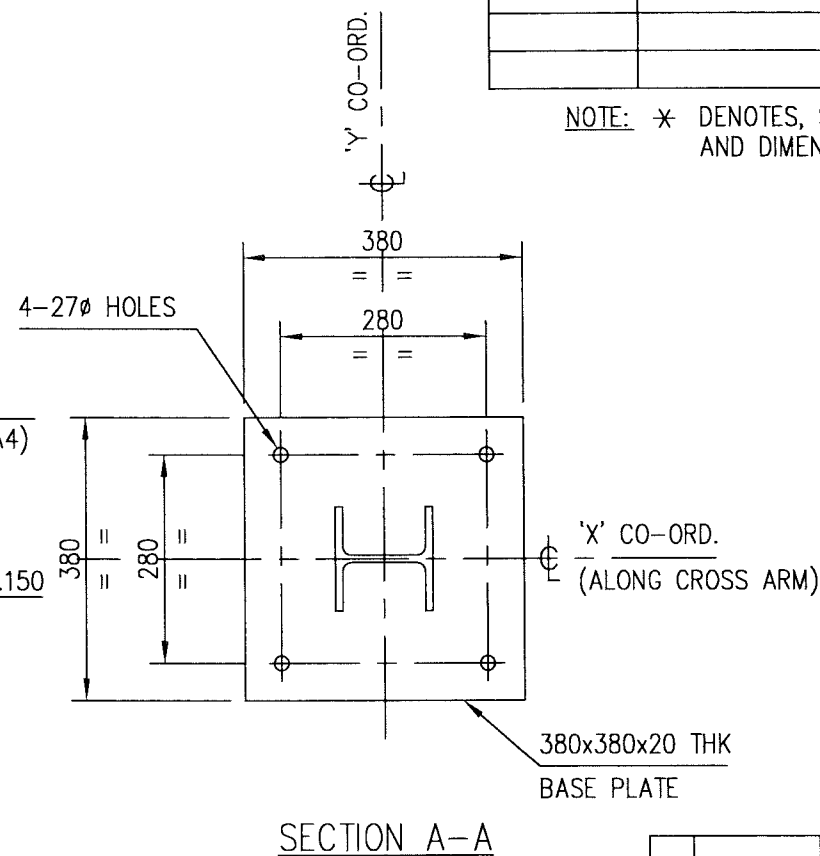

PROJECT DRAWING REVISION			
IN CASE OF DEVIATIONS A MARKED UP PRINT SHALL BE SENT TO THE PROJECT ENGINEER			
AREA	: NIMR		
SUB AREA	: NIMR SLUDGE PIT SYSTEM UPGRADE		
DRWG. TYPE	: PIPE SUPPORTS		
DESCRIPTION	: PS-006,007,009 TO 012,014,015, & 018 TO 023		
SCALE	: NTS		
CAD DRAWING	: NO. 16		
DRWG	AREA CODE	ENG SECT	SERIAL NUMBER
NO	NIM	2	1842 038 DQ
REV.	3	A	



NOTE: ✕ DENOTES, SINCE GRADE ELEVATION VARIES, CONTRACTOR TO VERIFY ELEVATIONS AND DIMENSIONS AT SITE, PRIOR TO FABRICATION/CONSTRUCTION/INSTALLATION.

APPROVED FOR
CONSTRUCTION

	A	27.02.11	GCS	PR	V:	APPROVED FOR CONSTRUCTION	IN.09.011	OSE/28N	
	O	26.02.11	JRP	KBR	GSB	ISSUED FOR COMMENTS	IN.09.011	OSE/28N	
	REV	DATE	DRAWN BY	TEAML.	J.ENG.	DESCRIPTION	WBS No.	PROJ. ENG.	SIGNATURE
				CHECKED				P D O APPROVAL	



 ورلي بارسونز - الصناعات العربية (مخاصة)
WorleyParsons - Arabian Industries (JV)

CONTRACT NO. : C31/0606	PROJ. NO. : PAIP00405
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PIPE SUPPORT-INDEX SHEET	NIM	2	1842	028	DQ	3
FOUNDATION DETAILS	NIM	2	1842	040	DQ	3
PIPE GUIDE DETAILS	NIM	2	1842	066	DQ	3
PIPE CLAMP/SHOE & LINE STOP DETS.	NIM	2	1842	070	DQ	3
DESCRIPTION	AREA	S	SERIAL	SH.	P	S
	DRAWING NUMBER					

REFERENCE DRAWINGS

PROJECT DRAWING REVISION	
IN CASE OF DEVIATIONS A MARKED UP PRINT SHALL BE SENT TO THE PROJECT ENGINEER	


AREA : NIMR

SUB AREA	: NIMR SLUDGE PIT SYSTEM UPGRADE	NO. 16
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DRWG. TYPE : PIPE SUPPORTS


DESCRIPTION : PS-008 & 013

SCALE : NTS CAD DRAWING


 **شركة تنمية نفط عُمان**
Petroleum Development Oman

DRWG	AREA CODE	ENG SECT	SERIAL NUMBER	SHEET	PROJ CODE	DWG SIZE	REV.
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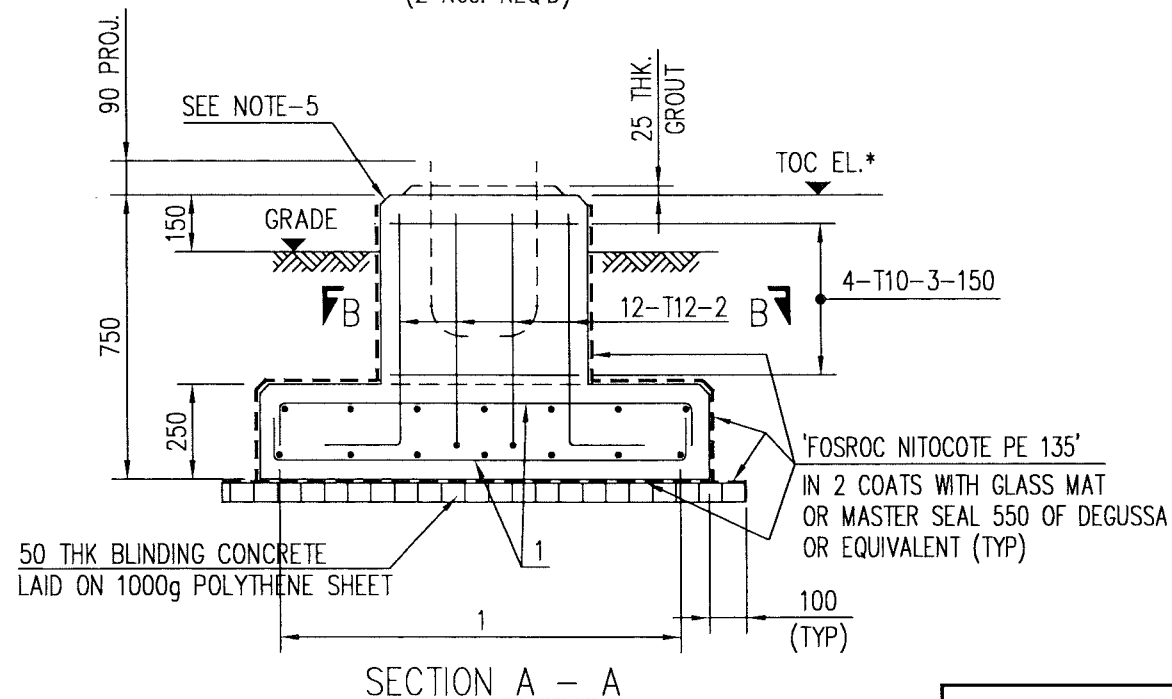
NO	NIM	2 1842 039 DQ 3 A
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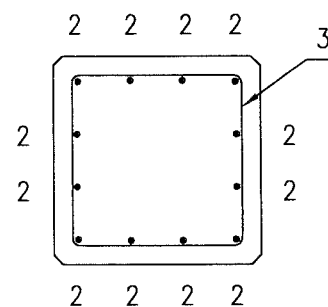
PLAN
(2 Nos. REQ'D)

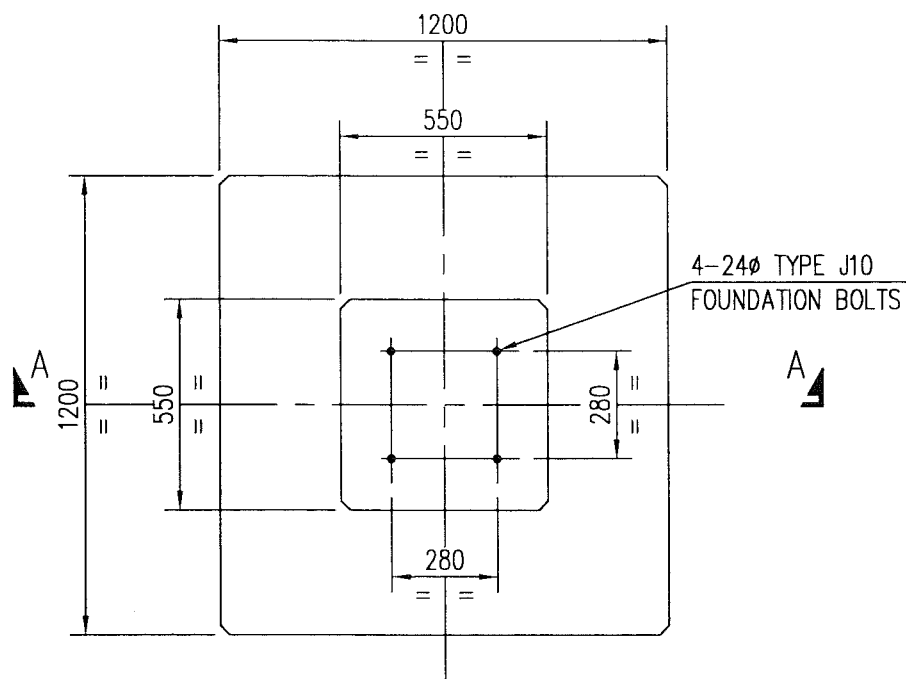

REINFORCEMENT PLAN

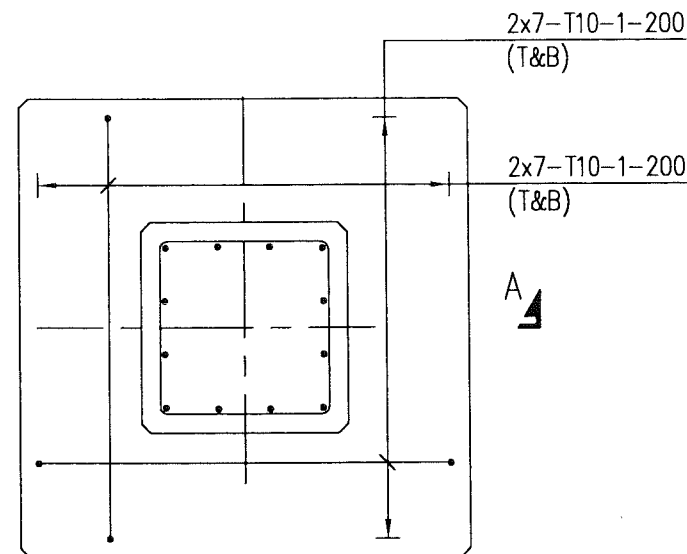

SECTION A - A



SECTION B - B

FOUNDATION DESIGNATION	REFERENCE DRAWING	NUMBERS REQUIRED	* TOC EL.
PS-008	NIM-2-0992-001-DQ-1	1	100.150
PS-013	NIM-2-0992-001-DQ-1	1	100.150

NOTE: * DENOTES, SINCE GRADE ELEVATION VARIES, CONTRACTOR TO VERIFY ELEVATIONS AND DIMENSIONS AT SITE, PRIOR TO FABRICATION/CONSTRUCTION/INSTALLATION.

M T O			
DESCRIPTION	QUANTITY	UNITS	SAP No.
BLINDING CONCRETE GRADE 10	0.20	m ³	N.A.
CONCRETE GRADE 35	1.02	m ³	N.A.
CEMENT SAND GROUT	11.80	lit	N.A.
REINFORCEMENT STEEL	73.43	Kg	N.A.
PROTECTIVE COATING	10.80	m ²	N.A.
24Ø FOUNDATION BOLT TYPE - J10	8	PCS	N.A.
1000g POLYTHENE SHEET	3.92	m ²	N.A.

APPROVED FOR
CONSTRUCTION

[THIS DRAWING IS BASED ON P.D.O. DRG. No. STD-2-3904-001-A3-D - TYPE 904]

- ALL DIMENSIONS ARE IN MILLIMETRES AND ELEVATIONS IN METRES.
- CONCRETE TO BS 8110, GRADE 35 FOR REINFORCED CONCRETE, GRADE 10 FOR BLINDING CONCRETE USING OPC.
- 50mm COVER TO REINFORCEMENT, REINFORCEMENT TO BS 4449.
- ALL EDGES SHALL HAVE A CHAMFER OF APPROX. 25mm.
- ALL EXPOSED CONCRETE SURFACES SHALL BE TREATED WITH TWO COATS OF "FOSROC DEKGUARD S" WITH A DFT OF 350 MICRONS OR ANY OTHER APPROVED EQUIVALENT.
- FOUNDATION BOLTS REFER DRG. No. STD-2-3950-001-A3
- FOR BAR BENDING SCHEDULE REFER DRG. No. NIM-2-1842-041-DQ-4

NOTES/REFERENCE DRAWINGS

WorleyParsons - Arabian Industries (JV)
 CONTRACT NO.: C31/0606 PROJ. NO.: PAIP00405

REV	DATE	DRAWN BY	TEAM L.	J. ENG.	CHECKED	DESCRIPTION	WBS No.	PROJ. ENG.	SIGNATURE
A	27.02.11	GCS	RB	GSB	✓	APPROVED FOR CONSTRUCTION	IN.09.011	OSE/28N	
O	26.02.11	JRP	KBR	GSB		ISSUED FOR COMMENTS	IN.09.011	OSE/28N	

PROJECT DRAWING REVISION
IN CASE OF DEVIATIONS A MARKED UP PRINT SHALL BE SENT TO THE PROJECT ENGINEER

AREA	: NIMR	SCALE : 1:20	CAD DRAWING
SUB AREA	: NIMR SLUDGE PIT SYSTEM UPGRADE	No. 16	
DRWG. TYPE	: PIPE SUPPORTS-FOUNDATION DETAILS		
DESCRIPTION	: PS-008 & 013		
DRWG	AREA CODE	ENG SECT	SERIAL NUMBER
NO	NIM 2 1842 040 DQ	3	A

BAR BENDING SCHEDULE

JOB NO.: PAIP00405
PART ID.: NIMR SLUDGE PIT SYSTEM UPGRADE
PS-008 & 013

Document No.: NIM-2-1842-041-DQ-4

Revision No.: A

Prepared by: JRP

Checked by: PNG

Date: 27.02.11

REF. DWG NO.: NIM-2-1842-040-DO-3

Total MTO for Rebars.

Dia. Of Bar	T6	T8	T10	T12	T16	T20	T25	T32
Length of Bar (m)			90.00	19.80				
Weight (Kgs)			55.80	17.63				

Total Weight (Kgs)

73 430

k. Number
- 12

[illegible]


This schedule complies with BS 8666 : 2005

All dimensions are in mm

Refer to Bar shape Code drawing

* Specified in multiples of 5 mm

† Specified in multiples of 25 mm

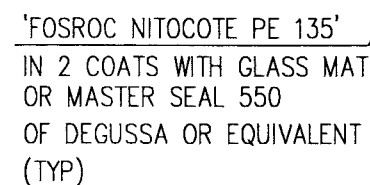

- 

 ورلي بارسونز - الصناعات العربية (محاصة)
WorleyParsons - Arabian Industries (JV)


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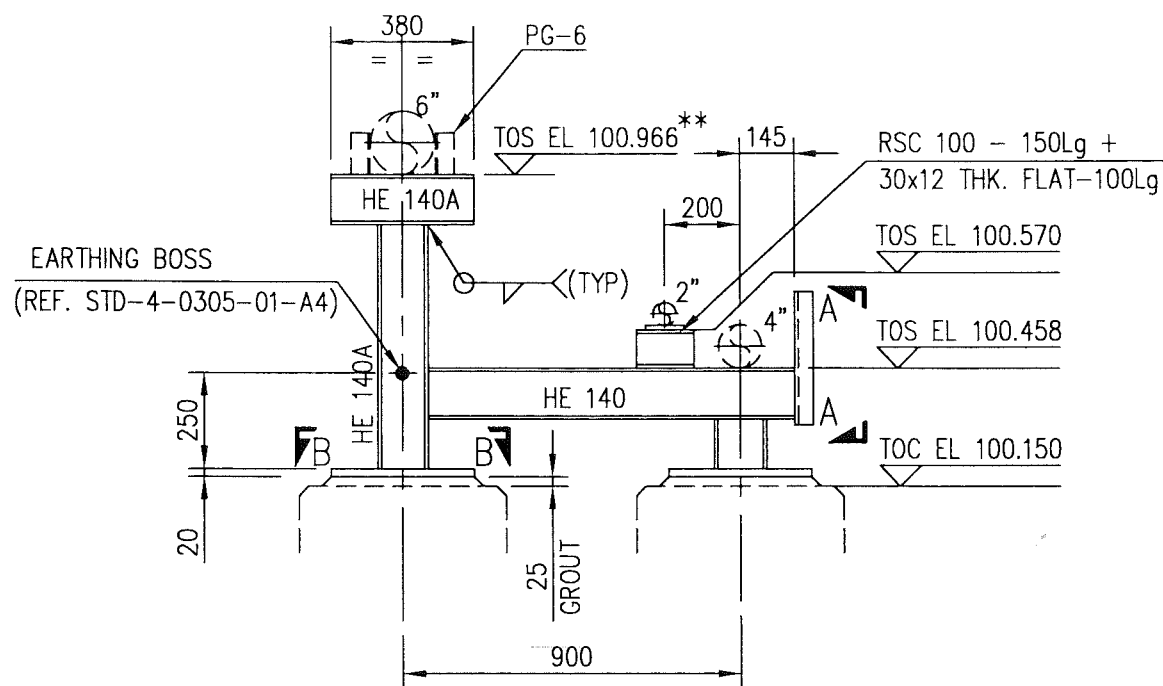
NOTE: * DENOTES, SINCE GRADE ELEVATION VARIES, CONTRACTOR TO VERIFY ELEVATIONS AND DIMENSIONS AT SITE, PRIOR TO FABRICATION/CONSTRUCTION/INSTALLATION.

1c. Manner
→ A2


APPROVED FOR
CONSTRUCTION

PROJECT DRAWING REVISION	
IN CASE OF DEVIATIONS A MARKED UP PRINT SHALL BE SENT TO THE PROJECT ENGINEER	


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				0 1 2 3 4 5 6 7			
		SUB AREA : NIMR SLUDGE PIT SYSTEM UPGRADE		No. 16		 شركة تنمية نفط عُمان Petroleum Development Oman	
S		DRWG. TYPE : PIPE SUPPORTS		DRWG		AREA CODE	
				ENG SECT		SERIAL NUMBER	
				SHEET		PROJ CODE	
		DESCRIPTION : PS-016 & 017		DWG SIZE		REV.	
				NO		A	



ELEVATION

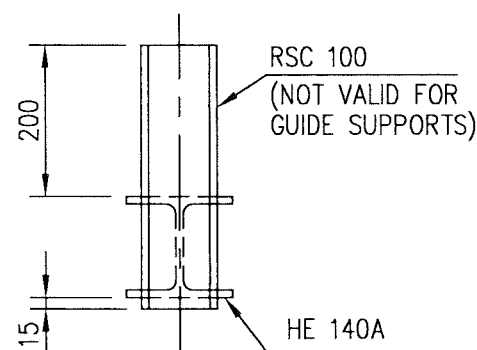

ELEVATION A-A

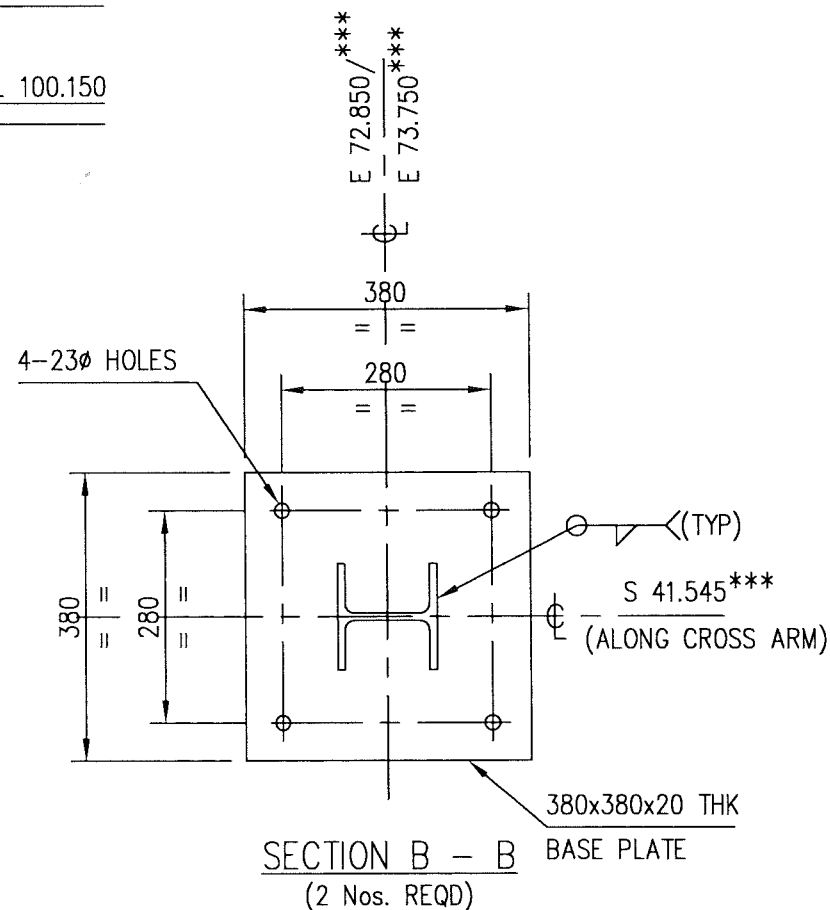


M T O			
DESCRIPTION	QUANTITY	UNITS	SAP No.
HE 140A	2.13	m	1000080438
RSC 100	0.50	m	1000145612
12 THK FLAT	0.10	m	1000032250
20 THK PLATE	0.30	m ²	1000062610
EARTHING BOSS	1	PCS	N.A.

NOTE: * DENOTES, SINCE GRADE ELEVATION VARIES, CONTRACTOR TO VERIFY ELEVATIONS AND DIMENSIONS AT SITE, PRIOR TO FABRICATION/CONSTRUCTION/INSTALLATION.

** ELEVATION UNDER HOLD
*** LOCATION SHALL BE CHECK AT SITE, BEFORE
INSTALLATION AND CONSTRUCTION OF PIPE SUPPORT

APPROVED FOR
CONSTRUCTION

REV	DATE	DRAWN BY	TEAM L.	J. ENG.	CHECKED	DESCRIPTION	WBS No.	PROJ. ENG.	SIGNATURE
A	27.02.11	GCS	RB	3/		APPROVED FOR CONSTRUCTION	IN.09.011	OSE/28N	
O	26.02.11	JRP	KBR	GSB		ISSUED FOR COMMENTS	IN.09.011	OSE/28N	
						PROJECT DRAWING REVISION	P D O APPROVAL		

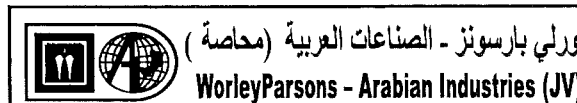



CONTRACT NO.: C31/0606 PROJ. NO.: PAIP00405

- ALL DIMENSIONS ARE IN MILLIMETRES.
- ALL ELEVATIONS & CO-ORDINATES ARE IN METRES.
- ALL STEEL WORK TO BS EN 10025 GRADE S275 JR
- PIPE SECTION TO API 5L GR B.
- ALL CONNECTIONS TO BE MADE USING 5mm CFW.
- ALL STEEL WORK TO RECEIVE CORROSION PROTECTION IN ACCORDANCE WITH DOCUMENT No. SP-1246-2

NOTES



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PIPE GUIDE DETAILS	NIM	2	1842	066	DQ	3
DESCRIPTION	AREA	S	SERIAL	SH.	P	S
DRAWING NUMBER						

REFERENCE DRAWINGS

AREA : NIMR			SCALE : 1:20		CAD DRAWING					
										
SUB AREA : NIMR SLUDGE PIT SYSTEMS		NO. 16								
			شركة تنمية نفط عُمان							
			Petroleum Development Oman							
DRWG. TYPE : PIPE SUPPORTS		DRWG		AREA CODE	ENG SECT	SERIAL NUMBER	SHEET	PROJ CODE	DWG SIZE	REV
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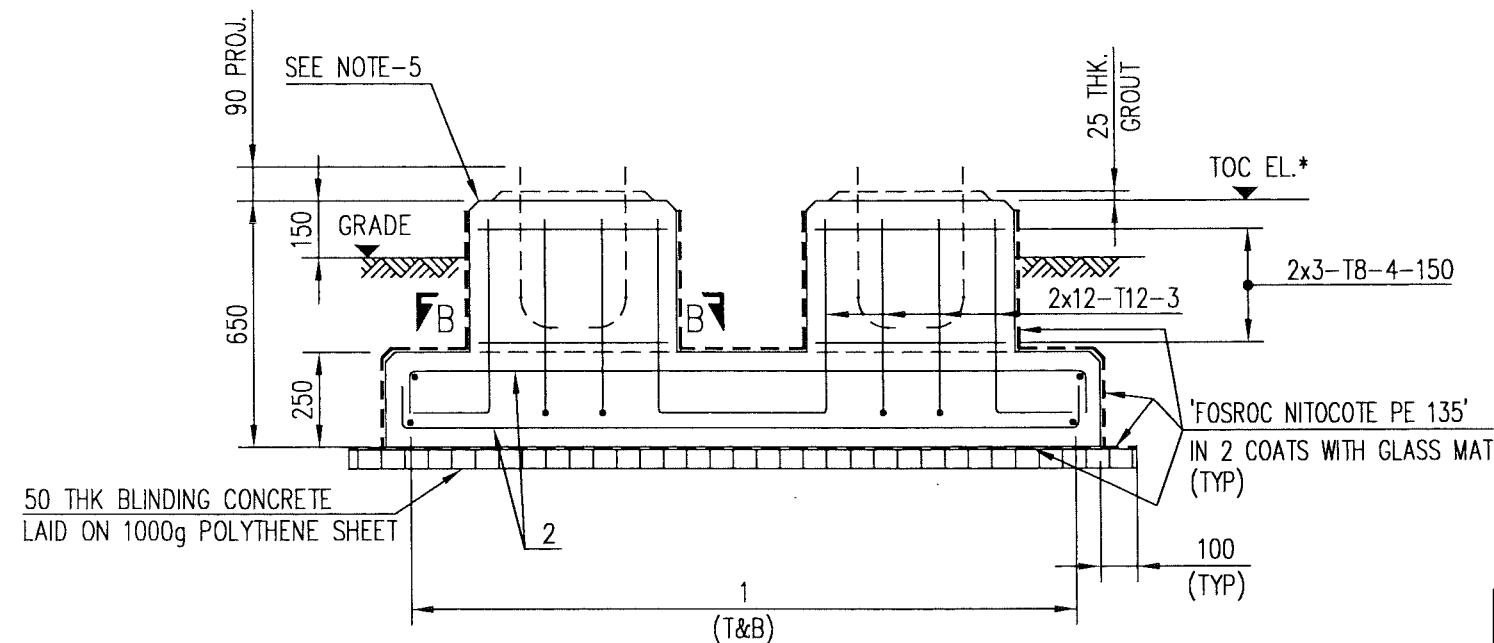
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NOTE: * DENOTES, SINCE GRADE ELEVATION VARIES, CONTRACTOR TO VERIFY ELEVATIONS AND DIMENSIONS AT SITE, PRIOR TO FABRICATION/CONSTRUCTION/INSTALLATION.




REINFORCEMENT PLAN

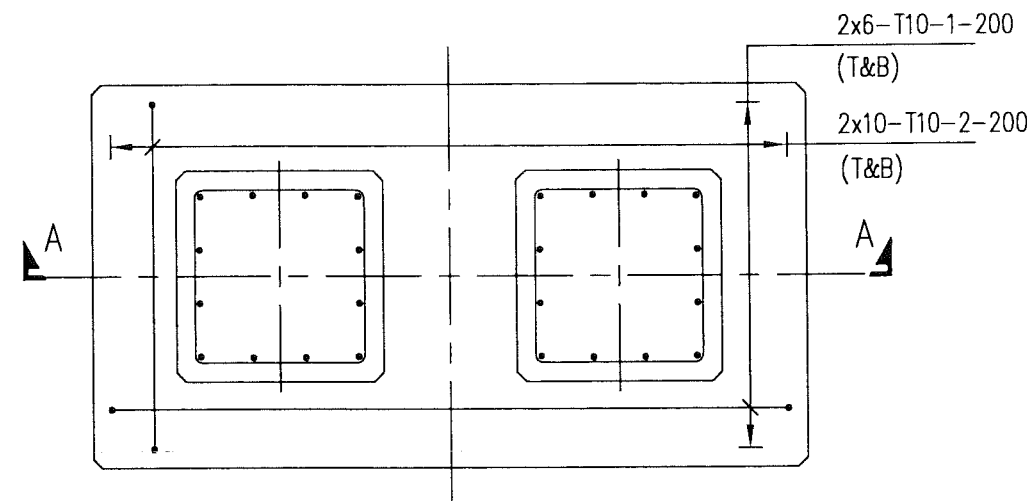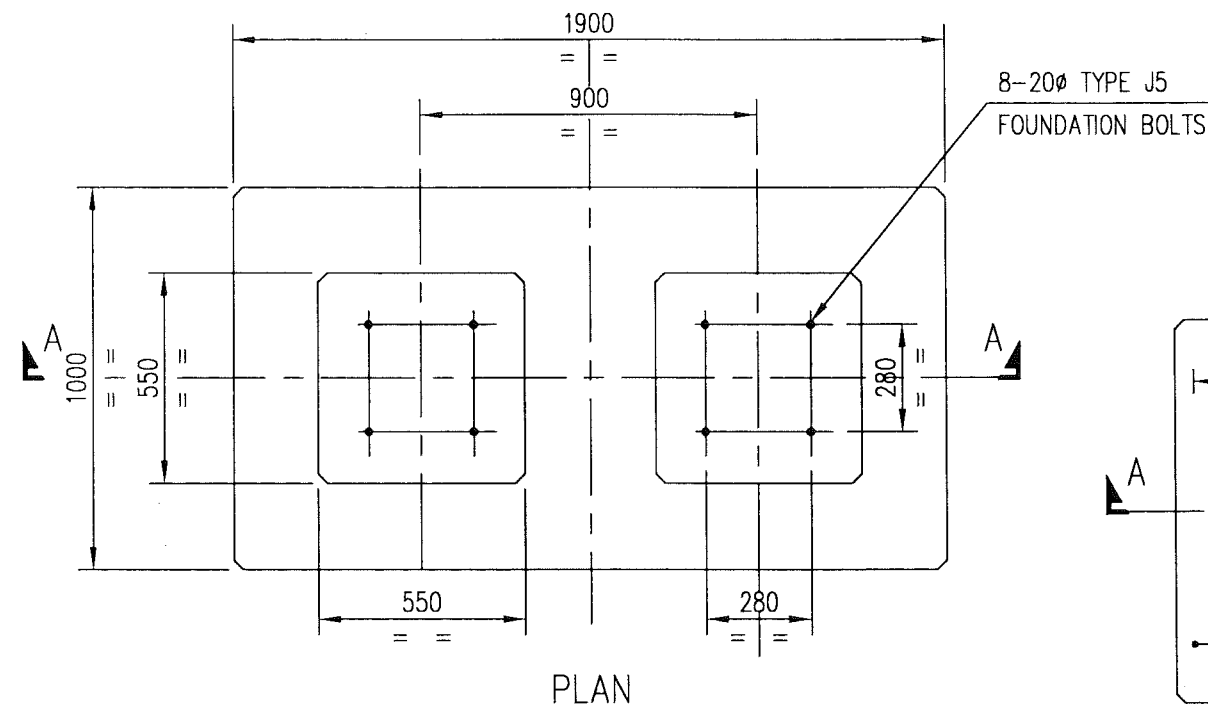M T O			
DESCRIPTION	QUANTITY	UNITS	SAP No.
BLINDING CONCRETE GRADE 10	0.13	m ³	N.A.
CONCRETE GRADE 35	0.72	m ³	N.A.
CEMENT SAND GROUT	10.52	lit	N.A.
REINFORCEMENT STEEL	49.25	Kg	N.A.
PROTECTIVE COATING	7.05	m ²	N.A.
20mm FOUNDATION BOLT TYPE - J5	8	PCS	N.A.
POLYTHENE SHEET	2.52	PCS	N.A.



SECTION A-A

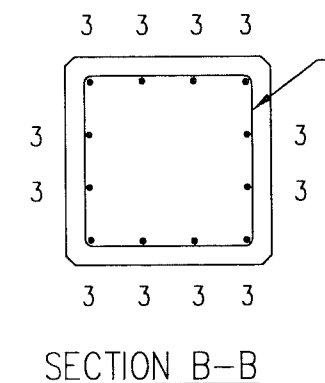

SECTION B-B

APPROVED FOR CONSTRUCTION

REV	DATE	DRAWN BY	TEAM	J.ENG.	DESCRIPTION	WBS No.	PROJ. ENG.	SIGNATURE
A	27.02.11	GCS	KBR	GSB	APPROVED FOR CONSTRUCTION	IN.09.011	OSE/28N	
O	26.02.11	JRP	KBR	GSB	ISSUED FOR COMMENTS	IN.09.011	OSE/28N	

WorleyParsons - Arabian Industries (JV)
 CONTRACT NO.: C31/0606 PROJ. NO.: PAIP00405

- ALL DIMENSIONS ARE IN MILLIMETRES AND ELEVATIONS IN METRES.
- CONCRETE TO BS 8110, GRADE 35 FOR REINFORCED CONCRETE, GRADE 10 FOR BLINDING CONCRETE USING OPC.
- 50mm COVER TO REINFORCEMENT, REINFORCEMENT TO BS 4449.
- ALL EDGES SHALL HAVE A CHAMFER OF APPROX. 25mm.
- ALL EXPOSED CONCRETE SURFACES SHALL BE TREATED WITH TWO COATS OF "FOSROC DEKGUARD S" WITH A DFT OF 350 MICRONS OR ANY OTHER APPROVED EQUIVALENT.
- FOUNDATION BOLTS REFER DRG. No. STD-2-3950-001-A3
- FOR BAR BENDING SCHEDULE REFER DRG. No. NIM-2-1842-046-DQ-4

PROJECT DRAWING REVISION
IN CASE OF DEVIATIONS A MARKED UP PRINT SHALL BE SENT TO THE PROJECT ENGINEER

AREA	: NIMR	SCALE : 1:20	CAD DRAWING
SUB AREA	: NIMR SLUDGE PIT SYSTEMS	No. 16	
DRWG. TYPE	: PIPE SUPPORTS-FOUNDATION DETAILS		
DESCRIPTION	: PS-028		

NOTES/REFERENCE DRAWINGS

BAR BENDING SCHEDULE

JOB NO.: PAIP00405
PART ID.: NIMR SLUDGE PIT SYSTEM UPGRADE
PS-028

Document No.: NIM-2-1842-046-DQ-4
Revision No.: A
Prepared by: JRP
Checked by: PNG *38*
Date: 27.02.11

REF. DWG NO.: NIM-2-1842-045-DQ-3

Total MTO for Rebars.

Dia. Of Bar	T6	T8	T10	T12	T16	T20	T25	T32
Length of Bar (m)		11.85	46.80	17.40				
Weight (Kgs)		4.74	29.02	15.49				

Total Weight (Kgs)

49 250

K. Munn
-A2

[illegible]


This schedule complies with BS 8666 : 2005

All dimensions are in mm


Refer to Bar shape Code drawing

* Specified in multiples of 5 mm

† Specified in multiples of 25 mm

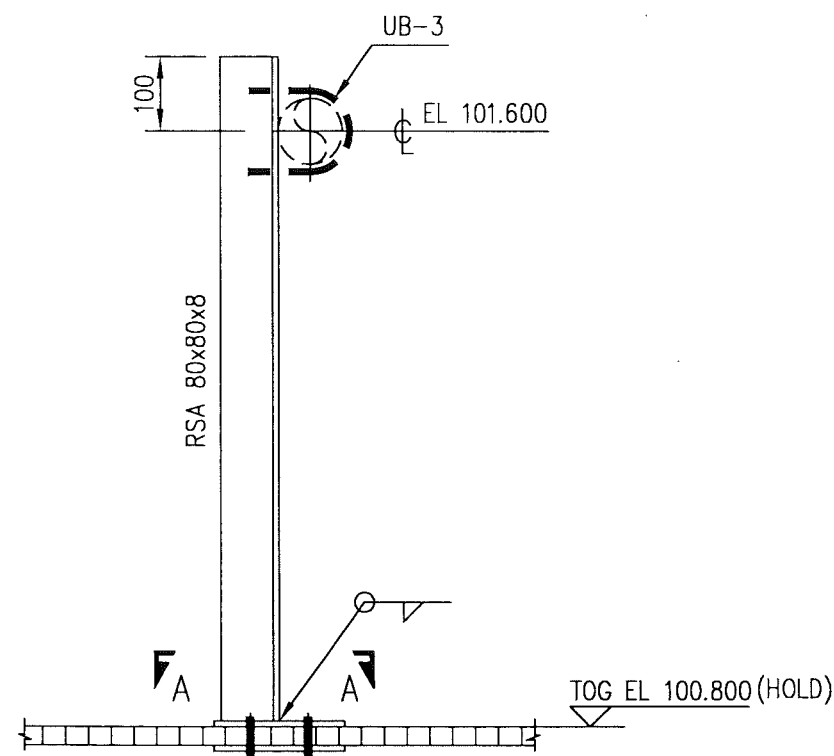

ELEVATION
(2 Nos. REQD)

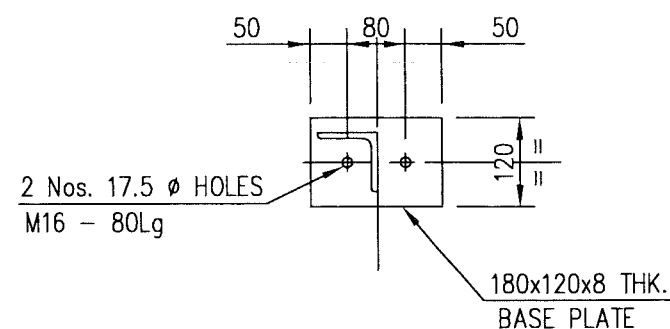

SECTION A-A
(2x2 Nos. REQ'D)

M T O			
DESCRIPTION	QUANTITY	UNITS	SAP No.
RSA 80x80x8	1.80	m	1000062630
8 THK PLATE	0.10	m ²	1000062607
M16 DIA BOLTS	4	Nos.	1000062607

**APPROVED FOR
CONSTRUCTION**



CONTRACT NO. : C31/0606 PROJ. NO. : PAIP00405

1. ALL DIMENSIONS ARE IN MILLIMETRES.	PIPING G.A (PS-029)	NIM	3	2140	001	DQ	1
2. ALL ELEVATIONS & CO-ORDINATES ARE IN METRES.	PIPING G.A (PS-045)	NIM	3	2142	001	DQ	1
3. ALL STEEL WORK TO BS EN 10025 GRADE S275 JR	'U' BOLT (PIPE NOT GRIPPED)	NIM	2	1842	064	DQ	3
4. PIPE SECTION TO API 5L GR B.							
5. ALL CONNECTIONS TO BE MADE USING 5mm CFW.							
6. ALL STEEL WORK TO RECEIVE CORROSION PROTECTION IN ACCORDANCE WITH DOCUMENT No. SP-1246-2							
DESCRIPTION	AREA	S	SERIAL	SH.	P	S	
DRAWING NUMBER							


NOTES

REFERENCE DRAWINGS


REV	DATE	DRAWN BY	TEAML.	J.ENG.	CHECKED	DESCRIPTION	WBS No.	PROJ. ENG.	SIGNATURE
A	27.02.11	GCS	PR	Y.		APPROVED FOR CONSTRUCTION	IN.09.011	OSE/28N	
O	26.02.11	JRP	KBR	GSB		ISSUED FOR COMMENTS	IN.09.011	OSE/28N	
P D O APPROVAL									

PROJECT DRAWING REVISION
IN CASE OF DEVIATIONS A MARKED UP PRINT SHALL BE SENT TO THE PROJECT ENGINEER


AREA : NIMR	SCALE : 1:10	CAD DRAWING
SUB AREA : NIMR SLUDGE PIT SYSTEMS	NO. 16	
DRWG. TYPE : PIPE SUPPORTS		
DESCRIPTION : PS-029 & 045		
DRWG	AREA CODE	ENG SECT
SERIAL NUMBER	SHEET	PROJ CODE
DWG SIZE	REV.	
NO	NIM	2 1842 047 DQ 3 A

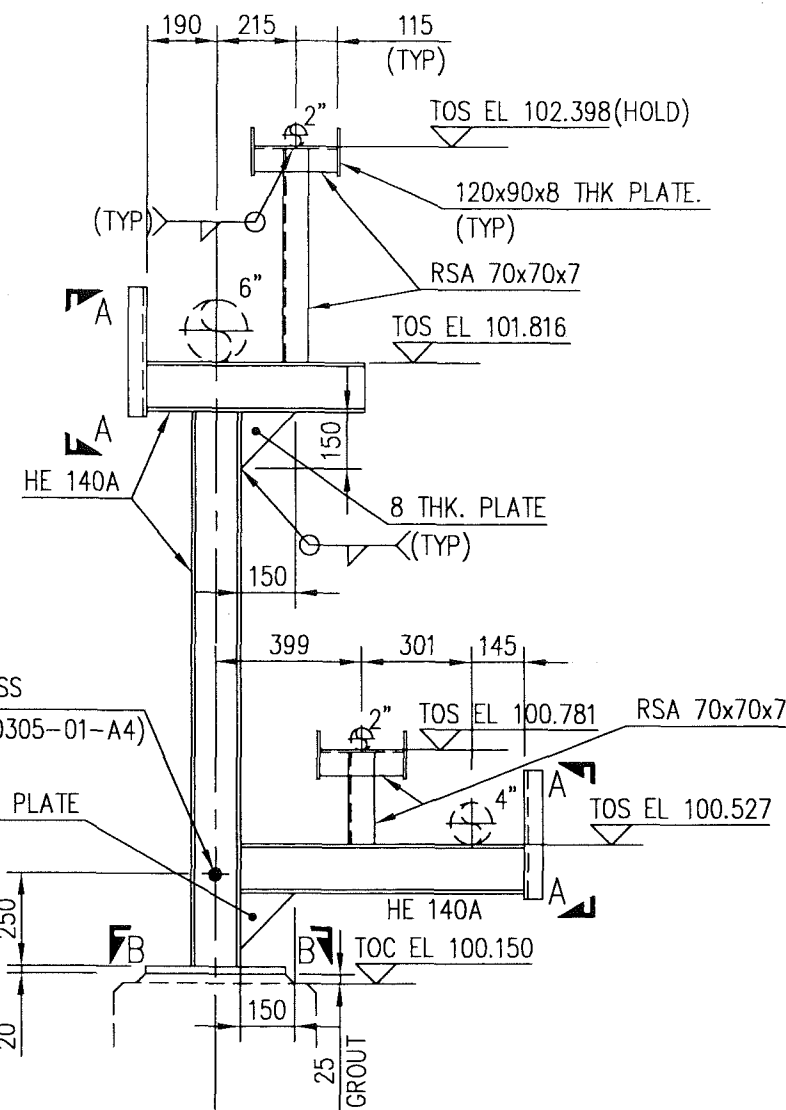

ELEVATION

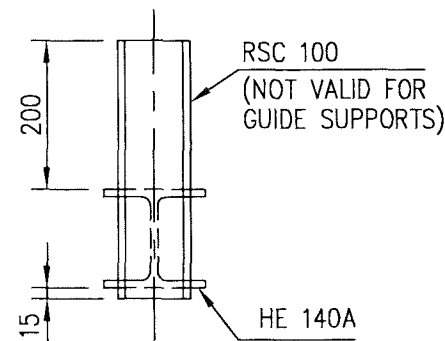

ELEVATION A-A

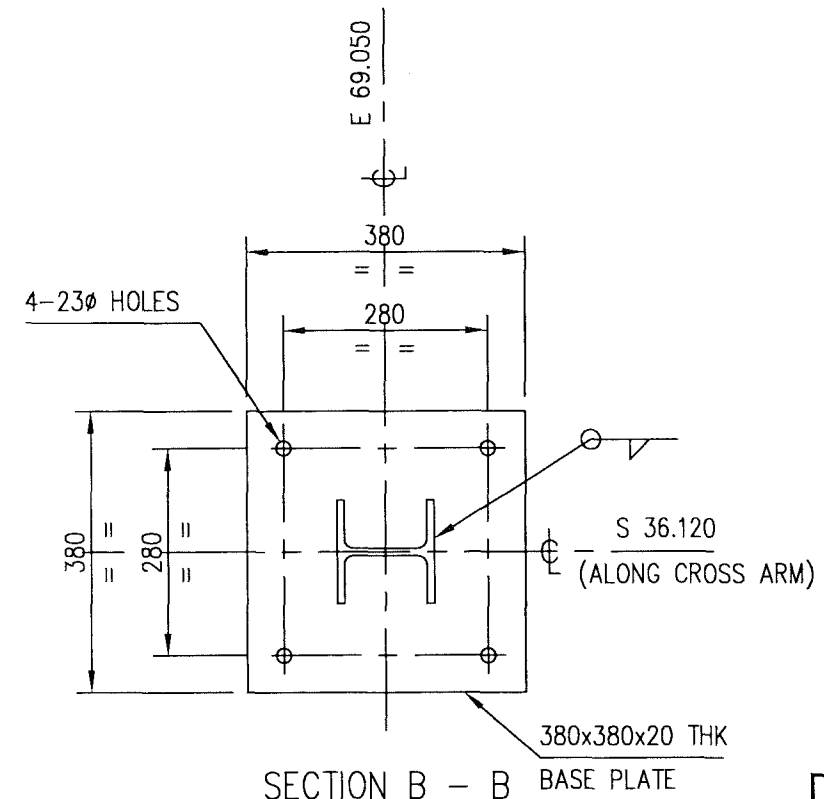


SECTION B - B BASE PLATE

M T O

DESCRIPTION	QUANTITY	UNITS	SAP No.
HE 140A	3.00	m	1000080438
RSC 100	0.70	m	1000145612
RSA 70x70x7	1.30	m	1000080321
8 THK PLATE	0.05	m ²	1000062607
20 THK PLATE	0.15	m ²	1000062610
EARTHING BOSS	1	PCS	N.A.

NOTE: ✕ DENOTES, SINCE GRADE ELEVATION VARIES, CONTRACTOR TO VERIFY ELEVATIONS AND DIMENSIONS AT SITE, PRIOR TO FABRICATION/CONSTRUCTION/INSTALLATION.

APPROVED FOR CONSTRUCTION

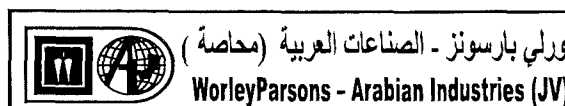

CONTRACT NO.: C31/0606 PROJ. NO.: PAIP00405

REV	DATE	DRAWN BY	TEAML.	J.ENG.	CHECKED	DESCRIPTION	WBS No.	PROJ. ENG.	SIGNATURE
A	27.02.11	GCS	KBR	GSB		APPROVED FOR CONSTRUCTION	IN.09.011	OSE/28N	
O	26.02.11	JRP	KBR	GSB		ISSUED FOR COMMENTS	IN.09.011	OSE/28N	

PROJECT DRAWING REVISION
IN CASE OF DEVIATIONS A MARKED UP PRINT SHALL BE SENT TO THE PROJECT ENGINEER

- ALL DIMENSIONS ARE IN MILLIMETRES.
- ALL ELEVATIONS & CO-ORDINATES ARE IN METRES.
- ALL STEEL WORK TO BS EN 10025 GRADE S275 JR
- PIPE SECTION TO API 5L GR B.
- ALL CONNECTIONS TO BE MADE USING 5mm CFW.
- ALL STEEL WORK TO RECEIVE CORROSION PROTECTION IN ACCORDANCE WITH DOCUMENT No. SP-1246-2


NOTES

DESCRIPTION	AREA	S	SERIAL	SH.	P	S
FOUNDATION DETAILS	NIM	2	1842	049	DQ	3


REFERENCE DRAWINGS

AREA : NIMR
SUB AREA : NIMR SLUDGE PIT SYSTEMS NO. 16
DRWG. TYPE : PIPE SUPPORTS
DESCRIPTION : PS-030


SCALE : 1:20	CAD DRAWING
0 1 2 3 4 5 6 7	
شركة تنمية نفط عُمان	Petroleum Development Oman
DRWG	AREA CODE
ENG SECT	SERIAL NUMBER
SHEET	PROJ CODE
DWG SIZE	REV.
NO	NIM 2 1842 048 DQ 3 A

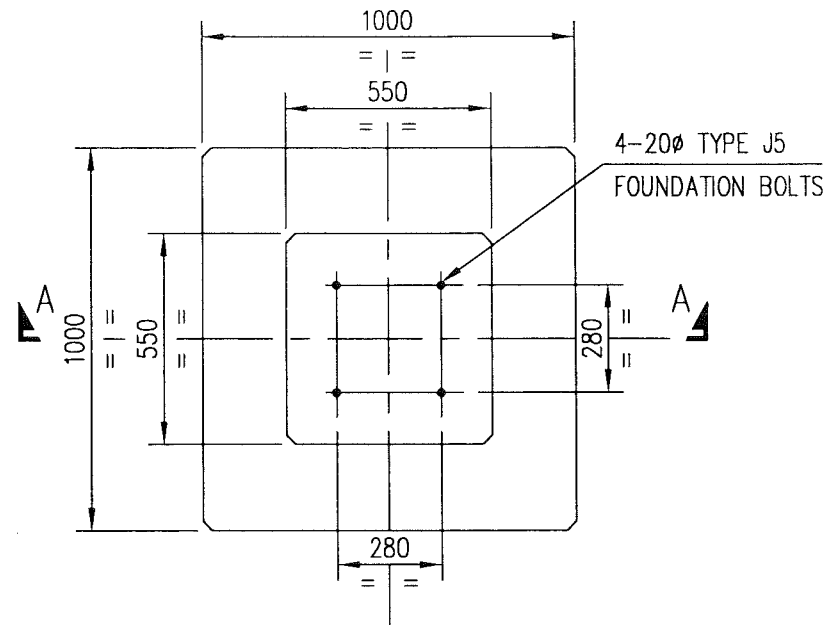


PLAN
(6 Nos. REQD.)

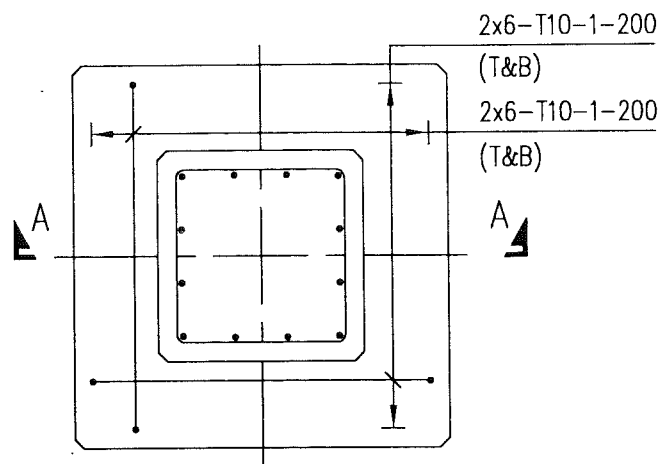

REINFORCEMENT PLAN

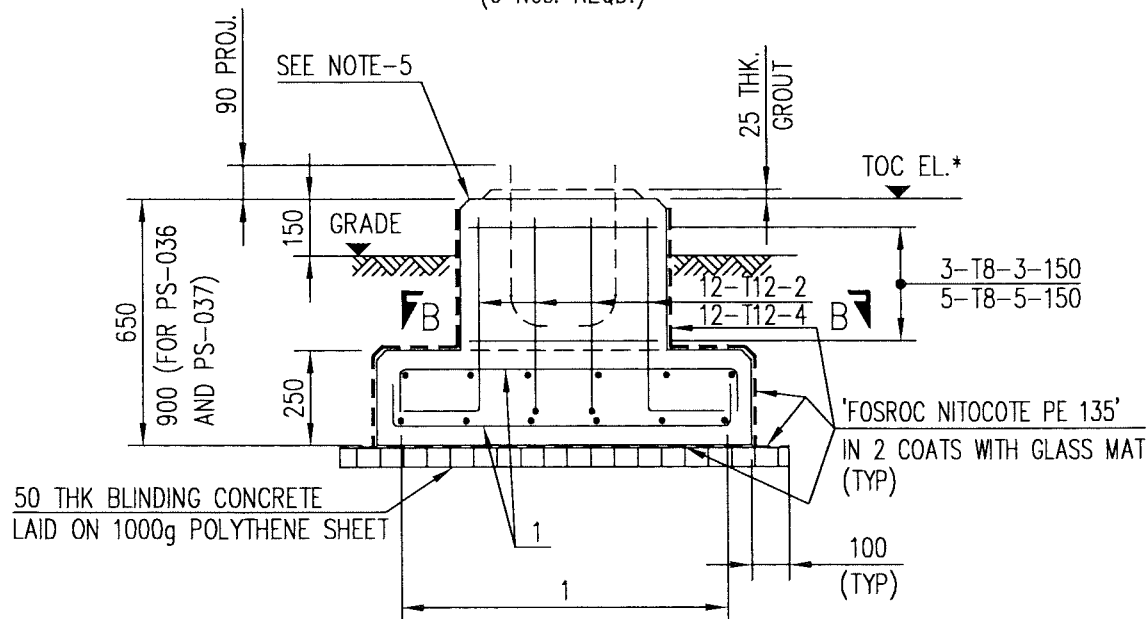

SECTION A - A

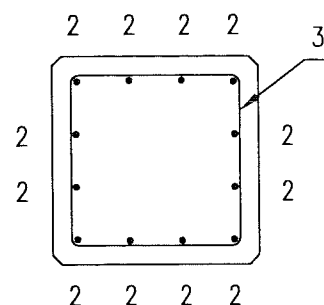

SECTION B - B

FOUNDATION DESIGNATION	REFERENCE DRAWING	NUMBERS REQUIRED	*TOC EL.
PS-030	NIM-2-0992-001-DQ-1	1	100.150
PS-031			
PS-032			
PS-033			
PS-036			
PS-037			

NOTE: * DENOTES, SINCE GRADE ELEVATION VARIES, CONTRACTOR TO VERIFY ELEVATIONS AND DIMENSIONS AT SITE, PRIOR TO FABRICATION/CONSTRUCTION/INSTALLATION.

M T O			
DESCRIPTION	QUANTITY	UNITS	SAP No.
BLINDING CONCRETE GRADE 10	0.43	m ³	N.A.
CONCRETE GRADE 35	2.40	m ³	N.A.
CEMENT SAND GROUT	31.57	lit	N.A.
REINFORCEMENT STEEL	169.62	Kg	N.A.
PROTECTIVE COATING	25.21	m ²	N.A.
20mm FOUNDATION BOLT TYPE - J5	24	PCS	N.A.
POLYTHENE SHEET	8.64	PCS	N.A.

APPROVED FOR
CONSTRUCTION

[THIS DRAWING IS BASED ON P.D.O. DRG. No. STD-2-3903-001-A3-E - TYPE 903]

- ALL DIMENSIONS ARE IN MILLIMETRES AND ELEVATIONS IN METRES.
- CONCRETE TO BS 8110, GRADE 35 FOR REINFORCED CONCRETE, GRADE 10 FOR BLINDING CONCRETE USING OPC.
- 50mm COVER TO REINFORCEMENT, REINFORCEMENT TO BS 4449.
- ALL EDGES SHALL HAVE A CHAMFER OF APPROX. 25mm.
- ALL EXPOSED CONCRETE SURFACES SHALL BE TREATED WITH TWO COATS OF "FOSROC DEKGUARD S" WITH A DFT OF 350 MICRONS OR ANY OTHER APPROVED EQUIVALENT.
- FOUNDATION BOLTS REFER DRG. No. STD-2-3950-001-A3
- FOR BAR BENDING SCHEDULE REFER DRG. No. NIM-2-1842-050-DQ-4

NOTES/REFERENCE DRAWINGS

WorleyParsons - Arabian Industries (JV)
 CONTRACT NO.: C31/0606 PROJ. NO.: PAIP00405

REV	DATE	DRAWN BY	TEAM L.	J. ENG.	CHECKED	DESCRIPTION	WBS No.	PROJ. ENG.	SIGNATURE
A	27.02.11	GCS	RB	✓		APPROVED FOR CONSTRUCTION	IN.09.011	OSE/28N	
O	26.02.11	JRP	KBR	GSB		ISSUED FOR COMMENTS	IN.09.011	OSE/28N	

PROJECT DRAWING REVISION
IN CASE OF DEVIATIONS A MARKED UP PRINT SHALL BE SENT TO THE PROJECT ENGINEER

AREA	: NIMR	SCALE	: 1:20	CAD DRAWING
SUB AREA	: NIMR SLUDGE PIT SYSTEMS	No.	16	
DRWG. TYPE	: PIPE SUPPORTS-FOUNDATION DETAILS			
DESCRIPTION	: PS-030 TO 033, 036 & 037			
DRWG	AREA CODE	ENG SECT	SERIAL NUMBER	SHEET
NO	NIM	2	1842	049DQ
				3 A

BAR BENDING SCHEDULE

JOB NO.: PAIP00405
PART ID.: NIMR SLUDGE PIT SYSTEM UPGRADE
PS-030 TO 033, 036 & 037

Document No.: NIM-2-1842-050-DQ-4

Revision No.: A

Prepared by: JRP

Checked by: PNG

Date: 27.02.11

REF. DWG NO.: NIM-2-1842-049-DQ-3

Total MTO for Rebars.

Dia. Of Bar	T6	T8	T10	T12	T16	T20	T25	T32
Length of Bar (m)		43.45	162.00	58.20				
Weight (Kgs)		17.38	100.44	51.80				

Total Weight (Kgs)

169.620

[illegible]

12. Manner
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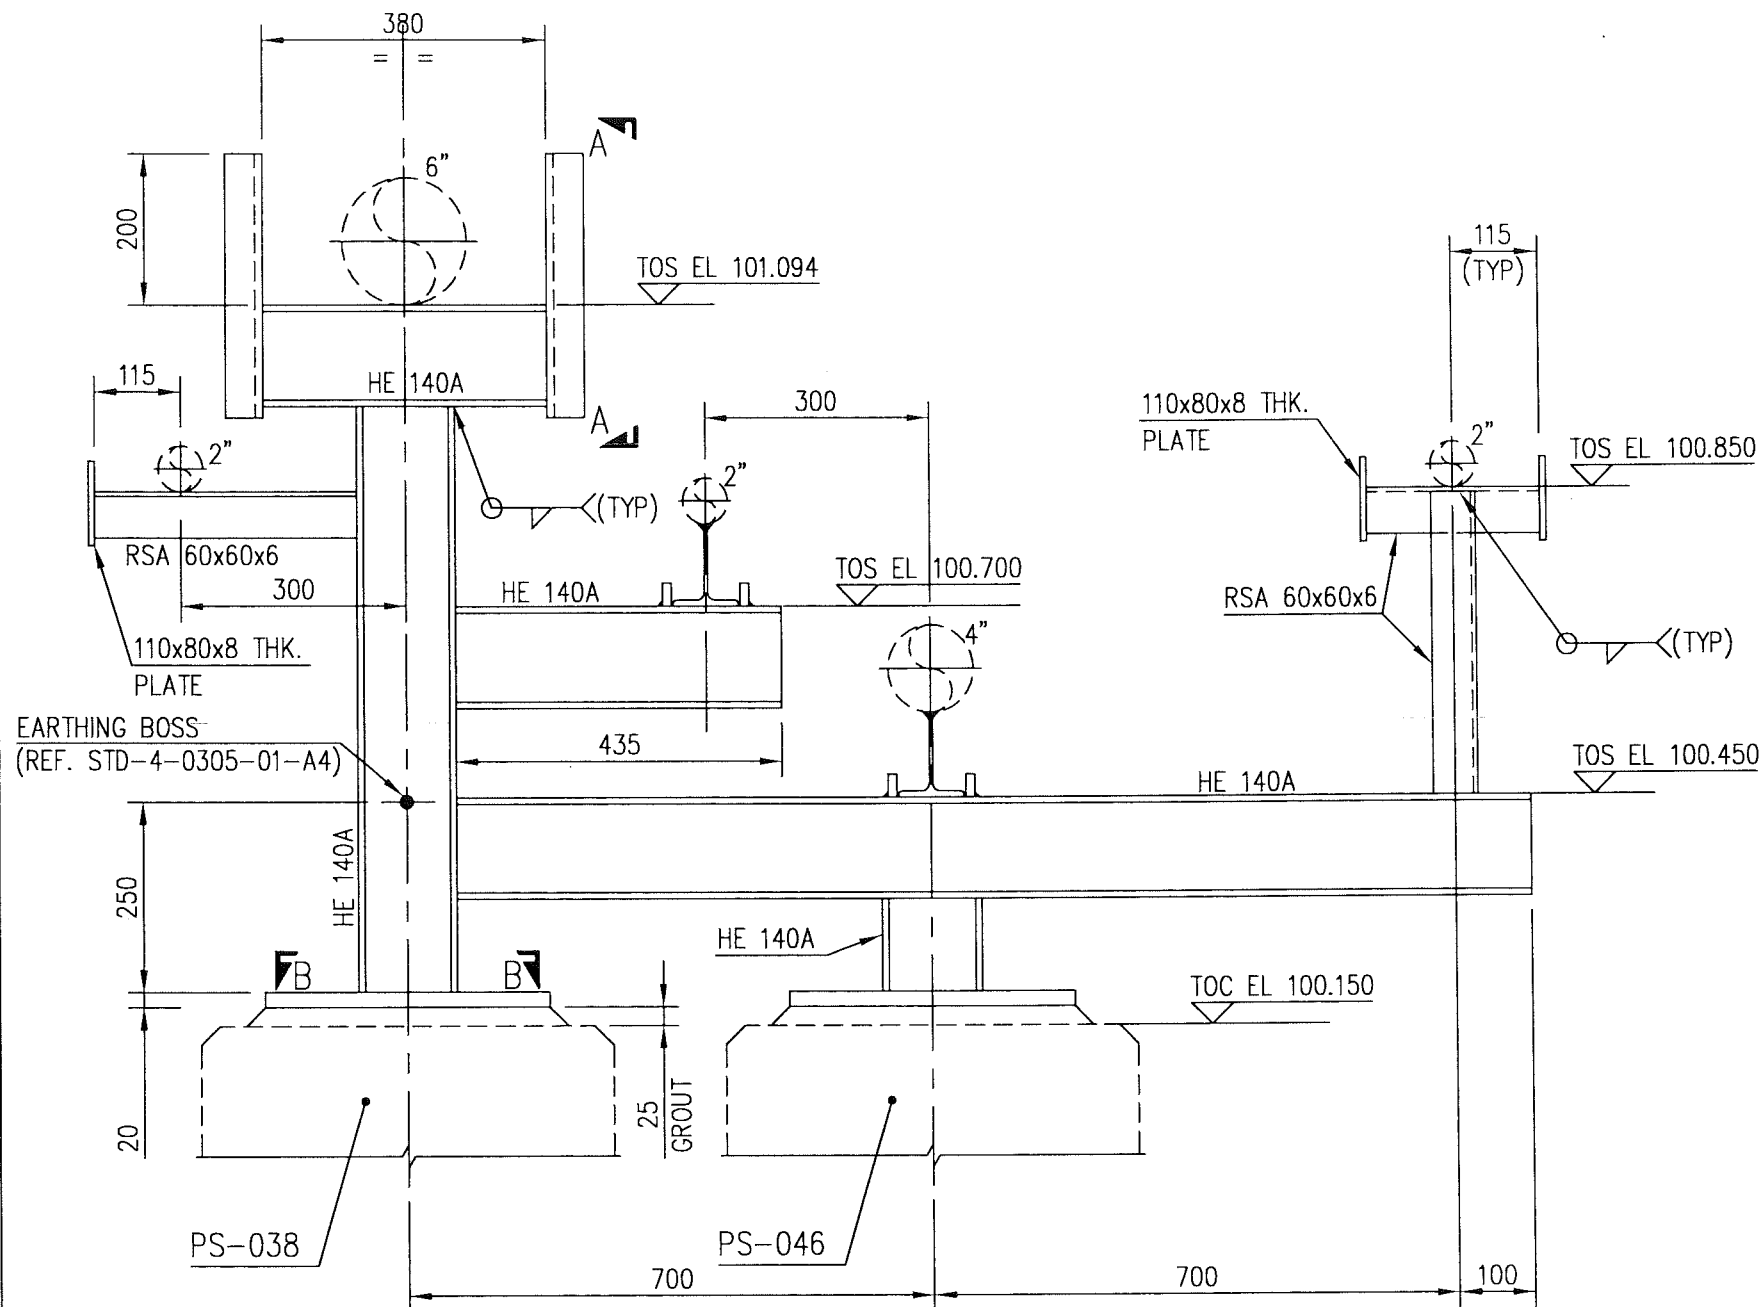
This schedule complies with BS 8666 : 2005

All dimensions are in mm

Refer to Bar shape Code drawing

* Specified in multiples of 5 mm


† Specified in multiples of 25 mm



ELEVATION
(SCALE 1:10)

M T O			
DESCRIPTION	QUANTITY	UNITS	SAP No.
HE 140A	3.15	m	1000080438
RSC 100	0.70	m	1000145612
RSA 60x60x6	1.00	m	1000080320
8 THK PLATE	0.03	m ²	1000062607
20 THK PLATE	0.30	m ²	1000062610
EARTHING BOSS	1	PCS	N.A.

NOTE: * DENOTES, SINCE GRADE ELEVATION VARIES, CONTRACTOR TO VERIFY ELEVATIONS AND DIMENSIONS AT SITE, PRIOR TO FABRICATION/CONSTRUCTION/INSTALLATION.

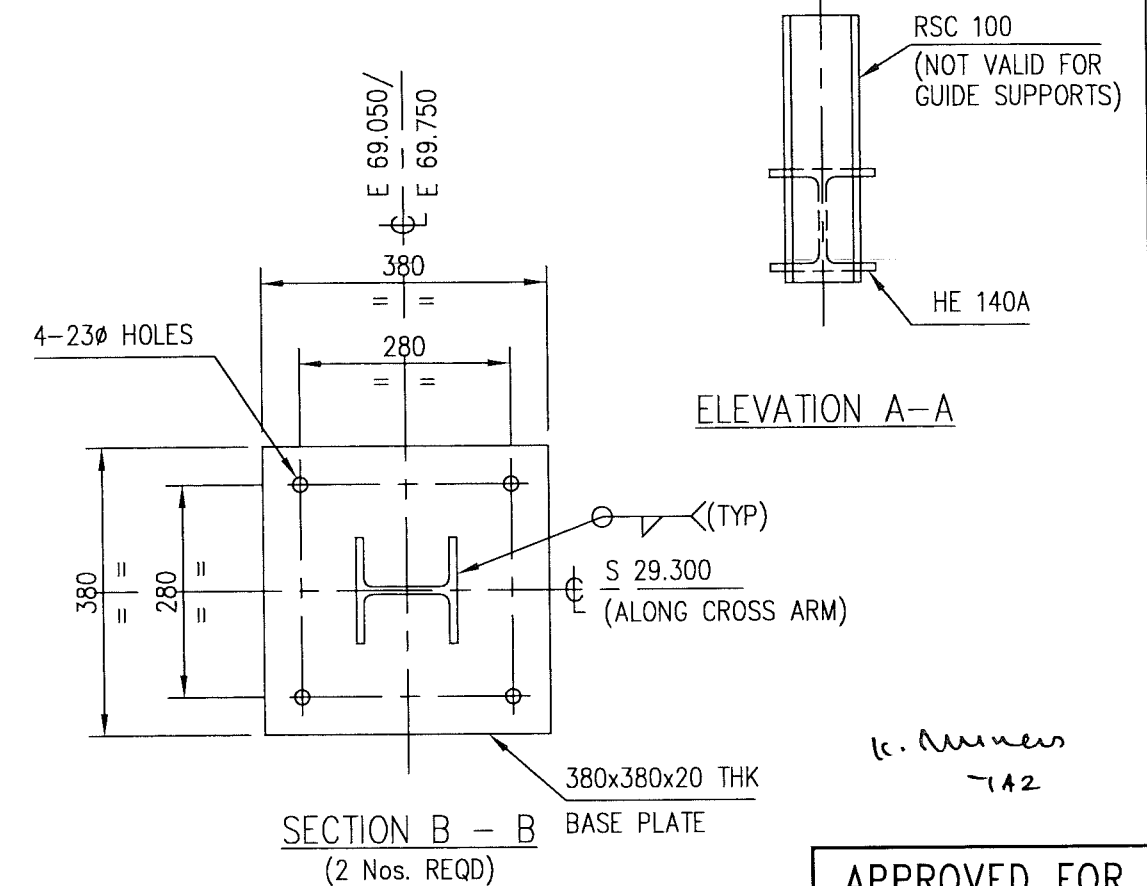

ELEVATION A-A

SECTION B - B
(2 Nos. REQD)

APPROVED FOR
CONSTRUCTION



CONTRACT NO.: C31/0606 PROJ. NO.: PAIP00405

- ALL DIMENSIONS ARE IN MILLIMETRES.
- ALL ELEVATIONS & CO-ORDINATES ARE IN METRES.
- ALL STEEL WORK TO BS EN 10025 GRADE S275 JR
- PIPE SECTION TO API 5L GR B.
- ALL CONNECTIONS TO BE MADE USING 5mm CFW.
- ALL STEEL WORK TO RECEIVE CORROSION PROTECTION IN ACCORDANCE WITH DOCUMENT No. SP-1246-2

NOTES

DESCRIPTION	AREA	S	SERIAL	SH.	P	S
FOUNDATION DETAILS	NIM	2	1842	056	DQ	3
LINE STOP DETAILS	NIM	2	1842	067	DQ	3
SHOE DETAILS	NIM	2	1842	068	DQ	3
SHOE GUIDE DETAILS	NIM	2	1842	069	DQ	3

REFERENCE DRAWINGS

REV	DATE	DRAWN BY	CHECKED	DESCRIPTION	WBS No.	PROJ. ENG.	SIGNATURE
A	27.02.11	GCS	BB	APPROVED FOR CONSTRUCTION	IN.09.011	OSE/28N	
O	26.02.11	JRP	KBR	ISSUED FOR COMMENTS	IN.09.011	OSE/28N	

PROJECT DRAWING REVISION
IN CASE OF DEVIATIONS A MARKED UP PRINT SHALL BE SENT TO THE PROJECT ENGINEER

AREA	: NIMR	SCALE : 1:20	CAD DRAWING
SUB AREA	: NIMR SLUDGE PIT SYSTEMS	0 1 2 3 4 5 6 7	
DRWG. TYPE	: PIPE SUPPORTS		
DESCRIPTION	: PS-038 & 046		

شركة تنمية نفط عُمان
Petrochem Development Oman

DRWG	AREA CODE	ENG SECT	SERIAL NUMBER	SHEET	PROJ CODE	DWG SIZE	REV.
NO	NIM	2	1842	055	DQ	3	A



BAR BENDING SCHEDULE

JOB NO.: PAIP00405
PART ID.: NIMR SLUDGE PIT SYSTEM UPGRADE
 PS-038 & 046

Document No.: NIM-2-1842-057-DQ-4

Revision No.: A

Prepared by: JRP

Checked by: PNG

Date: 27.02.11

REF. DWG NO.: NIM-2-1842-056-DQ-3

Total MTO for Rebars.

Dia. Of Bar	T6	T8	T10	T12	T16	T20	T25	T32
Length of Bar (m)		11.85	46.35	17.40				
Weight (Kgs)		4.74	28.74	15.49				

Total Weight (Kgs)

48 970

[illegible]

k. Munnus
-A2


This schedule complies with BS 8666 : 2005

All dimensions are in mm

Refer to Bar shape Code drawing

* Specified in multiples of 5 mm

† Specified in multiples of 25 mm

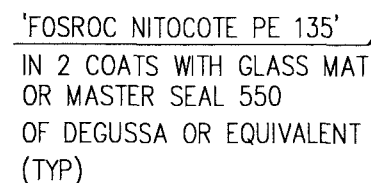

NOTE: * DENOTES, SINCE GRADE ELEVATION VARIES, CONTRACTOR TO VERIFY ELEVATIONS AND DIMENSIONS AT SITE, PRIOR TO FABRICATION/CONSTRUCTION/INSTALLATION.

k. Munnery
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
APPROVED FOR
CONSTRUCTION


-  ورلي بارسونز - الصناعات العربية (محاصة)
WorleyParsons - Arabian Industries (JV)

	A	27.02.11	GCS			APPROVED FOR CONSTRUCTION	IN.09.011	OSE/28N	
	O	26.02.11	JRP	KBR	GSB	ISSUED FOR COMMENTS	IN.09.011	OSE/28N	
	REV	DATE	DRAWN BY	TEAM L.	J. ENG.	DESCRIPTION	WBS No.	PROJ. ENG.	SIGNATURE
				CHECKED				P D O APPROVAL	



PROJECT DRAWING REVISION

IN CASE OF DEVIATIONS A MARKED UP PRINT SHALL BE SENT TO THE PROJECT ENGINEER

3	AREA : NIMR		SCALE : 1:20		CAD DRAWING							
	SUB AREA : NIMR SLUDGE PIT SYSTEM UPGRADE		No. 16		 شركة تنمية نفط عُمان Petroleum Development Oman							
S	DRWG. TYPE : PIPE SUPPORTS				DRWG	AREA CODE	ENG SECT	SERIAL NUMBER	SHEET	PROJ CODE	DWG SIZE	REV.
	DESCRIPTION : PS-039 & 040				NO	NIM	2	1842058DQ	3		A	

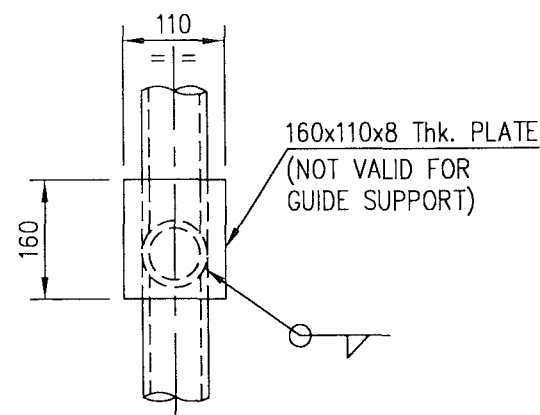


ELEVATION C-C

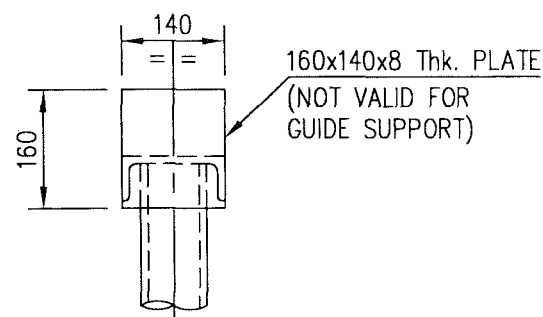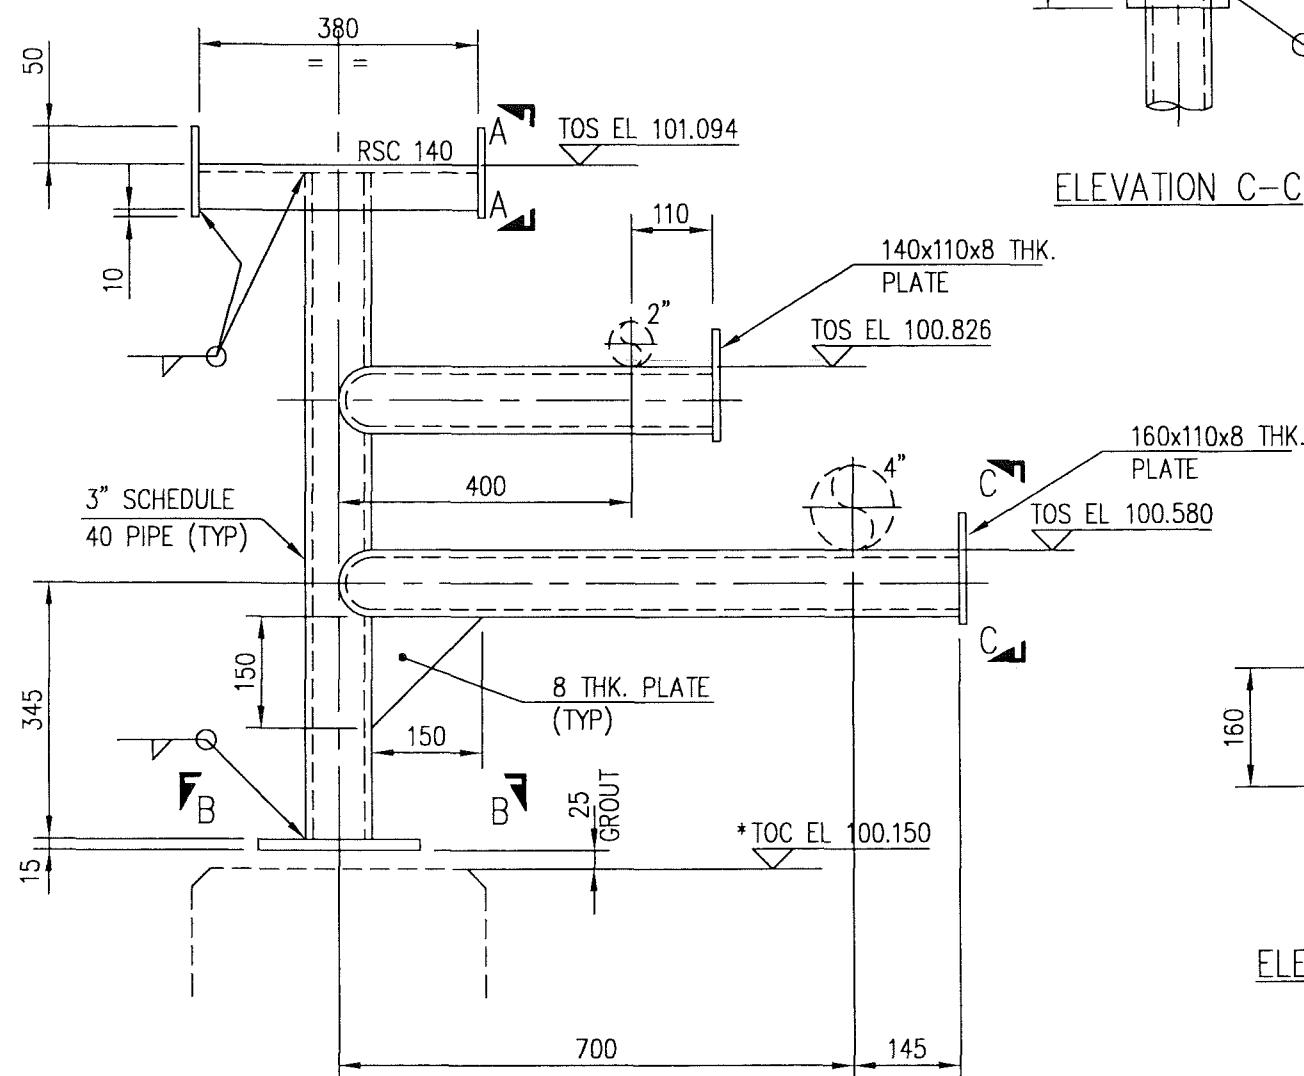

ELEVATION A-A

M T O			
DESCRIPTION	QUANTITY	UNITS	SAP No.
3" SCHEDULE 40 PIPE	2.30	m	1000051540
RSC 140	0.40	m	1000080366
15 THK PLATE	0.05	m ²	1000080265
8 THK PLATE	0.08	m ²	1000062607

NOTE: * DENOTES, SINCE GRADE ELEVATION VARIES, CONTRACTOR TO VERIFY ELEVATIONS AND DIMENSIONS AT SITE, PRIOR TO FABRICATION/CONSTRUCTION/INSTALLATION.

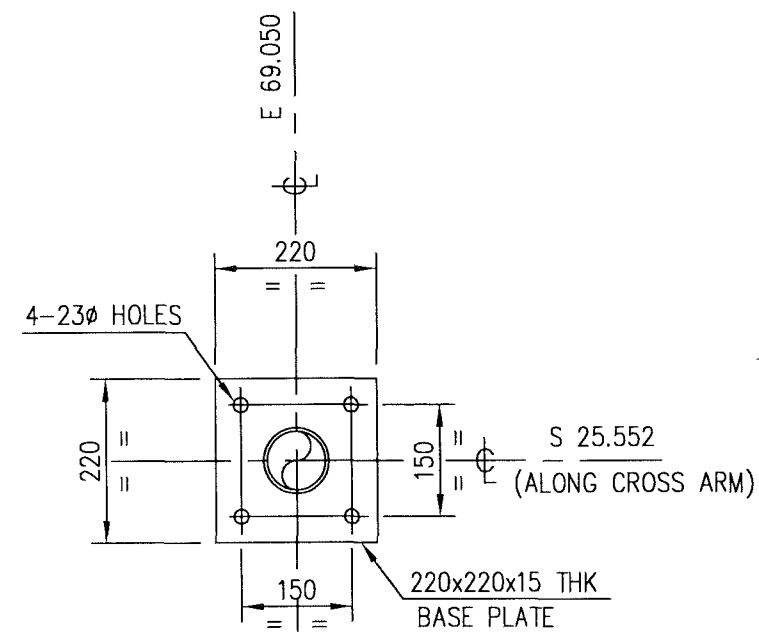

SECTION B-B

APPROVED FOR CONSTRUCTION

ELEVATION
(SCALE 1:10)



CONTRACT NO.: C31/0606 PROJ. NO.: PAIP00405

REV	DATE	DRAWN BY	CHECKED	DESCRIPTION	WBS No.	PROJ. ENG.	SIGNATURE
A	27.02.11	GCS	DR	APPROVED FOR CONSTRUCTION	IN.09.011	OSE/28N	
O	26.02.11	JRP	KBR	ISSUED FOR COMMENTS	IN.09.011	OSE/28N	

PROJECT DRAWING REVISION
IN CASE OF DEVIATIONS A MARKED UP PRINT SHALL BE SENT TO THE PROJECT ENGINEER

- ALL DIMENSIONS ARE IN MILLIMETRES.
- ALL ELEVATIONS & CO-ORDINATES ARE IN METRES.
- ALL STEEL WORK TO BS EN 10025 GRADE S275 JR
- PIPE SECTION TO API 5L GR B.
- ALL CONNECTIONS TO BE MADE USING 5mm CFW.
- ALL STEEL WORK TO RECEIVE CORROSION PROTECTION IN ACCORDANCE WITH DOCUMENT No. SP-1246-2


NOTES

DESCRIPTION	AREA	S	SERIAL	SH.	P	S
FOUNDATION DETAILS	NIM	2	1842	030	DQ	3


REFERENCE DRAWINGS

AREA : NIMR
SUB AREA : NIMR SLUDGE PIT SYSTEMS
DRWG. TYPE : PIPE SUPPORTS
DESCRIPTION : PS-041

DRWG	AREA CODE	ENG SECT	SERIAL NUMBER	SHEET	PROJ CODE	DWG SIZE	REV.
NO	NIM	2	1842	059	DQ	3	A

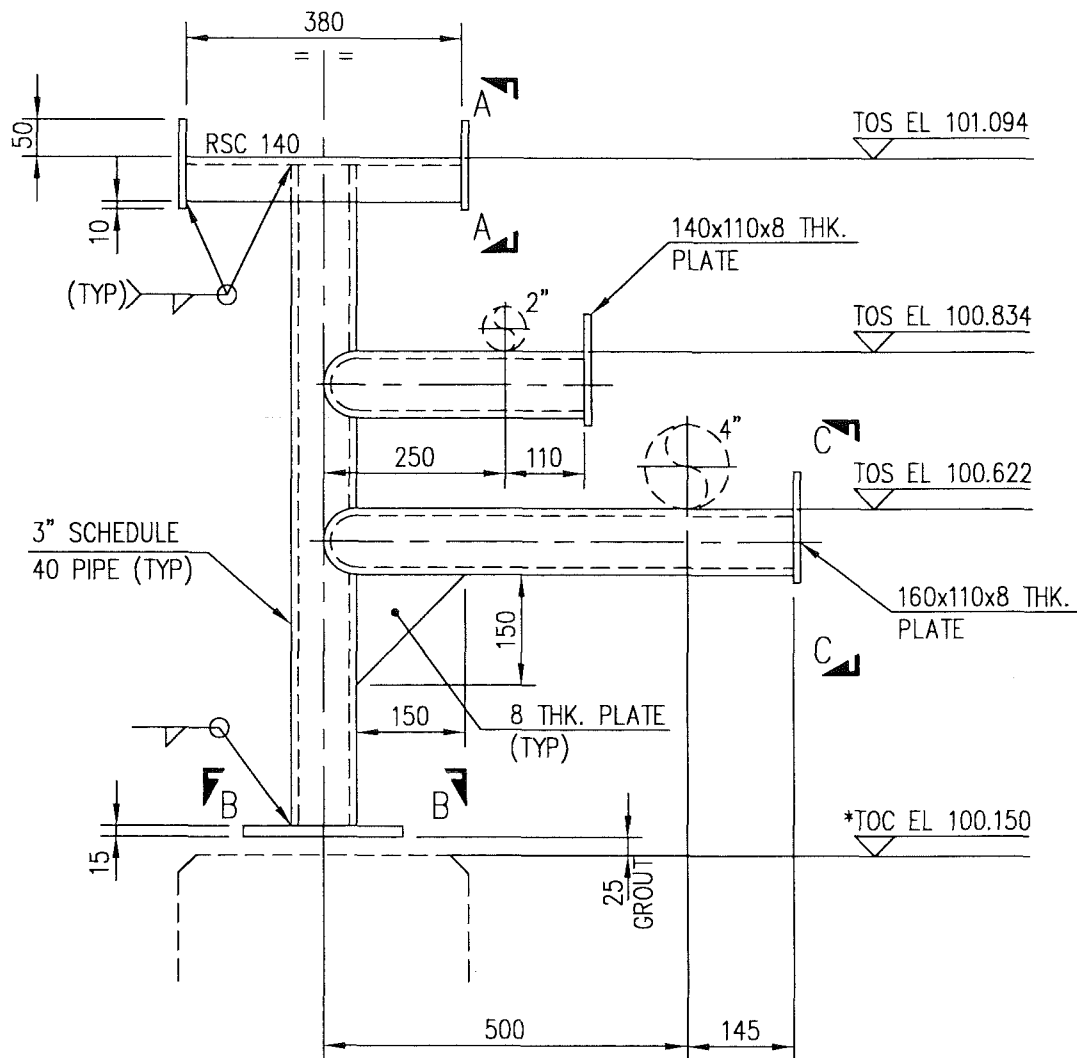


ELEVATION

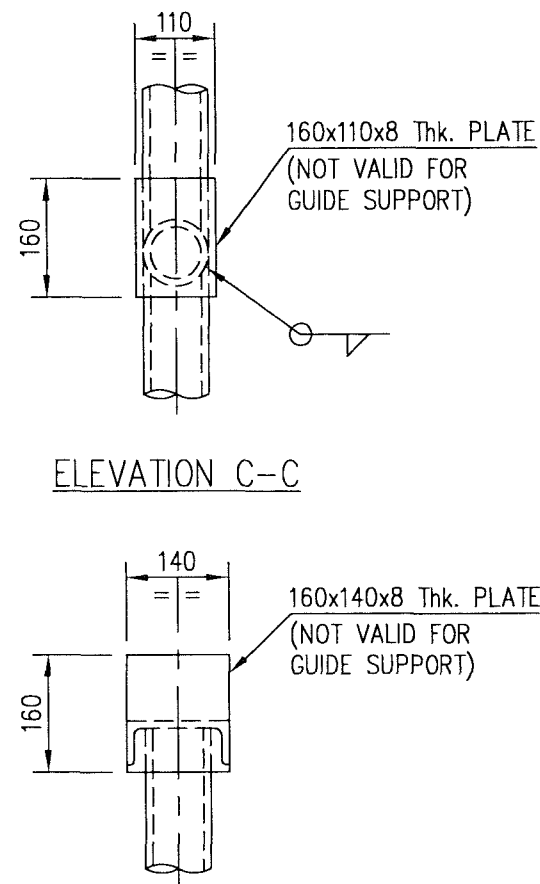

ELEVATION C-C

ELEVATION A-A

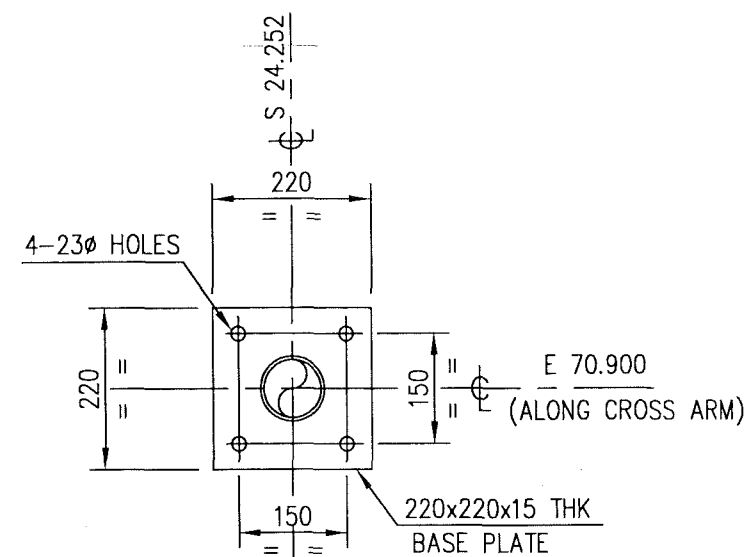

SECTION B-B

(c. Munn
-A2

M T O			
DESCRIPTION	QUANTITY	UNITS	SAP No.
3" SCHEDULE 40 PIPE	1.95	m	1000051540
RSC 140	0.38	m	1000080366
15 THK PLATE	0.05	m ²	1000080265
8 THK PLATE	0.08	m ²	1000062607

NOTE: * DENOTES, SINCE GRADE ELEVATION VARIES, CONTRACTOR TO VERIFY ELEVATIONS AND DIMENSIONS AT SITE, PRIOR TO FABRICATION/CONSTRUCTION/INSTALLATION.

APPROVED FOR
CONSTRUCTION



CONTRACT NO.: C31/0606 PROJ. NO.: PAIP00405

REV	DATE	DRAWN BY	TEAM L	J. ENG.	CHECKED	DESCRIPTION	WBS No.	PROJ. ENG.	SIGNATURE
A	27.02.11	GCS	BB	Y		APPROVED FOR CONSTRUCTION	IN.09.011	OSE/28N	
O	26.02.11	JRP	KBR	GSB		ISSUED FOR COMMENTS	IN.09.011	OSE/28N	
P D O APPROVAL									

PROJECT DRAWING REVISION

IN CASE OF DEVIATIONS A MARKED UP PRINT SHALL BE SENT TO THE PROJECT ENGINEER

- ALL DIMENSIONS ARE IN MILLIMETRES.
- ALL ELEVATIONS & CO-ORDINATES ARE IN METRES.
- ALL STEEL WORK TO BS EN 10025 GRADE S275 JR
- PIPE SECTION TO API 5L GR B.
- ALL CONNECTIONS TO BE MADE USING 5mm CFW.
- ALL STEEL WORK TO RECEIVE CORROSION PROTECTION IN ACCORDANCE WITH DOCUMENT No. SP-1246-2

NOTES

FOUNDATION DETAILS

NIM 2 1842 030 DQ 3

AREA : NIMR

SUB AREA : NIMR SLUDGE PIT SYSTEMS No. 16

DRWG. TYPE : PIPE SUPPORTS

DESCRIPTION : PS-042

SCALE : 1:20 CAD DRAWING

0 1 2 3 4 5 6 7



شركة تنمية نفط عُمان
Petrochem Development Oman

DRWG	AREA CODE	ENG SECT	SERIAL NUMBER	SHEET	PROJ CODE	DWG SIZE	REV.
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NO	NIM	2	1842	060	DQ	3	A
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NOTE: ✱ DENOTES, SINCE GRADE ELEVATION VARIES, CONTRACTOR TO VERIFY ELEVATIONS AND DIMENSIONS AT SITE, PRIOR TO FABRICATION/CONSTRUCTION/INSTALLATION.



1c. Mures
TA2


APPROVED FOR
CONSTRUCTION

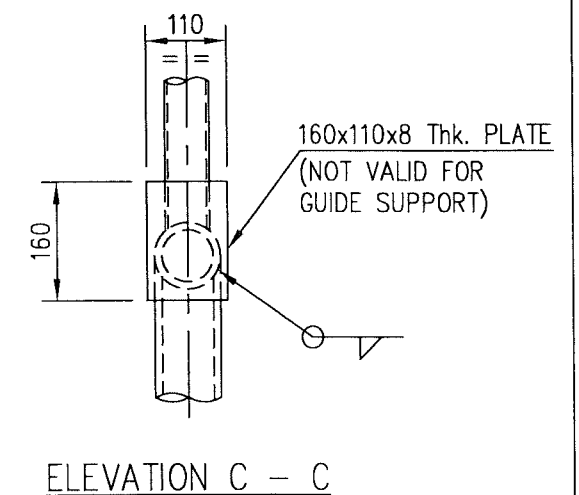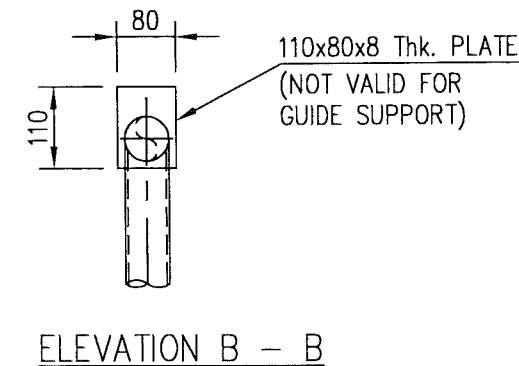
	A	27.02.11	GCS	R.B.	J.P.	APPROVED FOR CONSTRUCTION	IN.09.011	OSE/28N	
	O	26.02.11	JRP	KBR	GSB	ISSUED FOR COMMENTS	IN.09.011	OSE/28N	
U	REV	DATE	DRAWN BY	TEAML.	J.ENG.	DESCRIPTION	WBS No.	PROJ. ENG.	SIGNATURE
			CHECKED					P D O APPROVAL	

 **ورلي بارسونز - الصناعات العربية (مخاصة)**
WorleyParsons - Arabian Industries (JV)

CONTRACT NO. : C31/0606	PROJ. NO. : PAIP00405
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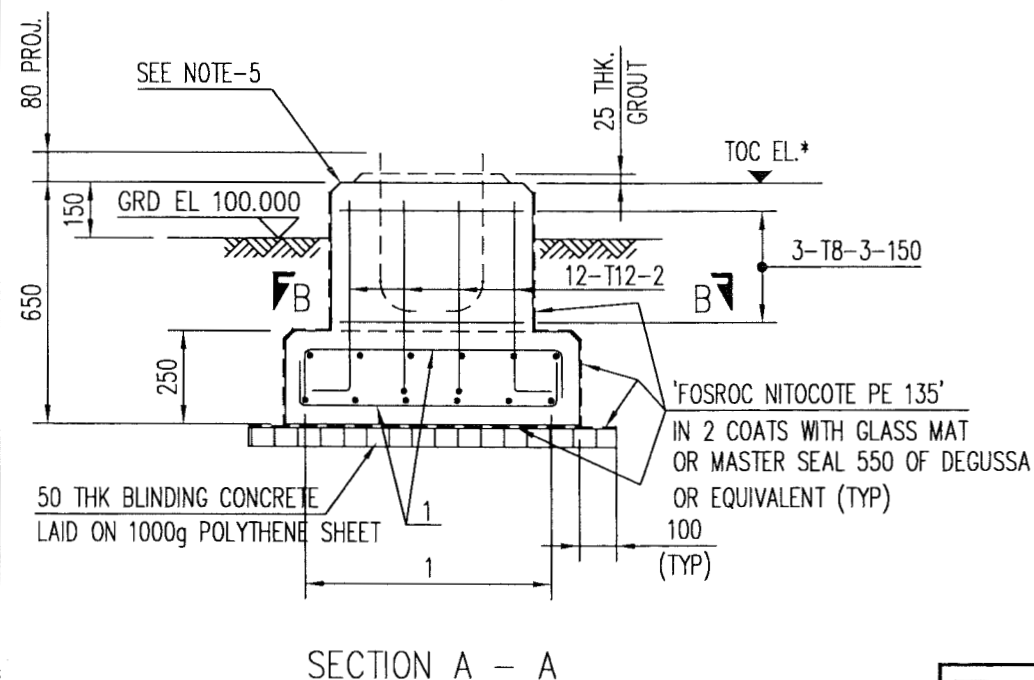
PROJECT DRAWING REVISION	
IN CASE OF DEVIATIONS A MARKED UP PRINT SHALL BE SENT TO THE PROJECT ENGINEER	

1. ALL DIMENSIONS ARE IN MILLIMETRES. 2. ALL ELEVATIONS & CO-ORDINATES ARE IN METRES. 3. ALL STEEL WORK TO BS EN 10025 GRADE S275 JR 4. PIPE SECTION TO API 5L GR B. 5. ALL CONNECTIONS TO BE MADE USING 5mm CFW. 6. ALL STEEL WORK TO RECEIVE CORROSION PROTECTION IN ACCORDANCE WITH DOCUMENT No. SP-1246-2	FOUNDATION DETAILS	NIM	2	1842	030	DQ	3	AREA : NIMR	SUB AREA : NIMR SLUDGE PIT SYSTEMS	No. 16	<div>SCALE : 1:20 0 1 2 3 4 5 6 7</div> <div><div>شركة تنمية نفط عُمان Petroileum Development Oman</div></div>						
	DESCRIPTION	AREA	S	SERIAL	SH.	P	S	DRWG. TYPE : PIPE SUPPORTS	DESCRIPTION : PS-043	DRWG	AREA CODE	ENG SECT	SERIAL NUMBER	SHEET	PROJ CODE	DWG SIZE	REV.
	DRAWING NUMBER																
NOTES	REFERENCE DRAWINGS							NO	NIM	2	1842	061	DQ	3	A		

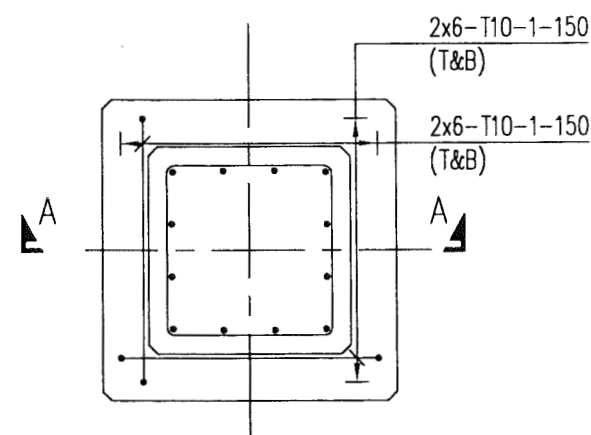

REINFORCEMENT PLAN

PLAN
(2 Nos. REQ'D)



SECTION B - B

[THIS DRAWING IS BASED ON P.D.O. DRG. No.
STD-2-3902-001-A3-D - TYPE 902]

1. ALL DIMENSIONS ARE IN MILLIMETRES AND ELEVATIONS IN METRES.
2. CONCRETE TO BS 8110, GRADE 35 FOR REINFORCED CONCRETE, GRADE 10 FOR BLINDING CONCRETE USING OPC.
3. 50mm COVER TO REINFORCEMENT, REINFORCEMENT TO BS 4449.
4. ALL EDGES SHALL HAVE A CHAMFER OF APPROX. 25mm.
5. ALL EXPOSED CONCRETE SURFACES SHALL BE TREATED WITH TWO COATS OF "FOSROC DEKGUARD S" WITH A DFT OF 350 MICRONS OR ANY OTHER APPROVED EQUIVALENT.
6. FOUNDATION BOLTS REFER DRG. No. STD-2-3950-001-A3
7. FOR BAR BENDING SCHEDULE REFER DRG. No. NIM-2-1842-063-DQ-4

NOTES/REFERENCE DRAWINGS

[illegible]

NOTE: * DENOTES, SINCE GRADE ELEVATION VARIES, CONTRACTOR TO VERIFY ELEVATIONS AND DIMENSIONS AT SITE, PRIOR TO FABRICATION/CONSTRUCTION/INSTALLATION.

M T O			
DESCRIPTION	QUANTITY	UNITS	SAP No.
BLINDING CONCRETE GRADE 10	0.10	m ³	N.A.
CONCRETE GRADE 35	0.56	m ³	N.A.
CEMENT SAND GROUT	10.52	lit	N.A.
REINFORCEMENT STEEL	47.76	Kg	N.A.
PROTECTIVE COATING	6.04	m ²	N.A.
20Ø FOUNDATION BOLT TYPE – J5	8	PCS	N.A.
1000g POLYTHENE SHEET	2.00	m ²	N.A.


16. Mm m
742

APPROVED FOR
CONSTRUCTION

A	27.02.11	GCS	PR	J.	APPROVED FOR CONSTRUCTION	IN.09.011	OSE/28N	
O	26.02.11	GCS	KBR	GSB	ISSUED FOR COMMENTS	IN.09.011	OSE/28N	
REV	DATE	DRAWN BY	TEAM L.	J. ENG.	DESCRIPTION	WBS No.	PROJ. ENG.	SIGNATURE
			CHECKED					P D O APPROVAL

PROJECT DRAWING REVISION	
NO.	DESCRIPTION
1	1.00
2	2.00
3	3.00
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93	93.00
94	94.00
95	95.00
96	96.00
97	97.00
98	98.00
99	99.00
100	100.00

IN CASE OF DEVIATIONS A MARKED UP PRINT SHALL BE SENT TO THE PROJECT ENGINEER

AREA : NIMR		SCALE : 1:20		CAD DRAWING			
SUB AREA : NIMR SLUDGE PIT SYSTEMS		NO. 16					
				شركة تنمية نفط عُمان Petro Development Oman			
DRWG. TYPE : PIPE SUPPORTS—FOUNDATION DETAILS							
DESCRIPTION : PS-001 & 002							

BAR BENDING SCHEDULE

JOB NO.: PAIP00405
PART ID.: NIMR SLUDGE PIT SYSTEM UPGRADE
 PS-001 & 002

Document No.: NIM-2-1842-063-DQ-4

Revision No.: A

Prepared by: GCS

Checked by: PNG

Date: 27.02.11

REF. DWG NO.: NIM-2-1842-062-DQ-3

Total MTO for Rebars.

Dia. Of Bar	T6	T8	T10	T12	T16	T20	T25	T32
Length of Bar (m)		11.85	44.40	17.40				
Weight (Kgs)		4.74	27.53	15.49				

Total Weight (Kgs)

47 760

[illegible]

1c. Name _____
- A2


This schedule complies with BS 8666 : 2005

All dimensions are in mm

Refer to Bar shape Code drawing

* Specified in multiples of 5 mm

† Specified in multiples of 25 mm

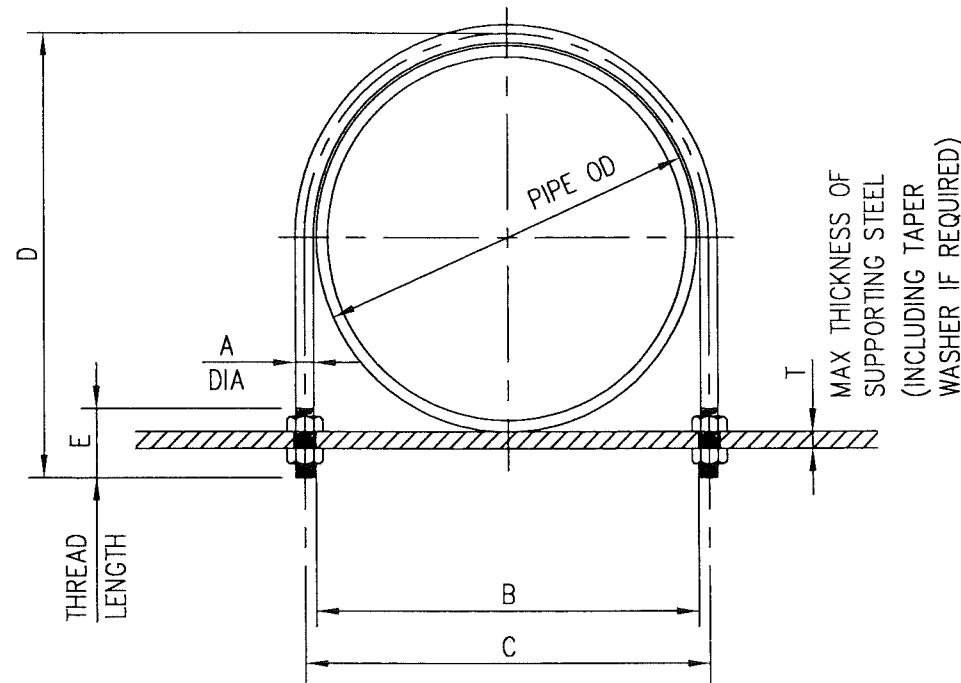

ELEVATION


MATERIAL GUIDE

BAR		NUTS	
SIZE	SAP No.	SIZE	SAP No.
8	1000080335	M8	1000063795
10	1000062586	M10	1000063796
16	1000062588	M16	1000063798
20	N.A.	M20	1000063799
24	N.A.	M24	1000120055

[THIS DRAWING IS BASED ON P.D.O. DRG. No. STD-2-3818-001-A3-D - TYPE 818]

- ALL DIMENSIONS ARE IN MILLIMETRES.
- EACH BOLT TO BE SUPPLIED WITH 2 NUTS & 2 LOCKNUTS.
- MATERIAL-BOLTS TO BS EN 10025 GR S275 JR NUTS TO ISO 898/11 GR 8
- U-BOLT CORROSION PROTECTION SHALL COMPLY WITH SP-1246-2

NOTES

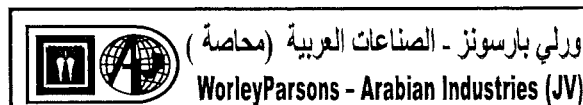

CONTRACT NO. : C31/0606 PROJ. NO. : PAIP00405

DESCRIPTION

DRAWING NUMBER


REFERENCE DRAWINGS


PIPE GUIDE DESIGNATION	NOMINAL PIPE SIZE		PIPE OD	DIMENSIONS						Nos. REQD.
	INCHES	MM		A	B	C	D	E	T	
UB-0.5	1/2"	15	21.3	8	32	40	45	30	10	-
UB-0.75	3/4"	20	26.7	8	37	45	55	35	10	-
UB-1	1"	25	33.4	8	42	50	60	35	10	-
UB-1.5	1 1/2"	40	48.3	10	55	65	85	45	16	-
UB-2	2"	50	60.3	10	70	80	100	45	16	7
UB-3	3"	80	88.9	16	94	110	140	60	19	2
UB-4	4"	100	114.3	16	124	140	165	60	19	3
UB-6	6"	150	168.3	20	175	195	225	70	19	-
UB-8	8"	200	219.1	20	230	250	275	70	19	-
UB-10	10"	250	273.0	20	285	305	335	75	22	-
UB-12	12"	300	323.9	20	335	355	385	75	22	-
UB-14	14"	350	355.6	24	366	390	425	80	22	-
UB-16	16"	400	406.4	24	416	440	475	80	22	-
UB-18	18"	450	457.0	24	471	495	525	80	22	-
UB-20	20"	500	508.0	24	521	545	575	80	22	-
UB-24	24"	600	610.0	24	621	645	675	80	22	-
UB-28	28"	700	711.2	24	721	745	775	80	22	-
UB-30	30"	750	762.0	24	771	795	825	80	22	-

APPROVED FOR CONSTRUCTION

REV	DATE	DRAWN BY	TEAM	J.ENG.	DESCRIPTION	WBS No.	PROJ. ENG.	SIGNATURE
A	27.02.11	GCS	RS	✓	APPROVED FOR CONSTRUCTION	IN.09.011	OSE/28N	
O	26.02.11	GCS	KBR	GSB	ISSUED FOR COMMENTS	IN.09.011	OSE/28N	
					CHECKED		P D O APPROVAL	

PROJECT DRAWING REVISION
IN CASE OF DEVIATIONS A MARKED UP PRINT SHALL BE SENT TO THE PROJECT ENGINEER

AREA : NIMR		SCALE : — 0 1 2 3 4 5 6 7		CAD DRAWING			
SUB AREA : NIMR SLUDGE PIT SYSTEMS		No. 16		<div><div>شركة تنمية نفط عُمان Petroleum Development Oman</div></div>			
DRWG. TYPE : PIPE SUPPORTS							
DESCRIPTION : 'U' BOLT (PIPE NOT GRIPPED) DETAILS							
NO		NIM 2 1842 064 DQ		3		A	

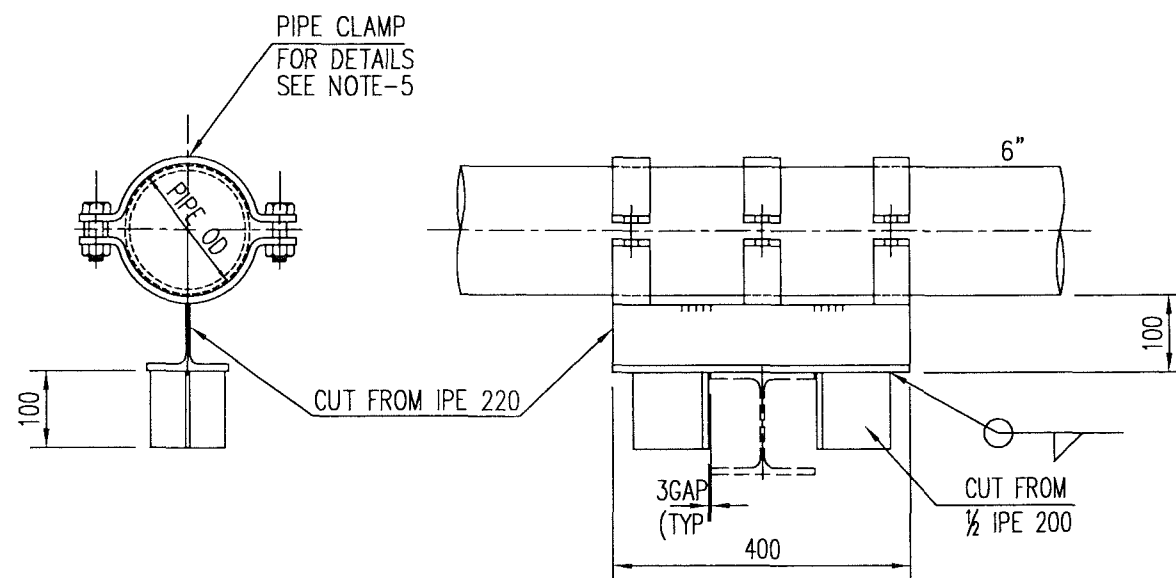

PS-002, 008, 013 & 036


SUPPORT NUMBER	REFERENCE DRAWING	PIPE SIZE	NUMBER REQD.
PS-002	NIM-3-2142-001-DQ-1	6"	1
PS-008	NIM-3-2141-001-DQ-1		
PS-013	NIM-3-2141-001-DQ-1		
PS-036	NIM-3-2140-001-DQ-1		

M T O			
DESCRIPTION	QUANTITY	UNITS	SAP No.
IPE 220	1.6	m	1000165322
IPE 200	0.80	m	1000080437
HE 300 B	-	m	1000062639
10THK. PLATE	-	m ²	1000062608

10. Number
7A2

APPROVED FOR
CONSTRUCTION

REV	DATE	DRAWN BY	TEAM L	J. ENG.	CHECKED	DESCRIPTION	WBS No.	PROJ. ENG.	SIGNATURE
A	27.02.11	GCS	RE	RE		APPROVED FOR CONSTRUCTION	IN.09.011	OSE/28N	
O	26.02.11	GCS	KBR	GSB		ISSUED FOR COMMENTS	IN.09.011	OSE/28N	
P D O APPROVAL									

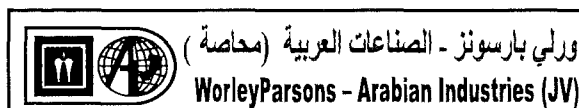

CONTRACT NO.: C31/0606 PROJ. NO.: PAIP00405

1. ALL DIMENSIONS ARE IN MILLIMETRES EXCEPT PIPE SIZE.
2. ALL STEEL WORK TO BS EN 10025 GRADE S275 JR.
3. ALL WELDS TO BE 6mm NON PENETRATING CFW NO HOLES IN LINE PIPE.
4. ALL STEEL WORK TO RECEIVE CORROSION PROTECTION IN ACCORDANCE WITH DOCUMENT No. SP-1246-2
5. REFER STD-2-3812-001 FOR PIPE CLAMP TYPE-812

DESCRIPTION	AREA	S	SERIAL	SH.	P	S
PIPE SUPPORTS-INDEX SHEET	NIM	2	1842	028	DQ	3
PIPE CLAMP DETAIL	NIM	2	2184	071	DQ	3

NOTES



REFERENCE DRAWINGS

PROJECT DRAWING REVISION
IN CASE OF DEVIATIONS A MARKED UP PRINT SHALL BE SENT TO THE PROJECT ENGINEER

AREA	SUB AREA	DRWG. TYPE	DESCRIPTION	SCALE	CAD DRAWING
: NIMR	: NIMR SLUDGE PIT SYSTEMS	: PIPE SUPPORTS -	: PIPE CLAMP WITH SHOE AND LINE STOP DETAILS	0 1 2 3 4 5 6 7	NTS



DRWG	AREA CODE	ENG SECT	SERIAL NUMBER	SHEET	PROJ CODE	DWG SIZE	REV.
NO	NIM	2	1842	065	DQ	3	A

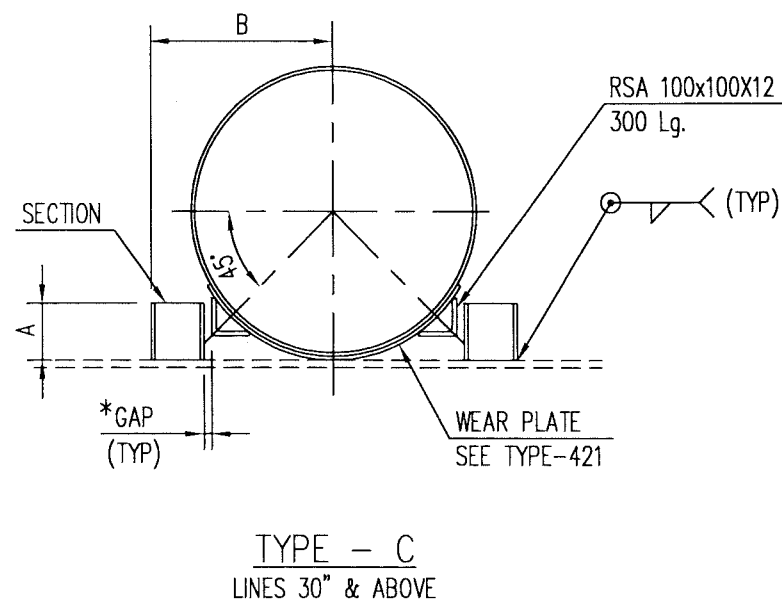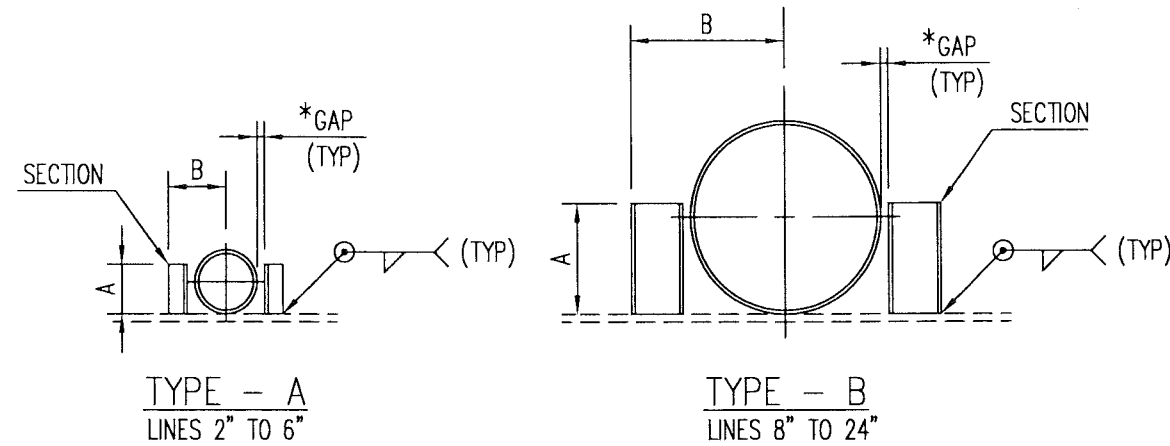

* - GAP SHALL BE AS PER PIPING GA.
IF NOT SPECIFIED IT SHALL BE 2mm

FOR LOCATION REFER PIPING GA.

PIPE GUIDE DESIGNATION	NOMINAL PIPE SIZE		PIPE OD	DIMENSIONS		SECTION	Nos. REQD.
	INCHES	MM		A	B		
PG-2	2"	50	60.3	55	82	RSA 50x50x6	6
PG-3	3"	80	88.9	80	97	RSA 50x50x6	-
PG-4	4"	100	114.3	80	110	RSA 50x50x6	3
PG-6	6"	150	168.3	110	137	RSA 50x50x6	5
PG-8	8"	200	219.1	160	212	RSC 100	-
PG-10	10"	250	273.0	160	239	RSC 100	-
PG-12	12"	300	323.9	230	264	RSC 100	-
PG-14	14"	350	355.6	230	280	RSC 100	-
PG-16	16"	400	406.4	230	306	RSC 100	-
PG-18	18"	450	457.0	260	371	RSC 140	-
PG-20	20"	500	508.0	290	396	RSC 140	-
PG-24	24"	600	610.0	340	447	RSC 140	-
PG-30	30"	750	762.0	150	464	RSC 140	-

M T O			
DESCRIPTION	QUANTITY	UNITS	SAP No.
RSC 140	-	m	1000080366
RSC 100	-	m	1000145612
RSA 100x100x12	-	m	1000142036
RSA 50x50x6	2.20	m	1000062629

APPROVED FOR
CONSTRUCTION

[THIS DRAWING IS BASED ON P.D.O. DRG. No.
STD-2-3604-001-A3-C - TYPE 604]

- ALL DIMENSIONS ARE IN MILLIMETRES EXCEPT PIPE SIZE
- ALL STEEL WORK EXCEPT REINFORCING PLATE TO TO BS EN 10025 GR S275 JR
- ALL CONNECTIONS TO BE MADE USING 6mm CFW.
- STEELWORK CORROSION PROTECTION SHALL COMPLY WITH SP-1246-2


NOTES



CONTRACT NO.: C31/0606 PROJ. NO.: PAIP00405


REV	DATE	DRAWN BY	CHECKED	DESCRIPTION	WBS No.	PROJ. ENG.	SIGNATURE
A	27.02.11	GCS	RE	APPROVED FOR CONSTRUCTION	IN.09.011	OSE/28N	
O	26.02.11	GCS	KBR	ISSUED FOR COMMENTS	IN.09.011	OSE/28N	

PROJECT DRAWING REVISION
IN CASE OF DEVIATIONS A MARKED UP PRINT SHALL BE SENT TO THE PROJECT ENGINEER

AREA : NIMR		SCALE : NTS		CAD DRAWING					
		0 1 2 3 4 5 6 7							
SUB AREA : NIMR SLUDGE PIT SYSTEMS		NO. 16		 <div>شركة تنمية نفط عُمان</div> <div>Petroleum Development Oman</div>					
DRWG. TYPE : PIPE SUPPORTS									
DESCRIPTION : PIPE GUIDE DETAILS		DRWG	AREA CODE	ENG SECT	SERIAL NUMBER	SHEET	PROJ CODE	DWG SIZE	REV.
		NO	NIM	2	1842 066 DQ	3	A		

DESCRIPTION	AREA	S	SERIAL	SH.	P	S
DRAWING NUMBER						


REFERENCE DRAWINGS

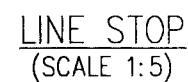[illegible]

M T O			
DESCRIPTION	QUANTITY	UNITS	SAP No.
IPE 200	0.40	m	1000080437
HE 220 A		m	1000165618
HE 300 A		m	1000165651
10Thk. PLATE		m ²	1000062608
			<i>K. Munn</i>



APPROVED FOR
CONSTRUCTION


	A	27.02.11	GCS			APPROVED FOR CONSTRUCTION	IN.09.011	OSE/28N	
	O	26.02.11	GCS	KBR	GSB	ISSUED FOR COMMENTS	IN.09.011	OSE/28N	
	REV	DATE	DRAWN BY	TEAM L.	J. ENG.	DESCRIPTION	WBS No.	PROJ. ENG.	SIGNATURE
				CHECKED				P D O APPROVAL	


 (محاصة) **وورلي بارسونز - الصناعات العربية**
WorleyParsons - Arabian Industries (JV)
 CONTRACT NO.: **C31/0606** PROJ. NO.: **PAIP00405**

1. ALL DIMENSIONS ARE IN MILLIMETRES EXCEPT PIPE SIZE.
2. ALL ELEVATIONS & CO-ORDINATES ARE IN METRES.
3. ALL STEEL WORK TO BS EN 10025 GRADE S275 JR.
4. ALL WELDS 6mm CFW. UNLESS NOTED
5. ALL THESE SHOE DETAILS ARE APPLICABLE ONLY FOR THICK WALLED PIPES. FOR THIN WALLED PIPES USE EITHER TYPES 417 & 424 OR DESIGN A FULL SLEEVE WITH A BACKING STRIP TO AVOID LONGITUDINAL WELDING DIRECTLY ON PIPES.
6. STEELWORK CORROSION PROTECTION SHALL COMPLY WITH SP-1246-2

DESCRIPTION	AREA	S	SERIAL	SH.	P	S
	DRAWING NUMBER					

PROJECT DRAWING REVISION													
IN CASE OF DEVIATIONS A MARKED UP PRINT SHALL BE SENT TO THE PROJECT ENGINEER													
AREA : NIMR						SCALE : NTS 0 1 2 3 4 5 6 7 							
SUB AREA : NIMR SLUDGE PIT SYSTEMS					NO. 16	 شركة تنمية نفط عُمان Petrochemical Development Oman							
DRWG.TYPE : PIPE SUPPORTS						DRWG	AREA CODE	ENG SECT	SERIAL NUMBER	SHEET	PROJ CODE	DWG SIZE	REV
DESCRIPTION : LINE STOP DETAILS FOR PS-038 & 046						NO	NIM 2 1842 067 DQ				3	A	

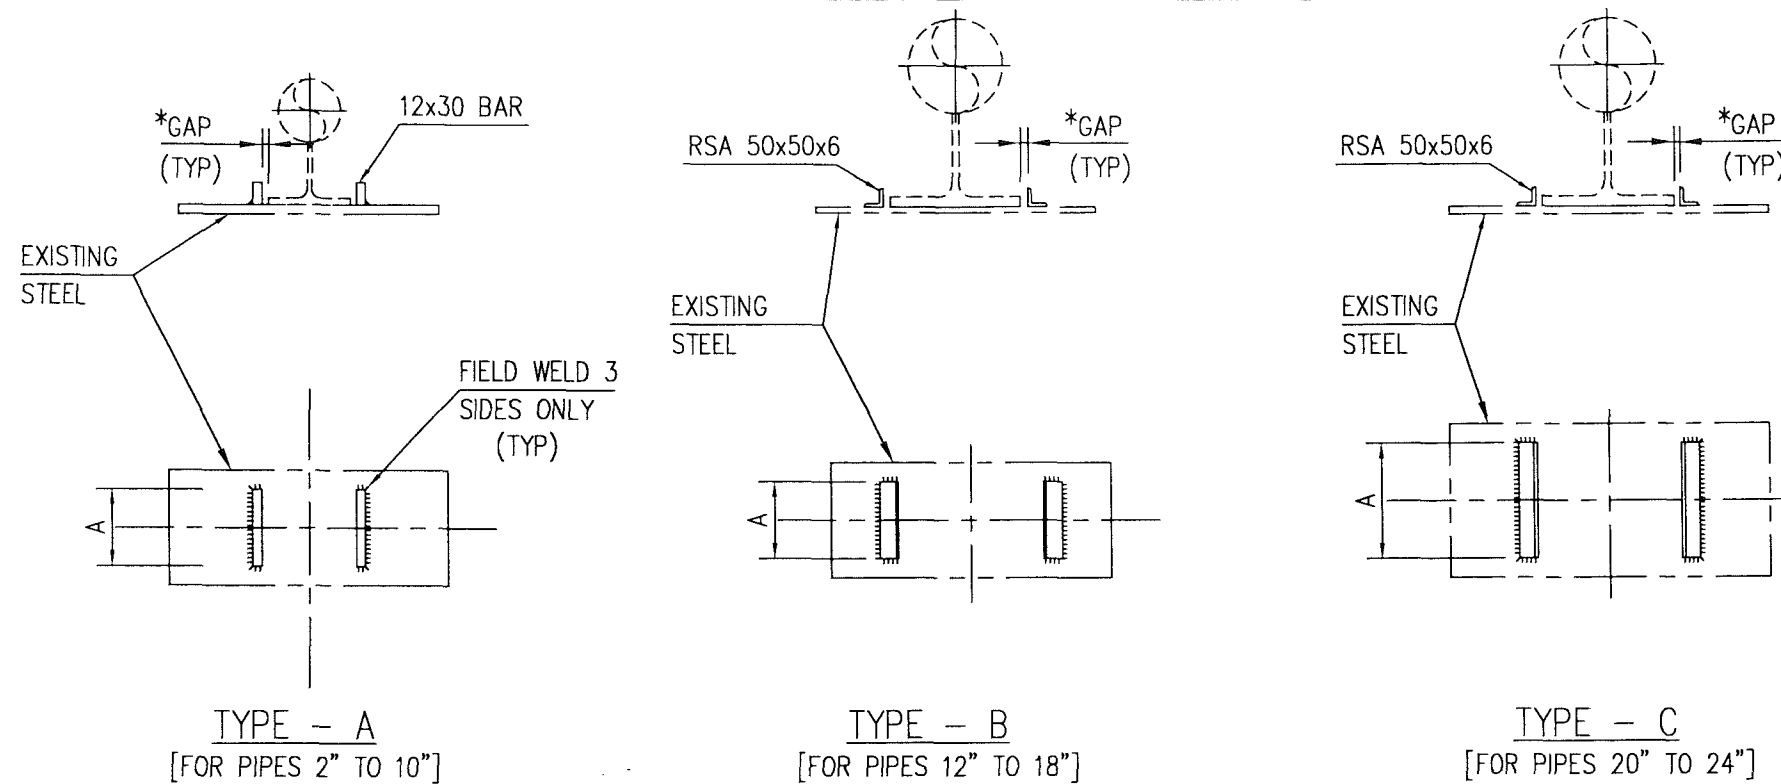


PIPE SIZE	MARK No.	TYPE	DIMENSION	Nos REQ'D
			A	
2"	SG-2	A	75	1
3"	SG-3	A	75	-
4"	SG-4	A	100	1
6"	SG-6	A	100	-
8"	SG-8	A	150	-
10"	SG-10	A	150	-
12"	SG-12	B	200	-
14"	SG-14	B	200	-
16"	SG-16	B	250	-
18"	SG-18	B	250	-
20"	SG-20	C	300	-
24"	SG-24	C	300	-

* - GAP SHALL BE AS PER PIPING GA.
IF NOT SPECIFIED IT SHALL BE 2mm

FOR LOCATION REFER PIPING GA.
MARKING 'SG' REFERS TO GUIDE FOR PIPE
HAVING SHOE MARKED AS 'PG' IN PIPING GA

M T O			
DESCRIPTION	QUANTITY	UNITS	SAP No.
12x30 BAR	0.35	m	1000132250
RSA 50x50x6	-	m	1000062629

APPROVED FOR
CONSTRUCTION


ورلي بارسونز - الصناعات العربية (محصاة)
WorleyParsons - Arabian Industries (JV)
 CONTRACT NO. : C31/0606 PROJ. NO. : PAIP00405


REV	DATE	DRAWN BY	TEAML	J.ENG.	CHECKED	DESCRIPTION	WBS No.	PROJ. ENG.	SIGNATURE
A	27.02.11	GCS	PR	PR		APPROVED FOR CONSTRUCTION	IN.09.011	OSE/28N	
O	26.02.11	GCS	KBR	GSB		ISSUED FOR COMMENTS	IN.09.011	OSE/28N	

PROJECT DRAWING REVISION
IN CASE OF DEVIATIONS A MARKED UP PRINT SHALL BE SENT TO THE PROJECT ENGINEER


- ALL DIMENSIONS ARE IN MILLIMETRES.
- ALL STEEL WORK TO BS 4360 GRADE 43A.
- ALL CONNECTIONS TO BE MADE USING 6mm CFW.
- ALL STEEL WORK TO RECEIVE CORROSION PROTECTION IN ACCORDANCE WITH DOCUMENT No. SP-1246

DESCRIPTION	AREA	S	SERIAL	SH.	P	S
SHOE DETAIL	NIM	2	1842	068	DQ	3
DRAWING NUMBER						
REFERENCE DRAWINGS						


AREA	: NIMR
SUB AREA	: NIMR SLUDGE PIT SYSTEMS NO. 16
DRWG. TYPE	: PIPE SUPPORTS
DESCRIPTION	: PIPE SHOE GUIDE DETAILS

SCALE : NTS
 0 1 2 3 4 5 6 7

شركة تنمية نفط عُمان
Petroleum Development Oman

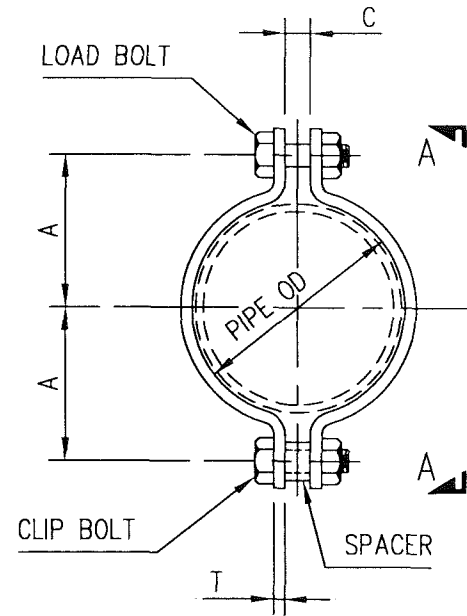DRWG	AREA CODE	ENG SECT	SERIAL NUMBER	SHEET	PROJ CODE	DWG SIZE	REV.
NO	NIM	2	1842	069	DQ	3	A

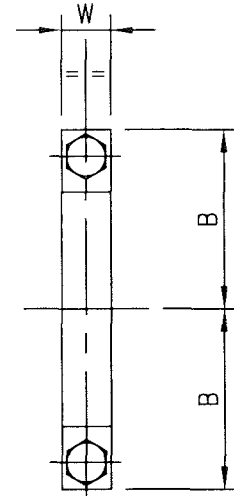

ELEVATION




VIEW A-A

PIPE GUIDE DESIGNATION	NOMINAL PIPE SIZE		PIPE OD	DIMENSIONS				BOLTS DIA x Lg.	Nos. REQD.
	INCHES	MM		A	B	C	W x T		
PC-0.5	1/2"	15	21.3	32	51	12	25 x 5	M12 x 45	-
PC-0.75	3/4"	20	26.7	32	51	12	25 x 5	M12 x 45	-
PC-1	1"	25	33.4	38	57	12	25 x 5	M12 x 45	-
PC-1.5	1 1/2"	40	48.3	50	70	16	40 x 6	M12 x 45	-
PC-2	2"	50	60.3	58	85	16	40 x 6	M12 x 45	-
PC-3	3"	80	88.9	85	110	20	40 x 6	M20 x 65	-
PC-4	4"	100	114.3	96	127	24	60 x 10	M24 x 75	-
PC-6	6"	150	168.3	135	175	28	65 x 12	M24 x 75	12
PC-8	8"	200	219.1	160	200	28	65 x 12	M24 x 75	-
PC-10	10"	250	273.0	200	235	34	65 x 15	M30 x 100	-
PC-12	12"	300	323.9	235	280	34	120 x 20	M30 x 100	-
PC-14	14"	350	355.6	255	305	40	120 x 20	M36 x 120	-
PC-16	16"	400	406.4	280	330	40	120 x 20	M36 x 120	-
PC-18	18"	450	457.0	305	360	40	120 x 20	M36 x 120	-
PC-20	20"	500	508.0	330	385	40	120 x 20	M36 x 120	-
PC-24	24"	600	610.0	395	445	40	120 x 20	M36 x 120	-
PC-30	30"	750	762.0	470	520	40	120 x 20	M36 x 120	-
PC-32	32"	800	812.8	500	550	40	120 x 20	M36 x 120	-
PC-36	36"	900	914.4	550	600	40	120 x 20	M36 x 120	-

MATERIAL GUIDE			
BOLTS		FLATS	
SIZE	SAP No.	SIZE	SAP No.
M12 x 45	1000062908	25 x 5	1000132190
M20 x 65	1000062911	40 x 6	1000080324
M24 x 75	1000099912	60 x 10	1000132245
M30 x 100	1000099927	65 x 12	1000132279
M30 x 120	1000099928	65 x 15	1000132316
M36 x 120	1000099948	120 x 20	1000132382

APPROVED FOR CONSTRUCTION

[THIS DRAWING IS BASED ON P.D.O. DRG. No. STD-2-3812-001-A3-D - TYPE 812]


ورلي بارسونز - الصناعات العربية (محصاة)
WorleyParsons - Arabian Industries (JV)
 CONTRACT NO.: C31/0606 PROJ. NO.: PAIP00405

REV	DATE	DRAWN BY	TEAM L	J. ENG.	CHECKED	DESCRIPTION	WBS No.	PROJ. ENG.	SIGNATURE
A	27.02.11	GCS	RS	GSB		APPROVED FOR CONSTRUCTION	IN.09.011	OSE/28N	
O	26.02.11	GCS	KBR	GSB		ISSUED FOR COMMENTS	IN.09.011	OSE/28N	


PROJECT DRAWING REVISION
IN CASE OF DEVIATIONS A MARKED UP PRINT SHALL BE SENT TO THE PROJECT ENGINEER

- ALL DIMENSIONS ARE IN MILLIMETRES.
- EACH CLAMP TO BE SUPPLIED COMPLETE WITH 2 BOLTS & NUTS AND 1 TUBULAR DISTANCE PIECE.
- MATERIAL-BAR TO BS EN 10025 GR S275 JR BOLTS TO ISO 898/1 GR4.6, NUTS TO ISO 898/2 GR4, CLAMP SPACER-CARBON STEEL
- PIPE CLIP CORROSION PROTECTION SHALL COMPLY WITH SP-1246-2


NOTES

REFERENCE DRAWINGS

AREA	: NIMR	
SUB AREA	: NIMR SLUDGE PIT SYSTEMS	
DRWG. TYPE	: PIPE SUPPORTS	
DESCRIPTION	: PIPE CLIP (HEAVY) DETAILS	

SCALE : NTS
 0 1 2 3 4 5 6 7

شركة تنمية نفط عُمان
 Petroleum Development Oman
 DRWG : AREA : ENG : SERIAL : SHEET : PROJ : DWG : REV.
 NO : NIM 2 1842 070 DQ 3 A

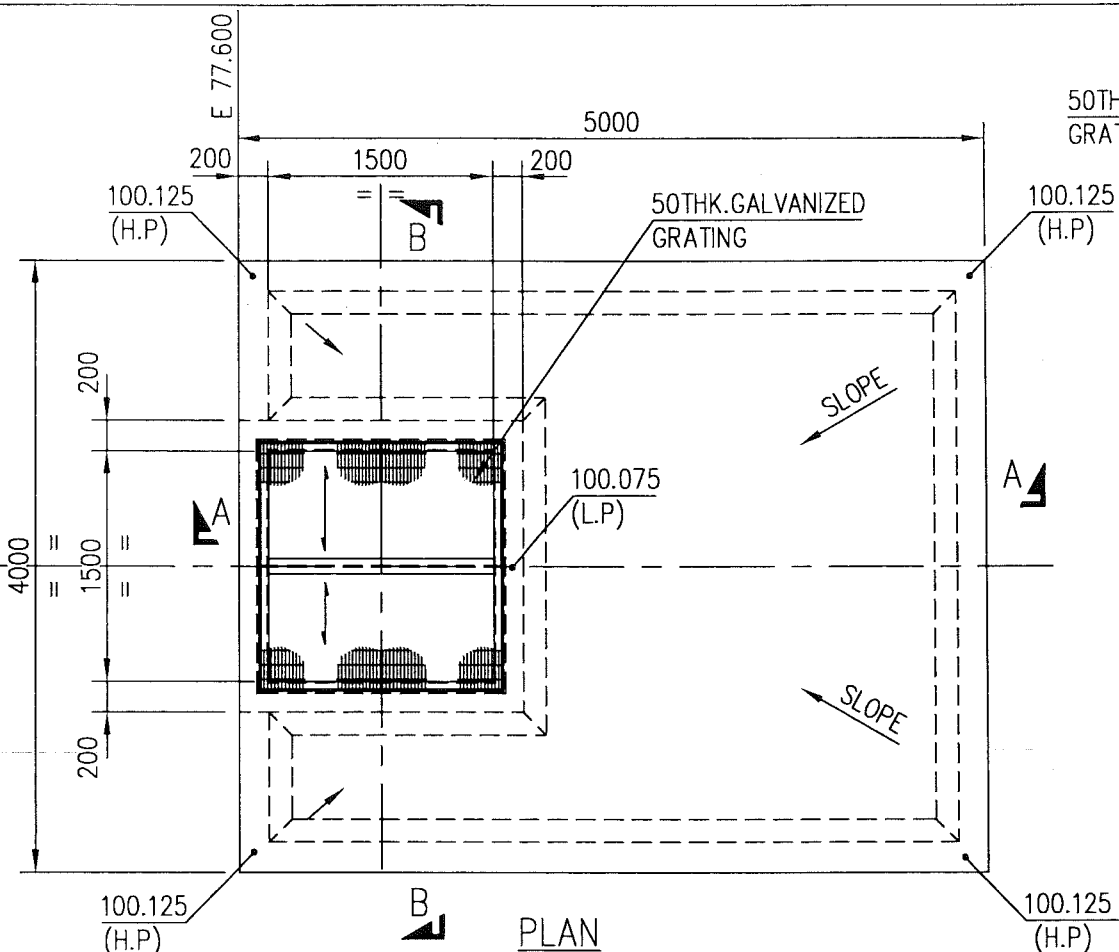PLANT NORTH


A-48305
PIG LAUNCHER
S 17.000
(HOLD)50THK.GALVANIZED
GRATING100.125
(H.P)

A


100.125
(H.P)

B

PLAN

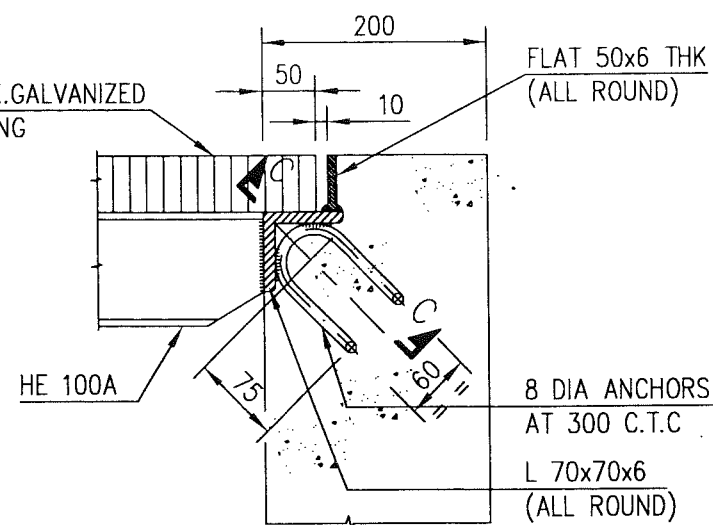


DETAIL-1

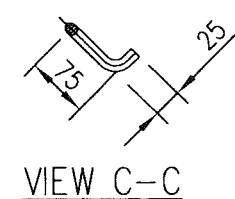FLAT 50x6 THK
(ALL ROUND)8 DIA ANCHORS
AT 300 C.T.C
L 70x70x6
(ALL ROUND)PANEL TO BE
FULLY BANDED

VIEW C-C


6mm TWISTED SQUARE
TRANSVERSE BARS WELDED
SLIGHTLY PROUD OF THE
MAIN BARS

DETAIL OF GRATING

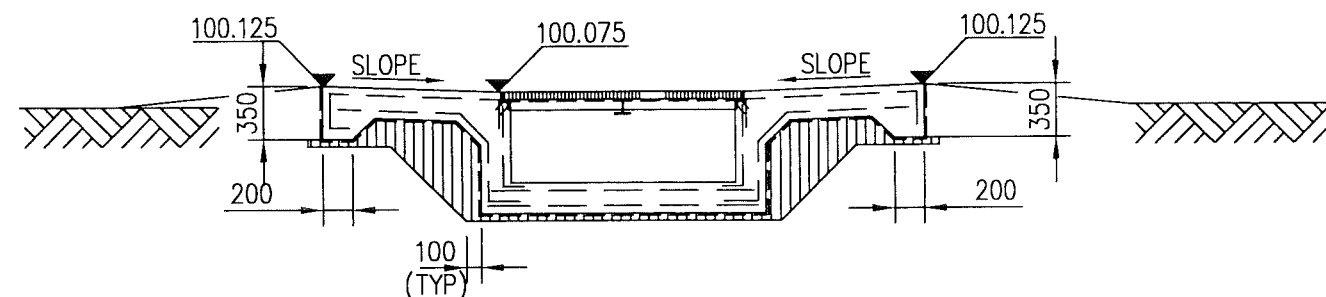

SECTION B-B

GRD EL 100.000

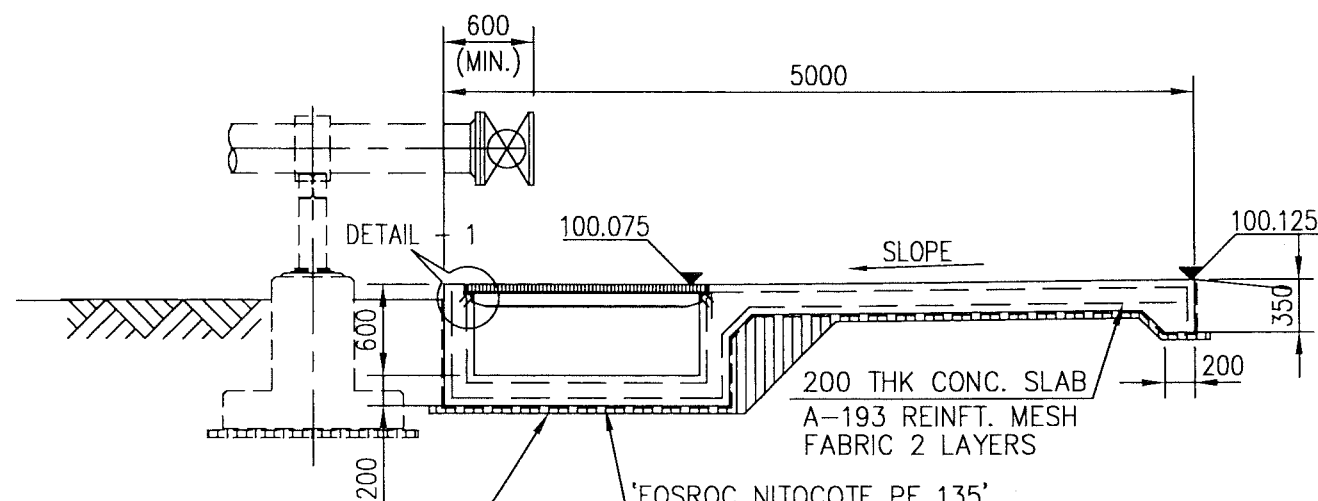

SECTION A-A

50 THK BLINDING
CONCRETE LAID ON
1000g POLYHTENE SHEET'FOSROC NITOCOTE PE 135'
IN 2 COATS WITH GLASS MAT
(TYP)200 THK CONC. SLAB
A-193 REINFT. MESH
FABRIC 2 LAYERSAPPROVED FOR
CONSTRUCTION

ورلي بارسونز - الصناعات العربية (محاصة)
WorleyParsons - Arabian Industries (JV)

CONTRACT NO.: C31/0606 PROJ. NO.: PAIP00405

4. FOUNDATION LOCATION PLAN

REF. DRG. NO. NIM-2-0992-001-DQ-1

3. GEN. NOTES, LEG. & ABBREVIATION (STEEL)

REF. DRG. No. NIM-2-1841-002-DQ-3

2. GEN. NOTES, LEGEND & ABBRE. (CONC)

REF. DRG. No. NIM-2-1841-001-DQ-3

1. ALL CO-ORDINATES, ELEVATION ARE IN
METERS AND ALL DIMENSIONS ARE IN mm.

NOTES/REFERENCE DRAWINGS

MASTER DRAWING REVISION
IN CASE OF DEVIATIONS MARKED UP PRINT SHALL BE SENT TO COASTAL DESIGN OFFICE

REV	DATE	DRAWN BY	CHECKED	DESCRIPTION	WBS No.	PROJ. ENG.	SIGNATURE
A	27.02.11	GCS	RB	APPROVED FOR CONSTRUCTION	IN.09.011	OSE/28N	
O	26.02.11	JRP	KBR	ISSUED FOR COMMENTS	IN.09.011	OSE/28N	

PROJECT DRAWING REVISION

IN CASE OF DEVIATIONS A MARKED UP PRINT SHALL BE SENT TO THE PROJECT ENGINEER

AREA : NIMR

SUB AREA : NIMR SLUDGE PIT SYSTEM UPGRADE No. 16

DRWG. TYPE : CIVIL DETAILS



DESCRIPTION : SPILL PIT AND HARD STRAND
FOR 8" PIG LAUNCHER

SCALE : 1:50 CAD DRAWING





شركة تنمية نفط عُمان
Petroleum Development Oman

DRWG	AREA CODE	ENG SECT	SERIAL NUMBER	SHEET	PROJ CODE	DWG SIZE	REV.
NO	NIM	2	1843	001	DQ	3	A

PARSONS File name: W:\2_CIVIL\C-310606(EMC)\PAIP\PAIP00405_DQ\LAUNCHER AREA\21843001_DQ.dwg-GCS-27/02/11-10:00:22

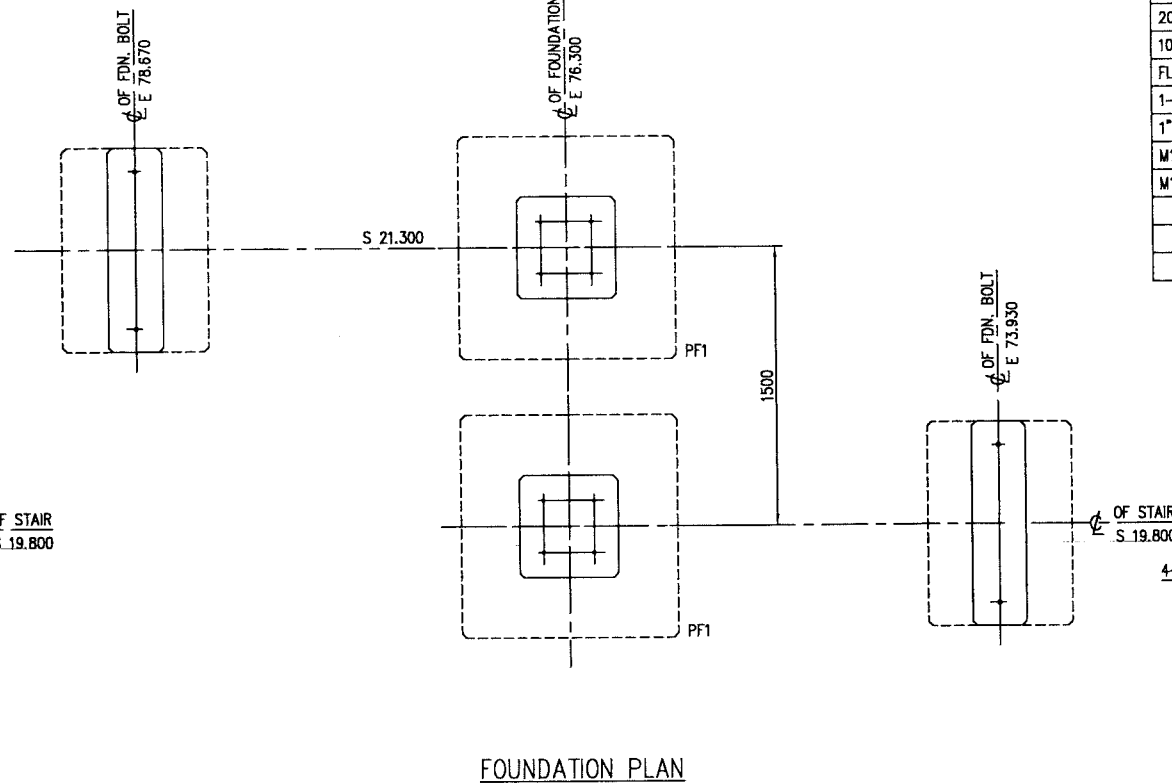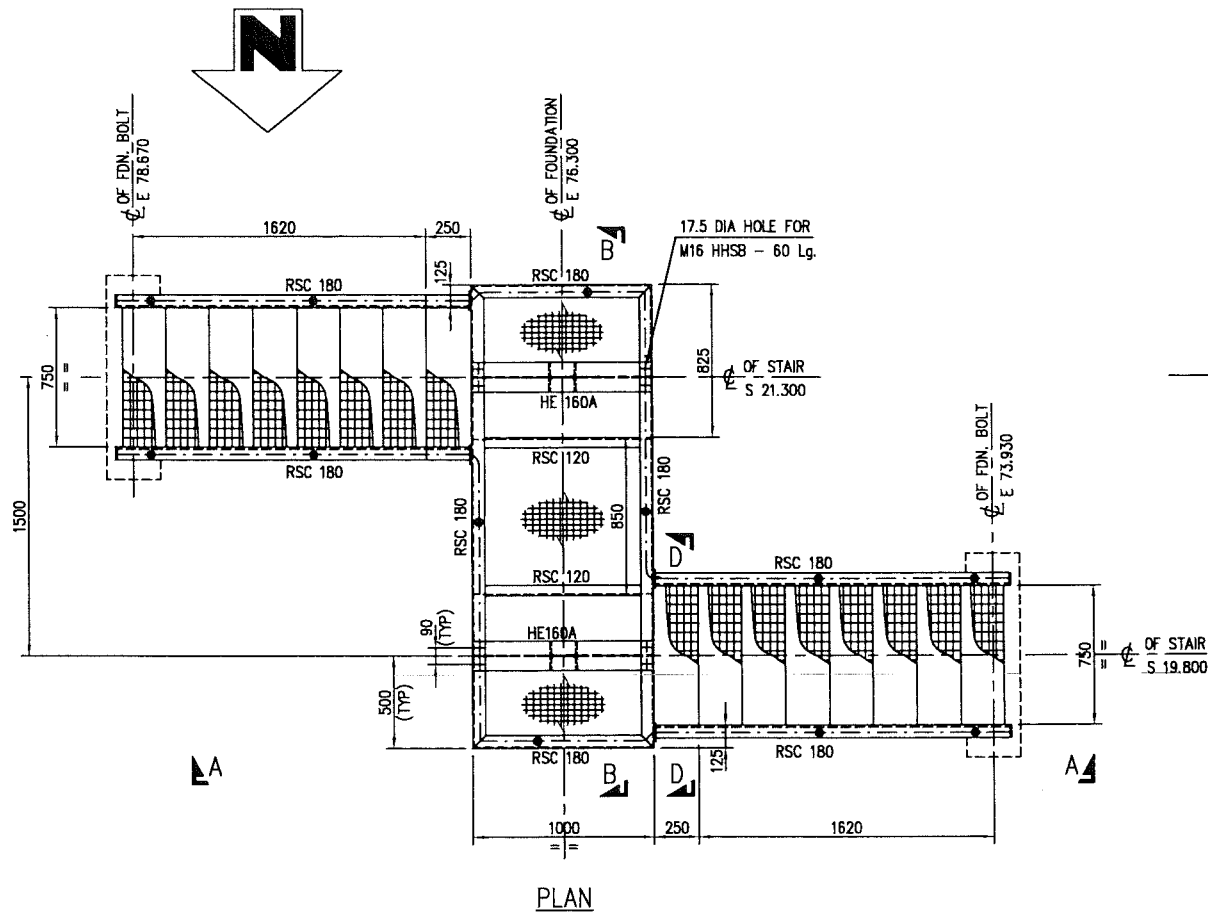

M.T.O.			
DESCRIPTION	QUANTITY	UNITS	SAP No.
HE 160 A	4.10	m	1000165612
RSC 180	17.15	m	1000080367
RSC 120	2.00	m	1000080365
25 THK. GRATING	2.50	m ²	N.A.
25 THK. STAIR TREAD	16	PCS	N.A.
20 THK PLATE	0.29	m ²	1000062610
10 THK PLATE	0.07	m ²	1000062608
FLAT 80x6	5.50	m	1000062576
1-1/4" PIPE SCHEDULE 40	28.55	m	N.A.
1" PIPE SCHEDULE 40	14.13	m	1000051530
M16 HSB WITH NUT & WASHER 60 Lg	16	PCS	N.A.
M12 HSB WITH NUT & WASHER 45 Lg	64	PCS	N.A.

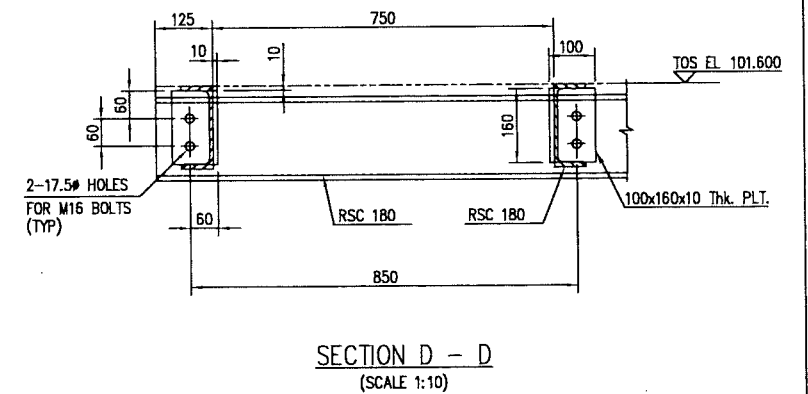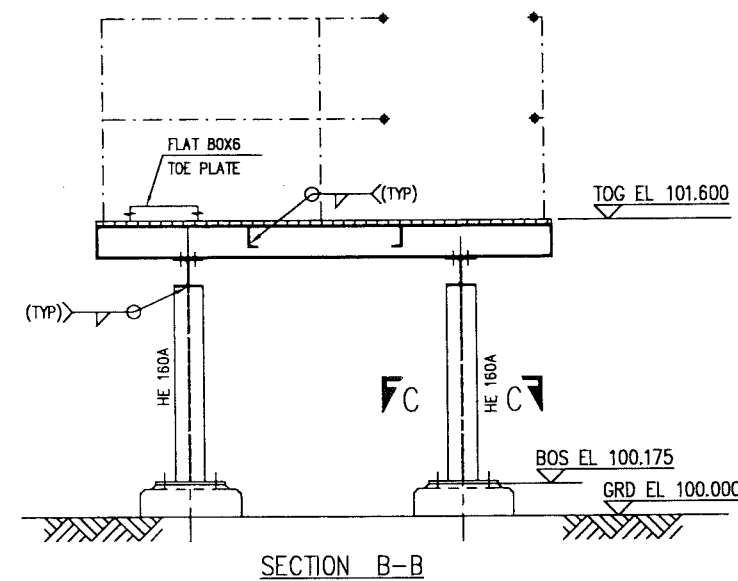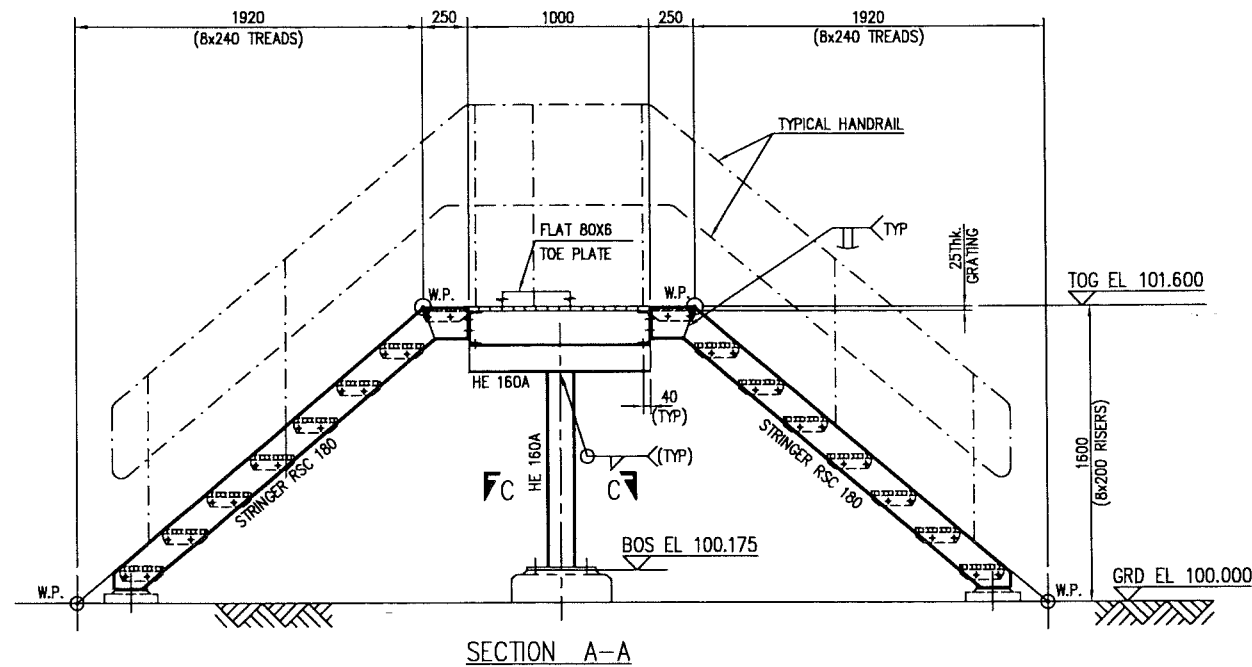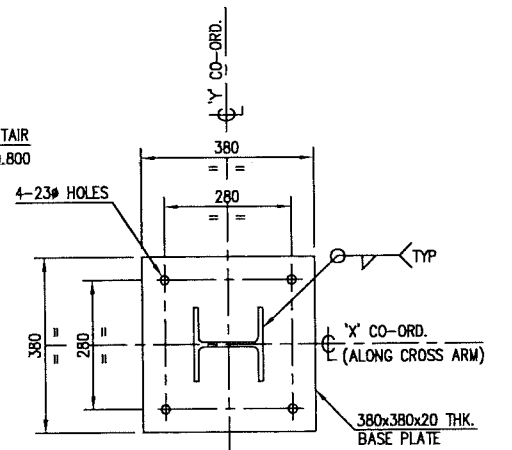

APPROVED FOR CONSTRUCTION



WorleyParsons - Arabian Industries (WJ)

REV	DATE	BY	CHKD	DESCRIPTION	REV	DATE	BY	CHKD	DESCRIPTION
0	27.02.11	GCS	KBR	ISSUED FOR COMMENTS	1	28.02.11	GCS	KBR	ISSUED FOR COMMENTS

PROJECT DRAWING REVISION

IN CASE OF DEVIATIONS A MARKED UP PRINT SHALL BE SENT TO THE PROJECT ENGINEER

AREA : NIMR

SUB AREA : NIMR SLUDGE PIT SYSTEMS

DESCRIPTION : STRUCTURE STEEL DETAILS

DESCRIPTION : PLATFORM MK'D P1

NO : NIM 2 1844 001 DQ 1 A

SCALE : 1:20

CAD DRAWING

PARSONS File name: W:\2_CIVIL\3-310606(EMC)\PAIP\PAIP00405_DQ\LAUNCHER AREA\21844001_DQ-GCS-27/02/11-10:00:24


DESCRIPTION	DRAWING NUMBER	REV	DATE	APPROVED BY	DESCRIPTION	REV	DATE	APPROVED BY	DESCRIPTION
PIPING PLAN	NIM 3 2132 002 DQ 1								
PLATFORM FOUNDATION MK'D PF1	NIM 2 1884 002 DQ 3								
FOUNDATION LOCATION PLAN	NIM 2 0992 001 DQ 1								
TYPICAL GRATING DETAILS	NIM 2 1841 004 DQ 3								
TYPICAL STAIR & HANDRAILING	NIM 2 1841 003 DQ 3								
GENERAL NOTE, LEGEND & ABBREVIATIONS STEEL	NIM 2 1841 002 DQ 3								

DESCRIPTION	DRAWING NUMBER	REV	DATE	APPROVED BY	DESCRIPTION	REV	DATE	APPROVED BY	DESCRIPTION
REFERENCE DRAWINGS									
MASTER DRAWING REVISION									
IN CASE OF DEVIATIONS MARKED UP PRINT SHALL BE SENT TO COASTAL DESIGN OFFICE									


DESCRIPTION	DRAWING NUMBER	REV	DATE	APPROVED BY	DESCRIPTION	REV	DATE	APPROVED BY	DESCRIPTION
REFERENCE DRAWINGS									
MASTER DRAWING REVISION									
IN CASE OF DEVIATIONS MARKED UP PRINT SHALL BE SENT TO COASTAL DESIGN OFFICE									

1. ALL DIMENSIONS ARE IN MILLIMETRES AND ELEVATIONS IN METRES.


NOTES

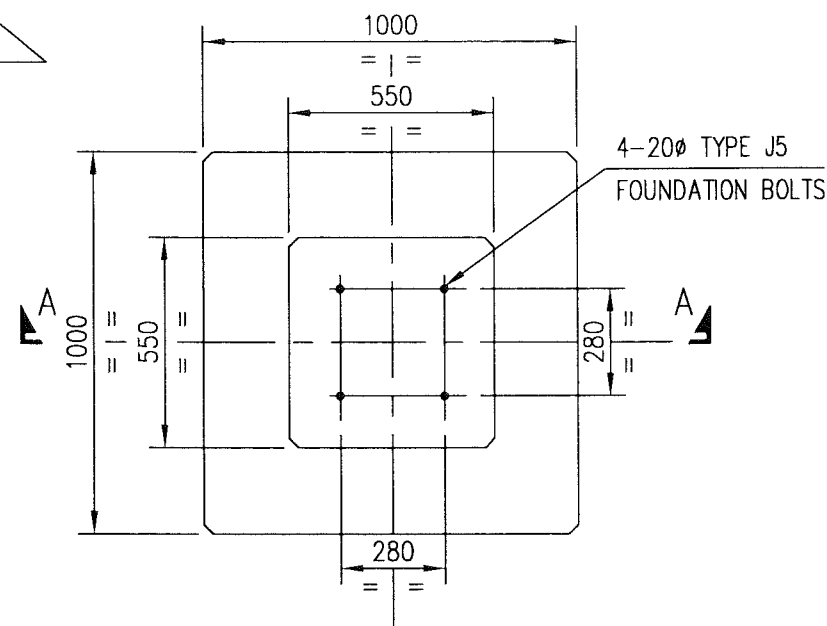


PLAN
(2 Nos. REQ'D)

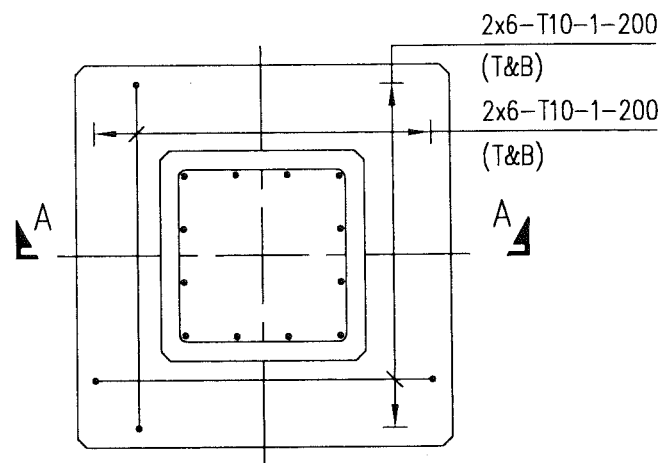

REINFORCEMENT PLAN

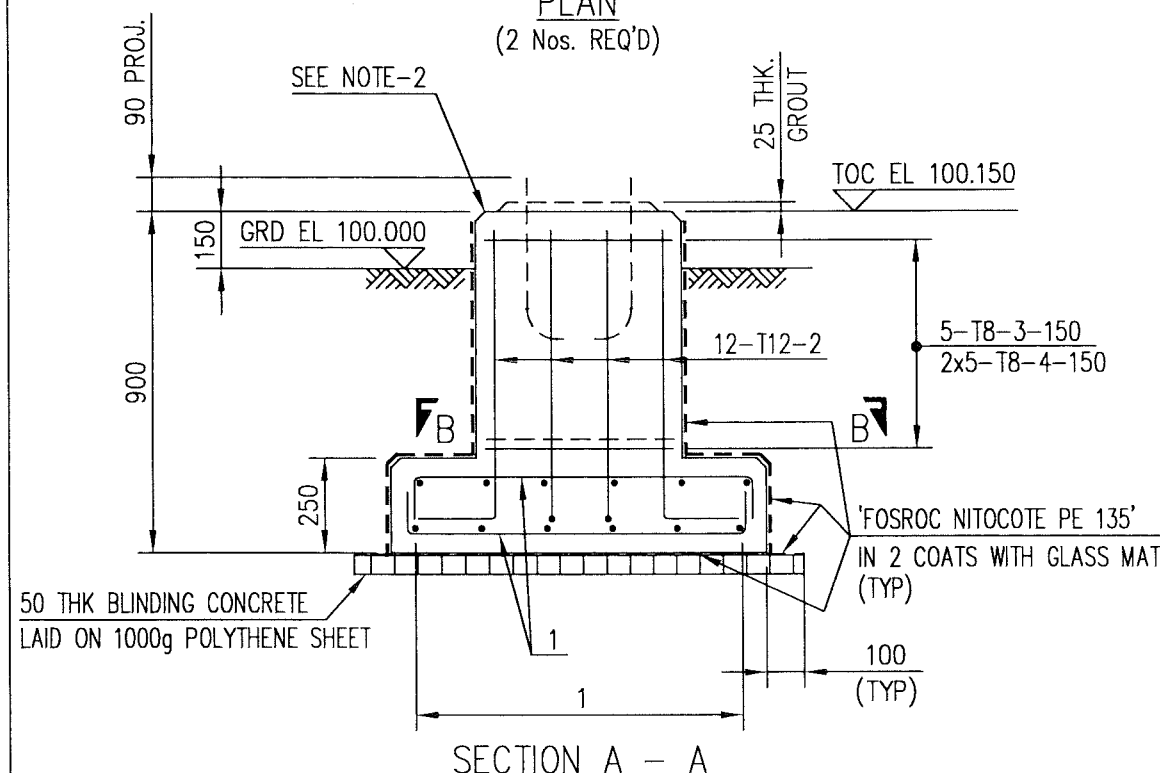

SECTION A - A

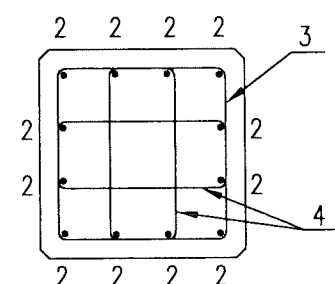

SECTION B - B


NOTE: * DENOTES, SINCE GRADE ELEVATION VARIES, CONTRACTOR TO VERIFY ELEVATIONS AND DIMENSIONS AT SITE, PRIOR TO FABRICATION/CONSTRUCTION/INSTALLATION.

REFERENCE DRGS: -

1. GEN.NOTES, LEGEND & ABBREVIATIONS (CONG.) - NIM -2-1841-001-DQ-3
2. PLATFORM P1 DETAILS - NIM -2-1844-001-DQ-1
3. FOUND BOLTS - STD -2-3950-001-00-3
4. BAR BENDING SCHEDULE - NIM -2-1844-003-DQ-4
5. FOUNDATION LOCATION PLAN - NIM -2-0992-001-DQ-1

CONCRETE GRADE-35

APPROVED FOR
CONSTRUCTION

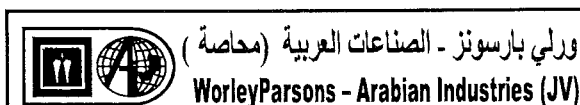

CONTRACT NO.: C31/0606 PROJ. NO.: PAIP00405

REV	DATE	APPROVED BY	DESCRIPTION	WBS NO.	PROJ.ENG.	SPEC.ENG.
1.			ALL DIMENSIONS ARE IN MILLIMETRES AND ELEVATIONS IN METRES.			
2.			ALL EXPOSED CONCRETE SURFACES SHALL BE TREATED WITH TWO COATS OF "FOSROC DEKGUARD S" WITH A DFT OF 350 MICRONS OR ANY OTHER APPROVED EQUIVALENT.			
NOTES/REFERENCE DRAWINGS						
MASTER DRAWING REVISION						
IN CASE OF DEVIATIONS MARKED UP PRINT SHALL BE SENT TO COASTAL DESIGN OFFICE						

REV	DATE	DRAWN BY	TEAML	J.ENG.	CHECKED	DESCRIPTION	WBS No.	PROJ. ENG.	SIGNATURE
A	27.02.11	GCS	RB	✓		APPROVED FOR CONSTRUCTION	IN.09.011	OSE/28N	
O	26.02.11	GCS	KBR	GSB		ISSUED FOR COMMENTS	IN.09.011	OSE/28N	
PROJECT DRAWING REVISION									
IN CASE OF DEVIATIONS A MARKED UP PRINT SHALL BE SENT TO THE PROJECT ENGINEER									
AREA : NIMR							SCALE : 1:20 CAD DRAWING		
SUB AREA : NIMR SLUDGE PIT SYSTEMS							No. 16		
DRWG.TYPE : CIVIL DETAILS							Petrochem Development Oman		
DESCRIPTION : PLATFORM FOUNDATION MK'D PF1							DRWG	AREA CODE	ENG SECT
							SERIAL NUMBER	SHEET	PROJ CODE
							DWG SIZE	REV.	
							NO	NIM 2 1844 002 DQ	3 A

BAR BENDING SCHEDULE

JOB NO.: PAIP00238
PART ID.: NIMR SLUDGE PIT SYSTEMS
PLATFORM-P1

Document No.: NIM-2-1844-003-DQ-4
Revision No.: A
Prepared by: GCS
Checked by: PNG *RE*
Date: 27.02.11

REF. DWG NO.: NIM-2-1844-002-DQ-3

Total MTO for Rebars.

Dia. Of Bar	T6	T8	T10	T12	T16	T20	T25	T32
Length of Bar (m)		48.25	54.00	23.40				
Weight (Kgs)		19.30	33.48	20.83				

Total Weight (Kgs)

73.610

10. Mmms
7A2

[illegible]



This schedule complies with BS 8666 : 2005

All dimensions are in mm


Refer to Bar shape Code drawing

* Specified in multiples of 5 mm

† Specified in multiples of 25 mm

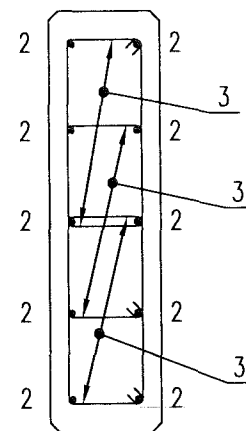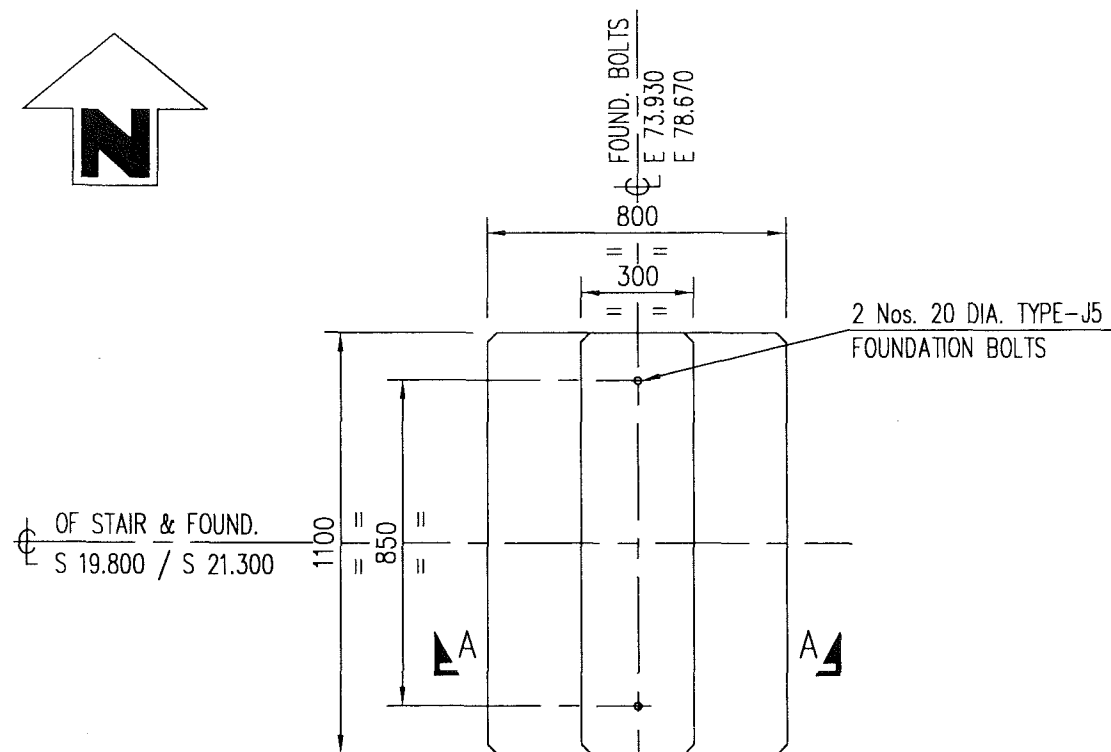

SECTION B-B

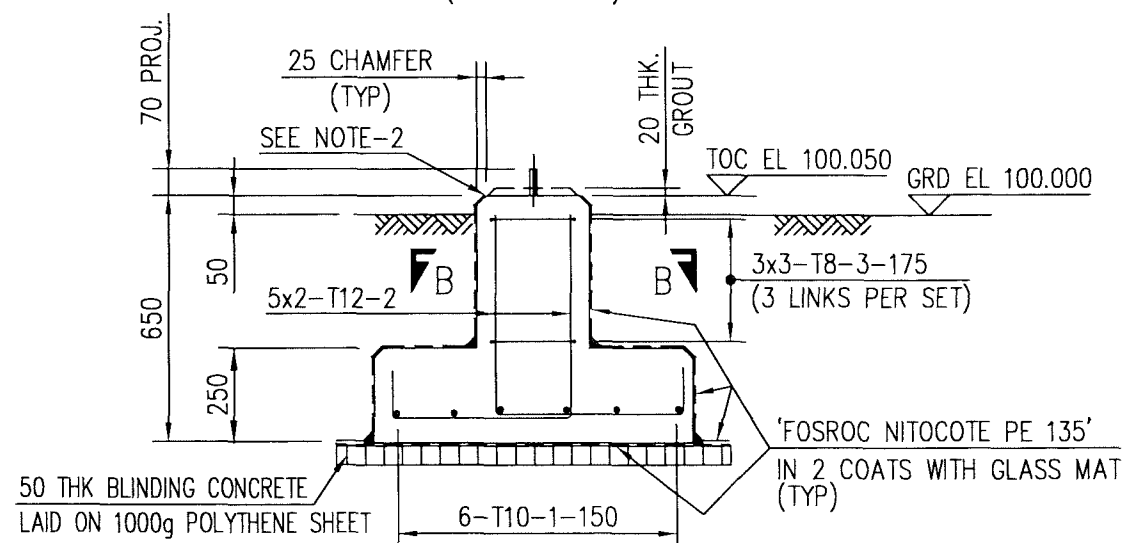

SECTION A-A

M.T.O.

DESCRIPTION	QUANTITY	UNITS	SAP No.
BLINDING CONCRETE	0.13	m ³	N.A.
CONCRETE GRADE 35	0.71	m ³	N.A.
CEMENT SAND GROUT	4.62	L ^t	N.A.
FOUNDATION BOLTS	4	PCS	N.A.
PROTECTIVE COATING	7.84	m ²	N.A.
REINFORCEMENT STEEL	41.04	kg	N.A.
POLYTHENE SHEET 1000g	2.60	m ²	N.A.

NOTE: * DENOTES, SINCE GRADE ELEVATION VARIES, CONTRACTOR TO VERIFY ELEVATIONS AND DIMENSIONS AT SITE, PRIOR TO FABRICATION/CONSTRUCTION/INSTALLATION.

REFERENCE DRGS: -

1. GEN.NOTES, LEGEND & ABBREVIATIONS (CONC.) NIM -2-1841-001-DQ-3
2. FOUND BOLTS STD -2-3950-001-00-3
3. BAR BENDING SCHEDULE NIM -2-1844-005-DQ-4
4. FOUNDATION LOCATION PLAN NIM -2-0992-001-DQ-1

CONCRETE GRADE-35

APPROVED FOR
CONSTRUCTION



CONTRACT NO.: C31/0606 PROJ. NO.: PAIP00405

REV	DATE	DRAWN BY	TEAM L	J. ENG.	DESCRIPTION	WBS No.	PROJ. ENG.	SIGNATURE
A	27.02.11	GCS	RB	✓	APPROVED FOR CONSTRUCTION	IN.09.011	OSE/28N	
O	26.02.11	GCS	KBR	GSB	ISSUED FOR COMMENTS	IN.09.011	OSE/28N	

PROJECT DRAWING REVISION

IN CASE OF DEVIATIONS A MARKED UP PRINT SHALL BE SENT TO THE PROJECT ENGINEER

2. ALL EXPOSED CONCRETE SURFACES SHALL BE TREATED WITH TWO COATS OF "FOSROC DEKGUARD S" WITH A DFT OF 350 MICRONS OR ANY OTHER APPROVED EQUIVALENT.

1. ALL DIMENSIONS ARE IN MILLIMETRES AND ELEVATIONS IN METRES.

NOTES/REFERENCE DRAWINGS

MASTER DRAWING REVISION
IN CASE OF DEVIATIONS MARKED UP PRINT SHALL BE SENT TO COASTAL DESIGN OFFICE

AREA : NIMR

SUB AREA : NIMR SLUDGE PIT SYSTEMS NO. 16

DRWG. TYPE : CIVIL DETAILS

DESCRIPTION : STAIR FOUNDATION MK'D SF1

SCALE : 1:20 CAD DRAWING

شركة تنمية نفط عمان
Petrochem Development Oman

DRWG	AREA CODE	ENG SECT	SERIAL NUMBER	SHEET	PROJ CODE	DWG SIZE	REV.
NO	NIM	2	1844	004	DQ	3	A

BAR BENDING SCHEDULE

JOB NO.: PAIP00238
PART ID.: NIMR SLUDGE PIT SYSTEMS
STAIR FOUNDATION

Document No.: NIM-2-1844-005-DQ-4
Revision No.: A
 Prepared by: GCS
 Checked by: PNG
 Date: 27.02.11

REF. DWG NO.: NIM-2-1844-004-DQ-3

Total MTO for Rebars.

Dia. Of Bar	T6	T8	T10	T12	T16	T20	T25	T32
Length of Bar (m)		28.80	15.30	22.50				
Weight (Kgs)		11.52	9.49	20.03				

Total Weight (Kgs)

41.040

[illegible]

1c. Murren
7A2


This schedule complies with BS 8666 : 2005

All dimensions are in mm


Refer to Bar shape Code drawing

* Specified in multiples of 5 mm

† Specified in multiples of 25 mm

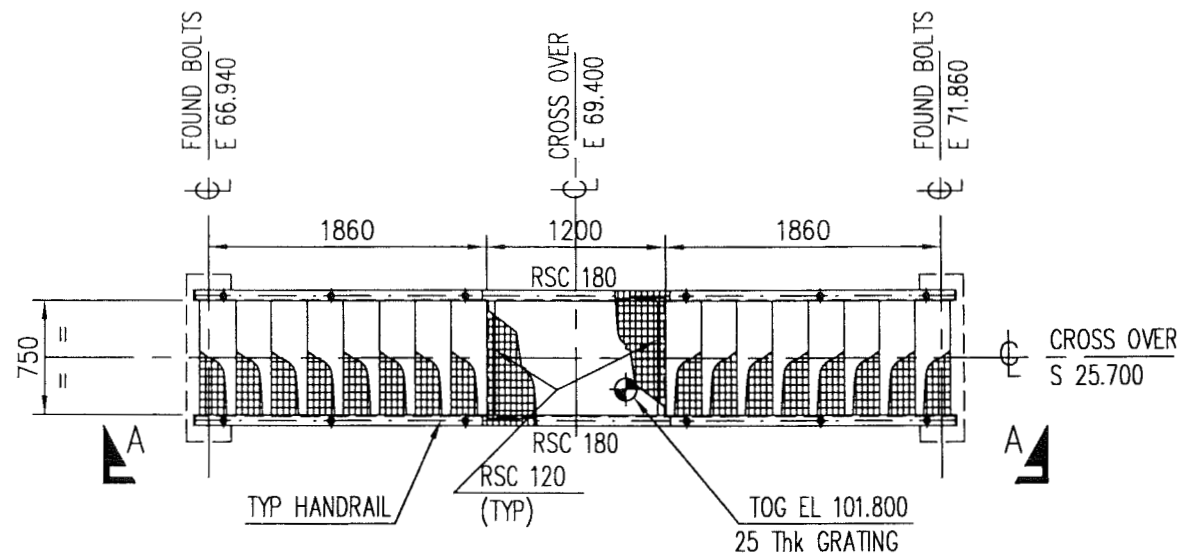

PLAN
CROSSOVER CO1
(1 No. REQD.)

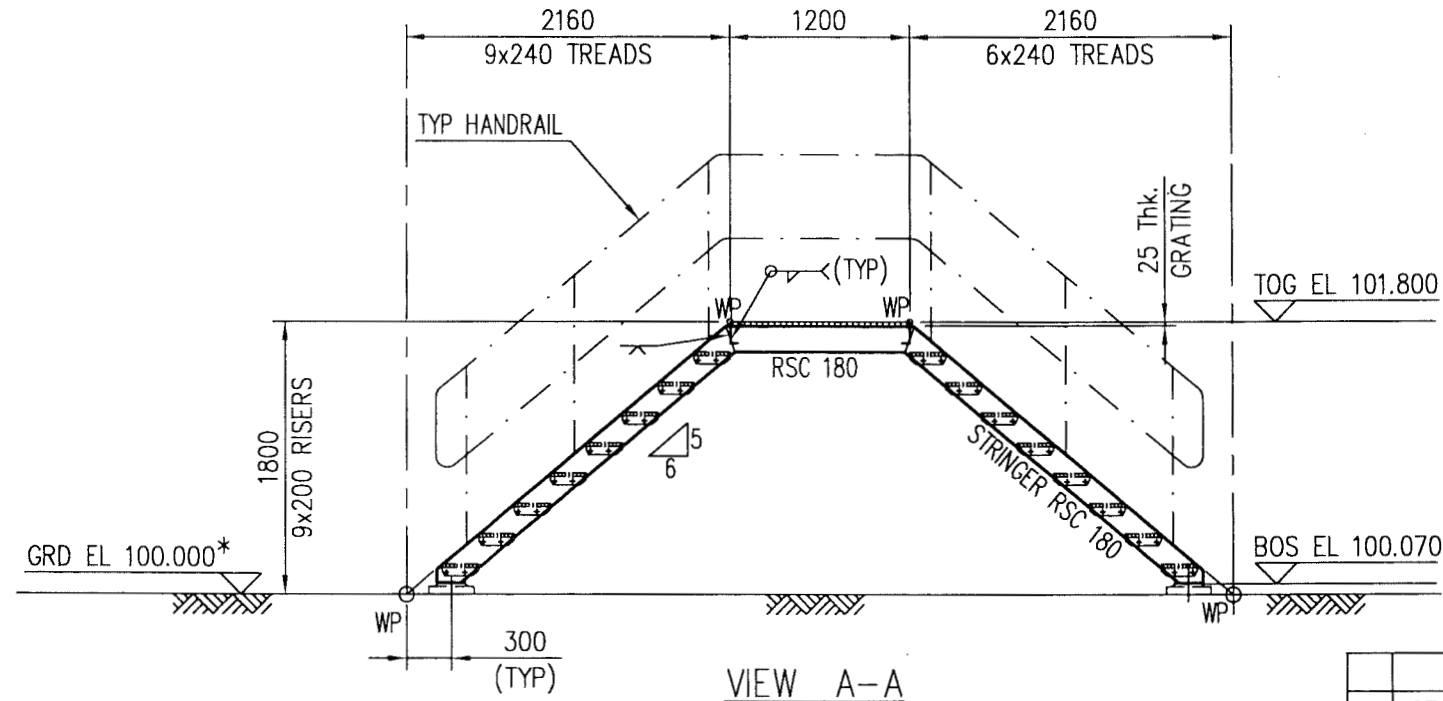

VIEW A-A

M.T.O.

DESCRIPTION	QUANTITY	UNITS	SAP No.
RSC 120	1.50	m	1000080365
RSC 180	13.00	m	1000080367
10 THK PLATE	0.10	m ²	1000062608
1-1/4" PIPE SCHEDULE 40	26.10	m	N.A.
1" PIPE SCHEDULE 40	11.50	m	1000051530
25 THK. GRATING	1.10	m ²	N.A.
25 THK. STAIR TREAD	16	PCS	N.A.
M12 HSB WITH NUT & WASHER 45 Lg	64	PCS	N.A.
M16 HSB WITH NUT & WASHER 55 Lg	24	PCS	N.A.

NOTE: * DENOTES, SINCE GRADE ELEVATION VARIES, CONTRACTOR TO VERIFY ELEVATIONS AND DIMENSIONS AT SITE, PRIOR TO FABRICATION/ CONSTRUCTION/INSTALLATION.

REF. DRGS.

- GENERAL NOTES, LEGEND AND ABBREVIATIONS. NIM -2-1841-002-DQ-3
- TYPICAL GRATING AND TREAD DETAILS. NIM -2-1841-004-DQ-3
- TYPICAL STAIR AND HANDRAILING DETAILS. NIM -2-1841-003-DQ-3
- STAIR FOUNDATION DETAIL. NIM -2-1844-013-DQ-3
- FOUNDATION LOCATION PLAN. NIM -2-0992-001-DQ-1
- PIPING PLAN. NIM -3-2140-001-DQ-1

APPROVED FOR
CONSTRUCTION



CONTRACT NO.: C31/0606 PROJ. NO.: PAIP00405

REV	DATE	DRAWN BY	TEAML.	J.ENG.	DESCRIPTION	WBS No.	PROJ. ENG.	SIGNATURE
A	27.02.11	GCS	BB	J.	APPROVED FOR CONSTRUCTION	IN.09.011	OSE/28N	
O	26.02.11	GCS	KBR	GSB	ISSUED FOR COMMENTS	IN.09.011	OSE/28N	
					CHECKED		P D O APPROVAL	

PROJECT DRAWING REVISION


IN CASE OF DEVIATIONS A MARKED UP PRINT SHALL BE SENT TO THE PROJECT ENGINEER

AREA	: NIMR	SCALE : 1:50	CAD DRAWING
SUB AREA	: NIMR SLUDGE PIT	NO. 16	
DRWG. TYPE	: STRUCTURAL STEEL DETAILS		
DESCRIPTION	: CROSS OVER-CO1		
DRWG	AREA CODE	ENG SECT	SERIAL NUMBER
NO	NIM	2	1844 006 DQ
			3 A


REV	DATE	APPROVED BY	DESCRIPTION	B.I.NO.	PROJ.ENG.	SPEC.ENG.
1. ALL DIMENSIONS ARE IN MILLIMETRES AND ELEVATIONS IN METRES.						

NOTES/REFERENCE DRAWINGS


MASTER DRAWING REVISION
IN CASE OF DEVIATIONS MARKED UP PRINT SHALL BE SENT TO COASTAL DESIGN OFFICE

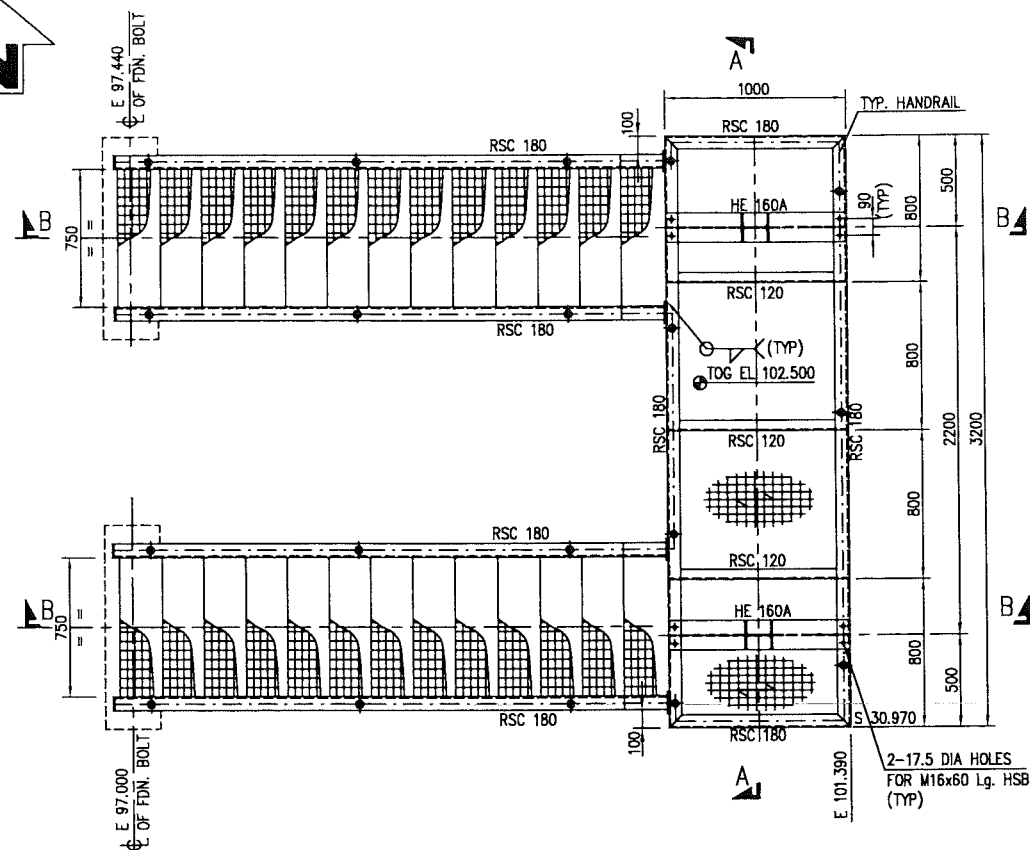


PLAN
CROSS OVER - C04

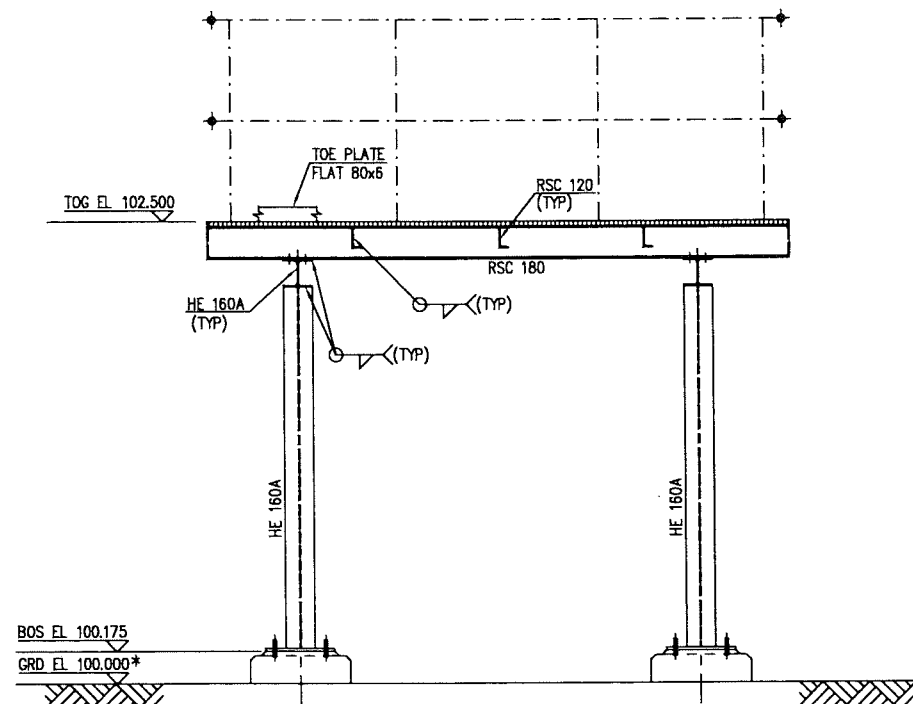


SECTION A - A

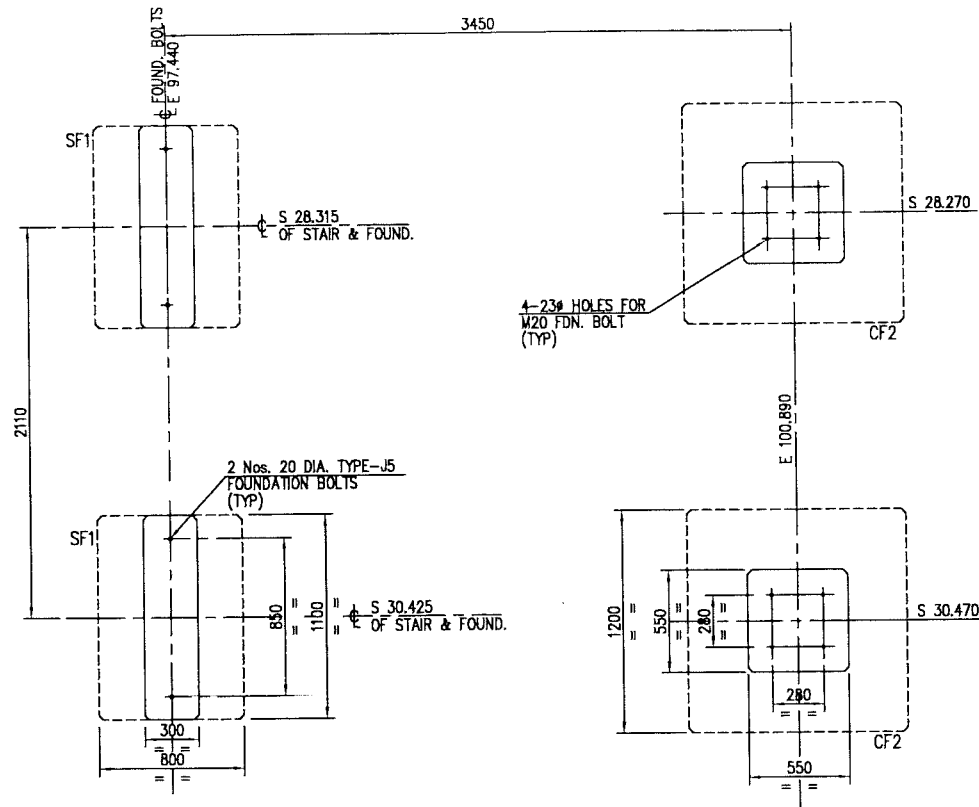


FOUNDATION PLAN

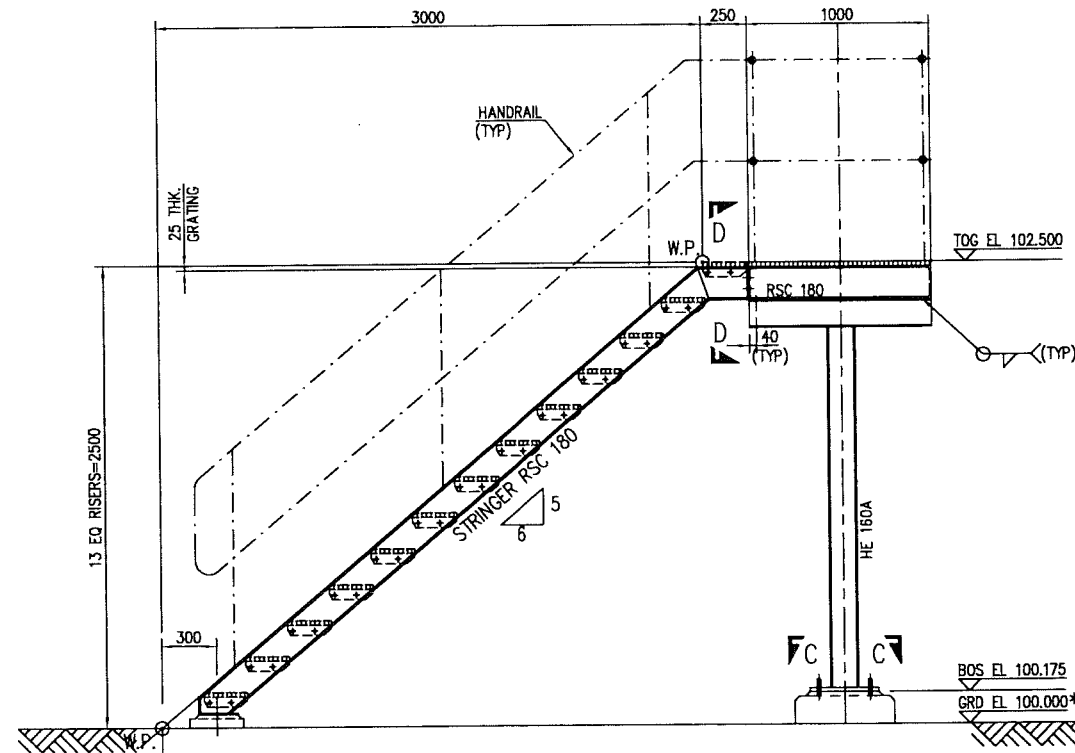

SECTION B - B

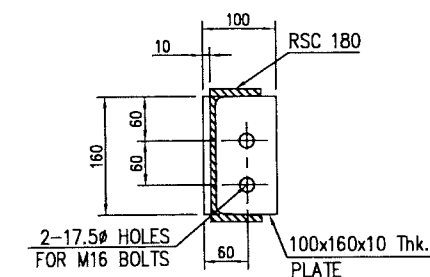

SECTION D - D
(SCALE 1:5)

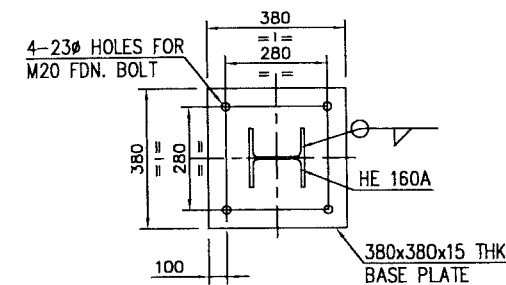

SECTION B-B
(2 Nos. REQD.)
(SCALE 1:10)

APPROVED FOR CONSTRUCTION



WorleyParsons - Arabian Industries (WPI)

CONTRACT NO.: C310606 PROJ. NO.: PAIP00405

A	27.02.11	GCS	38	✓	APPROVED FOR CONSTRUCTION	IN.09.011	OSE/28N
D	26.02.11	GCS	KBR	GSB	ISSUED FOR COMMENTS	IN.09.011	OSE/28N
REV	DATE	DRAWN BY	TEAM LEAD	APPROVED	DESCRIPTION	ISS NO	PROJ. ENG. SIGNATURE
			CHECKED				P.D.D. APPROVAL
PROJECT DRAWING REVISION							
IN CASE OF DEVIATIONS A MARKED UP PRINT SHALL BE SENT TO THE PROJECT ENGINEER							
AREA	: NIMR					SCALE : 1: 20	CAD DRAWING
SUB AREA	: NIMR SLUDGE PIT					NO. 16	شركة تنمية نفط عمان Petrochem Development Oman
DRWG. TYPE	: STRUCTURAL STEEL DETAILS					DRWG	AREA CODE ENG. SHEET SERIAL NUMBER SHEET PROJ. CODE PROJ. SIZE
DESCRIPTION	: CROSS OVER MK'D-C02					NO.	NIM 2 1844 007DQ 1


1. ALL DIMENSIONS ARE IN MILLIMETRES AND ELEVATIONS IN METRES.

NOTES


REFERENCE DRAWINGS

MASTER DRAWING REVISION
IN CASE OF DEVIATIONS MARKED UP PRINT SHALL BE SENT TO COASTAL DESIGN OFFICE


PARSONS File name: W:\2_CIVIL\C-310606(EMC)\PAIP\PAIP00405_DQ\LAUNCHER AREA\MECHANICAL REQUIREMENTS\21844007_DQ.dwg-GCS-27/02/11-10:02:34

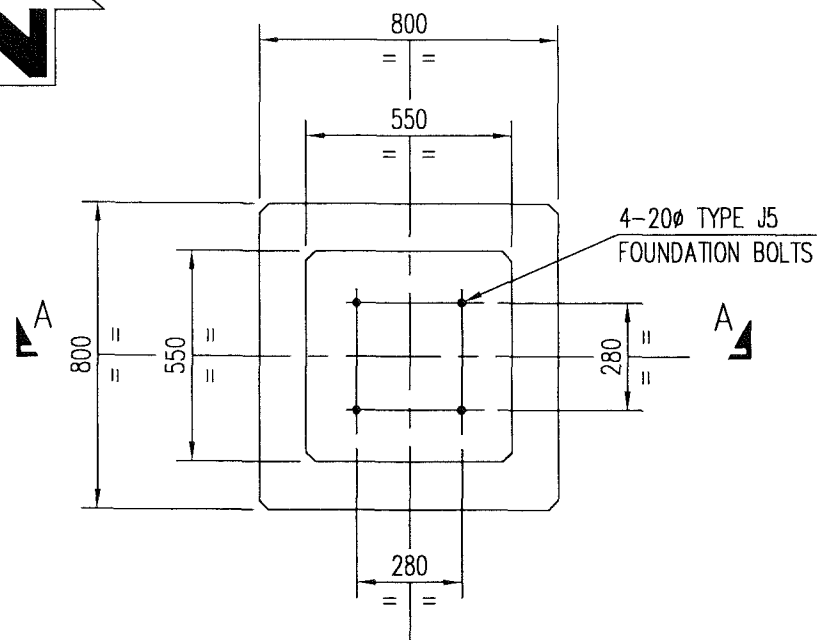


PLAN
(6 Nos. REQ'D)

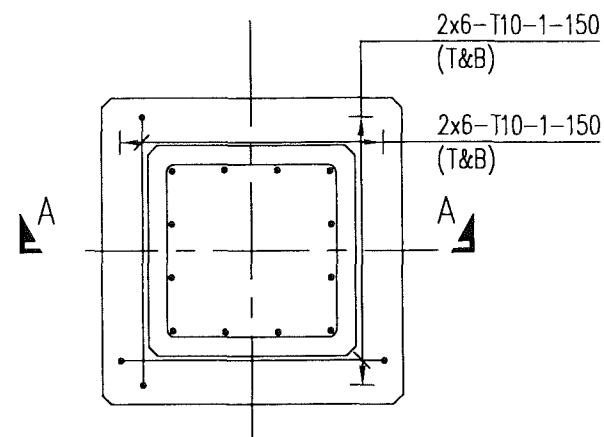

REINFORCEMENT PLAN

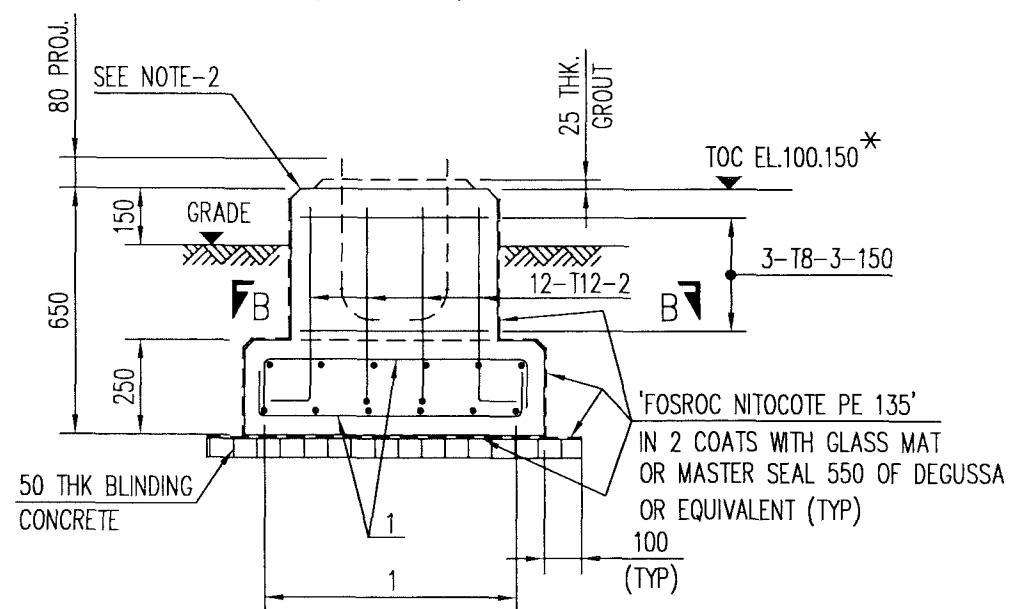

SECTION A - A

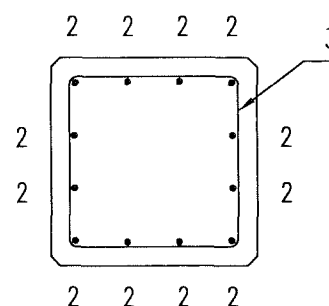

SECTION B - B

CONCRETE GRADE 35


NOTE: * DENOTES, SINCE GRADE ELEVATION VARIES, CONTRACTOR TO VERIFY ELEVATIONS AND DIMENSIONS AT SITE, PRIOR TO FABRICATION/CONSTRUCTION/INSTALLATION.

REFERENCE DRGS: -

1. GENERAL NOTES, LEGEND & ABBREV. (CONC.) - NIM-2-1841-001-DQ-3
2. FOUNDATION BOLTS - STD-2-3950-001-00-3
3. PLATFORM DETAILS - NIM-2-1844-010-DQ-1
4. FOUNDATION LOCATION PLAN - NIM-2-0992-001-DQ-1
5. BBS - NIM-2-1844-012-DQ-4

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APPROVED FOR
CONSTRUCTION

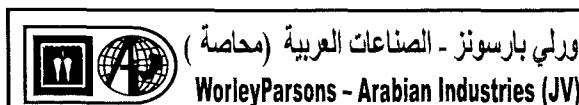

CONTRACT NO.: C31/0606 PROJ. NO.: PAIP00405

REV	DATE	DRAWN BY	TEAM L.	J. ENG.	CHECKED	DESCRIPTION	WBS No.	PROJ. ENG.	SIGNATURE
A	27.02.11	GCS	BB	WJ		APPROVED FOR CONSTRUCTION	IN.09.011	OSE/28N	
0	26.02.11	GCS	KBR	GSB		ISSUED FOR COMMENTS	IN.09.011	OSE/28N	

PROJECT DRAWING REVISION

IN CASE OF DEVIATIONS A MARKED UP PRINT SHALL BE SENT TO THE PROJECT ENGINEER

2. ALL EXPOSED CONCRETE SURFACES SHALL BE TREATED WITH 2 COATS OF "FOSROC DEKGUARD S" WITH A DFT OF 350 MICRONS OR ANY OTHER APPROVED EQUIVALENT.									
1. ALL DIMENSIONS ARE IN MM, LEVELS ARE IN METERS.	REV	DATE	APPROVED BY	DESCRIPTION	WBS NO.	PROJ. ENG.	SPEC. ENG.		
NOTES/REFERENCE DRAWINGS									

MASTER DRAWING REVISION
IN CASE OF DEVIATIONS MARKED UP PRINT SHALL BE SENT TO COASTAL DESIGN OFFICE

AREA : NIMR

SUB AREA : NIMR SLUDGE PIT

NO. 16

DRWG. TYPE : CIVIL DETAILS

DESCRIPTION : FOUNDATION DETAILS MK'D-PF1



SCALE : 1:20 CAD DRAWING




شركة تنمية نفط عُمان
Petroleum Development Oman

DRWG	AREA CODE	ENG SECT	SERIAL NUMBER	SHEET	PROJ CODE	DRWG SIZE	REV.
NO	NIM	2	1844	011	DQ	3	A


BAR BENDING SCHEDULE

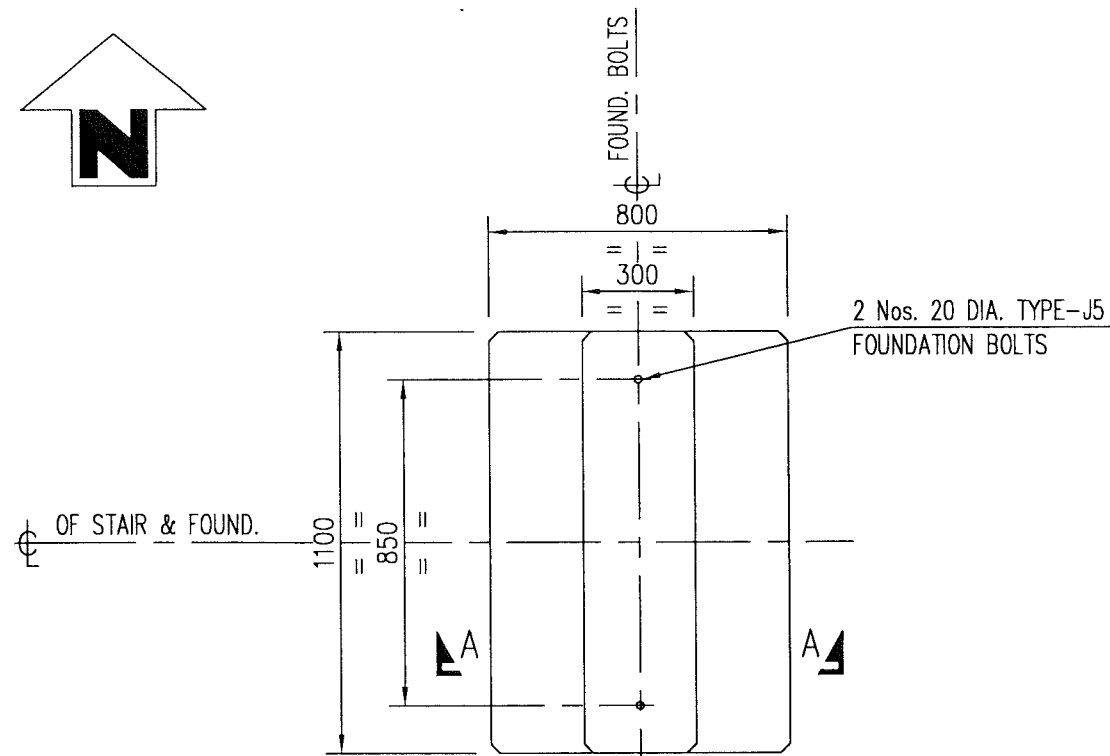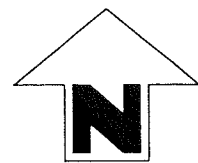

PLAN
(6 Nos. REQ'D)

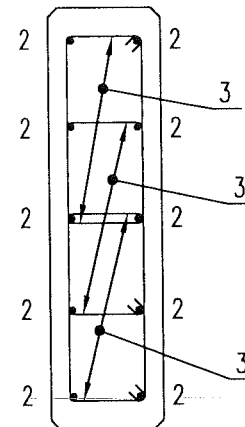

SECTION B-B

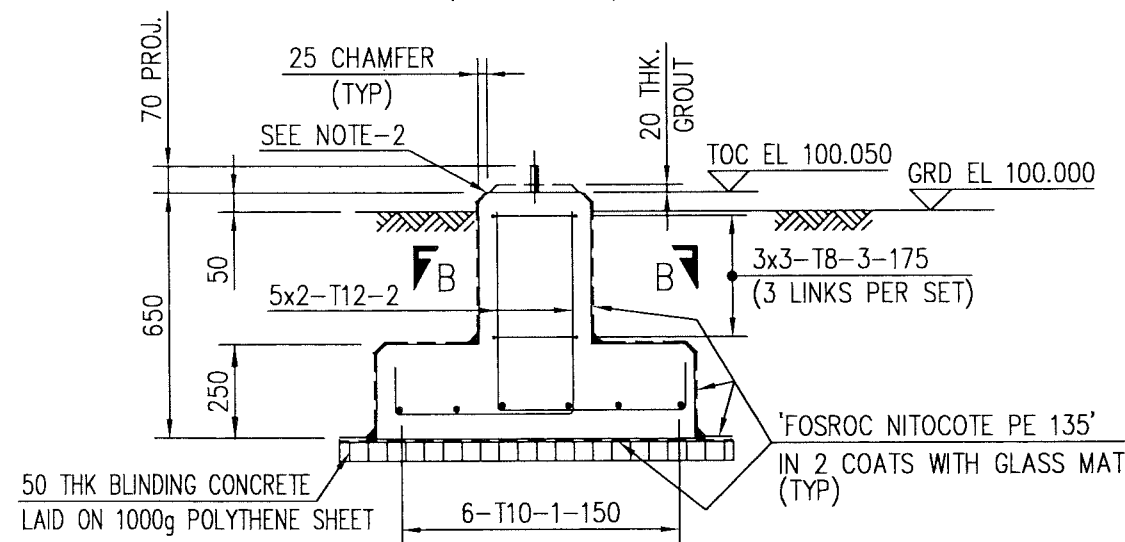

SECTION A-A

CONCRETE GRADE-35



ورلي بارسونز - الصناعات العربية (محاصة)
WorleyParsons - Arabian Industries (JV)

CONTRACT NO.: C31/0606 PROJ. NO.: PAIP00405

2. ALL EXPOSED CONCRETE SURFACES SHALL
BE TREATED WITH TWO COATS OF "FOSROC
DEKGUARD S" WITH A DFT OF 350 MICRONS
OR ANY OTHER APPROVED EQUIVALENT.

1. ALL DIMENSIONS ARE IN MILLIMETRES AND
ELEVATIONS IN METRES.

NOTES/REFERENCE DRAWINGS

MASTER DRAWING REVISION
IN CASE OF DEVIATIONS MARKED UP PRINT SHALL BE SENT TO COASTAL DESIGN OFFICE

REV	DATE	DRAWN BY	TEAML.	J.ENG.	CHECKED	DESCRIPTION	WBS No.	PROJ. ENG.	SIGNATURE
A	27.02.11	GCS	KBR	GSB		APPROVED FOR CONSTRUCTION	IN.09.011	OSE/28N	
O	26.02.11	GCS	KBR	GSB		ISSUED FOR COMMENTS	IN.09.011	OSE/28N	

PROJECT DRAWING REVISION
IN CASE OF DEVIATIONS A MARKED UP PRINT SHALL BE SENT TO THE PROJECT ENGINEER

AREA : NIMR

SUB AREA : NIMR SLUDGE PIT SYSTEMS

DRWG. TYPE : CIVIL DETAILS

DESCRIPTION : STAIR FOUNDATION MK'D SF1

SCALE : 1:20
0 1 2 3 4 5 6 7

شركة تنمية نفط عمان
Petrochem Development Oman

DRWG	AREA CODE	ENG SECT	SERIAL NUMBER	SHEET	PROJ CODE	DWG SIZE	REV.
NO	NIM	2	1844	013	DQ	3	A



BAR BENDING SCHEDULE

JOB NO.: PAIP00238
PART ID.: NIMR SLUDGE PIT SYSTEMS
STAIR FOUNDATION

Document No.: NIM-2-1844-014-DQ-4

Revision No.: A

Prepared by: GCS

Checked by: PNG

Date: 27.02.11

REF. DWG NO.: NIM-2-1844-013-DQ-3

Total MTO for Rebars.

Dia. Of Bar	T6	T8	T10	T12	T16	T20	T25	T32
Length of Bar (m)		86.40	45.90	67.50				
Weight (Kgs)		34.56	28.46	60.08				

Total Weight (Kgs)

123.100

k. $\neg A2$

[illegible]

This schedule complies with BS 8666 : 2005


All dimensions are in mm

Refer to Bar shape Code drawing


* Specified in multiples of 5 mm

† Specified in multiples of 25 mm


M.T.O.			
DESCRIPTION	QUANTITY	UNITS	SAP No.
CONCRETE GRADE 35	40.80	m ³	N.A.
BLINDING CONCRETE	1.90	m ³	N.A.
POLYTHENE SHEET 1000g	36.10	m ²	N.A.
PROTECTIVE COATING	133.60	m ²	N.A.
REINFORCEMENT STEEL	4399.57	kg	N.A.

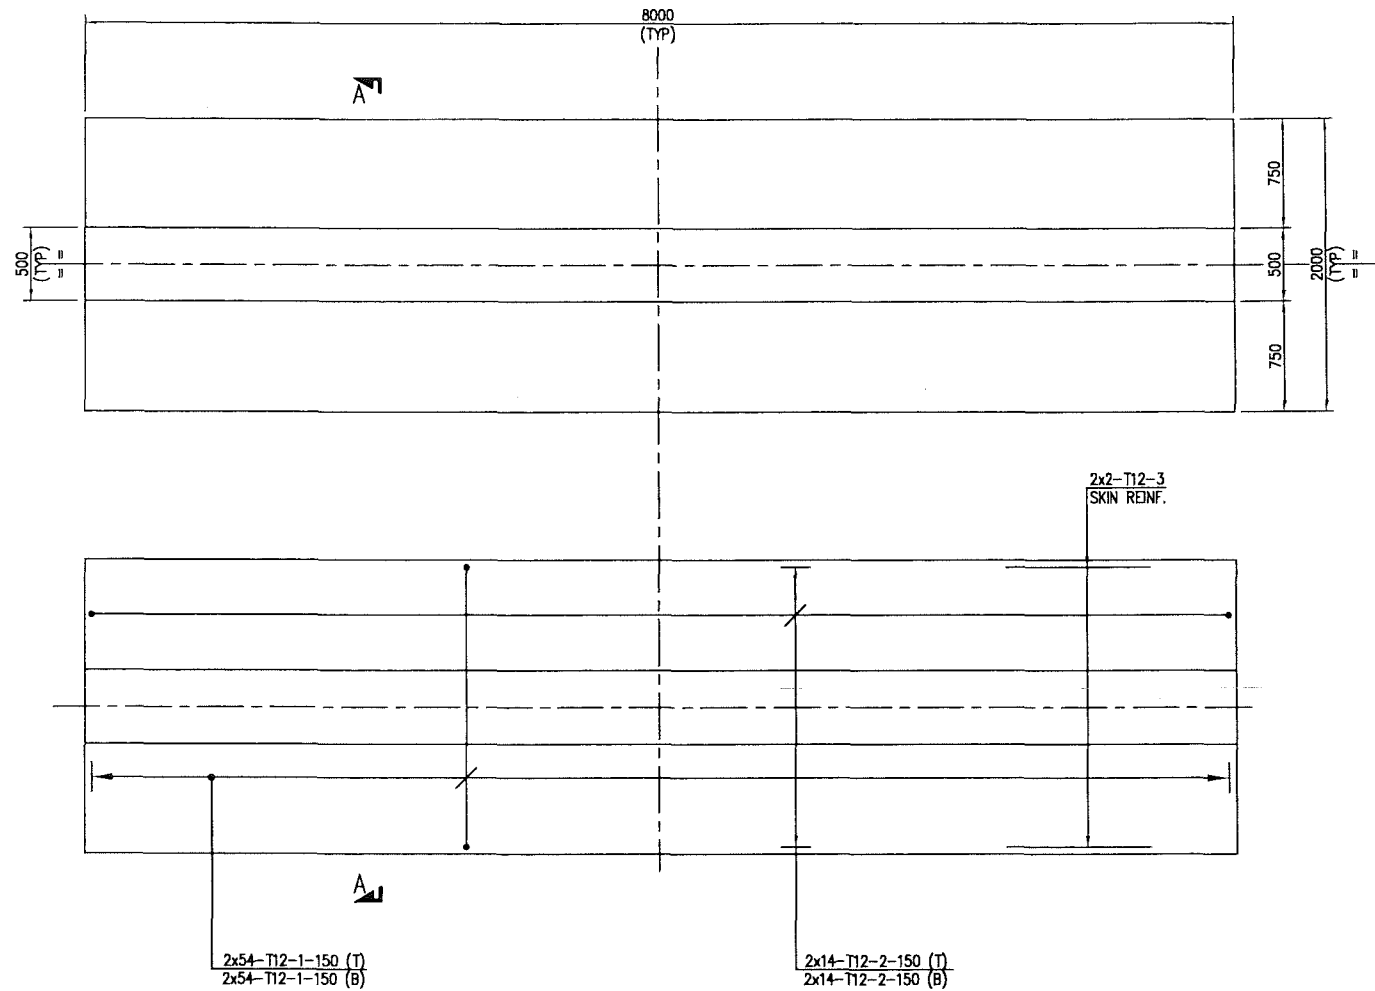


PLAN AT FOOTING LVL.

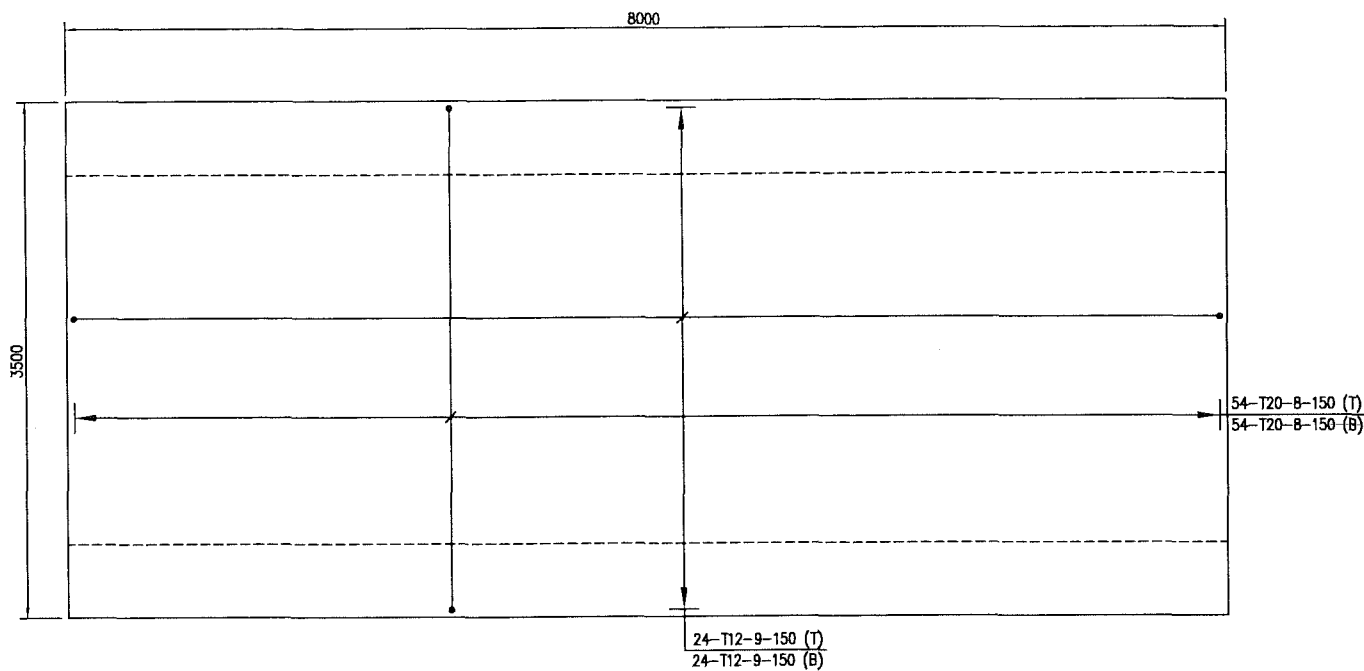

PLAN AT ROOF LVL.

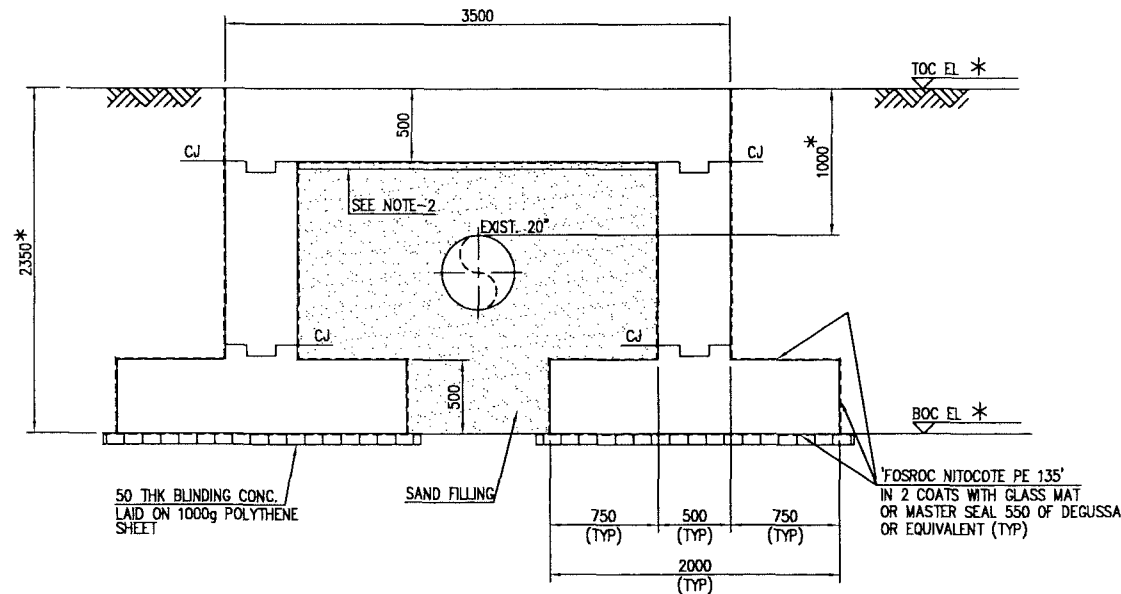

SECTION A-A

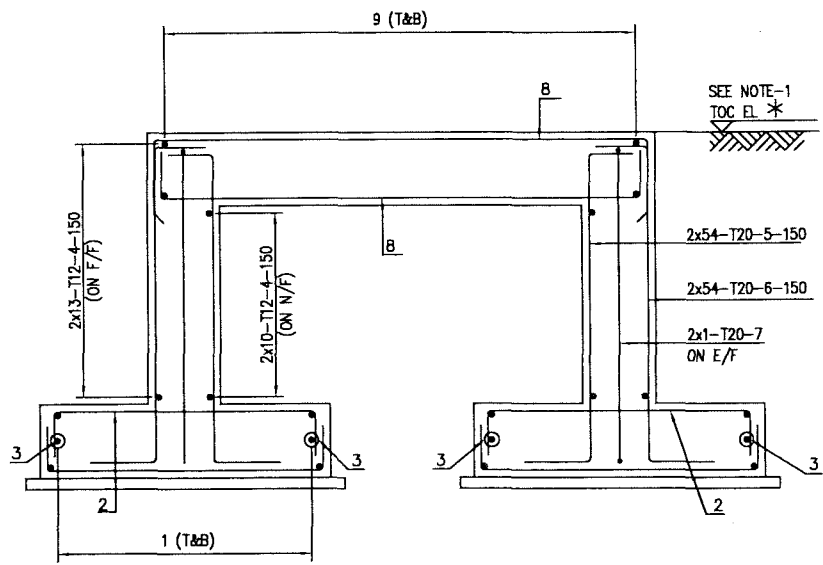

SECTION A-A

- NOTE :-**
1. TOC ELEVATION OF CULVERT MATCH WITH EXISTING GRADE ELEVATION
 2. POLYTHENE SHEET AND 50mm THK. KORK PACK TO BE PLACED INSTALL REINFORCEMENT & TOP SLAB CONCRETED.
 3. * CONTRACTOR SHALL VERIFY THE EXISTING BURIED PIPE LINE TOP ELEVATION. BEFORE PRIOR TO CONSTRUCTION.
 4. CONTRACTOR SHALL VERIFY EXISTING BURIED PIPE LINE TOP ELEVATION TO TOC ELEVATION OF CULVERT, IF VARIES SHOWN ON DRAWING. CONTRACTOR SHALL TAKE CARE OF CONCRETE QUANTITY & REBAR AT ACTUAL DIMENSION OF SITE CONDITION.

K. Amman
T A 2

APPROVED FOR CONSTRUCTION

NOTES				REFERENCE DRAWINGS				MASTER DRAWING REVISION				IN CASE OF DEVIATIONS MARKED UP PRINT SHALL BE SENT TO COASTAL DESIGN OFFICE			
1. ALL DIMENSIONS ARE IN MILLIMETRES AND LEVELS ARE IN METRES.				BBS				CONTRACT NO.: C31/0606 PROJ. NO.: PAIP 00405				PARSONS File name: W:\2_CIVIL\C-310606(EMC)\PAIP\PAIP00405_DQ\LAUNCHER AREA\21845001_DQ.dwg-GCS-27/02/11-10:00:27			
				STANDARD BAR SHAPE CODES				AREA : NIMR				SUB AREA : FIELD FACILITY			
				GEN. NOTES, LEGEND & ABBRE.-CONC				NO. 18				DESCRIPTION : CONCRETE STRUCTURE			
				PIPING GA.				DESCRIPTION : G.A & REINFORCEMENT DETAILS FOR ROAD CULVERT NO.5				NO. NIM 2 1845 001 DQ 1 A			

BAR BENDING SCHEDULE

JOB NO.: PAIP00405
PART ID.: FIELD FACILITY
CULVERT NO. 5

Document No.: NIM-2-1845-002-DQ-4

Revision No.: A

Prepared by: GCS

Checked by: PNG

Date: 27.02.11

REF. DWG NO.: NIM-2-1845-001-DO-1

Total MTO for Rebars.

Dia. Of Bar	T6	T8	T10	T12	T16	T20	T25	T32
Length of Bar (m)				1897.45		1097.50		
Weight (Kgs)				1688.74		2710.83		

Total Weight (Kgs)

4399.570

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[illegible]

This schedule complies with BS 8666 : 2005



All dimensions are in mm

Refer to Bar shape Code drawing


* Specified in multiples of 5 mm

† Specified in multiples of 25 mm


M.T.O.			
DESCRIPTION	QUANTITY	UNITS	SAP No.
CONCRETE GRADE 35	40.80	m ³	N.A.
BLINDING CONCRETE	1.90	m ³	N.A.
POLYTHENE SHEET 1000g	36.10	m ²	N.A.
PROTECTIVE COATING	133.60	m ²	N.A.
REINFORCEMENT STEEL	4399.57	kg	N.A.

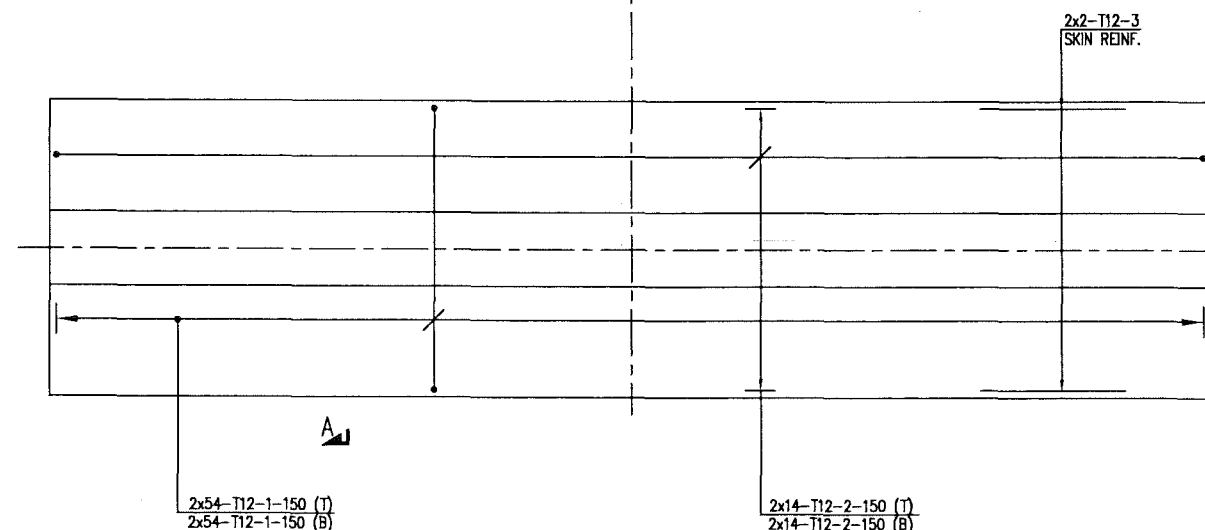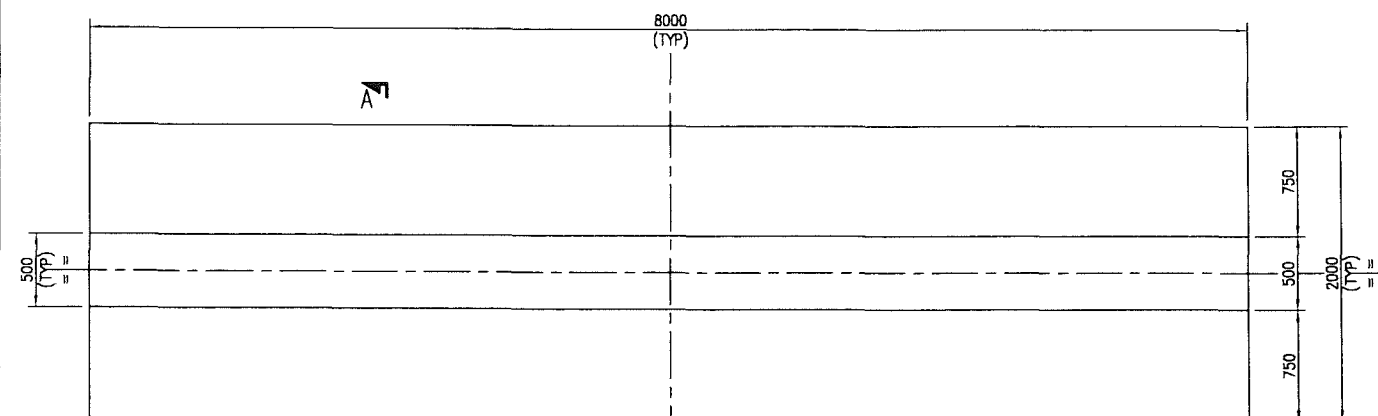


PLAN AT FOOTING LVL.

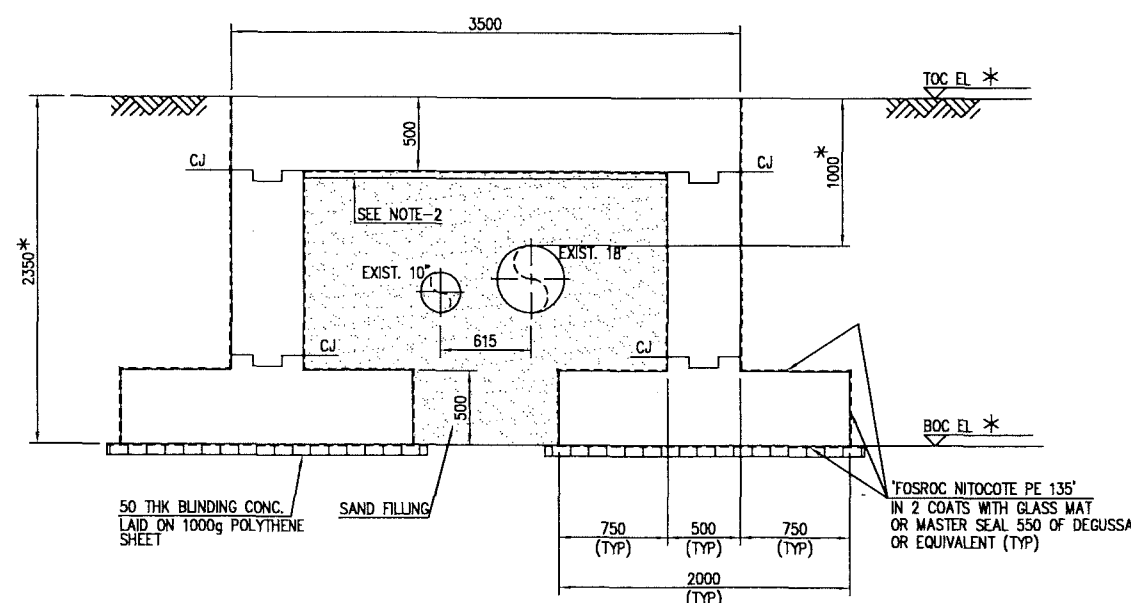

SECTION A-A

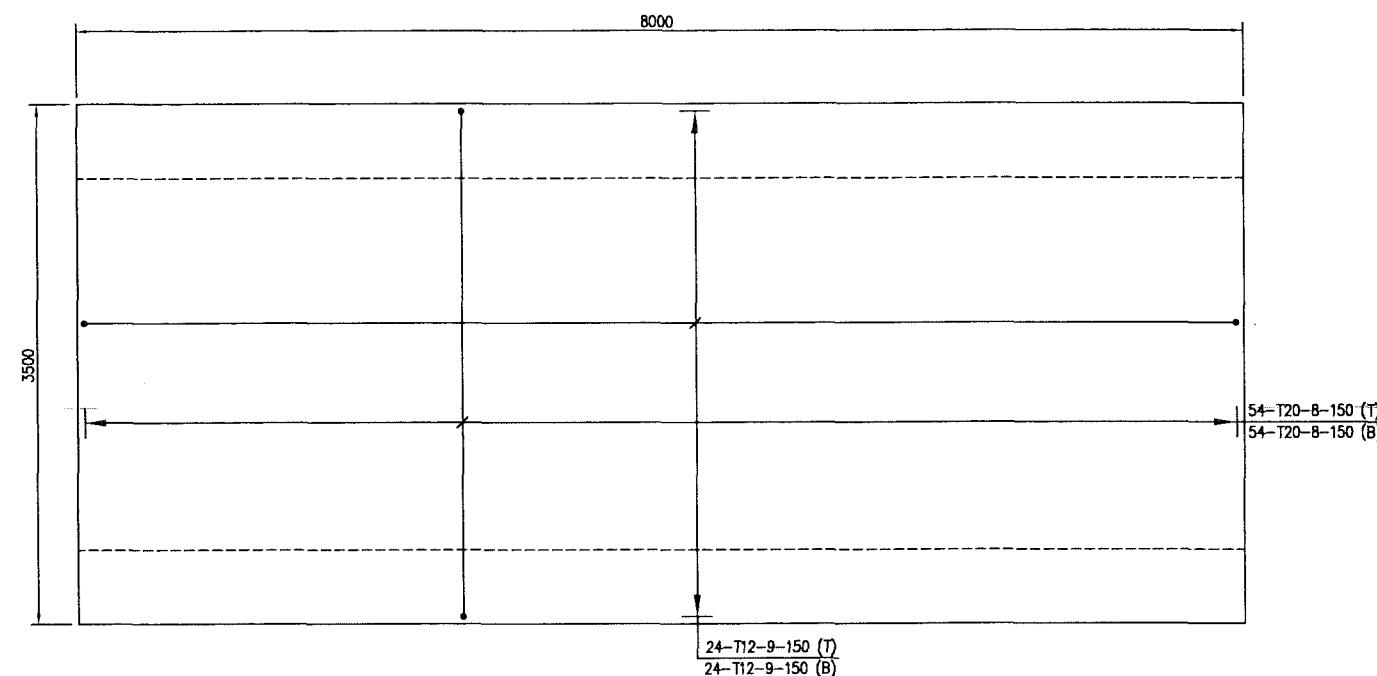

PLAN AT ROOF LVL.

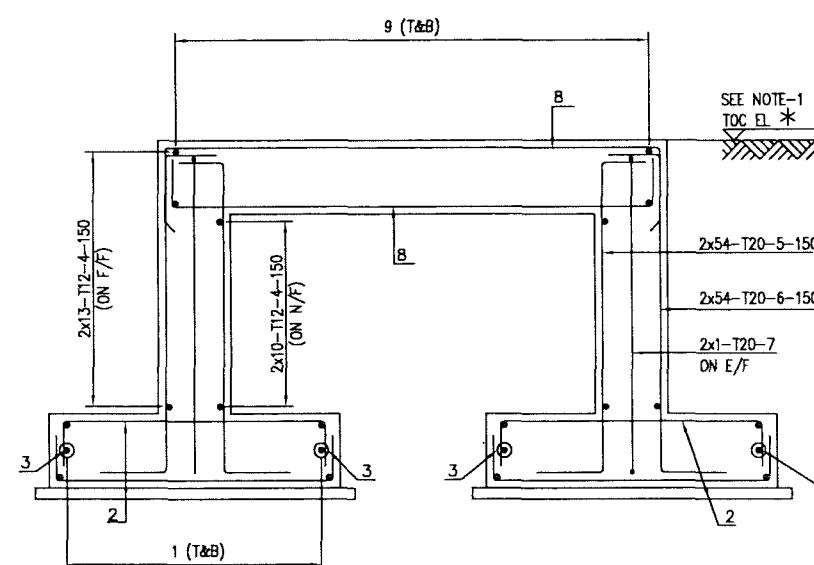


SECTION A-A

NOTE :-

1. TOC ELEVATION OF CULVERT MATCH WITH EXISTING GRADE ELEVATION
2. POLYTHENE SHEET AND 50mm THK. KORK PACK TO BE PLACED INSTALL REINFORCEMENT & TOP SLAB CONCRETED.
3. * CONTRACTOR SHALL VERIFY THE EXISTING BURIED PIPE LINE TOP ELEVATION. BEFORE PRIOR TO CONSTRUCTION.
4. CONTRACTOR SHALL VERIFY EXISTING BURIED PIPE LINE TOP ELEVATION TO TOC ELEVATION OF CULVERT. IF VARIES SHOWN ON DRAWING. CONTRACTOR SHALL TAKE CARE OF CONCRETE QUANTITY & REBAR AT ACTUAL DIMENSION OF SITE CONDITION
5. AFTER INSTALLATION & CONSTRUCTION OF CULVERT, CONTRACTOR FOUND THERE IS A ANY LEVEL DIFFERENCE TOP OF ROAD TO TOP OF CULVERT CONTRACTOR SHALL PROVIDE NECESSARY RAMP TO TOP OF CULVERT TO TOP OF ROAD
6. CONTRACTOR SHALL MAINTAIN THE RAMP SLOP 1:10 SIDE SLOPE SHALL BE 1:2
7. RAMP FILLING MATERIAL SHALL BE IN ACCORDANCE WITH PDO ERD-17-01 PART-S

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APPROVED FOR
CONSTRUCTION

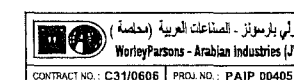

CONTRACT NO.: C31/0606 PROJ. NO.: PAIP 00405

REV	DATE	BY	CHECKED	DESCRIPTION	ISS NO	PROJ. ENG.	SIGNATURE
A	27.02.11	GCS	OK	APPROVED FOR CONSTRUCTION	IN.09.011	OSE/28N	
D	26.02.11	GCS	OK	ISSUED FOR COMMENTS	IN.09.011	OSE/28N	

PROJECT DRAWING REVISION
IN CASE OF DEVIATIONS A MARKED UP PRINT SHALL BE SENT TO THE PROJECT ENGINEER

AREA	NO.	DESCRIPTION	DATE	BY	CHECKED	PROJ. ENG.	SIGNATURE
NIMR	16	FIELD FACILITY					
CONCRETE STRUCTURE							
G.A & REINFORCEMENT DETAILS FOR ROAD CULVERT NO.2A							

DESCRIPTION	AREA	SERIAL	SH	P	S	REV	DATE	APPROVED BY	DESCRIPTION	REVISION	PROJ. ENG.	SIGNATURE
BBS	NIM	2	1845	004	DQ	4						
STANDARD BAR SHAPE CODES	NIM	2	1841	005	DQ	3						
GEN. NOTES, LEGEND & ABBRE.-CONC	NIM	2	1841	001	DQ	3						
PIPING GA.	NIM	2	2126	011	DQ	1						

1. ALL DIMENSIONS ARE IN MILLIMETRES AND LEVELS ARE IN METRES.

NOTES REFERENCE DRAWINGS MASTER DRAWING REVISION IN CASE OF DEVIATIONS MARKED UP PRINT SHALL BE SENT TO COASTAL DESIGN OFFICE

BAR BENDING SCHEDULE

JOB NO.: PAIP00405
PART ID.: FIELD FACILITY
CULVERT NO. 2A

Document No.: NIM-2-1845-004-DQ-4

Revision No.: A

Prepared by: GCS

Checked by: PNG

Date: 27.02.11

REF. DWG NO.: NIM-2-1845-003-DO-1

Total MTO for Rebars.

Dia. Of Bar	T6	T8	T10	T12	T16	T20	T25	T32
Length of Bar (m)				1897.45		1097.50		
Weight (Kgs)				1688.74		2710.83		

1	2	3	100
Total Weight (Kgs)																																																																																																			

4399.570

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[illegible]


This schedule complies with BS 8666 : 2005

All dimensions are in mm

Refer to Bar shape Code drawing

* Specified in multiples of 5 mm


† Specified in multiples of 25 mm

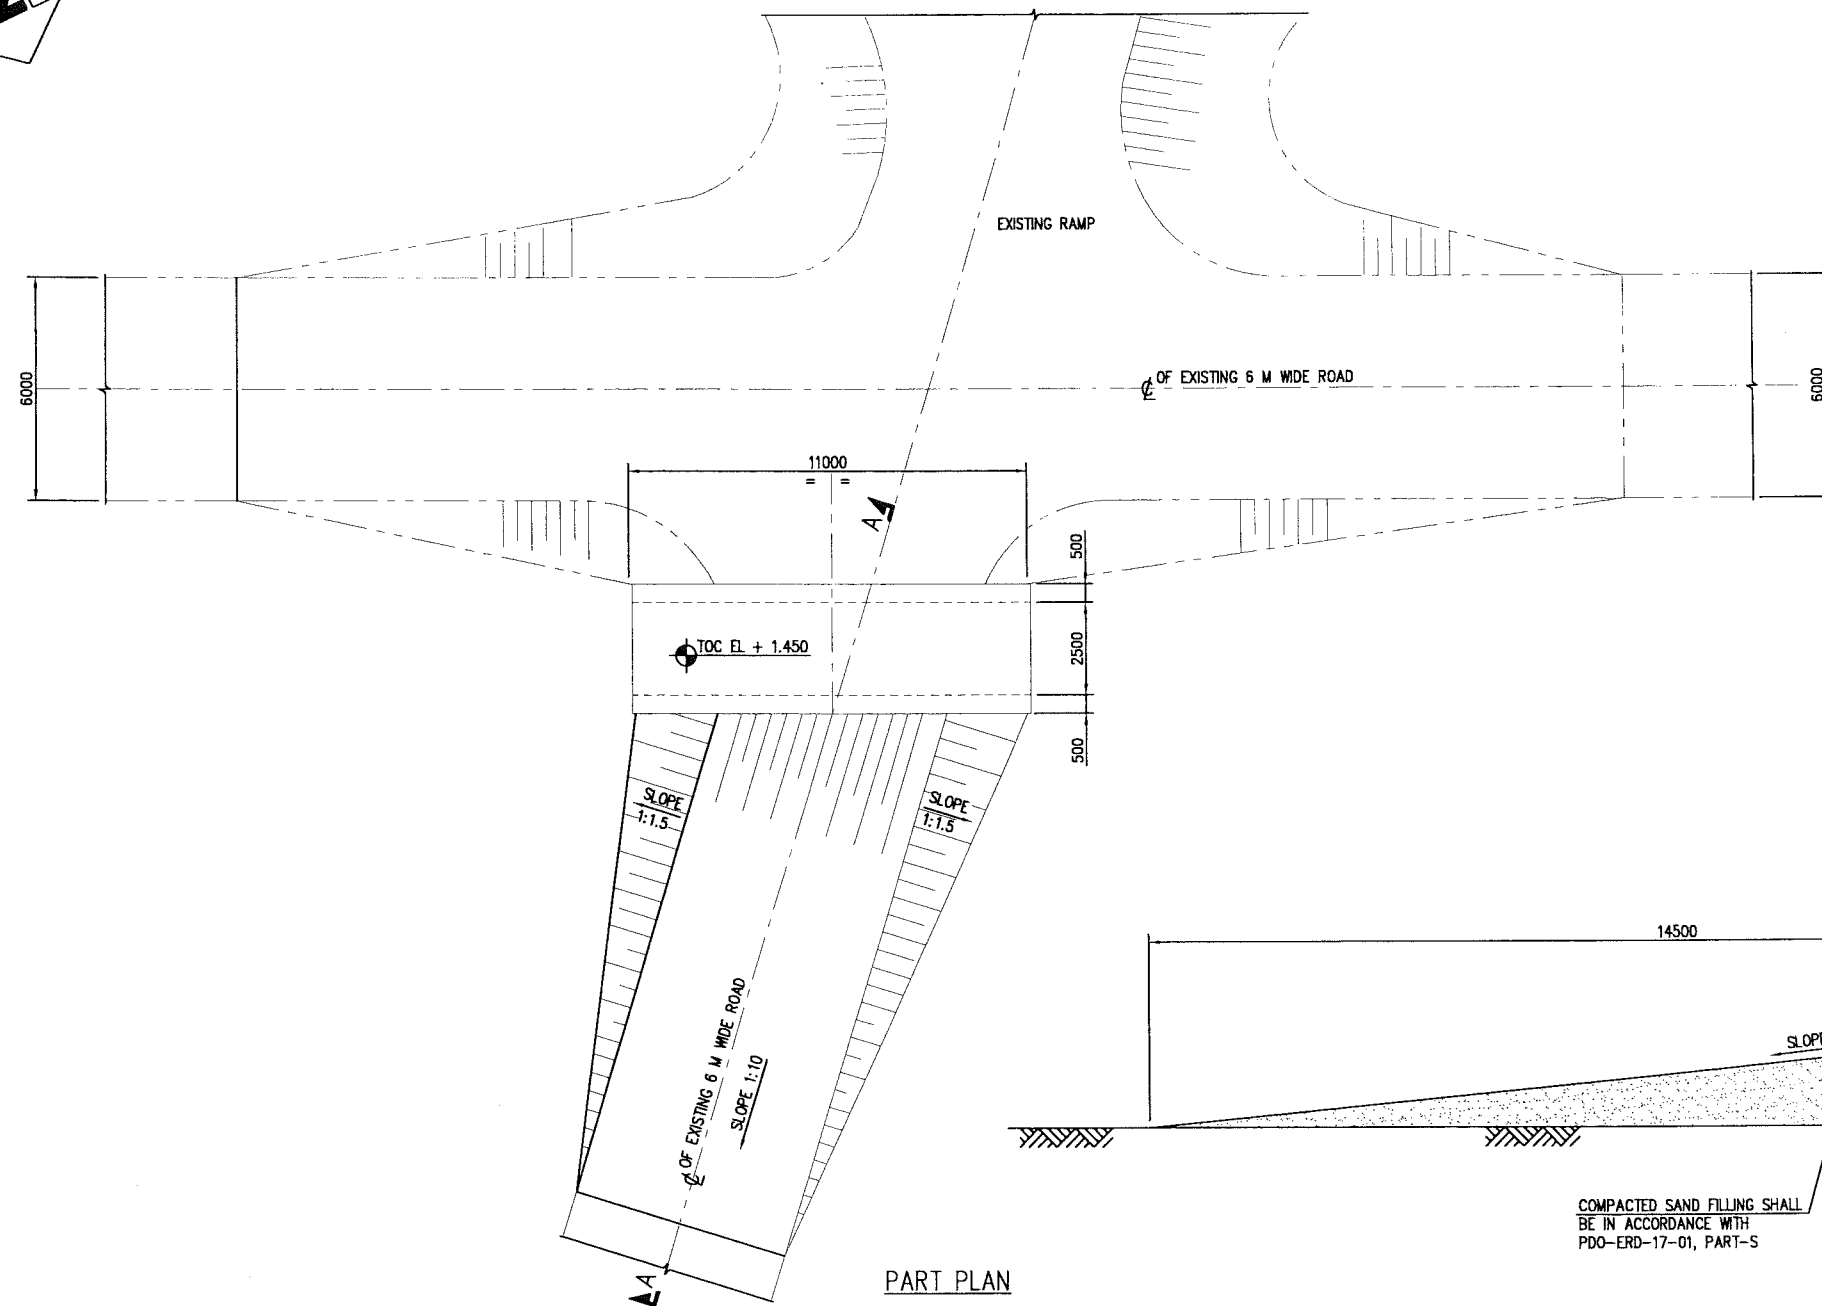

NOTE :-
CONTRACTORS FOUND ANY LEVEL DIFFERENCE BETWEEN TOP OF CULVERT TO EXISTING RAMP. CONTRACTOR SHALL BE DONE, FILLING TO MATCH WITH TOP OF CULVERT.

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APPROVED FOR CONSTRUCTION

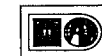

WorleyParsons - Arabian Industries (WPI)

CONTRACT NO: C31/0606 PROJ NO: PAIP 00405

REV	DATE	DRWN BY	TEAM	LEAD	CHECKED	DESCRIPTION	ISS NO	PROJ. ENR.	SIGNATURE
A	27.02.11	GCS	KBR	CSB		APPROVED FOR CONSTRUCTION	IN.09.011	OSE/2BN	
0	26.02.11	GCS	KBR	CSB		ISSUED FOR COMMENTS	IN.09.011	OSE/2BN	

PROJECT DRAWING REVISION
IN CASE OF DEVIATIONS A MARKED UP PRINT SHALL BE SENT TO THE PROJECT ENGINEER

AREA	NIMR	SCALE	1:100	CAD DRAWING
SUB AREA	FIELD FACILITY	NO.	16	
DESCRIPTION	LAYOUT	NO.	NIM 2 1845 005 DQ 1 A	

1. ALL DIMENSIONS ARE IN MILLIMETRES AND LEVELS ARE IN METRES.

NOTES


REFERENCE DRAWINGS

MASTER DRAWING REVISION


IN CASE OF DEVIATIONS MARKED UP PRINT SHALL BE SENT TO COASTAL DESIGN OFFICE

PARSONS File name: W:\2_CIVIL\C-310606(EMC)\PAIP\PAIP00405_DQ\LAUNCHER AREA\21845005_DQ.dwg-GCS-27/02/11-10:00:29


M.T.O.			
DESCRIPTION	QUANTITY	UNITS	SAP No.
CONCRETE GRADE 35	55.83	m ³	N.A.
BLINDING CONCRETE	2.50	m ³	N.A.
POLYTHENE SHEET 1000g	49.30	m ²	N.A.
PROTECTIVE COATING	157.70	m ²	N.A.
REINFORCEMENT STEEL	6199.80	kg	N.A.

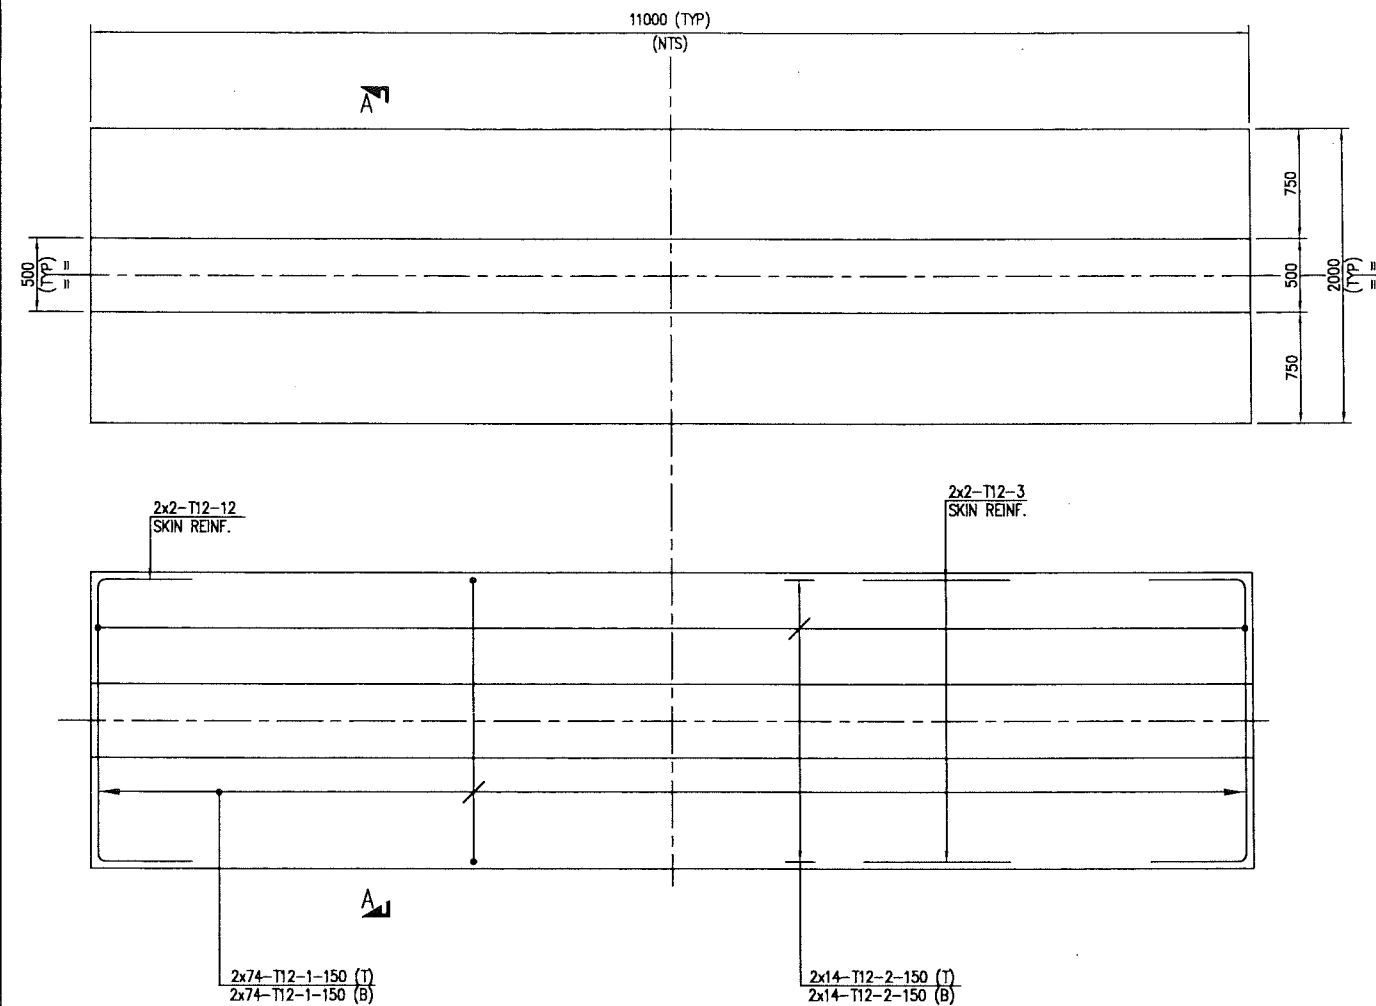


PLAN AT FOOTING LVL.

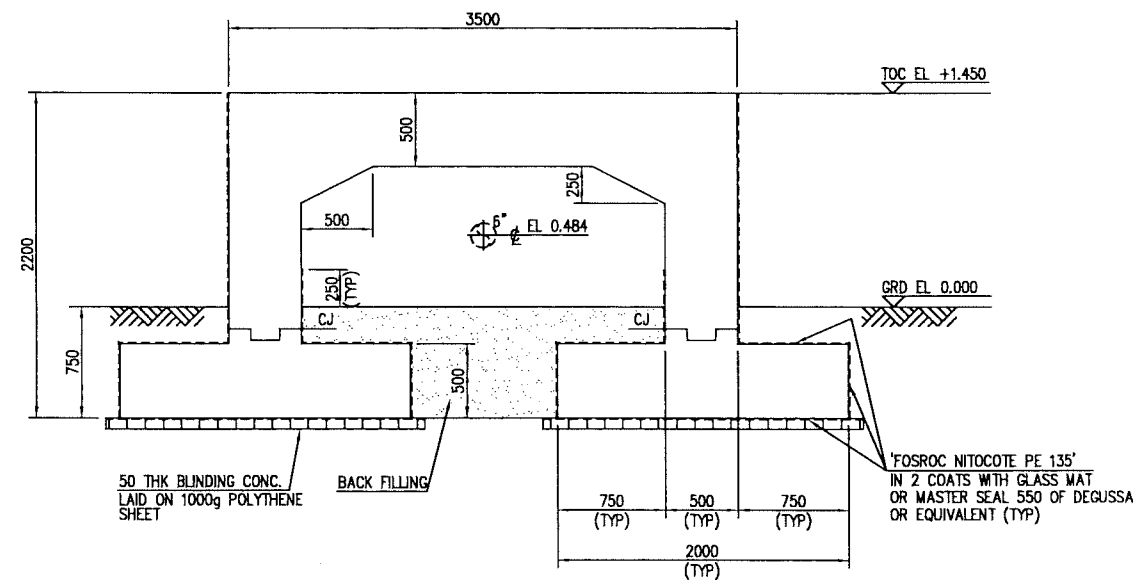

SECTION A-A

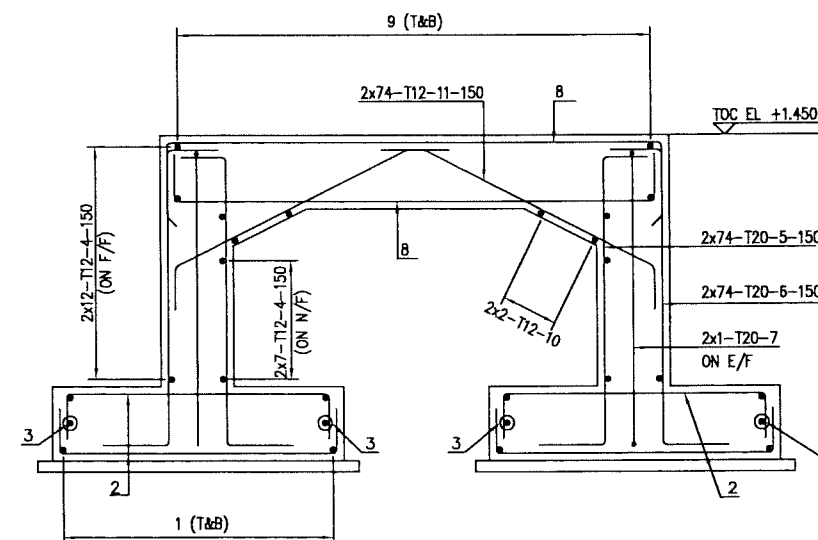

SECTION A-A

A	27.02.11	GCS		APPROVED FOR CONSTRUCTION		In.09.01	OSE /ZBN						
A	28.02.11	GCS	KBR GSB	ISSUED FOR COMMENTS		In.09.01	OSE /ZBN						
REV	DATE	DRAWN BY	TEAM LEAD. CHECKED	DESCRIPTION	WBS NO	PICAL ENGR.	SIGNATURE P.D.O APPROVAL						
PROJECT DRAWING REVISION													
05	IN CASE OF DEVIATIONS A MARKED UP PRINT SHALL BE SENT TO THE PROJECT ENGINEER												
AREA		.NIMR			NO. 16	SCALE : 1:25 0 1 2 3 4 5 6 7 CAD DRAWING							
SUB AREA		.FIELD FACILITY				شركة تنمية نفط عمان Petroleum Development Oman							
DRNG TYPE		.CONCRETE STRUCTURE				Petrolium Development Oman							
DESCRIPTION		.G.A & REINFORCEMENT DETAILS FOR ROAD CULVERT NO.1				DRNG	AREA CODE	END DIST	SIGNAL NUMBER	SHEET	PICAL CODE	SIZE	REV.
					NO	NIM	2	1845	006DQ	1	A		

	BBS
	G.A. OF CULVERT NO. 1
	STANDARD BAR SHAPE CODES
	GEN.NOTES, LEGEND & ABBRE.-CONC
	PIPING GA.
2. ALL EXPOSED CONCRETE SURFACES SHALL BE TREATED WITH TWO COATS OF "FOSROC DEXGUARD S" WITH A DFT OF 350 MICRONS OR ANY OTHER	
1. ALL DIMENSIONS ARE IN MILLIMETRES AND LEVELS ARE IN METRES.	
NOTES	
	DESCRIPTION
	REFERENCE DRAWING


 لي. بارسونز - الصناعات العربية (مخاصة)
 WorleyParsons - Arabian Industries (J)

CONTRACT NO.: C31/0606 PROJ. NO.: PAIP 00405

CONTRACT NO.: C31/0606	PROJ. NO.: PAIP 00405
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		PROLONG	SPEED
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	REC'D.	FOO APPROVAL
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REVISION
BY UNIT OR COASTAL DEFENSE OFFICE

PARSONS FILE NAME: W\2 CIVIL\C

PARSONS FILE NUMBER: W. 22-0116 (C)

BAR BENDING SCHEDULE

JOB NO.: PAIP00405
PART ID.: FIELD FACILITY
CULVERT NO. 1

Document No.: NIM-2-1845-007-DQ-4

Revision No.: A

Prepared by: GCS

Checked by: PNG RR

Date: 27.02.11

REF. DWG NO.: NIM-2-1845-006-DQ-1

Total MTO for Rebars.

Dia. Of Bar	T6	T8	T10	T12	T16	T20	T25	T32
Length of Bar (m)				2887.75		1469.50		
Weight (Kgs)				2570.10		3629.67		

1	2	3	100
Total Weight (Kgs)																																																																																																			

6199.770

1c. Murren
-A2

[illegible]


This schedule complies with BS 8666 : 2005

All dimensions are in mm

Refer to Bar shape Code drawing

* Specified in multiples of 5 mm

† Specified in multiples of 25 mm

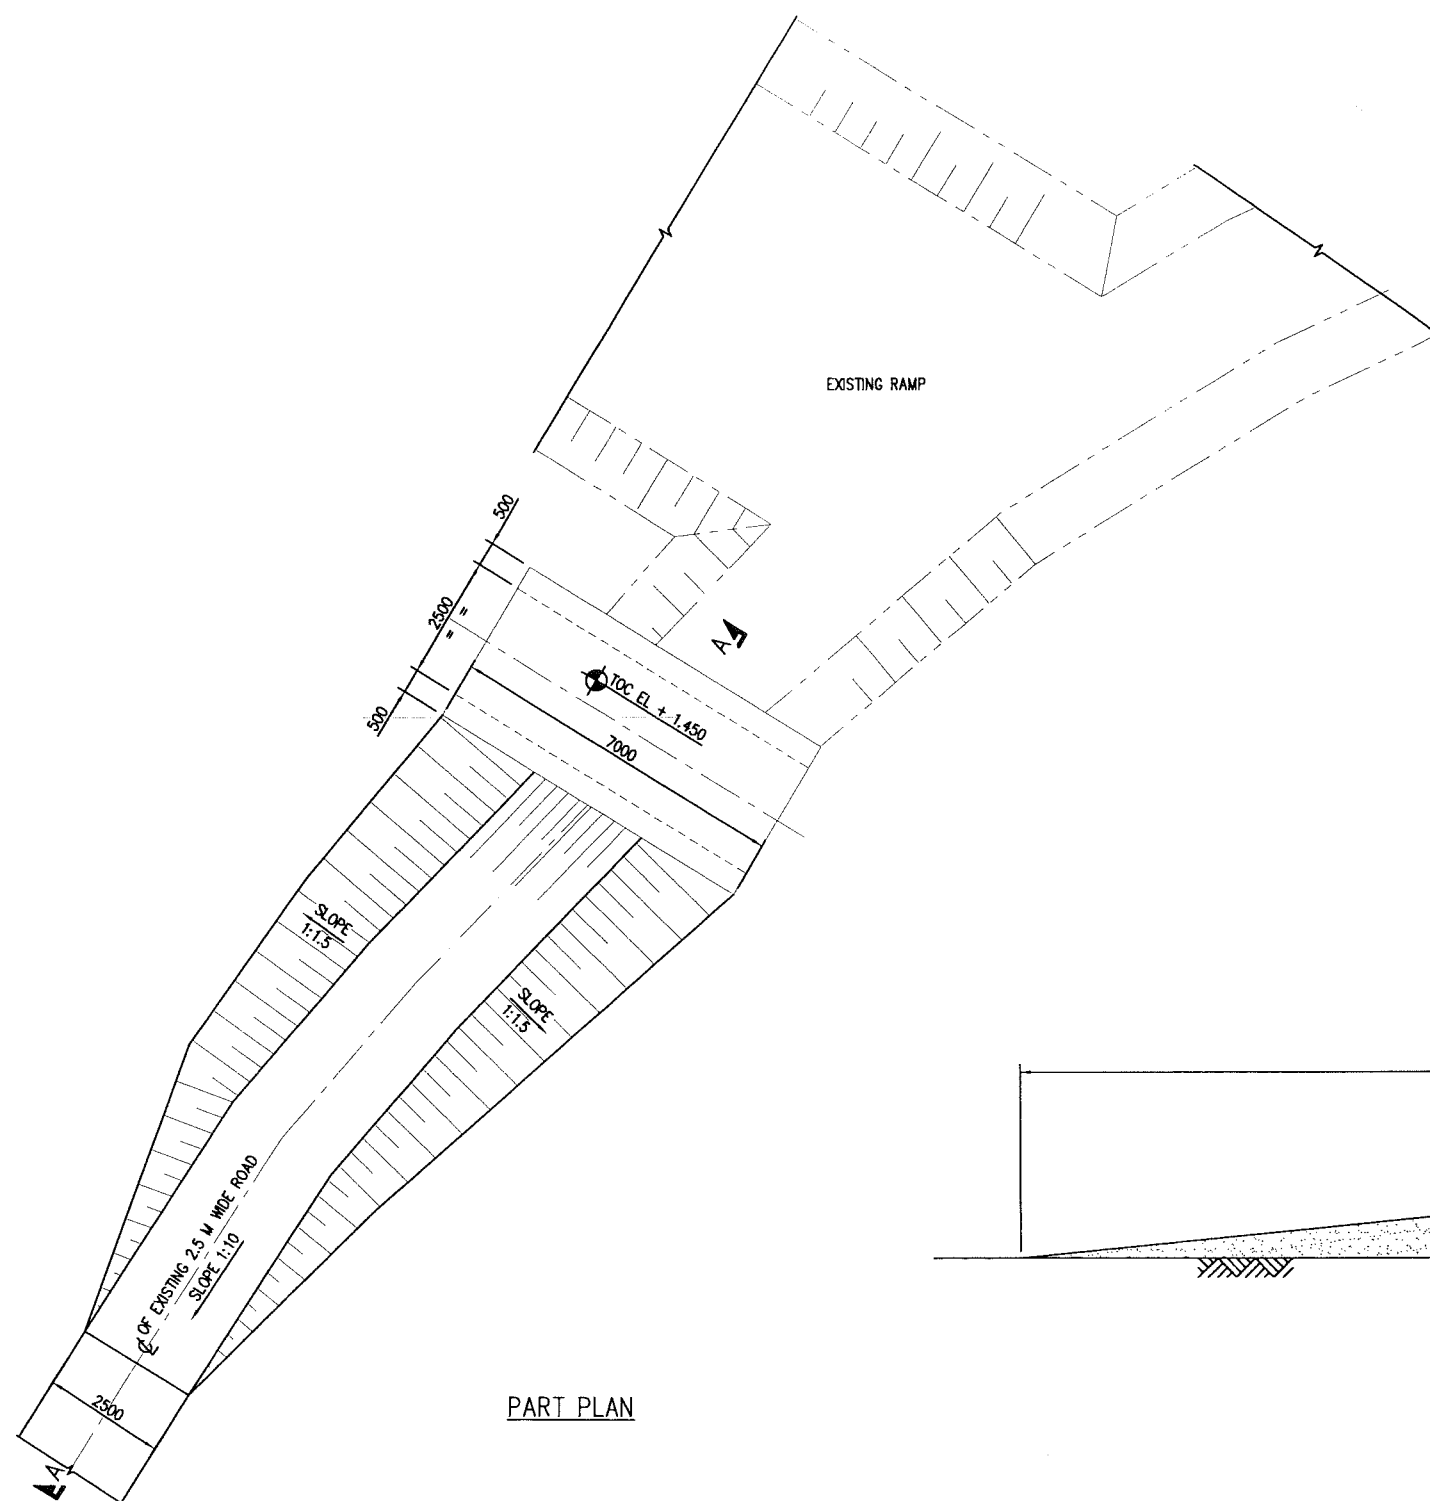

14500

SLOPE 1:10

SEE NOTE

TOC EL. +1.450

GRD EL. 0.000

COMPACTED SAND FILLING SHALL BE IN ACCORDANCE WITH PDO-ERD-17-01, PART-S

BACK FILLING

NOTE :-
CONTRACTORS FOUND ANY LEVEL DIFFERENCE BETWEEN TOP OF CULVERT TO EXISTING RAMP. CONTRACTOR SHALL BE DONE, FILLING TO MATCH WITH TOP OF CULVERT.

APPROVED FOR
CONSTRUCTION

	A	27.02.11	GCS	KBR	ISSUED FOR CONSTRUCTION	IN.09.011	OSE/28N		
	O	28.02.11	GCS	KBR	ISSUED FOR COMMENTS	IN.09.011	OSE/28N		
REV	DATE	DRAWN BY	TEAM	JUDG.	DESCRIPTION	REV NO	PRIOR. EXCL.	SIGNATURE	

 رولي بارسونز - الصناعات العربية (محصصة)
 WorleyParsons - Arabian Industries (JV)

PROJECT DRAWING REVISION

IN CASE OF DEVIATIONS A MARKED UP PRINT SHALL BE SENT TO THE PROJECT ENGINEER

SCALE : 1:100	CAD DRAWING
0 1 2 3 4 5 6	

AREA	: NIMR		
SUB AREA	: FIELD FACILITY	NO. 16	شركة تنمية نفط عمان

	LAYOUT	Petroleum Development Oman
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DATE	DRWG TYPE	TEXT	DRWG	AREA	ENG	SERIAL	SHEET	PROJ	DRWG	RE
					NO	NO		CODE	NO	
		C A. OF CULVERT NO. 2								

DESCRIPTION	G.A. OF COVERT NO. 2	NO	NIM 2 1845 008DQ 1	A
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1. ALL DIMENSIONS ARE IN MILLIMETRES AND LEVELS ARE IN METRES.

NOTES

REFERENCE DRAWINGS

MASTER DRAWING REVISION

IN CASE OF DEVIATIONS MARKED UP PRINT SHALL BE SENT TO COASTAL DESIGN OFFICE

PARSONS File name: W:\2_CIVIL\C-310606(EMC)\PAIP\PAIP00405_DQ\LAUNCHER AREA\21845008_DQ.dwg-GCS-27/02/11-10:00:31

BAR BENDING SCHEDULE

JOB NO.: PAIP00405
PART ID.: FIELD FACILITY
CULVERT NO. 2

Document No.: NIM-2-1845-010-DQ-4

Revision No.: A

Prepared by: GCS

Checked by: PNG *PR*

Date: 27.02.11

REF. DWG NO.: NIM-2-1845-009-DQ-1

Total MTO for Rebars.

Dia. Of Bar	T6	T8	T10	T12	T16	T20	T25	T32
Length of Bar (m)				1869.15		937.60		
Weight (Kgs)				1663.55		2315.88		

Total Weight (Kgs)

3979.430

1c. Answer
TA2

[illegible]

This schedule complies with BS 8666 : 2005

All dimensions are in mm

Refer to Bar shape Code drawing

* Specified in multiples of 5 mm

† Specified in multiples of 25 mm

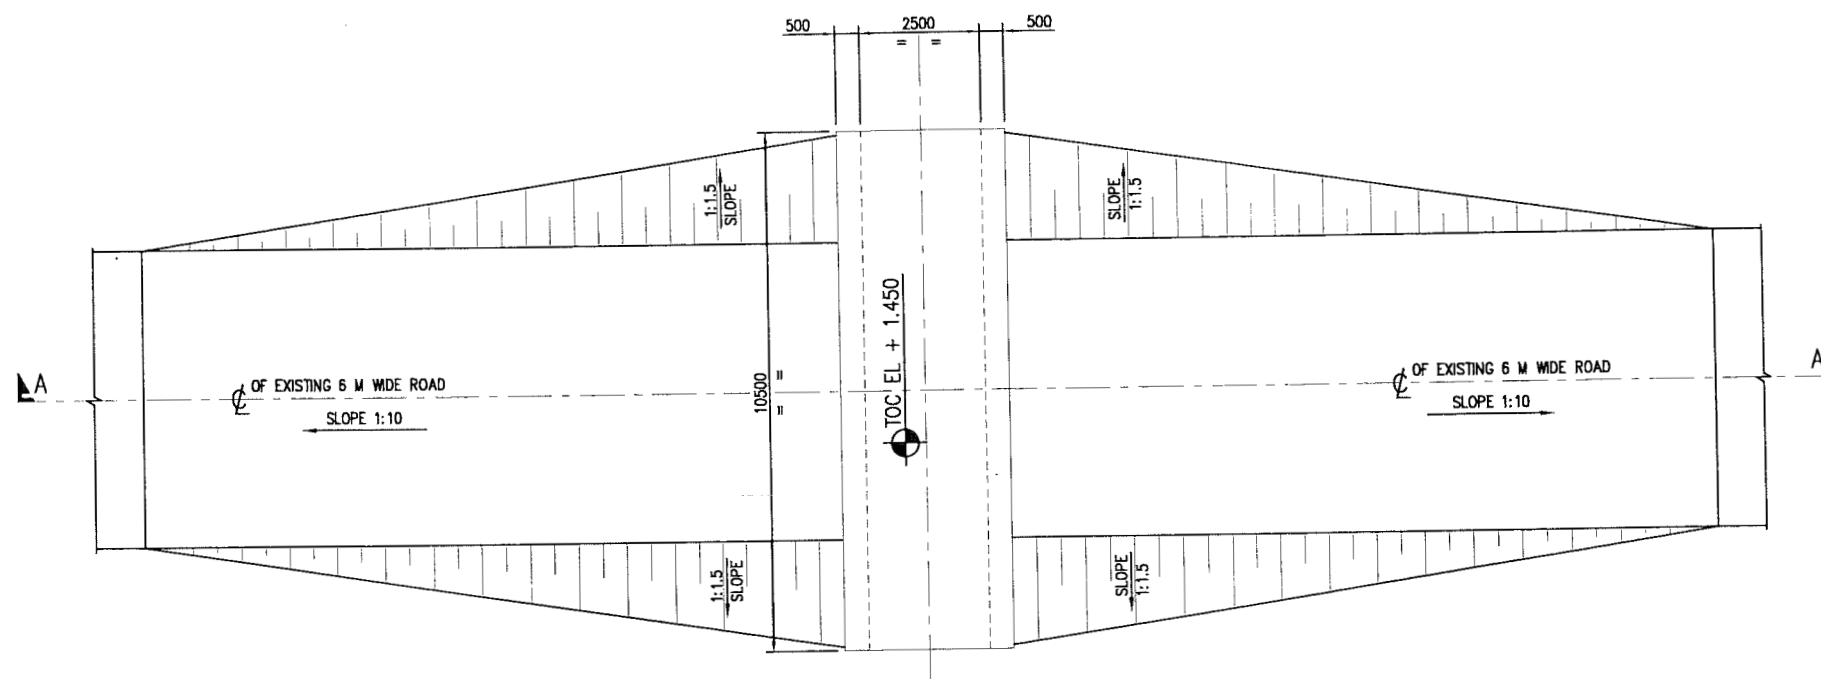


Diagram illustrating the cross-section of a bridge structure. The structure is symmetrical, with a central pier and two side slopes. The total width of the structure is 14500. The central pier has a width of 500. The side slopes are labeled "SLOPE 1:10". The top of the structure is labeled "TOC EL. +1.450". The ground level is labeled "GRD EL. 0.00". The structure is supported by a foundation, with "BACK FILLING" indicated below the pier. A note specifies: "COMPACTED SAND FILLING SHALL BE IN ACCORDANCE WITH PDO-ERD-17-01, PART-S".



	A	27.02.11	GCS	XBR	GSB	APPROVED FOR CONSTRUCTION	IN.09.011	OSE /ZBN
	D	26.02.11	GCS	XBR	GSB	ISSUED FOR COMMENTS	IN.09.011	OSE /ZBN
REV	DATE	DESCRIPTION	TEAM	JEDG.	DESCRIPTION	ISS NO	P.D.O APPROVAL	SIGNATURE

APPROVED FOR
CONSTRUCTION

11. Muner
TA2

[illegible]

405	IN CASE OF DEVIATIONS A MARKED UP PRINT SHALL BE SENT TO THE PROJECT ENGINEER	SCALE: 1:75	CAD DRAWING
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AREA : NIMR

FIELD FACILITY NO. 16  وزارة النفط عجمان

AMOUNT		Petroleum Development Om	
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DWG	DWG TYPE	AREA	DWG NO	SHEET NO	PROJ CODE	DWG NO
1	LAYOUT					

DESCRIPTION	G.A. OF CULVERT NO. 3 & 4	NO	NIM 2 1845 011 DQ 1
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\\C-310606(EMC)\PAIP\PAIP00405_DQ\LAUNCHER AREA\21845011_DQ.dwg-GCS-27/02/11-10:00

1. ALL DIMENSIONS ARE IN MILLIMETRES AND LEVELS ARE IN METRES.

NOTES


REFERENCE DRAWINGS

		BY			
MASTER DRAWING REVISION					
IN CASE OF DEVIATIONS MARKED UP PRINT SHALL BE SENT TO COASTAL DESIGN OFFICE					


BE SENT TO COASTAL DESIGN OFFICE

PARSONS File name: W:\2_CIVIL\C-310606(EMC)\PAIP\PAIP00405_DQ\LAUNCHER AREA\21845011_DQ.dwg-GCS-27/02/11-10:00:33


M.T.O.			
DESCRIPTION	QUANTITY	UNITS	SAP No.
CONCRETE GRADE 35	106.60	m ³	N.A.
BLINDING CONCRETE	4.80	m ³	N.A.
POLYTHENE SHEET 1000g	94.20	m ²	N.A.
PROTECTIVE COATING	300.60	m ²	N.A.
REINFORCEMENT STEEL	11891.70	kg	N.A.

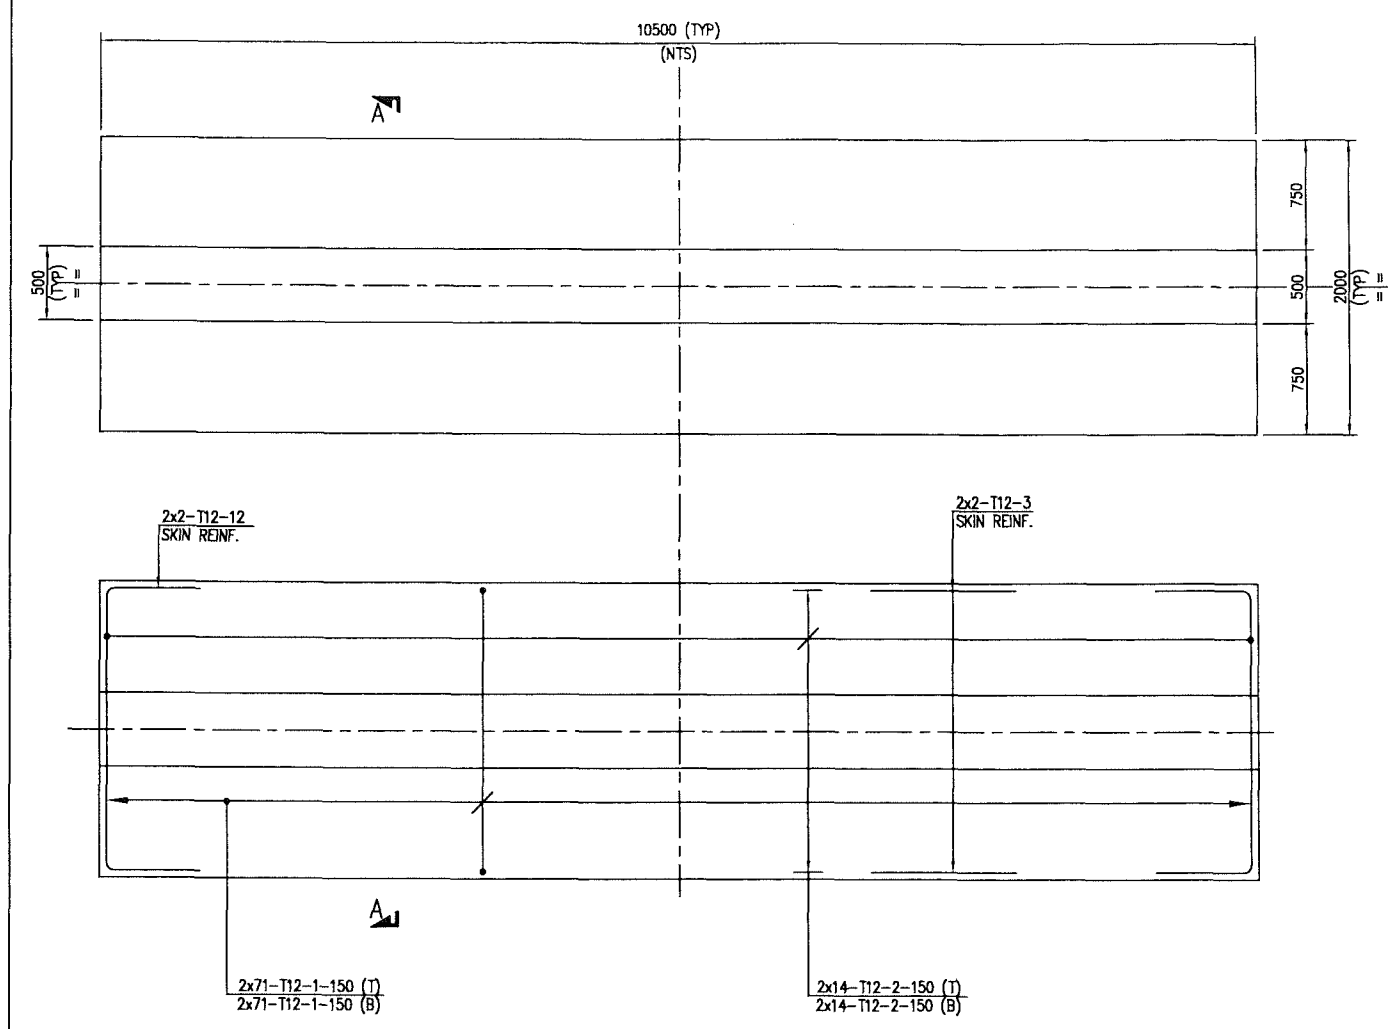


PLAN AT FOOTING LVL
(2 Nos. REQD)

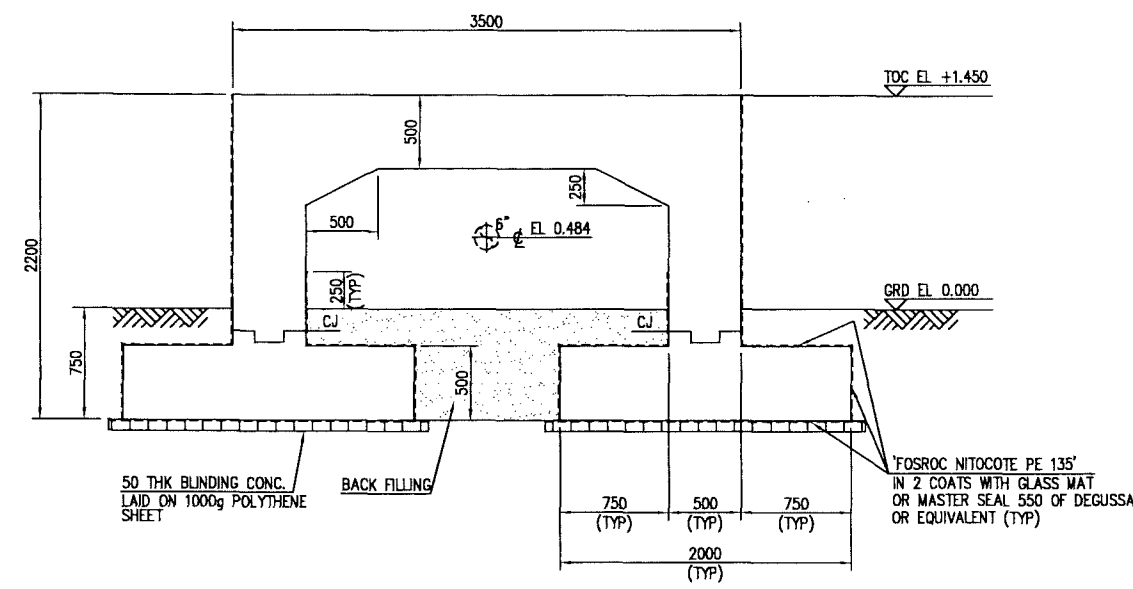

SECTION A-A

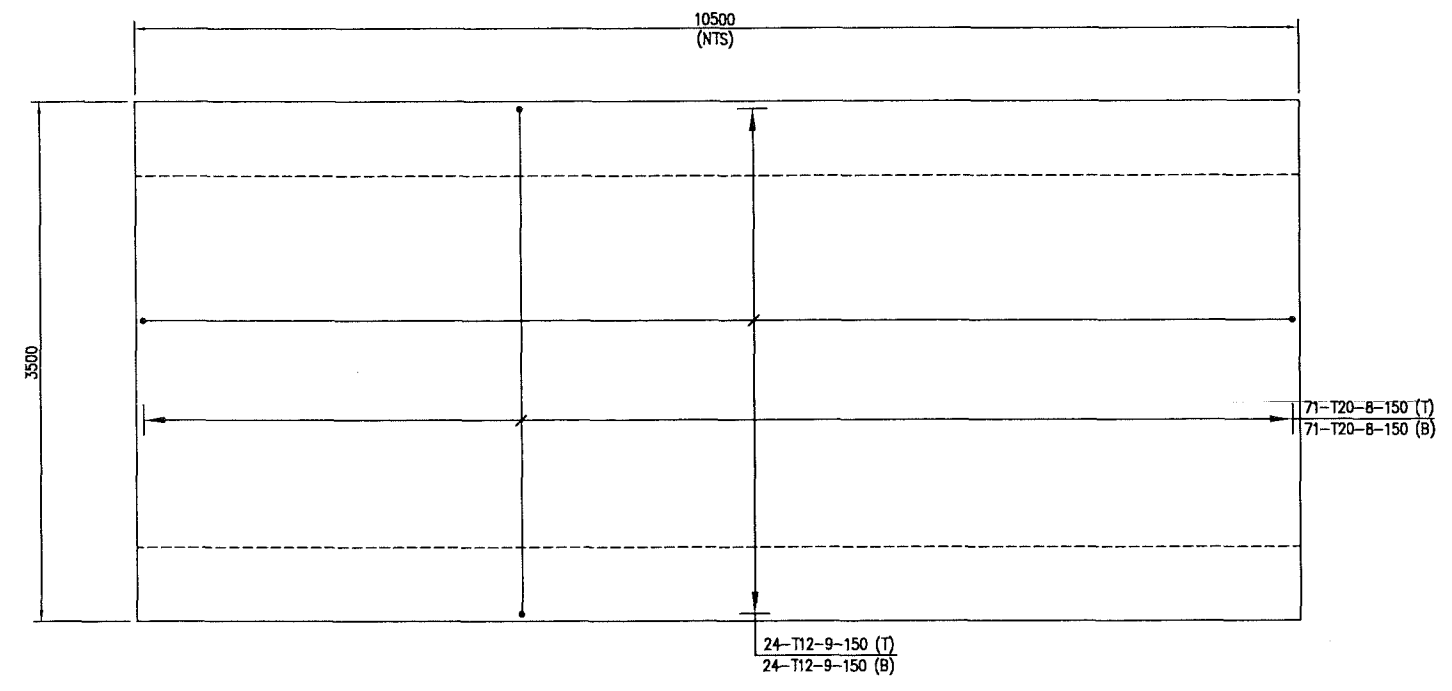

PLAN AT ROOF LVL

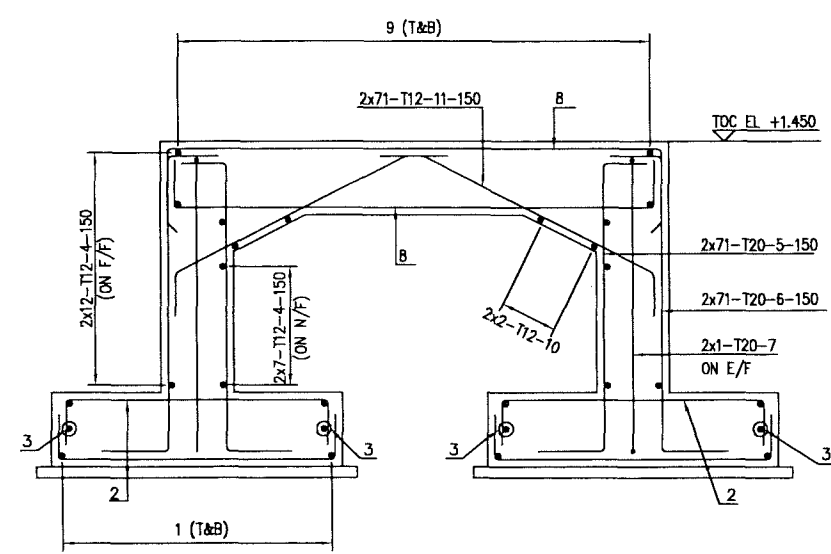

SECTION A-A

NOTES

2. ALL EXPOSED CONCRETE SURFACES SHALL BE TREATED WITH TWO COATS OF "FOSROC DEKGUARD S" WITH A DFT OF 350 MICRONS OR ANY OTHER

1. ALL DIMENSIONS ARE IN MILLIMETRES AND LEVELS ARE IN METRES.

DESCRIPTION	AREA	SERIAL	SH	P	REV	DATE	APPROVED BY	DESCRIPTION	REVISION	DATE	APPROVED BY	DESCRIPTION	REVISION	DATE	APPROVED BY
BBS															
G.A. OF CULVERT NO. 3 & 4															
STANDARD BAR SHAPE CODES															
GEN. NOTES, LEGEND & ABBRE.-CONC															
PIPING GA.															

DESCRIPTION	AREA	SERIAL	SH	P	REV	DATE	APPROVED BY	DESCRIPTION	REVISION	DATE	APPROVED BY	DESCRIPTION	REVISION	DATE	APPROVED BY

DESCRIPTION	AREA	SERIAL	SH	P	REV	DATE	APPROVED BY	DESCRIPTION	REVISION	DATE	APPROVED BY	DESCRIPTION	REVISION	DATE	APPROVED BY

REV	DATE	DESIGNED BY	CHECKED	APPROVED	DESCRIPTION	NO.	DATE	APPROVED	DESCRIPTION
A	27.02.11	GCS			APPROVED FOR CONSTRUCTION	IN.09.011	OSE/28N		
O	26.02.11	GCS	KBR	GSR	ISSUED FOR COMMENTS	IN.09.011	OSE/28N		

PROJECT DRAWING REVISION

IN CASE OF DEVIATIONS A MARKED UP PRINT SHALL BE SENT TO THE PROJECT ENGINEER

AREA : NIMR

SUB AREA : FIELD FACILITY

NO. 16

SCALE : 1:25

CAD DRAWING

CONCRETE STRUCTURE


G.A. & REINFORCEMENT DETAILS FOR ROAD CULVERT NO.3 & 4

NO. NIM 2 1845 012 DQ 1 A

CONTRACT NO. : C31/0605 PROJ. NO. : PAIP 00405

BAR BENDING SCHEDULE

JOB NO.: PAIP00405
PART ID.: FIELD FACILITY
CULVERT NO. 3 & 4

Document No.: NIM-2-1845-013-DQ-4
Revision No.: A
Prepared by: GCS
Checked by: PNG 
Date: 27.02.11

REF. DWG NO.: NIM-2-1845-012-DQ-1

Total MTO for Rebars.

Dia. Of Bar	T6	T8	T10	T12	T16	T20	T25	T32
Length of Bar (m)				5532.90		2820.80		
Weight (Kgs)				4924.29		6967.38		

Total Weight (Kgs)

11891.670

10. Murren
TA2

[illegible]


This schedule complies with BS 8666 : 2005


All dimensions are in mm

Refer to Bar shape Code drawing


* Specified in multiples of 5 mm

† Specified in multiples of 25 mm

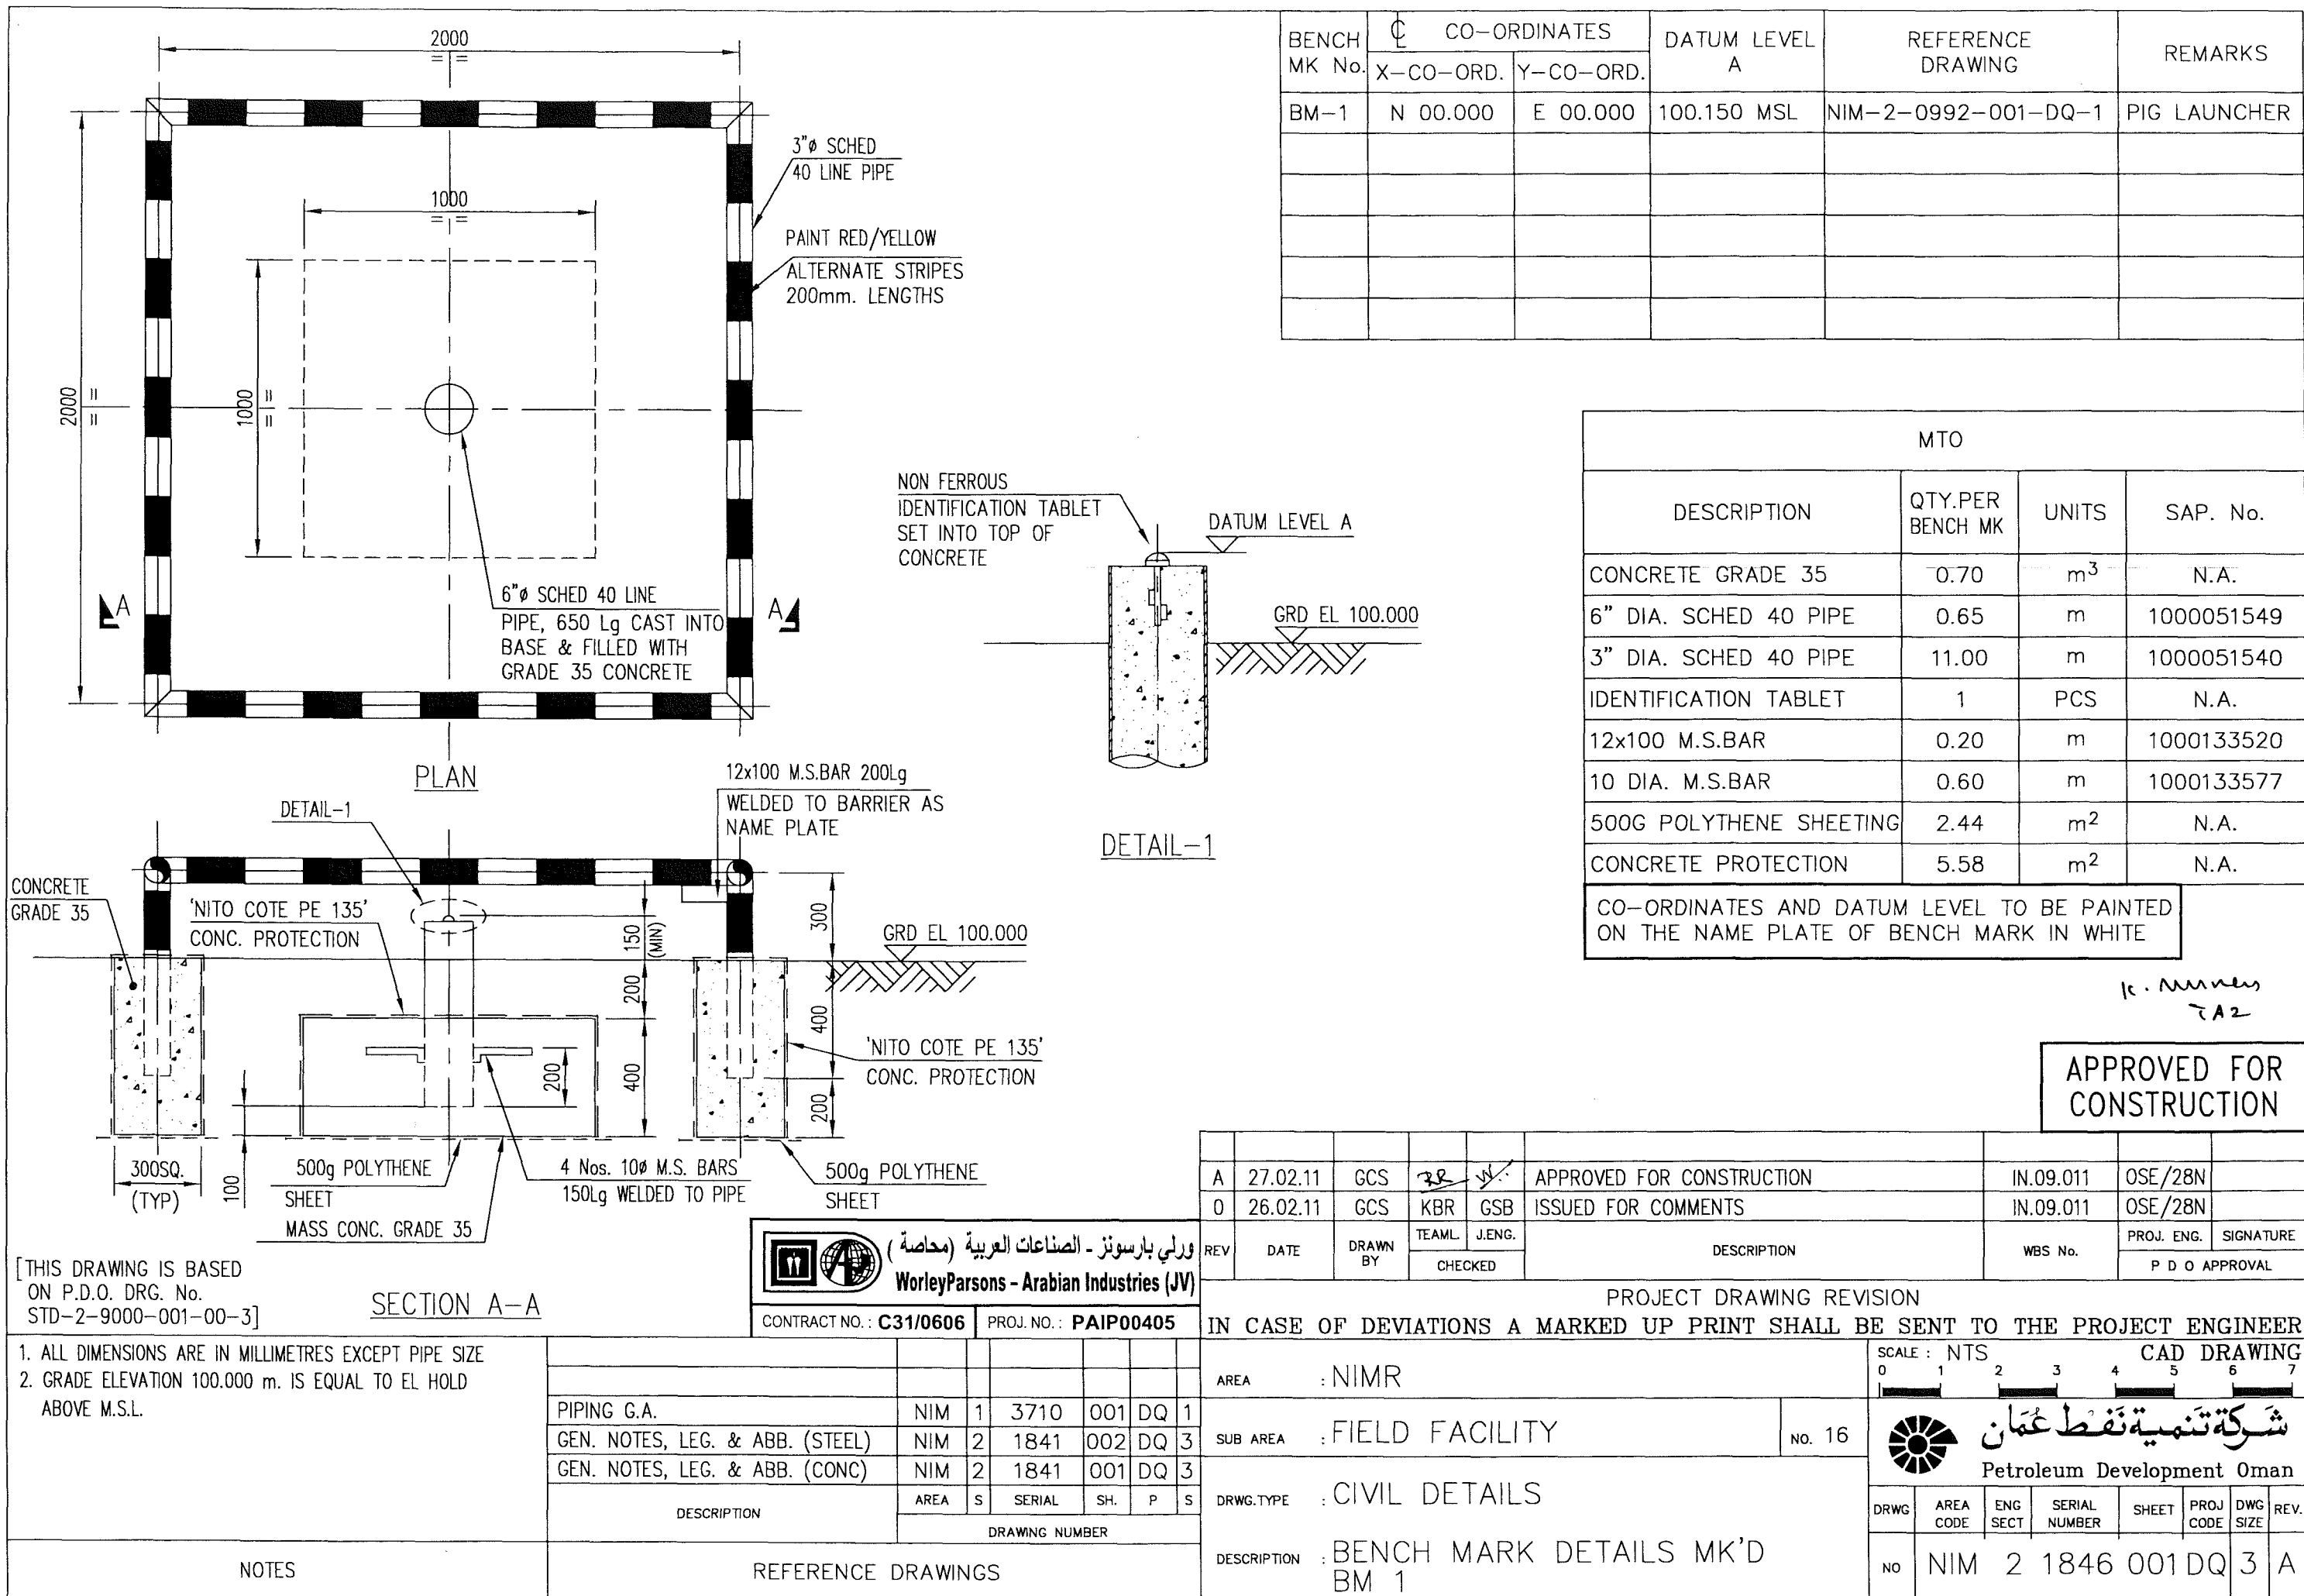


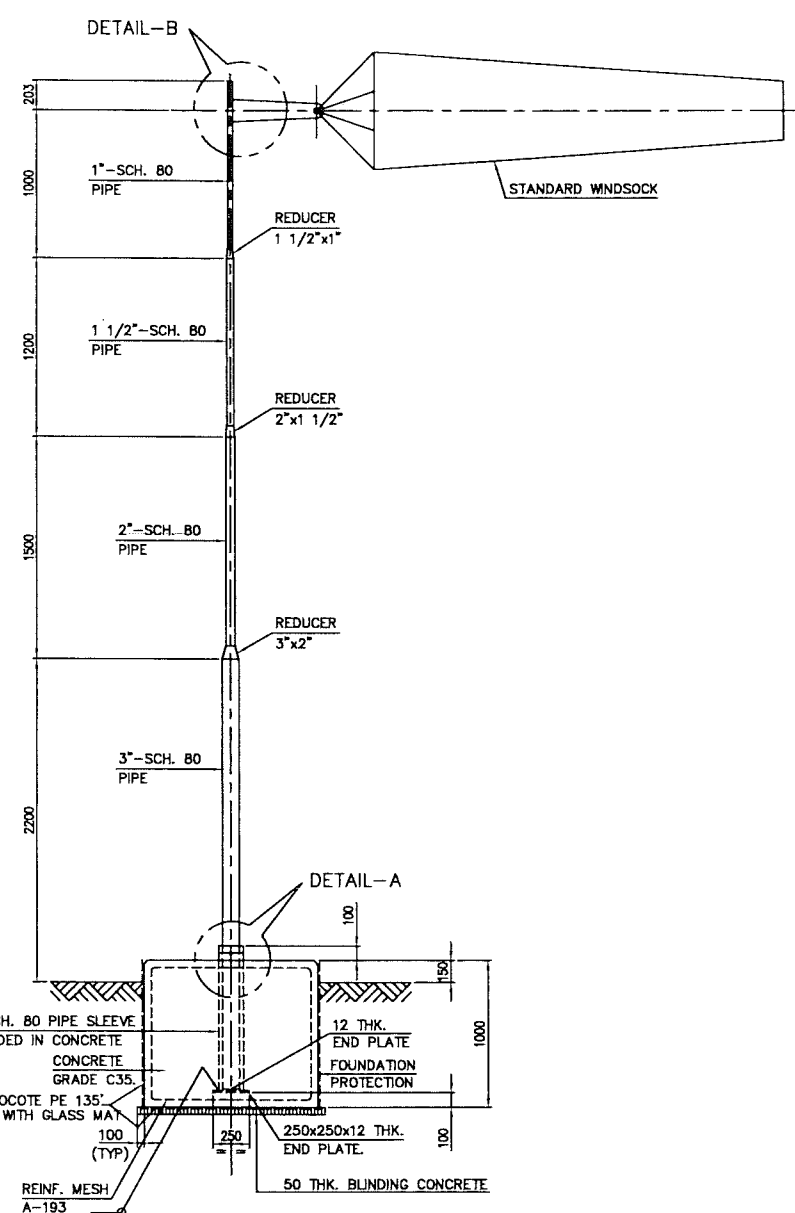

ELEVATION
(1 No REQD.)

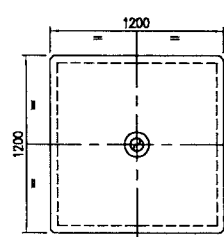


PLAN

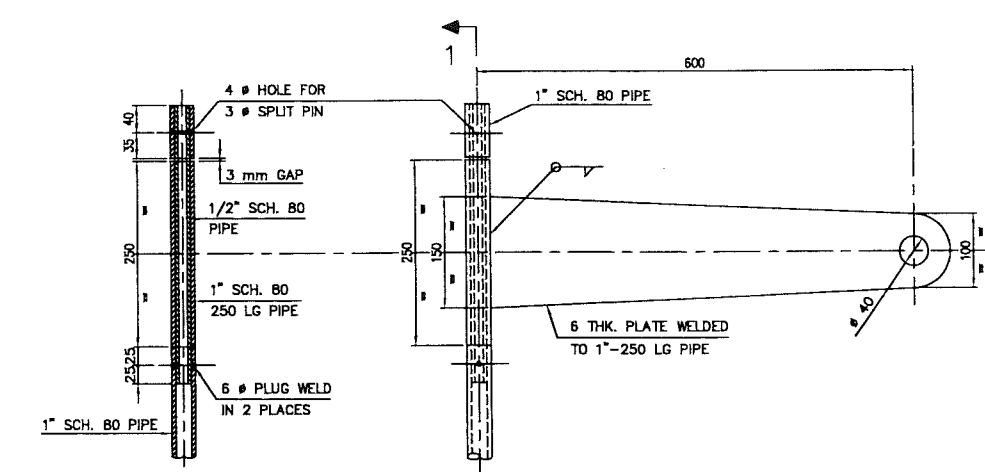


SECTION 1 - 1

DETAIL-B

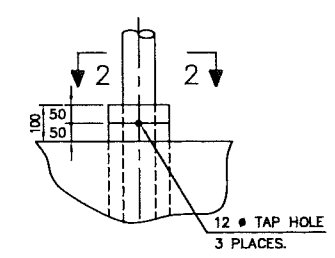

DETAIL-A

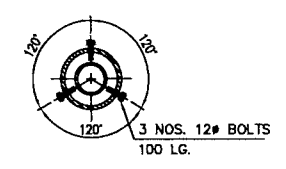

SECTION 2 - 2

M.T.O.			
DESCRIPTION	QUANTITY	UNITS	SAP No.
CONCRETE GRADE 35	1.50	m ³	N.A.
BLINDING CONCRETE	0.10	m ³	N.A.
PROTECTIVE COATING	6.80	m ²	N.A.
A 193 MESH FABRIC	6.50	m ²	1000062697
3" PIPE SCHEDULE 80	3.10	m	1000051542
6" PIPE SCHEDULE 80	1.00	m	1000051551
2" PIPE SCHEDULE 80	1.50	m	1000051538
1-1/2" PIPE SCHEDULE 80	1.20	m	1000051534
1" PIPE SCHEDULE 80	1.20	m	1000051531
1/2" PIPE SCH.80	0.40	m	1000051525
6 THK PLATE	0.10	m ²	1000062606
12 THK PLATE	0.06	m ²	1000062609
REDUCER-1 1/2"x1"	1 No.	-	1000053063
REDUCER-2"x1 1/2"	1 No.	-	1000053073
REDUCER-3"x2"	1 No.	-	1000053081
SPLIT PIN 3mm #	1 No.	-	NA
M12-100 LG BOLTS	6 Nos.	-	NA
WINDSOCK	1 No.	Pcs.	1000468729

- NOTES
5. GRADE ELEVATION 100.000 m. IS EQUAL TO EL. HOLD ABOVE M.S.L.
 4. ALL EXPOSED CONCRETE SURFACE SHALL BE TREATED WITH 2 COATS OF "FOSROC DEKGUARD S" WITH A DFT OF 350 MICRONS
 3. ALL EDGES SHALL HAVE A CHAMFER OF APPROX. 25mm
 2. STEELWORK/PIPEWORK TO BE PAINTED TO SP-1246-2 PCS-1 FINISH COLOUR WHITE
 1. ALL WELDING IS 6 THK. CONT. FILLET UNLESS OTHERWISE SPECIFIED

DESCRIPTION	REFERENCE DRAWINGS
FOUNDATION LOCATION PLAN	NIM 2 0992 001 DQ 1
GENERAL NOTES & ABBREVIATIONS (STEEL)	NIM 2 1841 002 DQ 3
GENERAL NOTES & ABBREVIATIONS (CONCRETE)	NIM 2 1841 001 DQ 3

REV	DATE	APPROVED BY	DESCRIPTION	WELDED	PROLONG.	SPECIAL
A	27.02.11	GCS	APPROVED FOR CONSTRUCTION			
D	26.02.11	GCS	ISSUED FOR COMMENTS			

CONTRACT NO.: C31/0606 PROJ. NO.: PAIP 00405

IN CASE OF DEVIATIONS A MARKED UP PRINT SHALL BE SENT TO THE PROJECT ENGINEER

AREA: NIMR

SUB AREA: FIELD FACILITY

NO. 16


SCALE: 1:75

PROJECT DRAWING REVISION


DESCRIPTION: WINDSOCK DETAILS

NO. NIM 2 1846 002 DQ 1 A


WorleyParsons - Arabian Industries (JV)

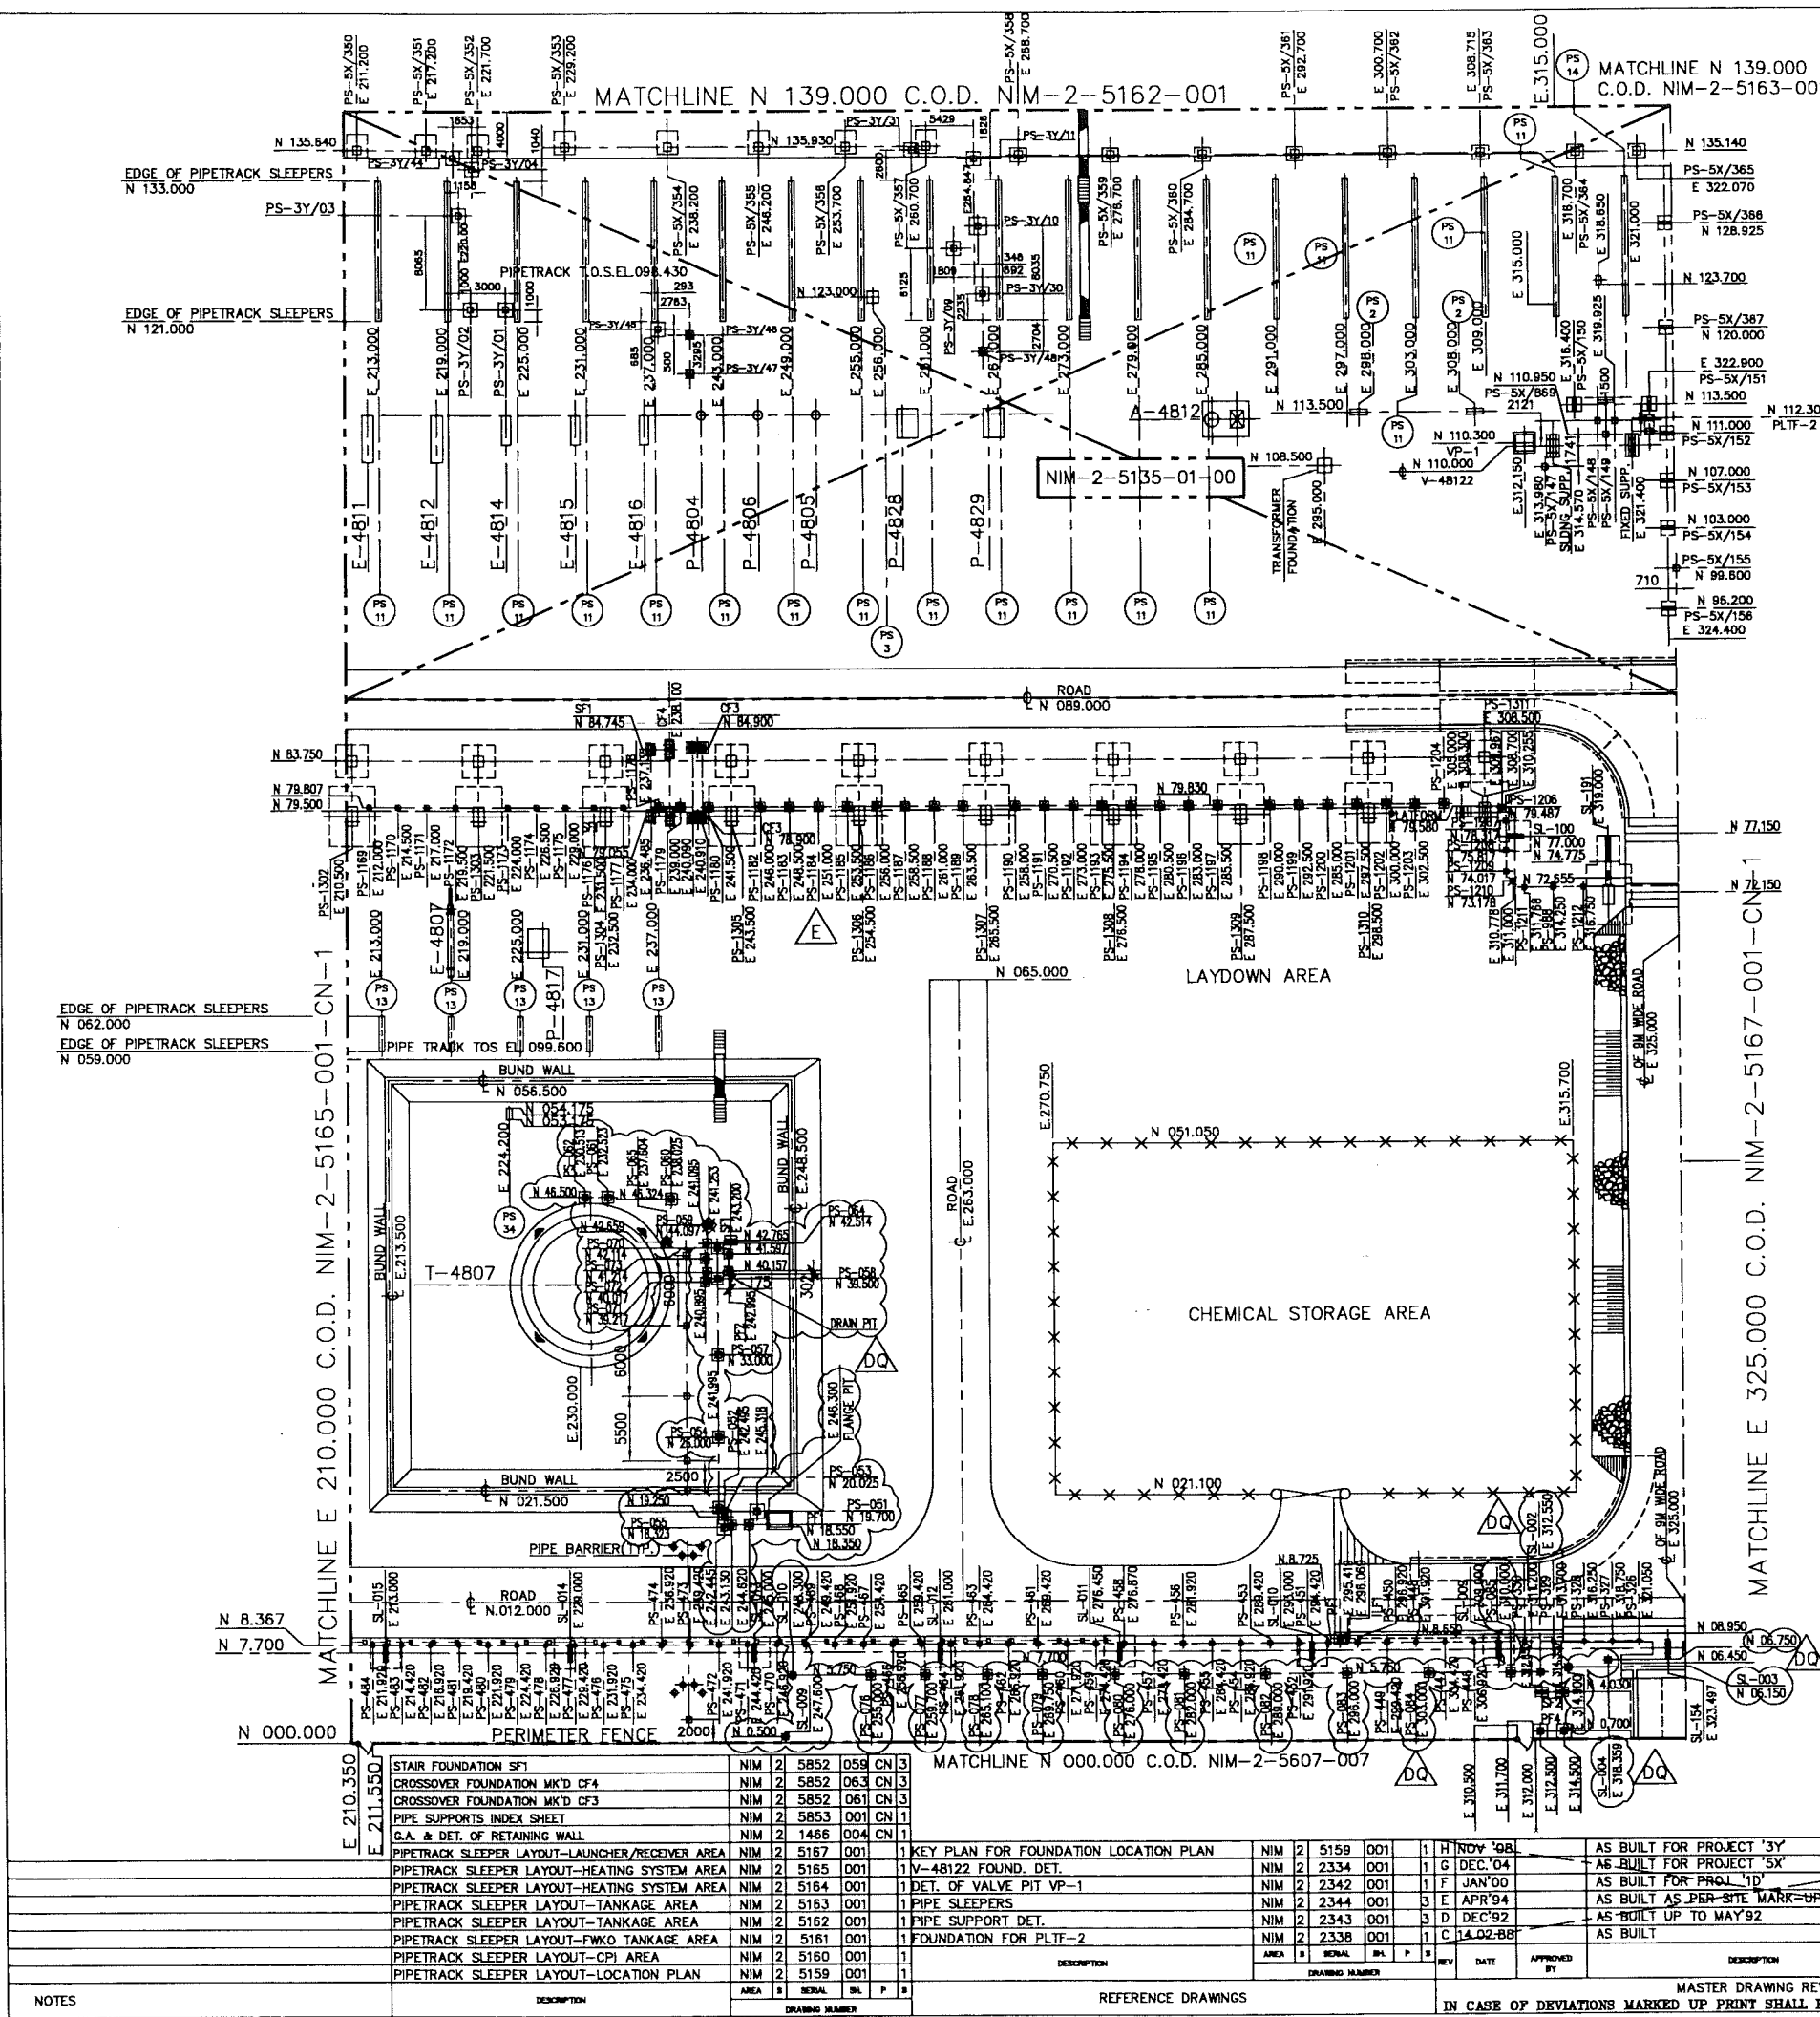

PS.No.	SLEEPER TYPE
01	C
02	C
03	B
04	A
05	A
06	C
07	A
08	A
09	A
10	A
11	A
12	A
13	C
14	A
15	A
16	B
17	C
18	A
19	B
20	B
21	C
22	B
23	B
24	B
25	B
26	B
27	B
28	C
29	C
30	C
31	C
32	C
33	A
34	C

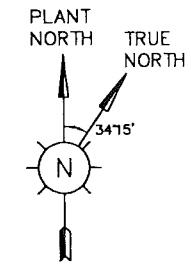

DESCRIPTION	DRAWING NUMBER
STAIR FOUNDATION SF1	NIM 2 5775 010 DQ 3
PLATFORM FOUNDATION PF1	NIM 2 5775 007 DQ 1
COLLECTION PIT G.A.	NIM 2 5774 006 DQ 3
FLANGE PIT G.A.	NIM 2 5774 005 DQ 1
PIPE SUPPORTS INDEX SHEET	NIM 2 5772 032 DQ 3


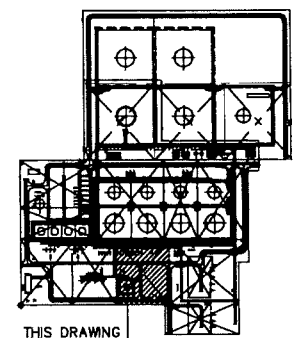


KEY PLAN


SCOPE OF PROJECT
WBS No. - NIM.IN.09.011

APPROVED FOR CONSTRUCTION

MATCHLINE CONTINUED ON DRG. NO. NIM-2-5209-001-CN-1

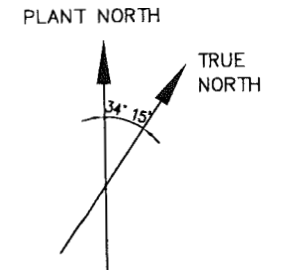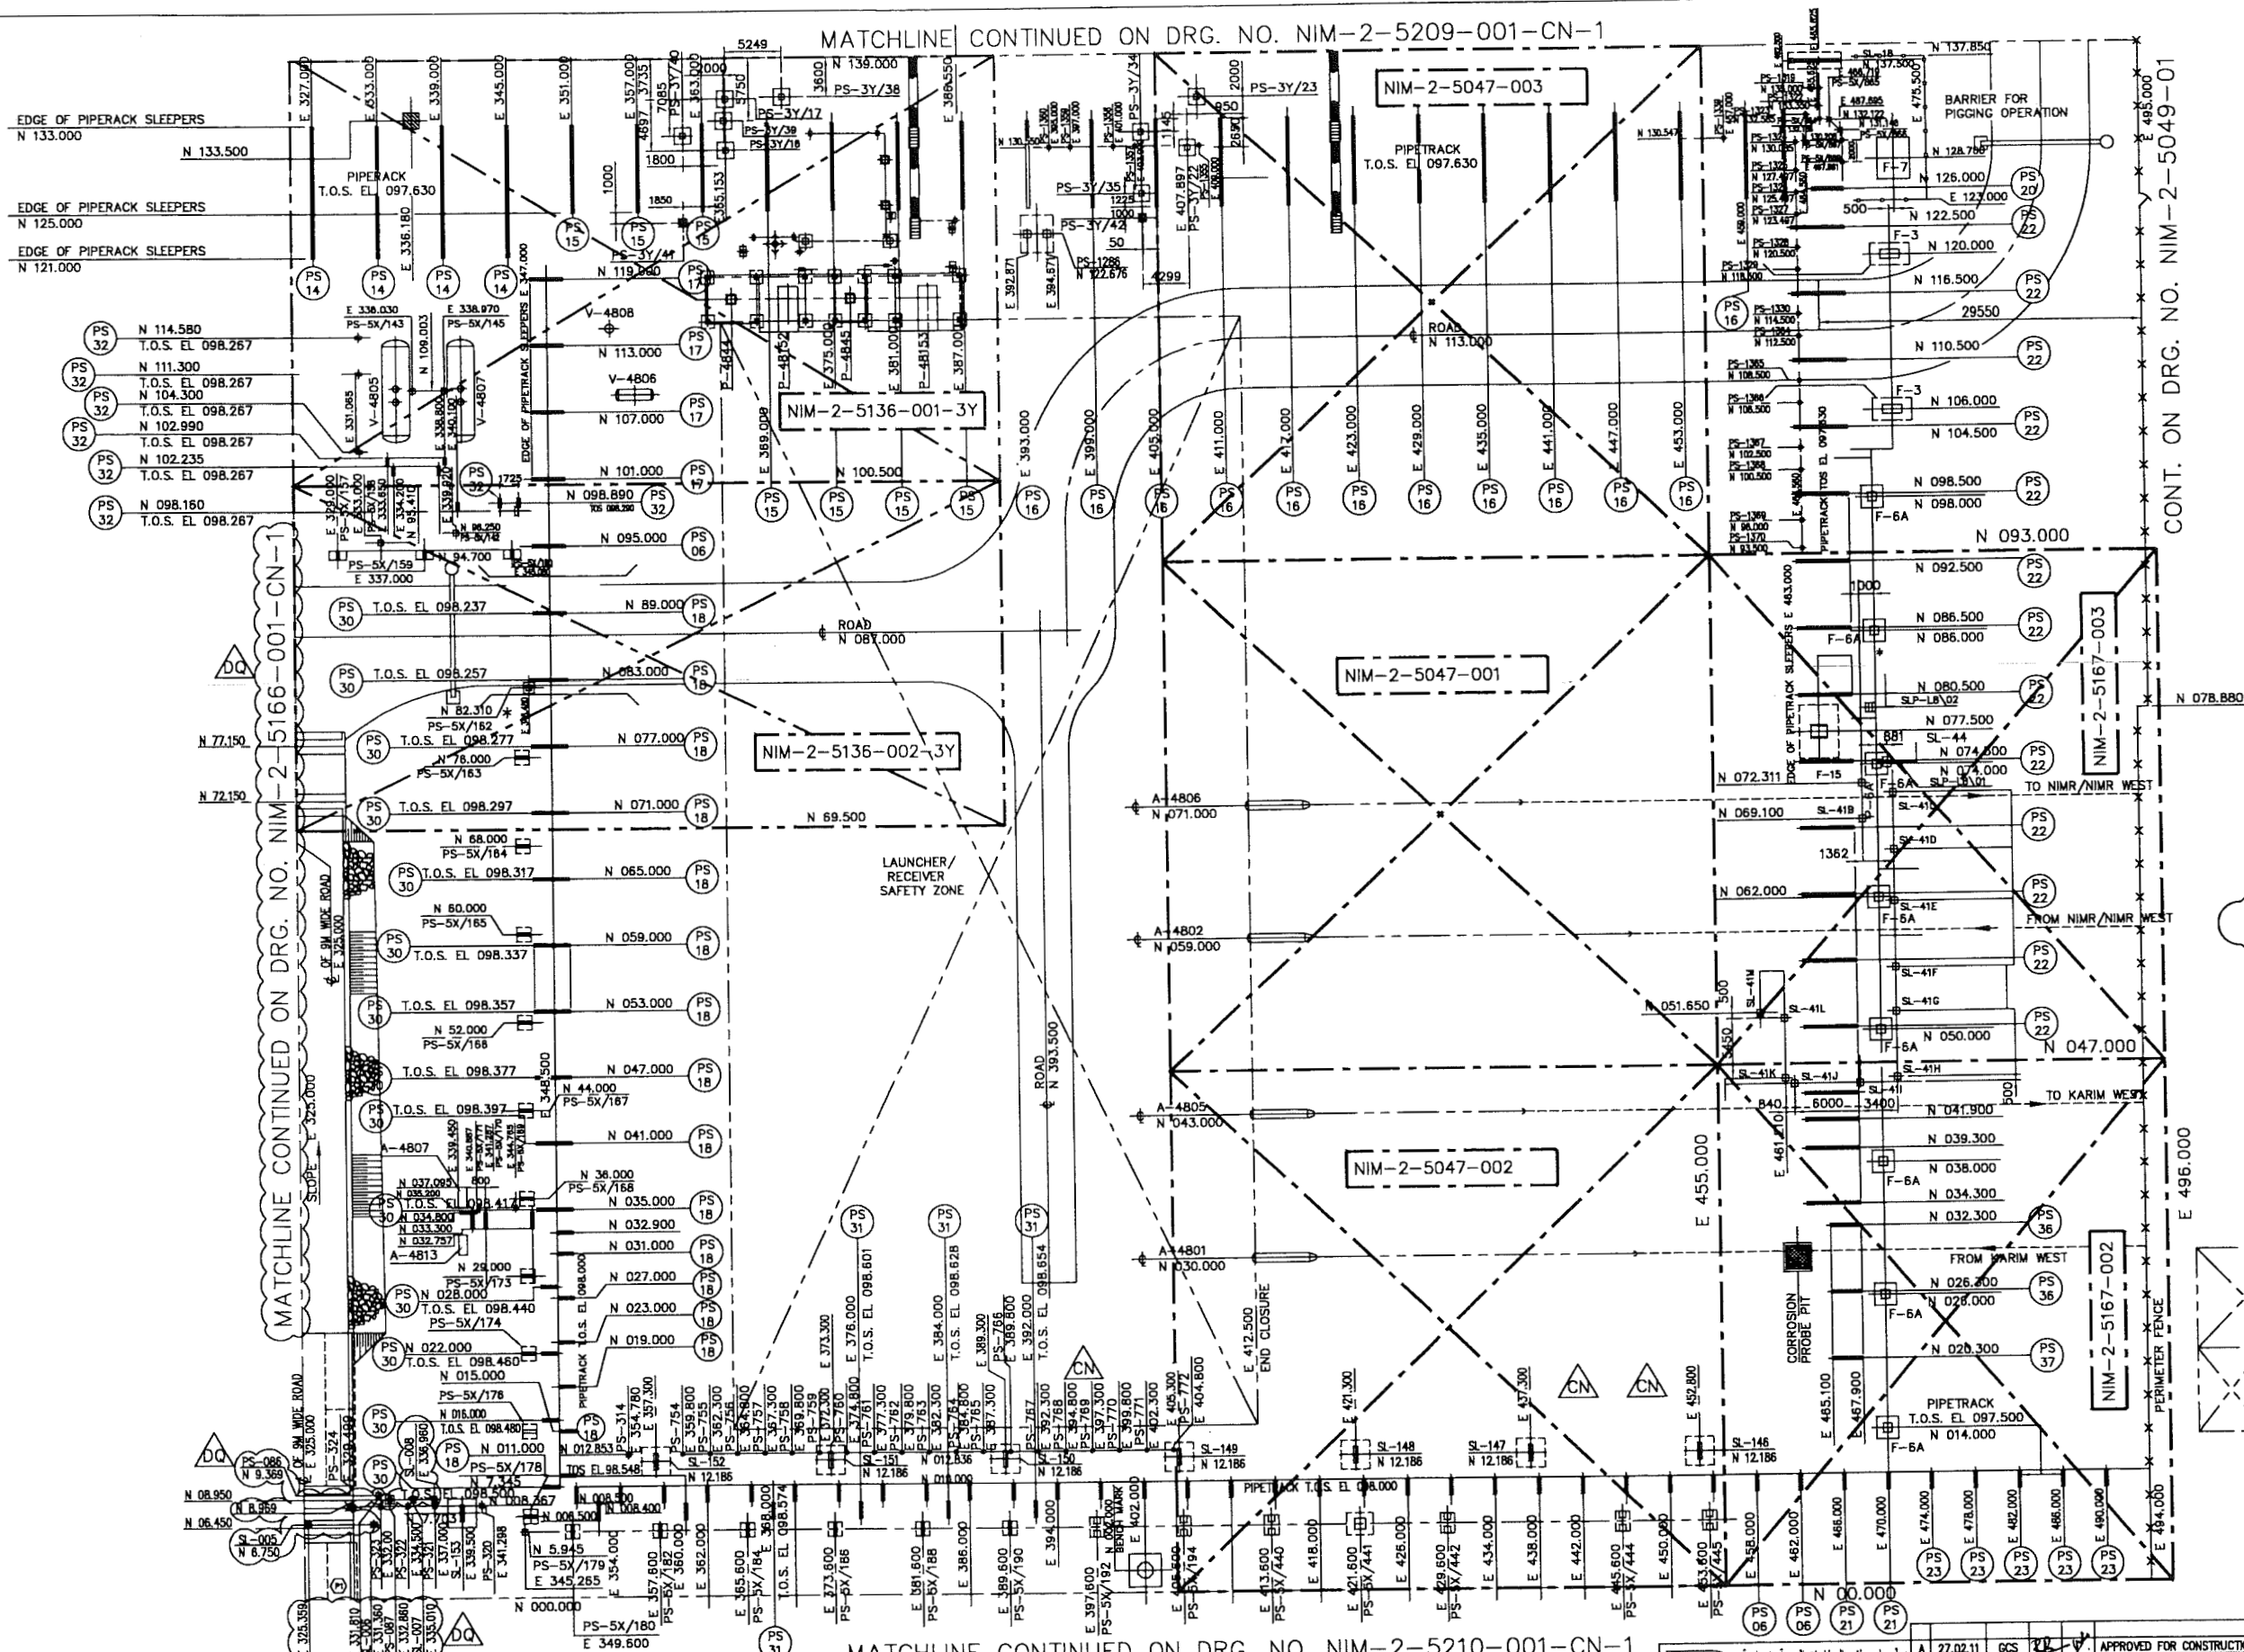

SCOPE OF PROJECT
WBS No. - NIM.IN.09.011

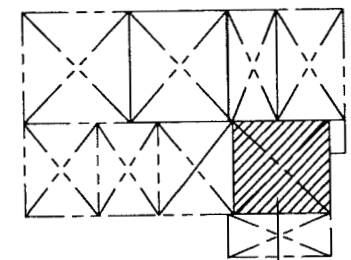

KEY PLAN

APPROVED FOR CONSTRUCTION
K. Muneer
7A2

MATCHLINE CONTINUED ON DRG. NO. NIM-2-5210-001-CN-1

DESCRIPTION	AREA	REMARKS	DATE	BY	CHECKED	APPROVED
PIPE SUPPORTS INDEX SHEET	NIM 2 5172 001	AS BUILT FOR PROJECT '3Y'	01.08.05	MAK		
SLEEPER DETAILS SL-18	NIM 2 5172 002	AS BUILT FOR PROJECT '3Y'	02.01.05	MAK		
SLEEPER DETAILS SL-39, 40, 41A TO 41M.	NIM 2 5172 003	AS BUILT FOR PROJECT '3Y'	02.01.05	MAK		
FOUNDATION DETAILS F-3	NIM 2 5172 004	AS BUILT FOR PROJECT '3Y'	02.01.05	MAK		
FOUNDATION DETAILS F-6A	NIM 2 5172 005	AS BUILT FOR PROJECT '3Y'	02.01.05	MAK		
FOUNDATION DETAILS F-7	NIM 2 5172 006	AS BUILT FOR PROJECT '3Y'	02.01.05	MAK		
FOUNDATION DETAILS F-15	NIM 2 5172 007	AS BUILT FOR PROJECT '3Y'	02.01.05	MAK		



DESCRIPTION	AREA	REMARKS	DATE	BY	CHECKED	APPROVED
PIPE SUPPORTS INDEX SHEET	NIM 2 5172 001	AS BUILT FOR PROJECT '3Y'	01.08.05	MAK		
SLEEPER DETAILS SL-18	NIM 2 5172 002	AS BUILT FOR PROJECT '3Y'	02.01.05	MAK		
SLEEPER DETAILS SL-39, 40, 41A TO 41M.	NIM 2 5172 003	AS BUILT FOR PROJECT '3Y'	02.01.05	MAK		
FOUNDATION DETAILS F-3	NIM 2 5172 004	AS BUILT FOR PROJECT '3Y'	02.01.05	MAK		
FOUNDATION DETAILS F-6A	NIM 2 5172 005	AS BUILT FOR PROJECT '3Y'	02.01.05	MAK		
FOUNDATION DETAILS F-7	NIM 2 5172 006	AS BUILT FOR PROJECT '3Y'	02.01.05	MAK		
FOUNDATION DETAILS F-15	NIM 2 5172 007	AS BUILT FOR PROJECT '3Y'	02.01.05	MAK		

DESCRIPTION	AREA	REMARKS	DATE	BY	CHECKED	APPROVED
PIPE SUPPORTS INDEX SHEET	NIM 2 5172 001	AS BUILT FOR PROJECT '3Y'	01.08.05	MAK		
SLEEPER DETAILS SL-18	NIM 2 5172 002	AS BUILT FOR PROJECT '3Y'	02.01.05	MAK		
SLEEPER DETAILS SL-39, 40, 41A TO 41M.	NIM 2 5172 003	AS BUILT FOR PROJECT '3Y'	02.01.05	MAK		
FOUNDATION DETAILS F-3	NIM 2 5172 004	AS BUILT FOR PROJECT '3Y'	02.01.05	MAK		
FOUNDATION DETAILS F-6A	NIM 2 5172 005	AS BUILT FOR PROJECT '3Y'	02.01.05	MAK		
FOUNDATION DETAILS F-7	NIM 2 5172 006	AS BUILT FOR PROJECT '3Y'	02.01.05	MAK		
FOUNDATION DETAILS F-15	NIM 2 5172 007	AS BUILT FOR PROJECT '3Y'	02.01.05	MAK		

DESCRIPTION	AREA	REMARKS	DATE	BY	CHECKED	APPROVED
PIPE SUPPORTS INDEX SHEET	NIM 2 5172 001	AS BUILT FOR PROJECT '3Y'	01.08.05	MAK		
SLEEPER DETAILS SL-18	NIM 2 5172 002	AS BUILT FOR PROJECT '3Y'	02.01.05	MAK		
SLEEPER DETAILS SL-39, 40, 41A TO 41M.	NIM 2 5172 003	AS BUILT FOR PROJECT '3Y'	02.01.05	MAK		
FOUNDATION DETAILS F-3	NIM 2 5172 004	AS BUILT FOR PROJECT '3Y'	02.01.05	MAK		
FOUNDATION DETAILS F-6A	NIM 2 5172 005	AS BUILT FOR PROJECT '3Y'	02.01.05	MAK		
FOUNDATION DETAILS F-7	NIM 2 5172 006	AS BUILT FOR PROJECT '3Y'	02.01.05	MAK		
FOUNDATION DETAILS F-15	NIM 2 5172 007	AS BUILT FOR PROJECT '3Y'	02.01.05	MAK		

DESCRIPTION	AREA	REMARKS	DATE	BY	CHECKED	APPROVED
PIPE SUPPORTS INDEX SHEET	NIM 2 5172 001	AS BUILT FOR PROJECT '3Y'	01.08.05	MAK		
SLEEPER DETAILS SL-18	NIM 2 5172 002	AS BUILT FOR PROJECT '3Y'	02.01.05	MAK		
SLEEPER DETAILS SL-39, 40, 41A TO 41M.	NIM 2 5172 003	AS BUILT FOR PROJECT '3Y'	02.01.05	MAK		
FOUNDATION DETAILS F-3	NIM 2 5172 004	AS BUILT FOR PROJECT '3Y'	02.01.05	MAK		
FOUNDATION DETAILS F-6A	NIM 2 5172 005	AS BUILT FOR PROJECT '3Y'	02.01.05	MAK		
FOUNDATION DETAILS F-7	NIM 2 5172 006	AS BUILT FOR PROJECT '3Y'	02.01.05	MAK		
FOUNDATION DETAILS F-15	NIM 2 5172 007	AS BUILT FOR PROJECT '3Y'	02.01.05	MAK		


PARSONS File name: W:\2_CIVIL\3-310606(EMC)\PAIP\PAIP00405_DQ\RECEIVER AREA\25167001_DQ.dwg - GCS - 27/02/11 - 10:30:46

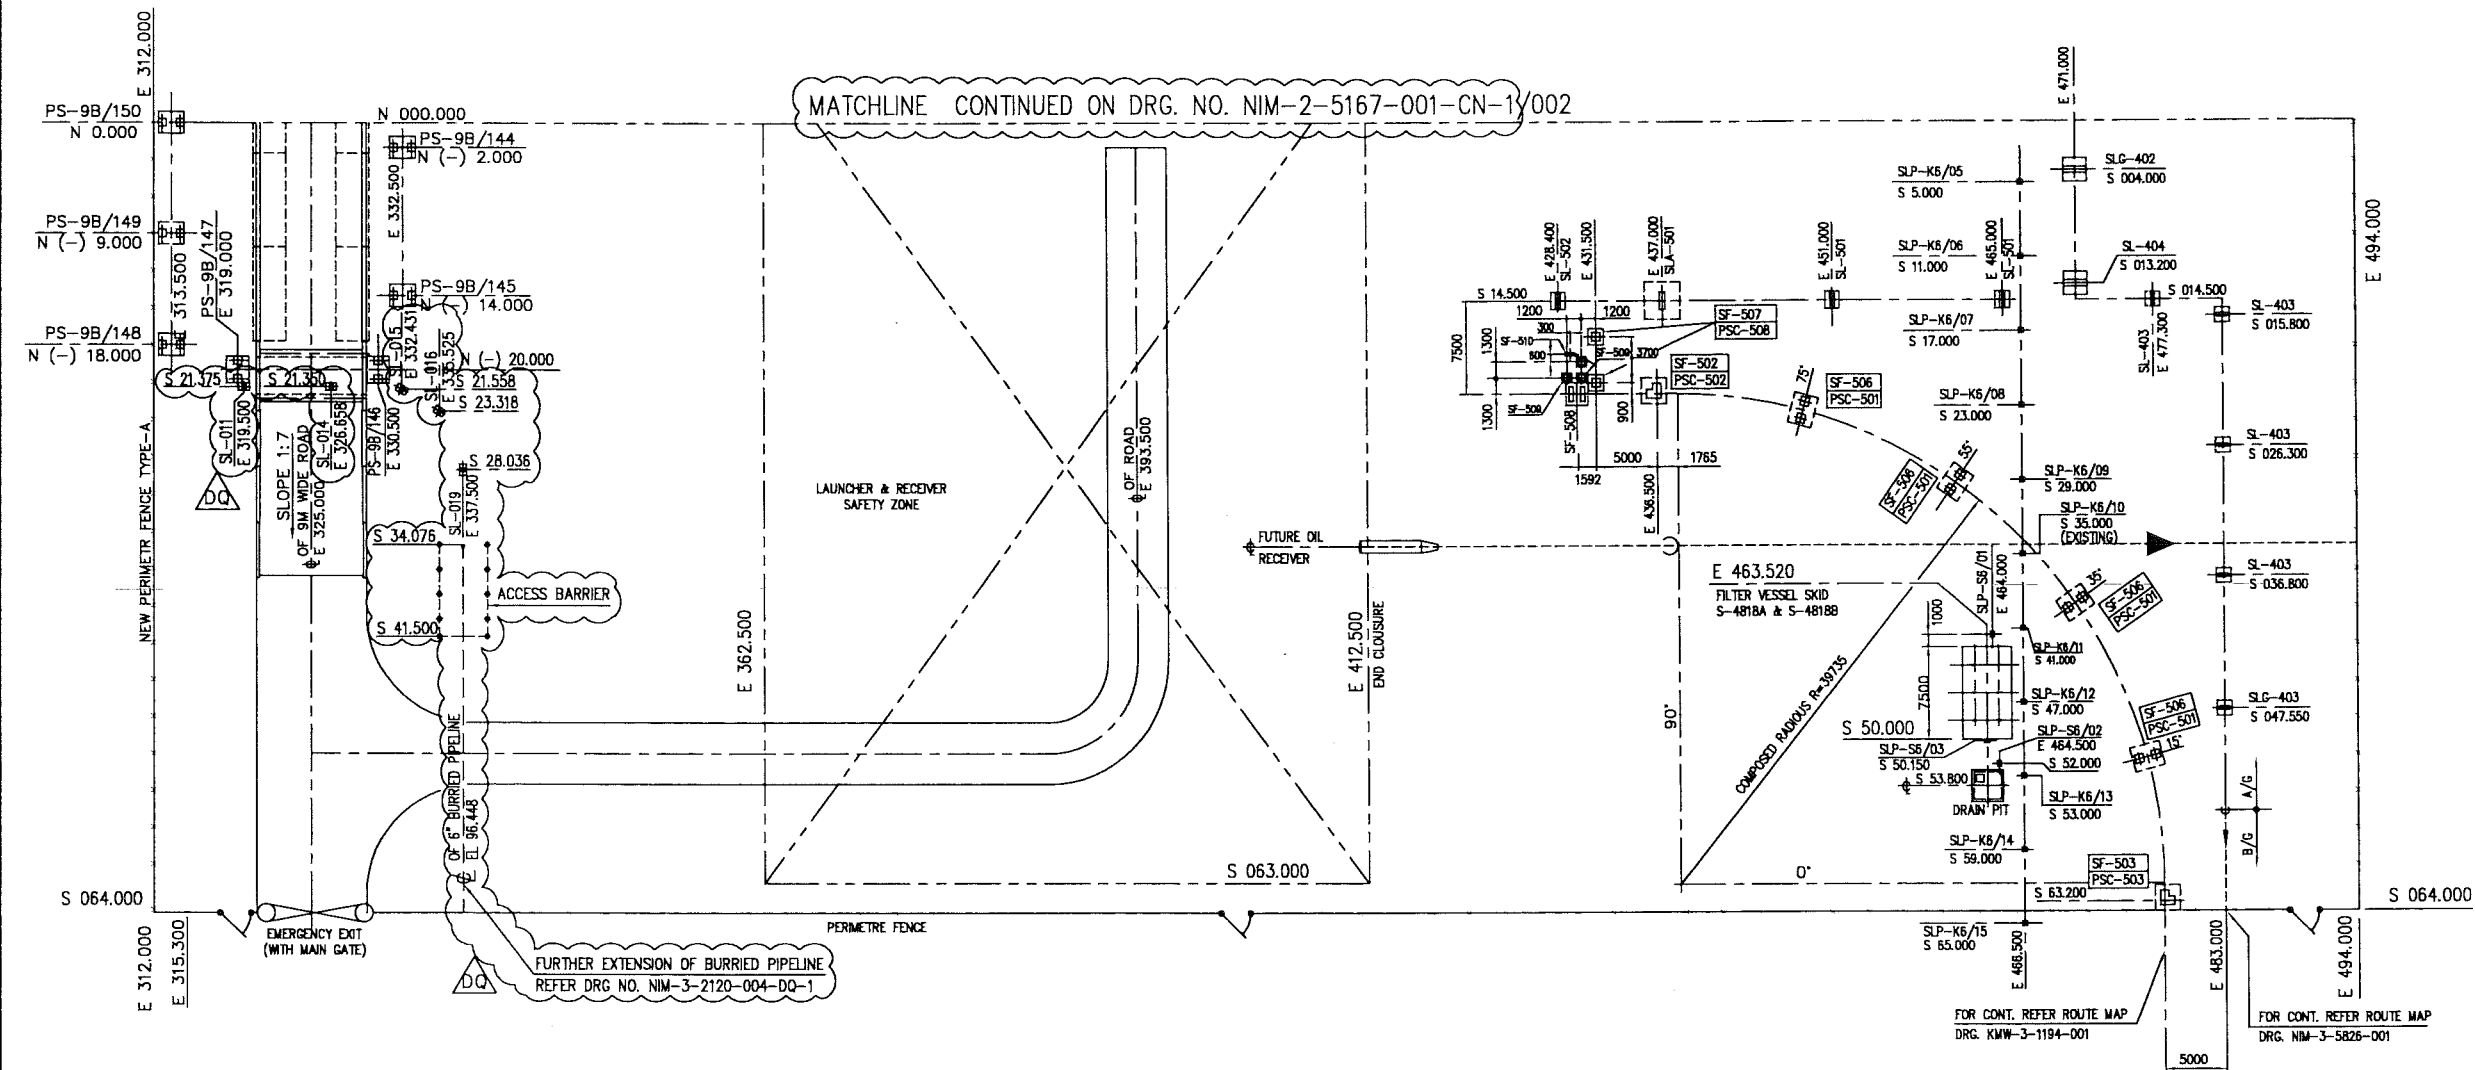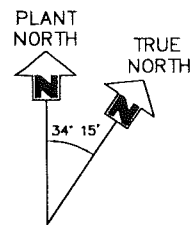

THIS DRAWING IS BASED ON
'CN'
PROJECT DRAWING

PIPE SUPPORT INDEX SHEET			
TYPICAL ACCESS BARRIER DETAILS	STD	2	1625 001 DQ 3
G.A. & DET. OF RETAINING WALL	NIM	2	1446 004 CN 1
CULVERT G.A. DETAILS	NIM	2	5844 002 CN 1
FENCE TYPE-A	STD	2	1600 001
PIPE SUPPORT DETAILS	NIM	2	1450 001 3
PIPE SLEEPER DETAILS	NIM	2	1451 001 3
CULVERT DETAILS	NIM	2	1446 001 1
PIPE SUPPORT PSC-508	NIM	2	5615 007 3
FOUNDATION DETAILS SF-507	NIM	2	5614 007 3
FOUNDATION DETAILS SF-508	NIM	2	5614 008 3
FOUNDATION DETAILS SF-509	NIM	2	5614 009 3
FOUNDATION DETAILS SF-510	NIM	2	5614 010 3
PIPE SUPPORT PSC-503	NIM	2	5615 003 3
PIPE SUPPORT PSC-502	NIM	2	5615 002 3
PIPE SUPPORT PSC-501	NIM	2	5615 001 3
FOUNDATION DETAILS SF-506	NIM	2	5614 006 3
FOUNDATION DETAILS SF-503	NIM	2	5614 003 3
FOUNDATION DETAILS SF-502	NIM	2	5614 002 3
FOUNDATION DETAILS SF-501	NIM	2	5614 001 3
ANCHOR SLEEPER DETAILS SLA-501	NIM	2	5613 003 3
SLEEPER DETAILS SL-502	NIM	2	5613 002 3
SLEEPER DETAILS SL-501	NIM	2	5613 001 3
GUIDE SLEEPER DETAILS SLG-403	NIM	2	1421 007 3
GUIDE SLEEPER DETAILS SLG-402	NIM	2	1421 006 3
SLEEPER DETAILS SL-404	NIM	2	1421 004 3
SLEEPER DETAILS SL-403	NIM	2	1421 003 3
KEY PLAN FOR FOUND. LOCATION PLAN	NIM	2	5159 001 1
SKID R. C. DETAILS	NIM	2	5514 001 1
DRAWING CONTROL	NIM	1	5518 001 4

SCOPE OF PROJECT
WBS No. - NIM.IN.09.011

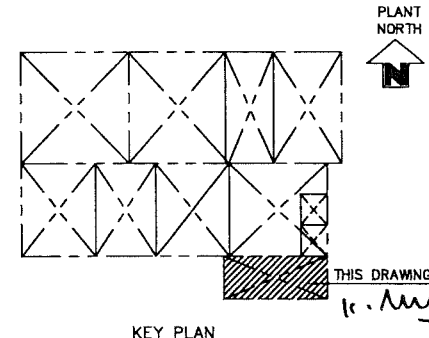

3. FOR GENERAL NOTES REF. DRG. NO. NIM-2-1445-001
2. PLANT DATUM EL.100.220 = EL.222.220 ABOVE MSL.
1. ALL CO-ORDINATES ARE IN METRES.

REFERENCE DRAWINGS				MASTER DRAWING REVISION				PROJECT DRAWING REVISION			
DESCRIPTION	REVISION	DATE	APPROVED BY	DESCRIPTION	REVISION	DATE	APPROVED BY	DESCRIPTION	REVISION	DATE	APPROVED BY
IN CASE OF DEVIATIONS MARKED UP PRINT SHALL BE SENT TO COASTAL DESIGN OFFICE				IN CASE OF DEVIATIONS A MARKED UP PRINT SHALL BE SENT TO THE PROJECT ENGINEER				IN CASE OF DEVIATIONS A MARKED UP PRINT SHALL BE SENT TO THE PROJECT ENGINEER			

WorleyParsons - Arabian Industries (JV)
CONTRACT NO.: C31/0606 PROJ. NO.: PAIP 00405
06.003 DSE/25M
98.186
95.495
90.569

APPROVED FOR CONSTRUCTION
IN.09.011 DSE/288
IN.09.011 DSE/288



PROJECT DRAWING REVISION
IN CASE OF DEVIATIONS A MARKED UP PRINT SHALL BE SENT TO THE PROJECT ENGINEER

SCALE: 1:300
C.A.D. DRAWING
NO. 05
Petroleum Development Oman

DESCRIPTION: FOUNDATION LOCATION PLAN OF LAUNCHER/RECEIVER AREA TRAIN 4 EXT

NIM 2 5210 001 DQ 1 A

PARSONS File name: W:\2_CIVIL\C-310606(EMC)\PAIP\PAIP00405_DQ\RECEIVER AREA\25210001_DQ.dwg-GCS-27/02/11-10:30:48

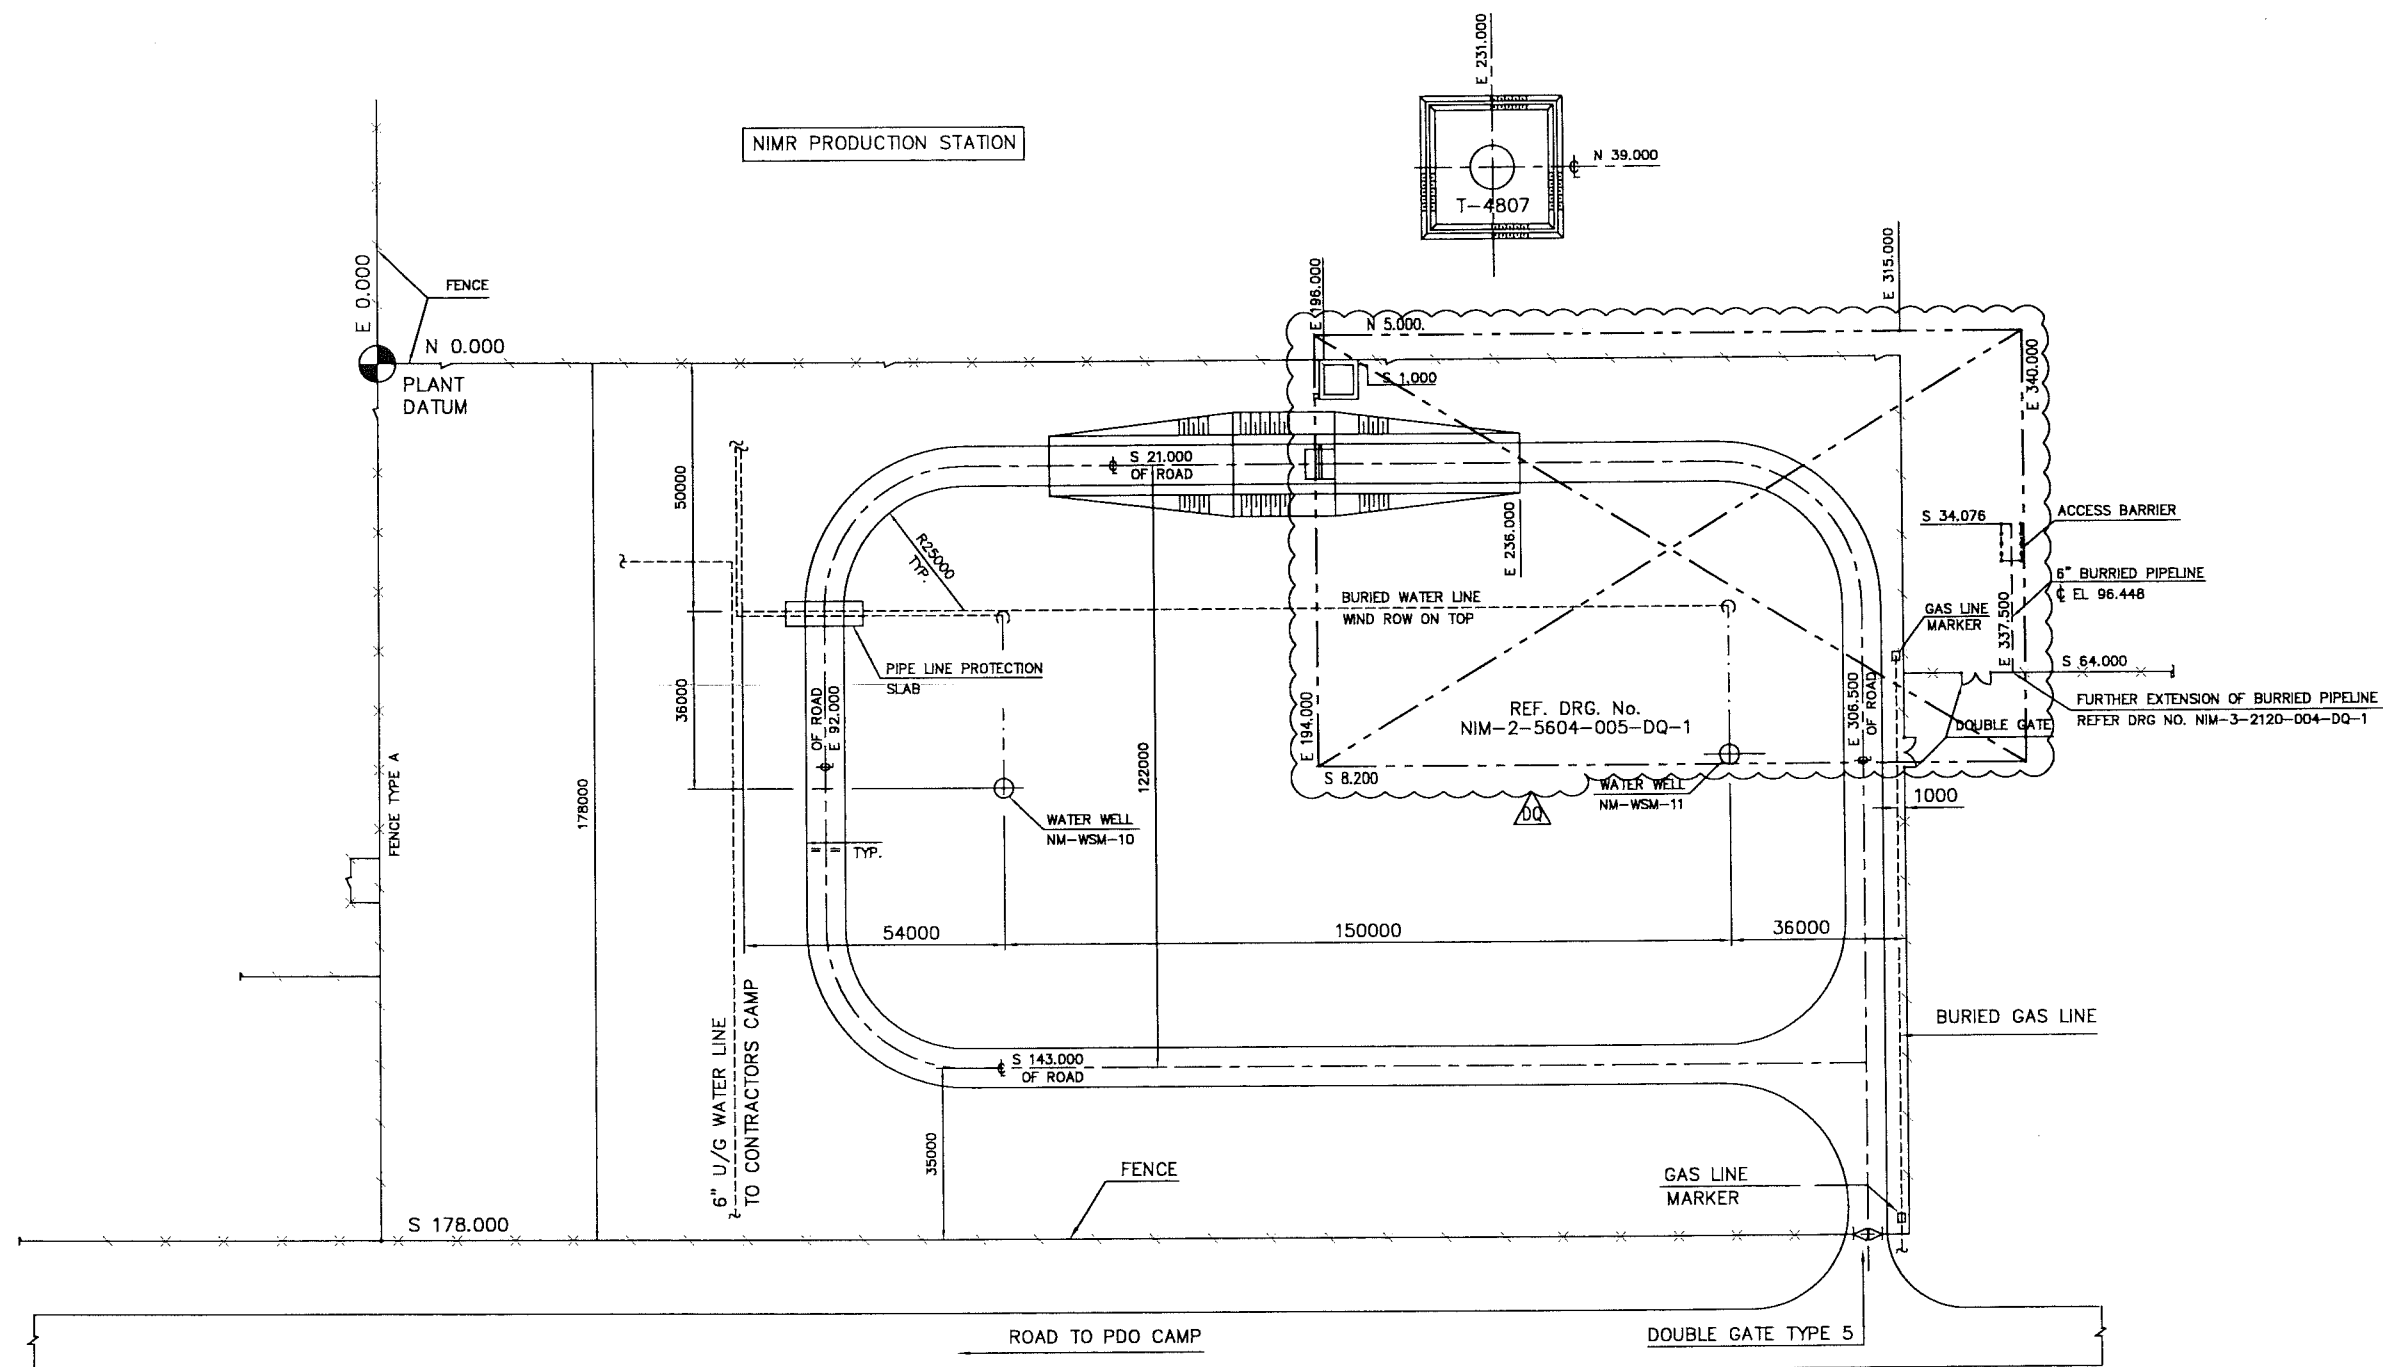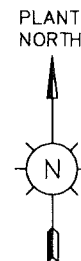

LOCATION PLAN

SCOPE OF PROJECT
WBS No. - NIM.IN.08.002

K. Muneer
T A 2

APPROVED FOR
CONSTRUCTION

CONTRACT NO.: C31/0606 PROJ. NO.: PAIP00405										A 27.02.11 GCS 28.02.11 GCS KBR GSB APPROVED FOR CONSTRUCTION IN.09.011 OSE/288									
										O 28.02.11 GCS KBR GSB ISSUED FOR COMMENTS IN.09.011 OSE/288									
WorleyParsons - Arabian Industries (JV)										PROJ. ENG. SIGNATURE P D O APPROVAL									
CONTRACT NO.: C31/0606 PROJ. NO.: PAIP00405										PROJECT DRAWING REVISION									
										IN CASE OF DEVIATIONS A MARKED UP PRINT SHALL BE SENT TO THE PROJECT ENGINEER									
										SCALE: 1:750 CAD DRAWING									
										AREA : NIMR NO. 05									
										SUB AREA : PRODUCTION STATION NO. 05									
										Petrochem Development Oman									
										LAYOUT									
										FENCE & GATE LAYOUT									
										SLUDGE TANK T-4807									
										NO NIM 2 5604 001DQ 1 A									

DOUBLE GATE TYPE 5										STD 2 1625 005 A DEC'99 - AS BUILT FOR PROJECTS 98.134 ONE/24									
FENCE TYPE A HIGH SECURITY FENCE										STD 2 1600 001 O NOV'98 - ORIGINAL ISSUE FOR CONSTRUCTION 98.134									
DESCRIPTION										AREA SERIAL SPL P REV DATE APPROVED BY DESCRIPTION BL NO. PROJ. ENG. SIGNATURE P D O APPROVAL									
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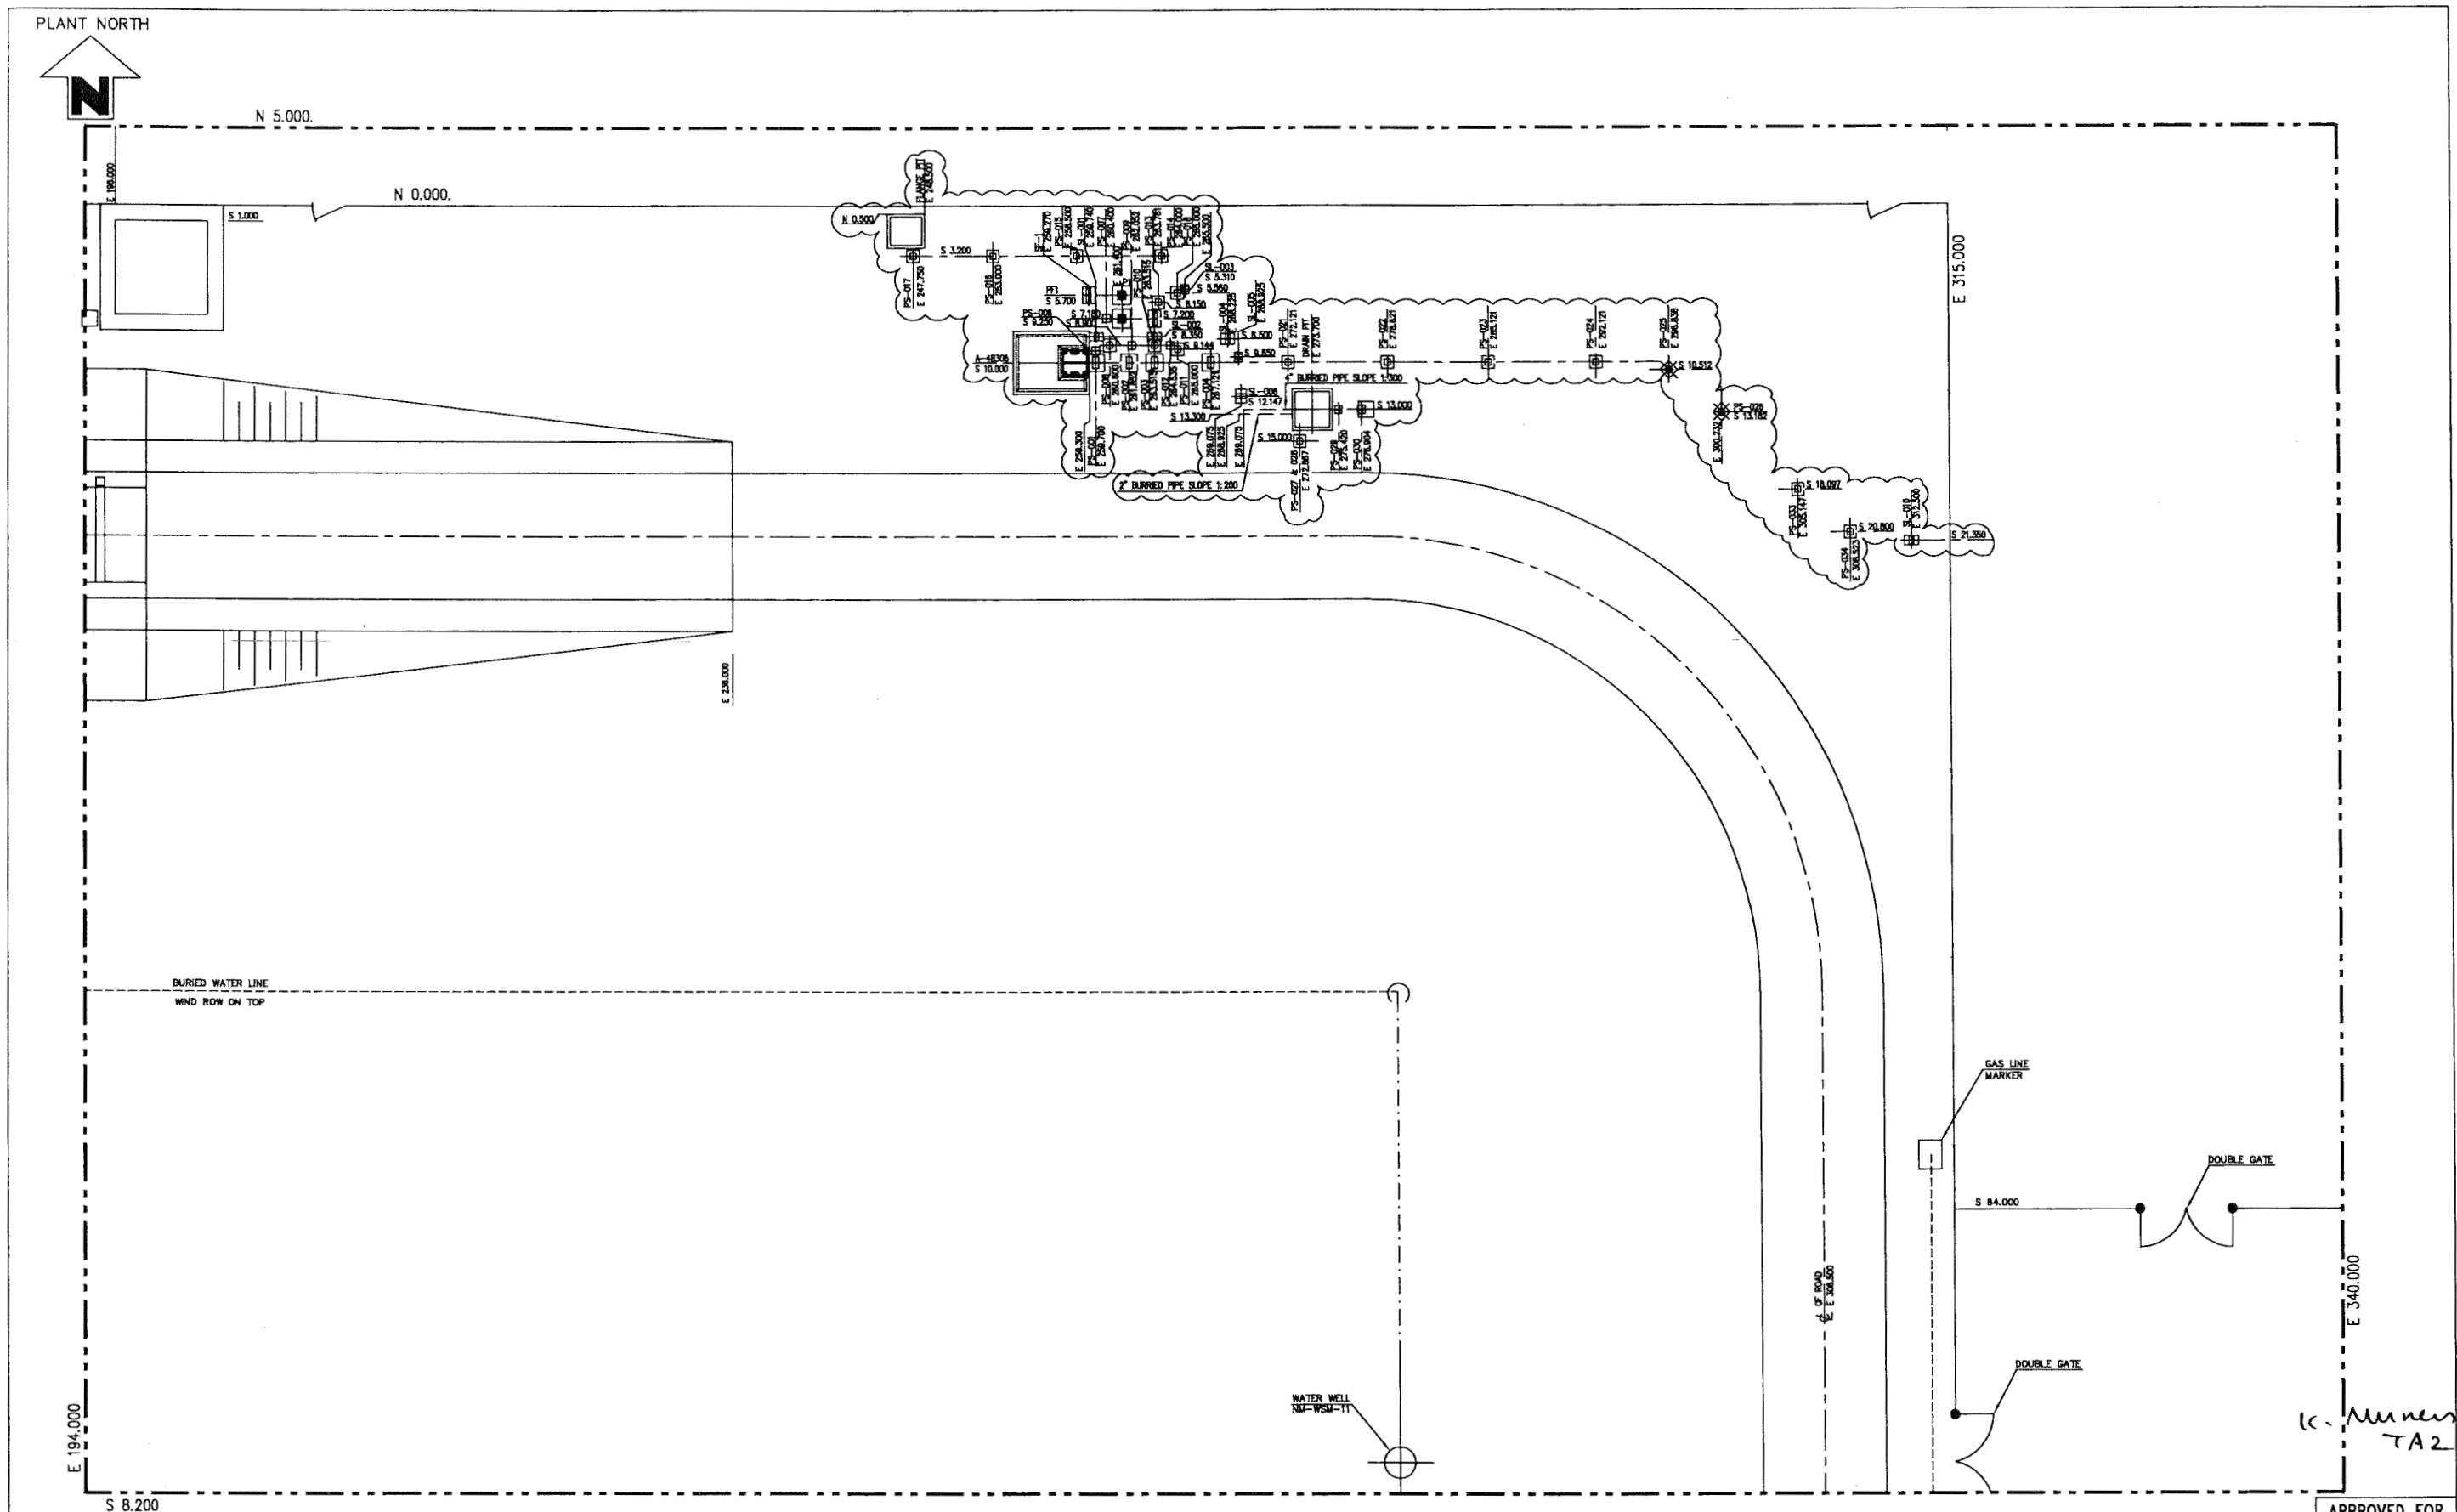
1. ALL DIMENSIONS ARE IN MM, ELEVATIONS & CO-ORDINATES ARE IN METERS

NOTES

1. ALL DIMENSIONS ARE IN MM, ELEVATIONS & CO-ORDINATES ARE IN METERS

NOTES

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PART PLAN

SCOPE OF PROJECT
WBS No. - NIM.IN.08.002

STAIR FDN. SF1	NIM	2	5775	004	DQ	3
PLATFORM FDN. PF1	NIM	2	5775	002	DQ	3
CONC. HARD STAND	NIM	2	5774	004	DQ	3
TYPICAL ACCESS BARRIER DETAILS	STD	2	1626	001		3
SPILL PIT & HARD STAND PIG RECEIVER	NIM	2	5773	001	DQ	3
FLANGE PIT DETAILS	NIM	2	5774	003	DQ	3
DRAIN PIT DETAILS	NIM	2	5774	001	DQ	3
PIPE SUPPORT INDEX SHEET	NIM	2	5572	001	DQ	3
DOUBLE GATE TYPE 5	STD	2	1625	005		3
FENCE TYPE A HIGH SECURITY FENCE	STD	2	1600	001		3

1. ALL DIMENSIONS ARE IN MM, ELEVATIONS & CO-ORDINATES ARE IN METERS

NOTES

REFERENCE DRAWINGS

MASTER DRAWING REVISION
IN CASE OF DEVIATIONS MARKED UP PRINT SHALL BE SENT TO COASTAL DESIGN OFFICE



WorleyParsons - Arabian Industries (WPAI)
CONTRACT NO.: C310606 PROJ. NO.: PAIP00405

REV	DATE	DRAWN BY	CHECKED	DESCRIPTION	IN. 09.011	OSE/28N
A	27.02.11	GCS		APPROVED FOR CONSTRUCTION	IN. 09.011	OSE/28N
D	26.02.11	GCS	KBR	ISSUED FOR COMMENTS	IN. 09.011	OSE/28N
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PROJECT DRAWING REVISION						
IN CASE OF DEVIATIONS A MARKED UP PRINT SHALL BE SENT TO THE PROJECT ENGINEER						
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SUB AREA	: PRODUCTION STATION		NO. 05	شركة تنمية نفط عمان Petrochem Development Oman		
DRAWN TYPE	: LAYOUT		NO. 05	NIM 2 5604.005 DQ 1 A		
DESCRIPTION	: FOUNDATION LOCATION PLAN		NO. 05	NIM 2 5604.005 DQ 1 A		

1.0 GENERAL NOTES

- 1.1 ALL WORK SHALL BE CARRIED OUT IN ACCORDANCE WITH CONSTRUCTION CONTRACT AND / OR CIVIL AND BUILDING CONSTRUCTION SPECIFICATIONS SP-1279 AND GUIDE TO CONCRETE CONSTRUCTION SP-1282.
- 1.2 ALL DIMENSIONS ARE IN MILLIMETERS EXCEPT FOR PIPE SIZES WHICH ARE SHOWN IN INCHES.
- 1.3 ALL ELEVATIONS ARE IN METERS AND RELATED TO DATUM ELEVATION OF 100.000

2.0 EXCAVATION, TRENCHING AND BACKFILL

- 2.1 BACKFILL FOR FOUNDATIONS, WALLS, TRENCHES AND SITE GRADING SHALL BE PLACED IN EVEN LAYERS (SUCH THAT COMPACTED THICKNESS DOES NOT EXCEED 150mm) AND THE FULL WIDTH OF THE FORMATION. THE FILL SHALL BE GRADED AS SHOWN BELOW.

BS SEIVE SIZE	% PASSING BY WEIGHT
50.00 mm	100%
9.50 mm	60%-100%
5.00 mm	50%-85%
2.00 mm	40%-70%
425 µm	25%-45%
75 µm	8%-15%

ALL FILL MATERIAL INCLUDING SUBGRADE AND VERGES SHALL BE COMPACTED TO 95% OF THE MAXIMUM DRY DENSITY OBTAINED IN THE MODIFIED AASHTO COMPACTION TEST.

- 2.2 ALL UNDERGROUND CABLES EXCEPT EARTHING CABLES SHALL BE LAID AT A MINIMUM DEPTH OF 600mm.
- 2.3 INSTRUMENTATION CABLES SHALL NOT BE LAID IN THE SAME TRENCH WITH POWER AND LIGHTING CABLES.
- 2.4 ALL BURIED CABLES SHALL BE LAID IN SUCH A WAY THAT THE FILLING MATERIAL WITHIN 100mm FROM THE CABLES SHALL BE FREE OF STONES OR OTHER MATERIALS WHICH MAY DAMAGE THE CABLES. SUITABLE FILL, SUCH AS CLEAN SMALL-GRAINED SAND SHALL BE USED FOR THIS PURPOSE. THE CABLES SHALL BE PROTECTED BY SUITABLE SLABS OR TILES WHICH SHALL FORM A CONTINUOUS BUT REMOVABLE COVERING 200mm ABOVE THE HIGHEST CABLE.
- 2.5 WHERE CROSSING OF INSTRUMENTATION WITH POWER AND LIGHTING CABLES IS UNAVOIDABLE, INSTRUMENTATION CABLE SHALL BE LAID ABOVE AND SHALL BE KEPT AT A MINIMUM DISTANCE OF 750mm FROM POWER AND LIGHTING CABLES.

3.0 FOUNDATION WORKS

- 3.1 THE FOUNDATIONS FOR BUILDINGS, EQUIPMENT, STEEL STRUCTURES AND PIPE SUPPORTS WHEREVER SPECIFIED ON DRAWINGS SHALL BE LAID ON 2 COATS OF FOSROC'S 'NITOCOTE PE 135' GLASS MAT SPREAD OVER BLINDING CONCRETE. THE SIDES AND TOP OF CONCRETE FOUNDATION IN CONTACT WITH SOIL AND UPTO 250mm ABOVE GRADE SHALL BE APPLIED WITH FOSROC'S 'NITOCOTE PE 135' IN 2 COATS WITH EACH COAT MEASURING 600 MICRON THICKNESS. WHILE THE FIRST COAT IS STILL WET, APPLY 120-150 gsm GLASS MAT ON THE SURFACE AND ROLL OVER TO ENSURE THE MAT IS FULLY EMBEDDED. MASTER SEAL 550 MANUFACTURED BY DEGUSSA OR ANY OTHER PDO APPROVED EQUIVALENT IN PLACE OF 'NITOCOTE PE 135'. APPLICATION SHALL BE AS PER RESPECTIVE MANUFACTURER'S INSTRUCTIONS.
- 3.2 BEFORE POURING CONCRETE, THE FIELD SHALL MAKE PROVISION FOR THE INSTALLATION OF ALL UNDERGROUND SERVICES AFFECTED BY THE FOUNDATIONS.
- 3.3 BEFORE CASTING FOUNDATIONS, ANY IMMEDIATE OR ADJACENT AREAS OF DISTURBED OR SOFT SOIL MUST BE REMOVED AND REPLACED WITH MASS CONCRETE OF GRADE 10.
- 3.4 ALL EXPOSED PORTIONS OF FOUNDATION CONCRETE AND INSIDE SURFACES OF RCC PITS, WHEREVER NOT SPECIFICALLY SPECIFIED, SHALL BE COATED WITH 'FOSROC DEKGUARD S' OR EQUIVALENT.

4.0 CONCRETE

- 4.1 ALL CONCRETE WORK SHALL BE CARRIED OUT IN ACCORDANCE WITH CODE OF PRACTICE FOR THE STRUCTURAL USE OF CONCRETE: BS 8110 INCLUDING ALL RELATED CODES FOR PLACING, MIXING, CURING AND TESTING.
- 4.2 A LAYER OF BLINDING CONCRETE 50mm THK SHALL BE PLACED UNDER ALL FOUNDATIONS. BLINDING CONCRETE SHALL HAVE A CHARACTERISTIC STRENGTH OF 10 N/mm² AT 28 DAYS.
- 4.3 ALL CONCRETE WITH THE EXCEPTION OF BLINDING CONCRETE SHALL OF GRADE AS SPECIFIED IN THE RESPECTIVE DETAILED DRAWINGS AND SHALL NOT BE LOWER THAN GRADE 35 CONCRETE WITH 'CORTEC MCI 2005' CORROSION INHIBITOR AT A RATE OF 0.6 lit/m³ OR EQUIVALENT. MIXING SHALL BE AS PER MANUFACTURER INSTRUCTIONS.
- 4.4 FOR ALL CONCRETE WORKS, ORDINARY PORTLAND CEMENT TO BS EN 197 SHALL BE USED, UNLESS OTHERWISE SPECIFIED.
MAXIMUM FREE WATER CEMENT RATIO SHALL BE 0.45
MINIMUM CEMENT CONTENT FOR 20mm AGGREGATE SHALL BE 370 kg/m³.
FOR 40mm AGGREGATE SHALL BE 340 kg/m³.

- 4.5 ALL EDGES OF EXPOSED AND BURIED CONCRETE MEMBERS SHALL HAVE CHAMFER OF APPROXIMATELY 25mm.
- 4.6 HOT-ROLLED DEFORMED HIGH-YIELD BARS GRADE 460 WITH A SPECIFIED CHARACTERISTIC STRENGTH OF 460 N/mm² SHALL BE USED AS REINFORCEMENT FOR ALL CONCRETE WORKS. HOT-ROLLED MILD STEEL BARS GRADE 250 WITH A SPECIFIED CHARACTERISTIC STRENGTH OF 250 N/mm² SHALL BE USED WHERE SPECIFIED.

- 4.7 NOMINAL COVER TO ALL REINFORCEMENT (INCLUDING LINKS) UNLESS SPECIFIED OTHERWISE SHALL BE


- 1) FOUNDATIONS, COLUMNS, BEAMS, SLABS AND WALLS IN CONTACT WITH SOIL OR EXPOSED TO WEATHER. - 50 mm
- 2) COLUMNS, BEAMS AND WALLS NEITHER IN CONTACT WITH SOIL NOR EXPOSED TO WEATHER. - 40 mm
- 3) BUILDING FLOOR SLABS & ROOF SLABS - 25 mm

- 4.8 UNLESS NOTED OTHERWISE ON THE DRAWING FOLLOWING MINIMUM LAP LENGTHS SHALL BE USED.

SIZE	LAP LENGTH*
T8	450
T10	550
T12	650
T16	850
T20	1050
T25	1300
T32	1650

* - SPECIFIED TO THE NEAREST 25 mm.

- 4.9 LEGEND FOR REINFORCEMENT OF HOT-ROLLED MILD STEEL AND HOT ROLLED DEFORMED HIGH YIELD STRESS BARS.

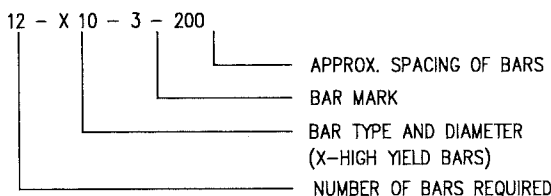

5.0 ANCHOR BOLTS

- 5.1 ALL ANCHOR BOLTS AND NUTS SHALL CONFORM TO A 307-B OR DIN 267 4.6 OR BS 970 070 M20 UNLESS SPECIFIED OTHERWISE. ALL WASHERS SHALL BE ACCORDING TO BS 4320. ALL THREADING SHALL BE ISO METRIC THREAD CONFORMING TO BS 3643.
- 5.2 ALL PROJECTIONS OF HOLDING DOWN BOLTS (ANCHOR BOLTS) ARE TAKEN FROM TOP OF ROUGH CONCRETE.
- 5.3 STYROPOR OR SIMILAR APPROVED MATERIAL FOR FORMING THE (ANCHOR) BOLT POCKETS SHALL BE SECURED AGAINST ANY MOVEMENT DURING CONSTRUCTION AND REMOVED AS SOON AS THE CONCRETE IS SET.

6.0 GROUTING

- 6.1 ALL GROUTING REQUIRES PRIOR APPROVAL BY ENGINEER BEFORE GROUTING. THE SURFACE SHALL BE CLEANED AND SOAKED WITH WATER.
- 6.2 GROUT MORTAR SHALL CONSIST OF ONE PART OF ORDINARY PORTLAND CEMENT AND TWO PARTS OF SAND WITH WATER CEMENT RATIO NOT EXCEEDING 0.4.
- 6.3 GROUT MORTAR SHALL HAVE A MINIMUM COMPRESSIVE STRENGTH OF 40 N/mm².
- 6.4 WHERE REQUIRED AND INDICATED ON THE DRAWINGS, A NON-SHRINK GROUT SHALL BE PREPARED AND APPLIED STRICTLY IN ACCORDANCE WITH THE MANUFACTURER'S INSTRUCTIONS.

LEGEND

	ROCK FILL
	WELL GRADED COMPACTED SAND
	BLINDING LAYER 50 mm THK.
	STYROFOM OR OTHER INSULATING MATERIAL
	FIBRE MAT OR BUILDING PAPER
	SLOPE
	CHEQUER PLATE
	GRATING
	HOLE
	POCKET OR RECESS
	ELECTRICAL TRENCHES
	INSTRUMENT TRENCHES
	ELEVATION
	FENCE
	GRADE
	ANCHOR BOLT
	PIPE OR SLEEVE
	CONSTRUCTION JOINT
	WATERSTOP
	SPAN DIRECTION
	MATERIAL ITEM

ABBREVIATIONS

AB	DENOTES	ANCHOR BOLTS
ALT		ALTERNATE
APPROX		APPROXIMATE
BTF		BOTTOM FACE
BOC		BOTTOM OF CONCRETE
BOS		BOTTOM OF STEEL
CL		CENTRE LINE
CTC		CENTRE TO CENTRE
CONC		CONCRETE
DIA		DIAMETER
DWG / DRG		DRAWING
EF		EACH FACE
EL / ELEV		ELEVATION
ES		EVENLY SPACED
FF		FAR FACE
FFL		FINISHED FLOOR LEVEL
FP		FIXED POINT
FDN / FOUND		FOUNDATION
GRD		GRADE LEVEL
GL		GROUND LEVEL
HP		HIGH POINT
ID		INSIDE DIAMETER
LG		LONG OR LENGTH
LP		LOW POINT
MK		MARK
MKD		MARKED
NF		NEAR FACE
Ø		DIAMETER

ABBREVIATIONS

OD	OUTSIDE DIAMETER
PTFE	POLYTETRAFLUORETHYLENE
RAD	RADIUS
REV	REVISION
SCHED	SCHEDULE
SECT/SEC	SECTION
SP	SLIDING POINT
STGD	STAGGERED
TF	TOP FACE
TOC	TOP OF CONCRETE
TOG	TOP OF GRATING
TORC	TOP OF ROUGH CONCRETE
TOS	TOP OF STEEL
TYP	TYPICAL

APPROVED FOR CONSTRUCTION

REV	DATE	DRAWN BY	TEAM L.	J.ENG.	CHECKED	DESCRIPTION	WBS No.	PROJ. ENG.	SIGNATURE
A	27.02.11	GCS	JB	JS		APPROVED FOR CONSTRUCTION	IN.09.011	OSE/28N	
O	26.02.11	GCS	KBR	GSB		ISSUED FOR COMMENTS	IN.09.011	OSE/28N	

PROJECT DRAWING REVISION									
IN CASE OF DEVIATIONS A MARKED UP PRINT SHALL BE SENT TO THE PROJECT ENGINEER									
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SUB AREA : PRODUCTION STATION						No. 05			
DRWG. TYPE : CONCRETE STRUCTURE						DESCRIPTION : GENERAL NOTES, LEGEND AND ABBREVIATIONS			
CONTRACT NO.: C31/0606						PROJ. NO.: PAIP00405			
DRWG						AREA CODE	ENG SECT	SERIAL NUMBER	SHEET
NO						NO	2	5771	001
						PROJ CODE	DWG SIZE	REV.	
							3	A	

1.0 GENERAL NOTES.

- 1.1 ALL WORKS SHALL BE CARRIED OUT IN ACCORDANCE WITH CONSTRUCTION CONTRACT AND / OR CONSTRUCTION SPECIFICATION SP-1279.
- 1.2 ALL DIMENSIONS ARE IN MILLIMETRES EXCEPT FOR PIPE SIZES WHICH ARE SHOWN IN INCHES.
- 1.3 ALL ELEVATIONS ARE IN METERS AND RELATED TO DATUM ELEVATION OF 100.000

2.0 STRUCTURAL STEEL MATERIAL

- 2.1 STEEL STRUCTURE SHALL BE FABRICATED IN ACCORDANCE WITH GOOD WORKING PRACTICE, MATERIALS, WORKMANSHIP AND TESTING GENERALLY SHALL COMPLY WITH BS 5950 PART-1,2000.
- 2.2 STRUCTURAL STEEL SHALL COMPLY WITH THE FOLLOWING MATERIAL REQUIREMENT. GRADE S275 JR COMPLYING WITH BS EN 10025 PART 1 & 3.
- 2.3 STRUCTURAL STEEL SHALL COMPLY WITH THE REQUIREMENT OF BS 5950, PART-1, IN ADDITION STRUCTURAL STEEL HOT ROLLED SECTIONS SHALL COMPLY WITH THE REQUIREMENTS OF BS 4 PART-1,1993 AND PART-2,1969 AND FOR ANGLES BS EN 10056-1:1999 (METRIC DIMENSIONS). PIPES USED FOR STRUCTURAL PURPOSE SHALL COMPLY WITH ASTM A 106 GRADE B, OR AS SPECIFIED ON THE DRAWINGS.

3.0 BOLTING

- 3.1 BOLTS AND NUTS SHALL HAVE ISO - METRIC COARSE THREAD.
- 3.2 MILD STEEL BOLTS, NUTS AND WASHERS SHALL COMPLY WITH THE REQUIREMENT OF BS 5950 PART-1,BS 4190 AND BS 4320.
- 3.3 WASHERS ARE TO BE PROVIDED UNDER ALL NUTS ON BEVELLED SURFACES SQUARE TAPER WASHERS OF 5 mm MEAN THICKNESS SHALL BE PROVIDED UNDER NUT OR HEAD AS APPROPRIATE.

4.0 WELDING

- 4.1 WELDING USED IN THE FABRICATION WORK IS TO BE BY THE METALLIC ARC PROCESS USING ELECTRODES COMPLYING WITH THE REQUIREMENTS OF BS 639. THE WHOLE OF THE WORK IS TO BE IN ACCORDANCE WITH THE REQUIREMENTS LAID DOWN IN BS 5950 AND 5135.
- 4.2 THE ENDS OF ALL STANCHIONS AND POSTS TOGETHER WITH GUSSETS WHERE PRESENT AND ALREADY WELDED ON, SHALL BE MACHINED SO THAT THE WHOLE AREA IS IN DIRECT CONTACT WITH THE BASE, BEARING OR CAP PLATE, SUCH PLATES BEING TRULY AT RIGHT ANGLES TO THE STANCHION AXIS OR AS OTHERWISE SPECIFIED ON THE DRAWING.
- 4.3 MINIMUM SIZE OF WELD SHALL BE 6 mm UNLESS SPECIFIED.

5.0 FLOORING AND GRATING

- 5.1 STAIR TREADS SHALL BE OF HOT DIP GALVANIZED GRATING.
- 5.2 SOLID FLOORING SHALL BE MADE OF TEAR PLATE (DURBAR OR EQUIVALENT).
- 5.3 CHEQUERED PLATE SHALL NOT BE USED FOR PLATFORMS IN OIL AND GAS PROCESSING PLANTS. HOWEVER CHEQUERED PLATE FLOORING IS PERMITTED TO BE USED AS TRENCH COVERING WITHIN CONTROL BUILDINGS AND ELECTRICAL SUBSTATIONS.
- 5.4 FOR OPEN FLOORING GALVANIZED GRATING SHALL BE USED. THE MAIN BARS OF THE GRATING SHALL BE 25x5mm MINIMUM AT A CENTRE LINE SPACING OF 33 mm. LATERAL RESTRAINT SHALL BE PROVIDED BY 6 mm SQUARE TRANSVERSE BARS AT A SPACING OF 33 mm, WELDED INTO THE UPPER EDGE OF THE MAIN BARS. FIXING MATERIAL SHALL BE HOT DIP GALVANIZED TO BS EN ISO 1461:1999

6.0 ERECTION

- 6.1 ERECTION ON CONCRETE FOUNDATION SHALL NOT COMMENCE WITHIN 7 DAYS OF POURING THE CONCRETE FOUNDATIONS AND ONLY IF THE CONCRETE HAS ACQUIRED SUFFICIENT STRENGTH.
- 6.2 THE CONTRACTOR SHALL PROPERLY ALIGN EACH PART OF THE STRUCTURE BEFORE MAKING THE FIELD CONNECTIONS.
- 6.3 THE CONTRACTOR SHALL ENTIRELY BE RESPONSIBLE FOR THE STABILITY OF THE STEELWORK DURING ERECTION AND HE SHALL ARRANGE FOR ALL TEMPORARY GUYING, BRACING AND SUPPORTS TOGETHER WITH ANY ADDITIONAL TACK BOLTS NECESSARY FOR THE STABILITY OF THE STEELWORK UNTIL FINAL BOLTING UP.
- 6.4 THE STEELWORK SHALL BE ACCURATELY ERECTED WITHIN THE FOLLOWING TOLERANCE.

SETTING OUT-PLAN DIMENSIONS } $\pm 10\text{mm}$ OVERALL BUILDING BUT NOT MORE THAN $\pm 5\text{mm}$ IN ANY ONE 5 METER BAY

LEVELS-FOR STANCHIONS AND COLUMN BASE PLATES. } $\pm 5\text{mm}$

PLUMB OF STANCHIONS, POSTS, ETC } 0.1 % OF HEIGHT, BUT NOT MORE THAN $\pm 5\text{ mm}$ OVERALL

STRAIGHTNESS OR BOW OR OUT OF SQUARENESS OF SECTIONS AFTER ERECTION. } NOT MORE THAN THE ROLLING TOLERANCES AS GIVEN IN BS 5950 PART 2:2001

7.0 HOT-DIP GALVANIZING

- 7.1 THE SURFACE OF ALL STEEL DESCRIBED AS GALVANISED ARE TO BE THOROUGHLY AND EVENLY COATED. THE AVERAGE WEIGHT OF THE ZINC LAYER SHALL BE 610g/m^2 OF GALVANIZED SURFACE.
- 7.2 ALL DAMAGED GALVANIZED SURFACES AND ALL EDGES EXPOSED BY CUTTING AFTER GALVANIZING SHALL BE TREATED WITH TWO COATS OF ZINC PAINT SPRAYED IN ACCORDANCE WITH BS EN ISO 1461-1999.

8.0 CORROSION PROTECTION

- 8.1 CORROSION PROTECTION FOR STRUCTURAL STEEL SHALL BE IN ACCORDANCE WITH CONSTRUCTION SPECIFICATION SP-1279 PART N CIVIL AND BUILDING CONSTRUCTION SPECIFICATION, PAINTING AND DECORATING. FOR ALL STEEL STRUCTURES WITHIN OIL & GAS PLANT SHALL BE AS PER SP-1246.

9.0 EARTHING CONNECTIONS

- 9.1 PROVIDE EARTHING BOSS FOR ALL COLUMNS AND STAIR STRINGERS RESTING ON GROUND / FOUNDATIONS. THE EARTHING BOSS DETAILS SHALL CONFIRM TO DRG No. STD-4-0305-01- -4

LEGEND

	TEAR PLATE
	GRATING
	HOLE
	POCKET OR RECESS
	ELEVATION
	FENCE
	GRADE
	ANCHOR BOLT
	PIPE OR SLEEVE
	MATERIAL ITEM
	FILLET WELD-WELD SIZE
	FIELD WELD
	WELD ALL ROUND
	FULL PENETRATION WELD TYPE GROVE BEVEL WELD.
	GRATING SPAN








ABBREVIATIONS

AB	DENOTES	ANCHOR BOLTS	M 20	METRIC BOLT AND DIAMETER
ALT		ALTERNATE	MKD	MARKED
BOS		BOTTOM OF STEEL	NF	NEAR FACE
BF		BOTH FACES	ϕ	DIAMETER
C		CENTRE LINE	\square / SQ	SQUARE
CTC		CENTRE TO CENTRE	OD	OUTSIDE DIAMETER
CONC		CONCRETE	PLT	PLATE
DIA		DIAMETER	PTFE	POLYTETRAFLUORETHYLENE
DWG / DRG		DRAWING	PS	PIPE SUPPORT
DET		DETAIL	RAD	RADIUS
EL / ELEV		ELEVATION	REQD	REQUIRED
FF		FAR FACE	REF	REFER
FP		FIXED POINT	SCHED	SCHEDULE
FDN / FOUND		FOUNDATION	SECT / SEC	SECTION
GALV		GALVANIZED	SP	SLIDING POINT
HSFG BOLTS		HIGH STRENGTH FRICTION GRIP BOLTS	STGD	STAGGERED
HSB		HIGH STRENGTH BOLT (A325 OR EQUIVALENT)	THK	THICK
ID		INSIDE DIAMETER	TOG	TOP OF GRATING
LG		LONG OR LENGTH	TOS	TOP OF STEEL
			TYP	TYPICAL
			WP	WORKING POINT

APPROVED FOR
CONSTRUCTION

REV	DATE	DRAWN BY	CHECKED	DESCRIPTION	WBS No.	PROJ. ENG.	SIGNATURE
A	27.02.11	GCS	RB	APPROVED FOR CONSTRUCTION	IN.09.011	OSE/28N	
O	26.02.11	GCS	KBR	ISSUED FOR COMMENTS	IN.09.011	OSE/28N	
				PROJECT DRAWING REVISION			
				IN CASE OF DEVIATIONS A MARKED UP PRINT SHALL BE SENT TO THE PROJECT ENGINEER			
AREA : NIMR				SCALE : —	CAD DRAWING		
SUB AREA : PRODUCTION STATION				NO. 05	شركة تنمية نفط عُمان Petrochem Development Oman		
DRWG TYPE : STEEL STRUCTURE							
DESCRIPTION : GENERAL NOTES, LEGEND AND ABBREVIATIONS							
DRWG	AREA CODE	ENG SECT	SERIAL NUMBER	SHEET	PROJ CODE	DWG SIZE	REV.
NO	NIM	2	5771	002	DQ	3	A

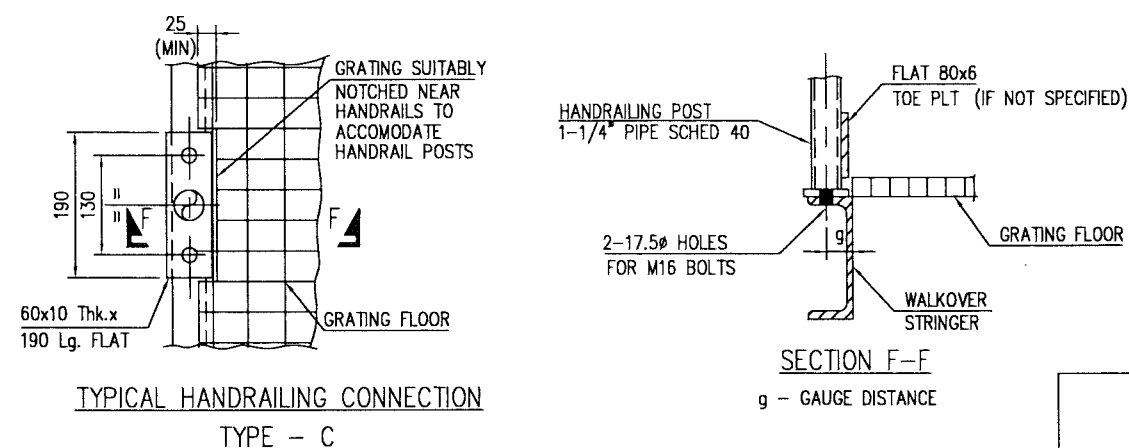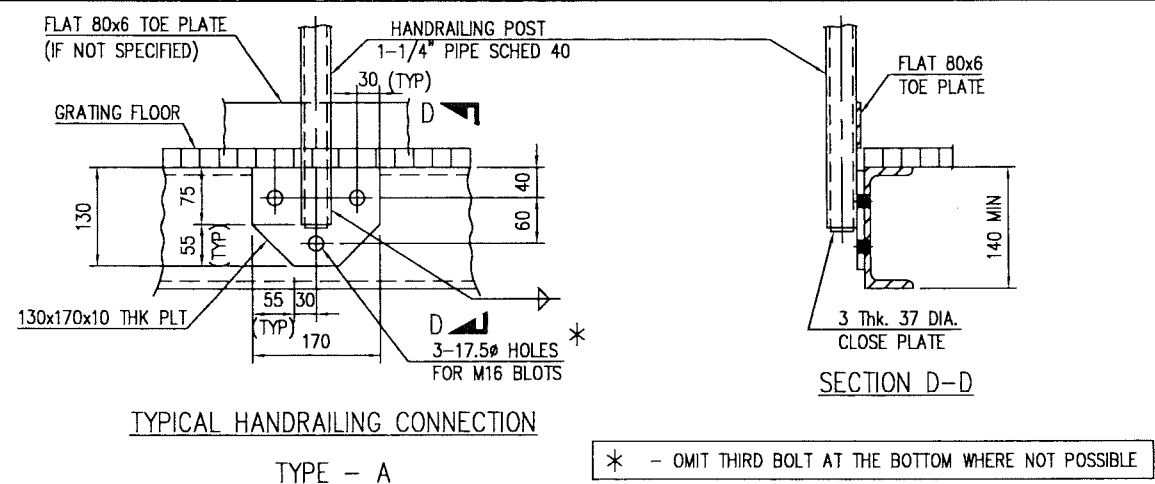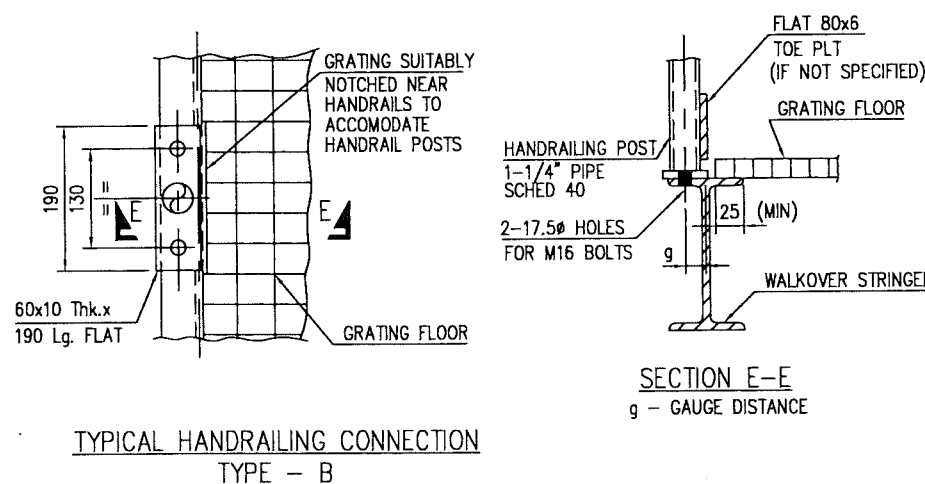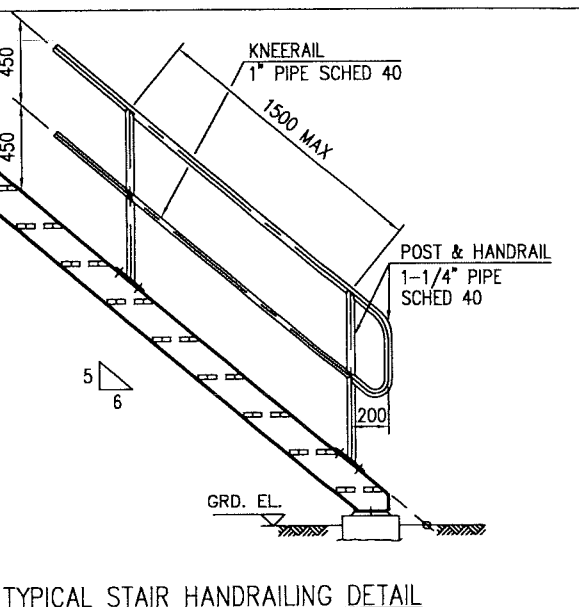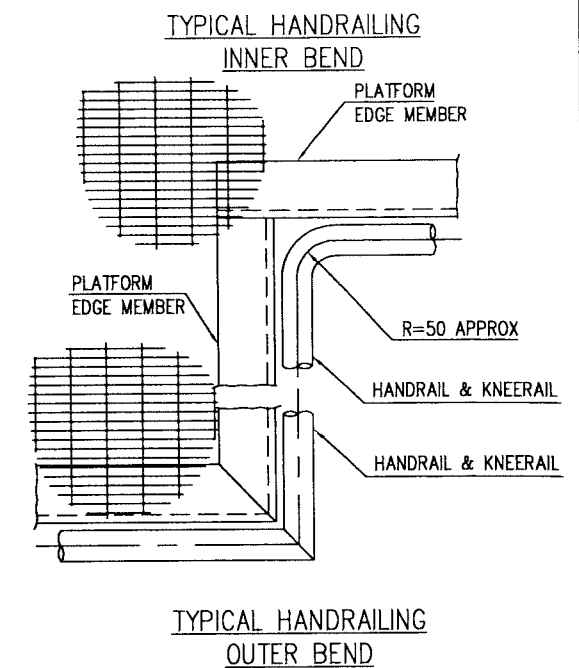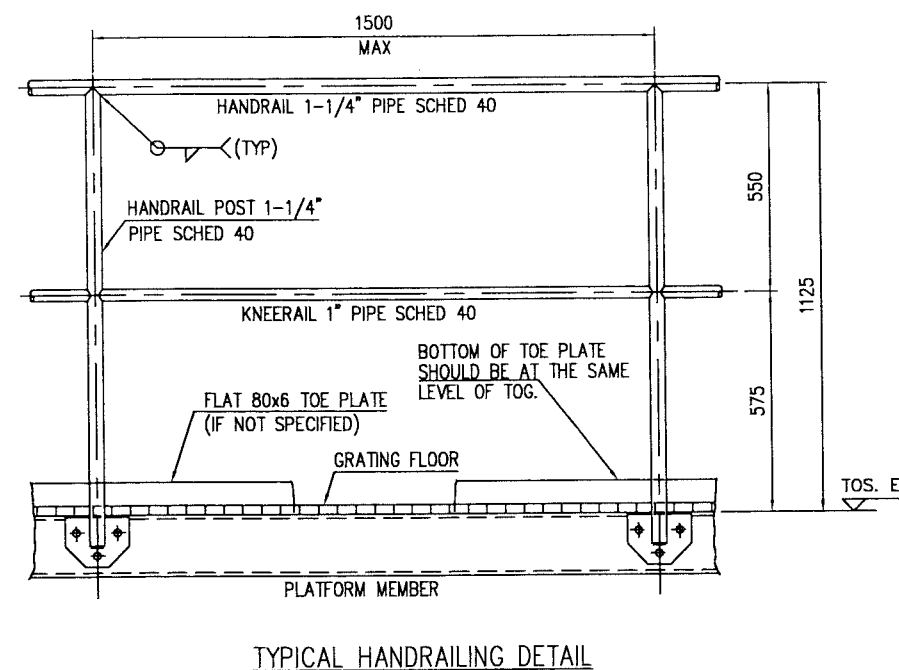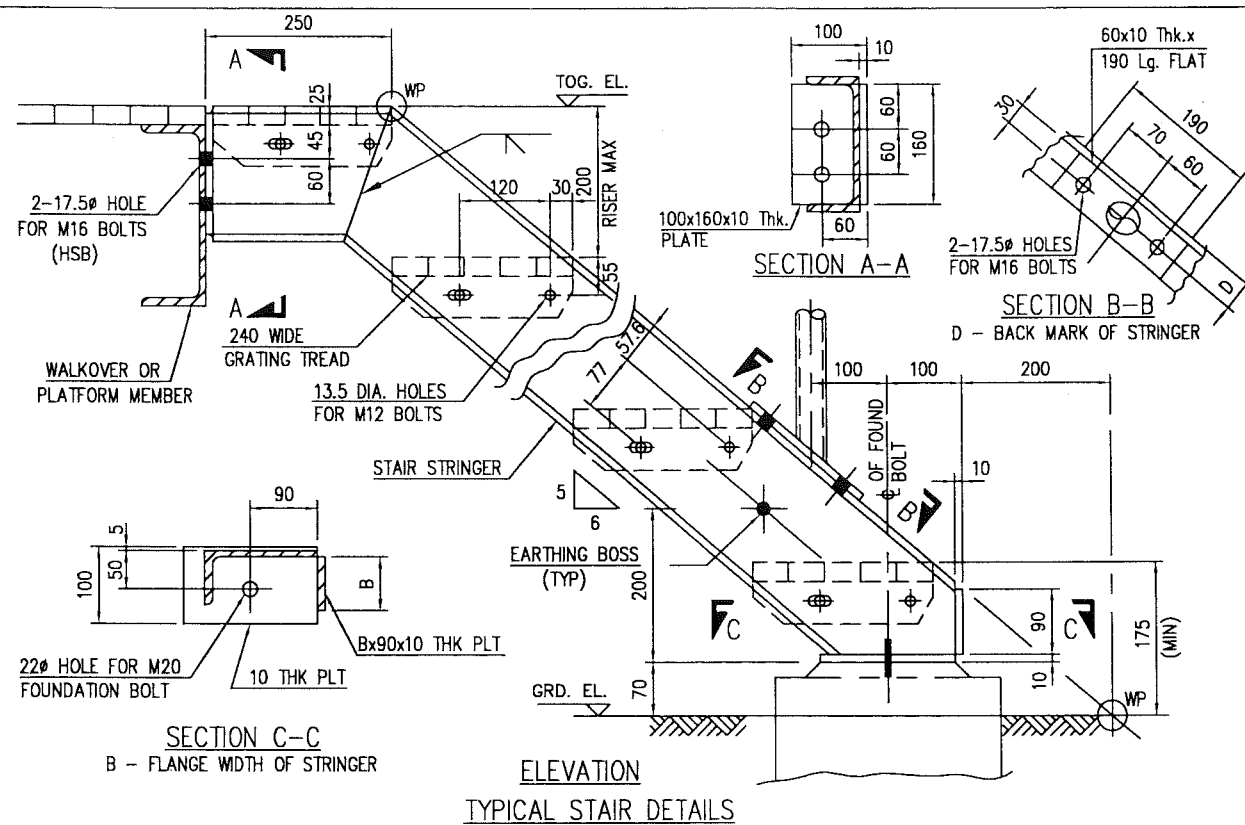

	ورلي بارسونز - الصناعات العربية (محصاة) WorleyParsons - Arabian Industries (JV)
CONTRACT NO. : C31/0606	PROJ. NO. : PAIP00405



NOTES



1. THE DETAILS SHOWN ON THIS DRAWING IS ONLY TYPICAL
HOWEVER DETAIL DRAWING FOR ALL STAIRS AND HANDRAILING TO THE EXACT
LOCATION REQUIRED SHALL BE DRAWN OUT BASED ON THESE DETAILS

1. FOR GENERAL NOTES, LEGEND AND ABBREVIATIONS. __ NIM -2-5771-002-CN-3
2. EARTHING BOSS ____ STD -4-0305-001-00-4





 (محاصة) **ورولي پارسونز - الصناعات العربية**
WorleyParsons - Arabian Industries (JV)
 CONTRACT NO. : **C31/0606** PROJ. NO. : **PAIP00405**

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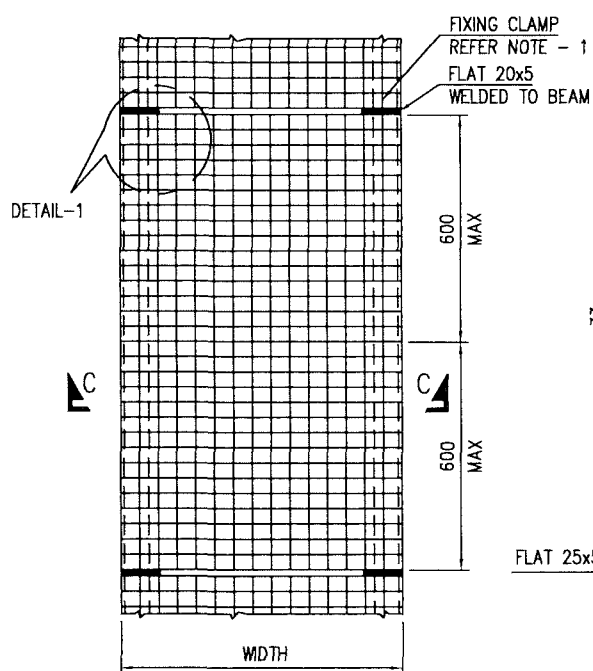
APPROVED FOR
CONSTRUCTION

A	27.02.11	GCS	RB	N.	APPROVED FOR CONSTRUCTION	IN.09.011	OSE/28N	
O	26.02.11	GCS	KBR	GSB	ISSUED FOR COMMENTS	IN.09.011	OSE/28N	
REV	DATE	DRAWN BY	TEAM L.	J.ENG.	DESCRIPTION	WBS No.	PROJ. ENG.	SIGNATURE
		CHECKED					P D O APPROVAL	
PROJECT DRAWING REVISION								
IN CASE OF DEVIATIONS A MARKED UP PRINT SHALL BE SENT TO THE PROJECT ENGINEER								
AREA : NIMR						SCALE : 1:1 0 1 2 3 4 5 6 7  CAD DRAWING		
SUB AREA : PRODUCTION STATION					No. 05	 شركة تنمية نفط عُمان Petro Development Oman		
DRWG. TYPE : STRUCTURAL STEEL DETAILS								
DESCRIPTION : TYPICAL STAIR AND HANDRAILING								
NO	AREA CODE	ENG SECT	SERIAL NUMBER	SHEET	PROJ CODE	DWG SIZE	REV.	
NIM	2	5771	003DQ	3	A			



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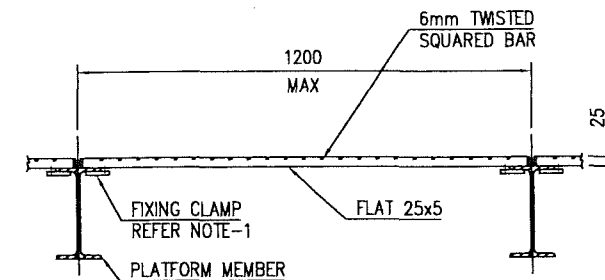
TYPICAL GRATING TREAD

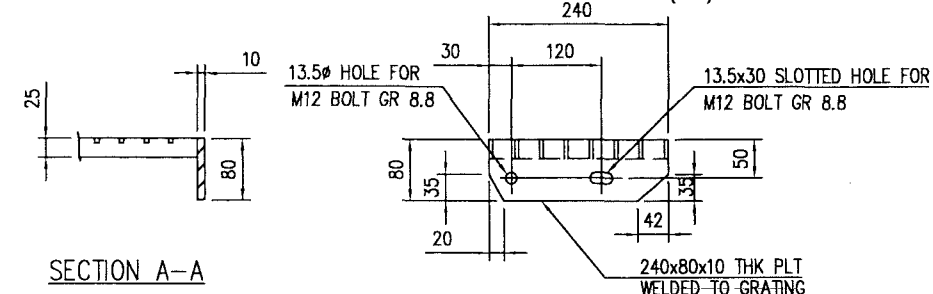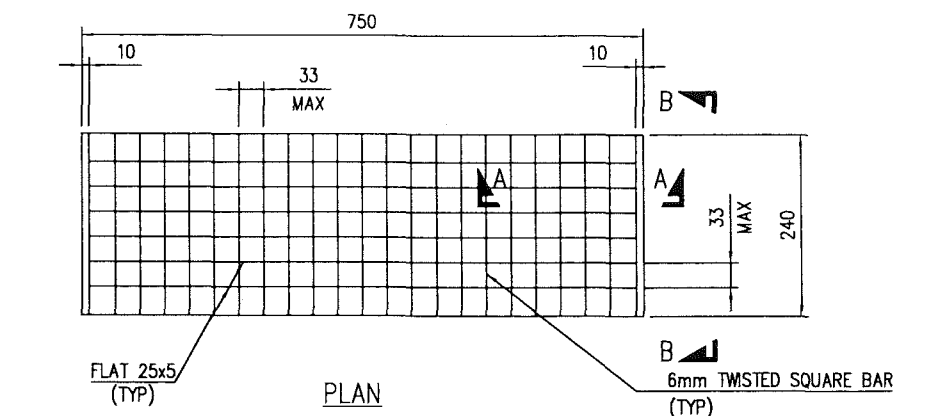


TYPICAL WALKWAY GRATING



TYPICAL PLATFORM GRATING

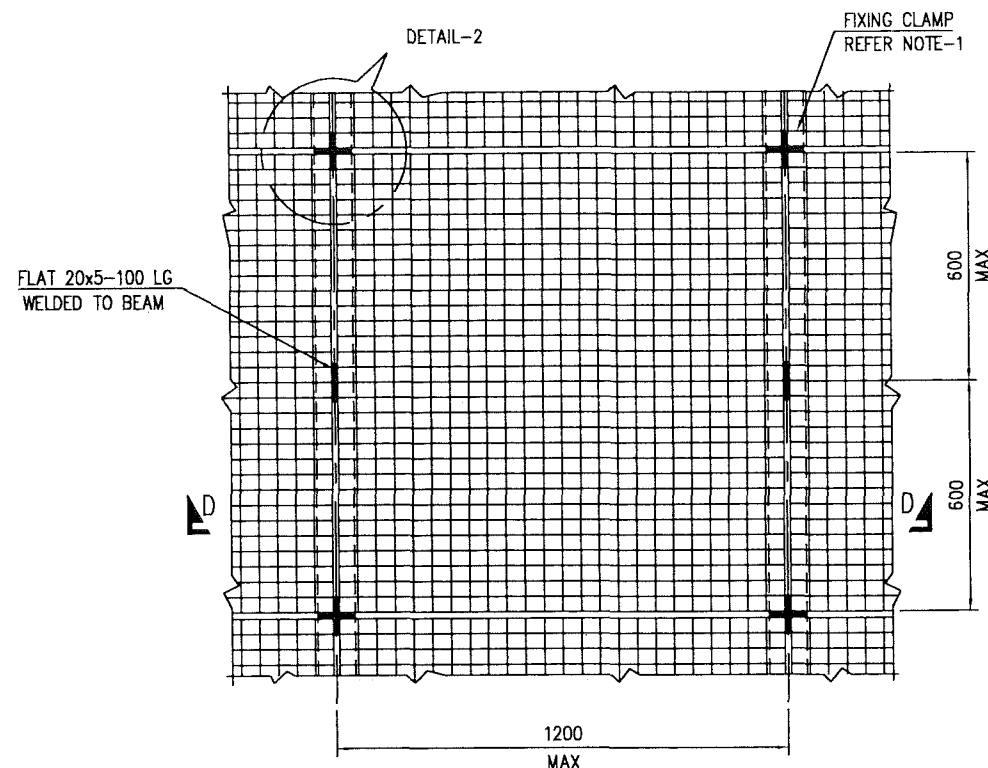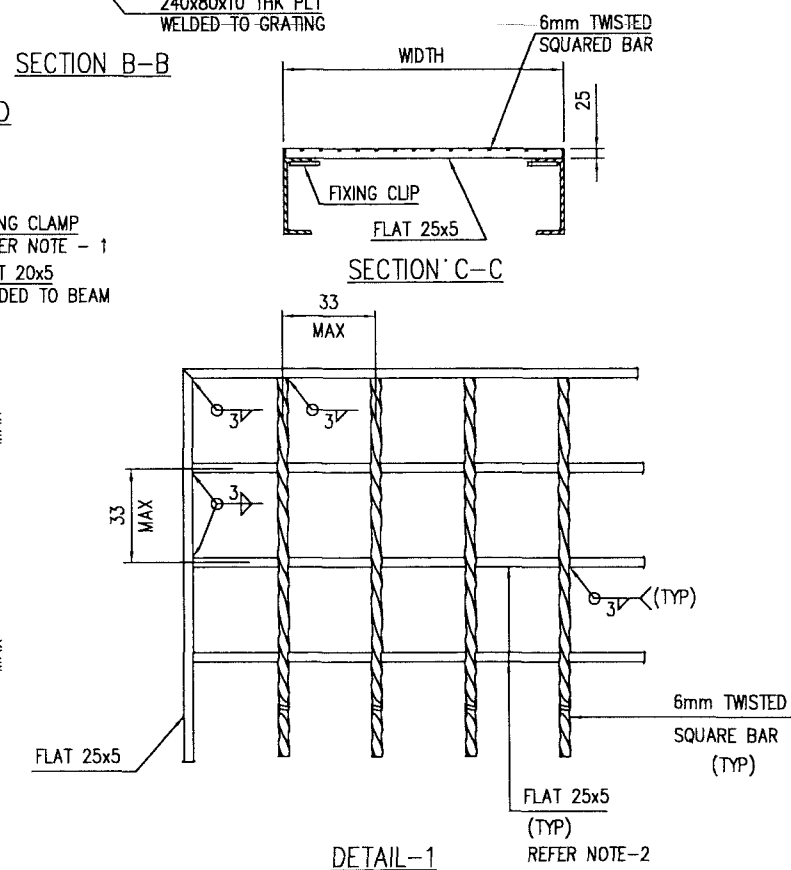

SECTION D-D

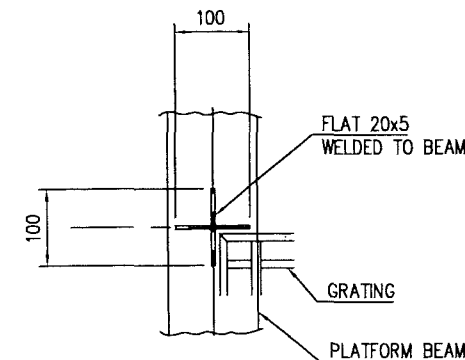

DETAIL-2

APPROVED FOR
CONSTRUCTION

REV	DATE	DRAWN BY	CHECKED	DESCRIPTION	WBS No.	PROJ. ENG.	SIGNATURE
A	27.02.11	GCS	RB	APPROVED FOR CONSTRUCTION	IN.09.011	OSE/28N	
O	26.02.11	GCS	KBR	ISSUED FOR COMMENTS	IN.09.011	OSE/28N	

PROJECT DRAWING REVISION
IN CASE OF DEVIATIONS A MARKED UP PRINT SHALL BE SENT TO THE PROJECT ENGINEER

AREA : NIMR
SCALE : NTS
CAD DRAWING

SUB AREA : PRODUCTION STATION
NO. 05

DRWG. TYPE : STRUCTURAL STEEL DETAILS

DESCRIPTION : TYPICAL GRATING AND TREAD DETAILS

NO NIM 2 5771004 DQ 3 A

- NOTES
- EACH GRATING PANEL TO BE FIXED TO FLOOR BEAMS BY MEANS OF ATLEAST 4 CLAMPS (IN CASE OF VERY LARGE PANELS MIN 4 CLAMPS/m²) GALVANISED.
 - AFTER COMPLETION OF GRATING PANELS & GRATING TREADS TO BE HOT DIP GALVANISED (610 g/m²)

REFERENCE DRAWINGS

- FOR GENERAL NOTES, LEGEND AND ABBREVIATIONS. — NIM -2-5771-002-CN-3

WorleyParsons - Arabian Industries (JV)
CONTRACT NO.: C31/0606 PROJ. NO.: PAIP00405

BAR SHAPE CODES

00 $L = A$	01 $L = A$, STOCK LENGTHS	11 $A \geq B \geq P$ $L = A+B-0.5r-d$	12 $A \geq B \geq P \text{ \& } (R+5d)$ $L = A+B-0.43R-1.2d$	13 $A \geq C \geq P \text{ \& } (B/2+5d)$ $B \geq 2r+2d$ $L = A+0.57B+C-1.6d$	14 $A \geq C \geq P$ $L = A+C-4d$	15 $A \geq C \geq P$ $L = A+C$	21 $A \geq C \geq P$ $L = A+B+C-r-2d$	22 $C \geq 2r+2d$ $A \geq D \geq P \text{ \& } (C/2+5d)$ $L = A+B+C+D-1.5r-3d$	23 $A \geq C \geq P$ $L = A+B+C-r-2d$	24 $L = A+B+C$
25 $A \geq B \geq P$ $L = A+B+E$	26 $D \geq 2d$ $A \geq C \geq P$ $L = A+B+C$	27 $A \geq C \geq P$ $L = A+B+C-0.5r-d$	28 $C \geq P$ $L = A+B+C-0.5r-d$	29 $A \geq C \geq P$ $L = A+B+C-r-2d$	31 $A \geq D \geq P$ $L = A+B+C+D-1.5r-3d$	32 $A \geq D \geq P$ $L = A+B+C+D-1.5r-3d$	33 $A \geq 12d+30mm$ $B \geq 2r+2d$ $C \geq P, B/2+5d$ $L = 2A+1.7B+2C-4d$	34 $A \geq E \geq P$ $L = A+B+C+E-0.5r-d$	35 $A \geq E \geq P$ $L = A+B+C+E-0.5r-d$	36 $A \geq D \geq P$ $L = A+B+C+D-r-2d$
41 $A \geq E \geq P$ $L = A+B+C+D+E-2r-4d$	44 $A \geq E \geq P$ $L = A+B+C+D+E-2r-4d$	46 $D \geq 2d$ $A \geq E \geq P$ $L = A+B+C+E$	47 $P \leq C \leq A$ $L = 2A+B+Max(21d, 240)$	51 $A \geq B \geq P$ $L = 2(A+B)+max(16d, 150)$	56 $E \geq F \geq P$ $L = A+B+C+D+2E-2.5r-5d$	63 $C \geq D \geq P$ $L = 2A+3B+max(14d, 150)$	64 $A \geq F \geq P$ $L = A+B+C+D+E+F-3r-6d$	67 $L = A$	75 $B = LAP$ $L = 3.14 \cdot (A-d)+B$	77 $C = NO. OF TURNS$ $(F \cdot B \leq A/5) L = C \cdot 3.14 \cdot (A-d)$ $(F \cdot B > A/5) L = C \cdot ((3.14 \cdot (A-d)) + B) \cdot 1.5$
98 $C \geq D \geq P$ $L = A+B+C+D-2r-4d$	99a $C \geq P$ $B \geq 2r+2d$ $L = A+1.14B+2C-3.2d$	99b $A \geq P$ $L = A+B+C+E$	99c $A \geq C \geq P$ $L = A+C+(3.14 \cdot R/2)$	99d $A \geq P$ $L = 2(A+B+D)+E-r-2d$	99e $A \geq P$ $L = A+B+C+D-r-2d$	99f $A \geq E \geq P$ $L = A+B+C+E-r-2d$	99g $A \geq P$ $L = 2(A+B+C)+D-r-2d$	99h $A \geq P$ $L = A+B+C+D+500-r-2d$	99j $A \geq P$ $L = 2A+B+C-0.5r-d$	99k $A \geq P$ $L = 2(A+B)+C-r-2d$
99m $D \geq 2d$ $A \geq E \geq P$ $L = A+B+C+E$	99n $A \geq E \geq P$ $L = A+B+C+E-0.5r-d$	99p $A \geq C \geq P$ $L = A+B+C-r-2d$	99q $A \geq C \geq P$ $L = A+B+C-r-2d$	99r $A \geq C \geq P$ $L = A+B+C-r-2d$	99s $A \geq B \geq P$ $L = A+B-0.5r-d$	99t $L = 4A+16d$	99u $A \geq D \geq P$ $L = A+B+C+D-1.5r-3d$			

BAR SIZE d	r	MINIMUM END PROJECTION - P		OVERALL DIM X TWO BENDS	SKETCH
		$\geq 150'$ (min 5d Straight)	$< 150'$ (min 10d Straight)		
6	12	110 ^a	110 ^a	60	
8	16	115 ^a	115 ^a	80	
10	20	120 ^a	130	100	
12	24	125 ^a	160	120	
16	32	130	210	160	
20	70	190	290	260	
25	87	240	365	325	
32	112	305	465	420	
40	140	380	580	520	
50	175	475	725	650	

a - THE MINIMUM END PROJECTIONS FOR SMALLER BARS IS GOVERNED BY THE PRACTICALITIES OF BENDING BARS.

NOTES:

1. THE STEEL REINFORCEMENT GRADE SHALL CONFORM TO BS 4449.
2. THE BAR SHAPE CODES SHALL BE IN ACCORDANCE WITH BS 8666 :2005 UNLESS NOTED OTHERWISE.




CONTRACT NO.: C31/0606 PROJ. NO.: PAIP00405

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APPROVED FOR
CONSTRUCTION

REV	DATE	DRAWN BY	CHECKED	DESCRIPTION	WBS No.	PROJ. ENG.	SIGNATURE
A	27.02.11	GCS	RB	APPROVED FOR CONSTRUCTION	IN.09.011	OSE/28N	
O	26.02.11	GCS	KBR	ISSUED FOR COMMENTS	IN.09.011	OSE/28N	

PROJECT DRAWING REVISION				CAD DRAWING			
IN CASE OF DEVIATIONS A MARKED UP PRINT SHALL BE SENT TO THE PROJECT ENGINEER				SCALE : —			
AREA	: NIMR			0	1	2	3
SUB AREA	: PRODUCTION STATION			4	5	6	7
DRWG. TYPE	:			شركة تنمية نفط عُمان			
DESCRIPTION	: STANDARD BAR SHAPE CODES			Petroleum Development Oman			
NO	AREA CODE	ENG SECT	SERIAL NUMBER	SHEET	PROJ CODE	DWG SIZE	REV.
NIM	2	5771	005	DQ	3	A	

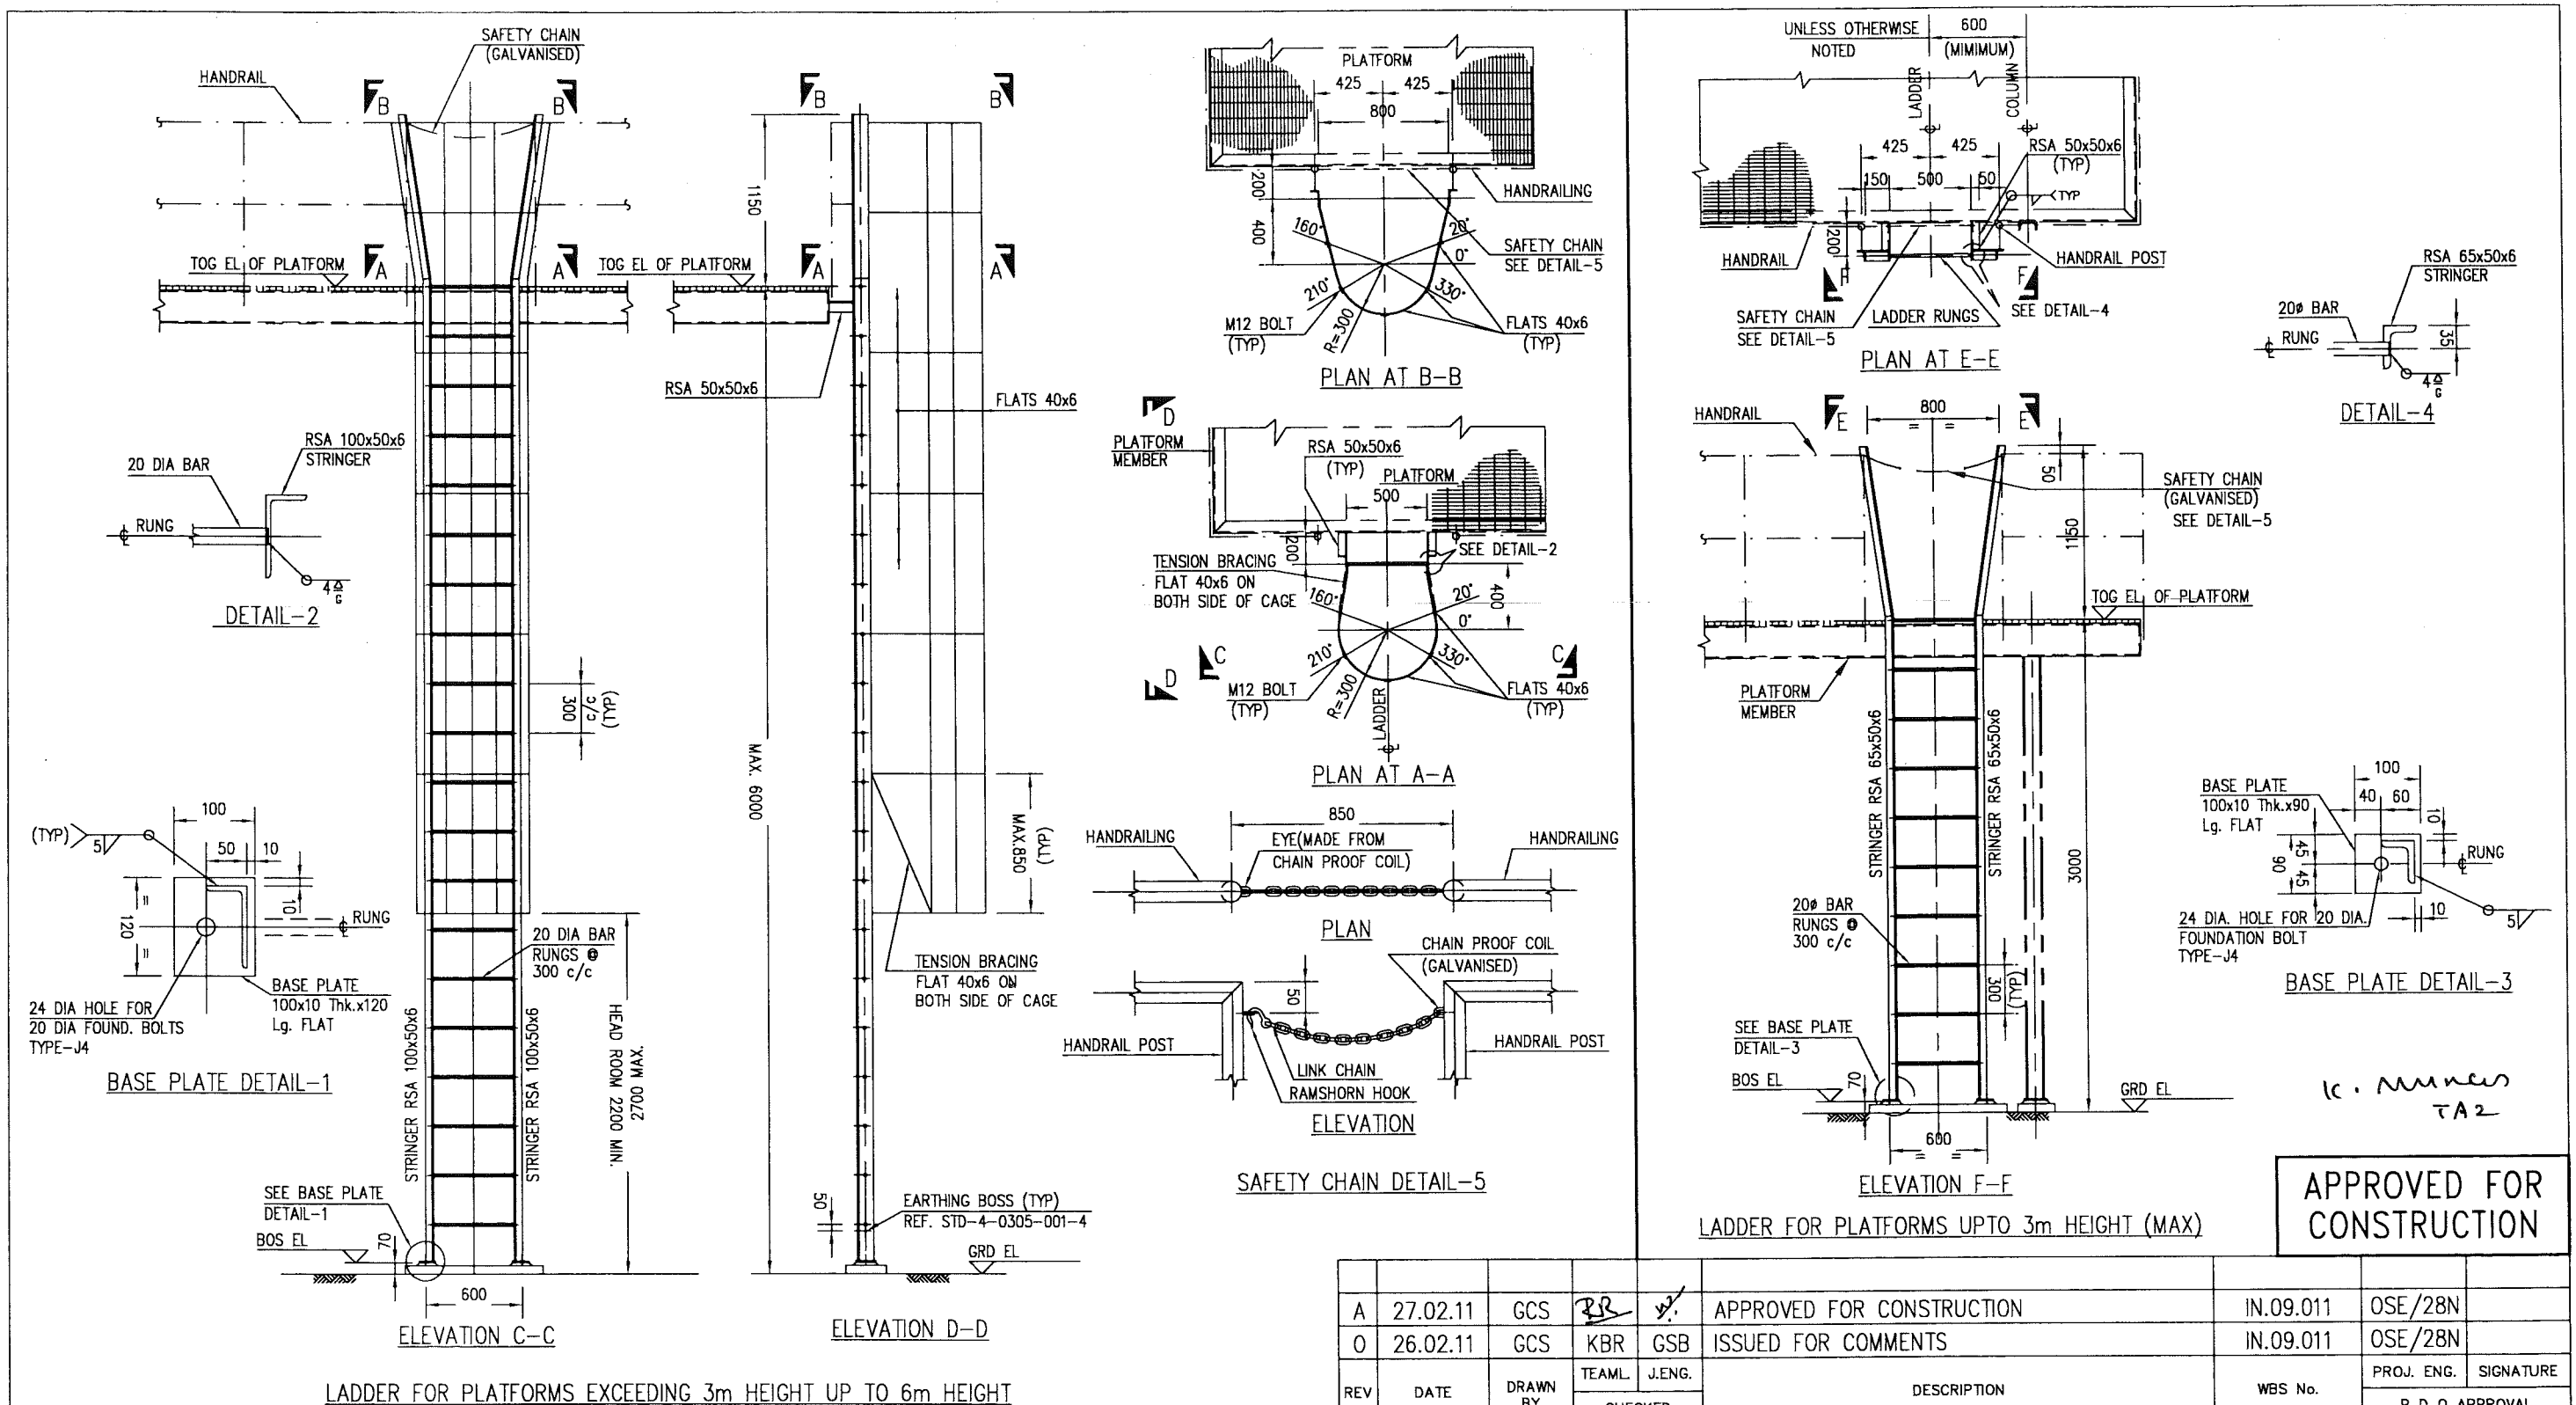


**THIS DRAWING IS
FOR REFERENCE ONLY**

NOTES
 IF LADDER RESTS ON GRATING FIX WITH M20 BOLT AND 100 SQx10 THK. WASHER.
 IF LADDER RESTS ON STRUCTURAL MEMBER, OMIT BASE PLATE AND WELD TO STRUCTURAL MEMBER.
 IF LADDER IS SUSPENDED FROM TOP MEMBER(S) OMIT BASE PLATE.
 FOR LOCATION OF LADDER REFER STRUCTURAL DRAWINGS.
REFERENCE DRAWINGS
 1. FOR GENERAL NOTES, LEGEND AND ABBREVIATIONS. — NIM-2-5771-002-DQ-3
 2. EARTHING BOSS — STD-4-0305-001-00-4
 3. STRUCTURAL MEMBERS ARE TO BE PAINTED AND GRATING & CLAMPS ARE TO BE GALVANISED

WorleyParsons - Arabian Industries (JV)
 CONTRACT NO.: C31/0606 PROJ. NO.: PAIP00405


REV	DATE	DRAWN BY	TEAM L.	J. ENG.	CHECKED	DESCRIPTION	WBS No.	PROJ. ENG.	SIGNATURE
A	27.02.11	GCS	BR	✓		APPROVED FOR CONSTRUCTION	IN.09.011	OSE/28N	
O	26.02.11	GCS	KBR	GSB		ISSUED FOR COMMENTS	IN.09.011	OSE/28N	

PROJECT DRAWING REVISION												
IN CASE OF DEVIATIONS A MARKED UP PRINT SHALL BE SENT TO THE PROJECT ENGINEER												
AREA : NIMR					SCALE : N.T.S. 0 1 2 3 4 5 6 7							
SUB AREA : PRODUCTION STATION					No. 05	 <div>شركة تنمية نفط عمان</div> <div>Petroleum Development Oman</div>						
DRWG. TYPE : STRUCTURAL STEEL												
DESCRIPTION : TYPICAL LADDER DETAILS (FRONT ENTRY)					DRWG	AREA CODE	ENG SECT	SERIAL NUMBER	SHEET	PROJ CODE	DWG SIZE	REV.
					NO	NIM	2	5771 006 DQ	3	A		


PIPE SUPPORT/ SLEEPER NUMBER	REFERENCE DRAWINGS			REMARKS
	STEELWORK DETAILS	SLEEPER/FOUNDATION DETAILS	LOCATION PLAN	
SL-001	-	NIM-2-5772-024-DQ-3	NIM-2-5604-005-DQ-1	-
SL-002	-	NIM-2-5772-024-DQ-3		-
SL-003	-	NIM-2-5772-026-DQ-3		-
SL-004	-	NIM-2-5772-028-DQ-3		-
SL-005	-	NIM-2-5772-026-DQ-3		-
SL-006	-	NIM-2-5772-028-DQ-3		-
SL-007	-	-	-	SPARE
SL-008	-	-	-	SPARE
SL-009	-	-	-	SPARE
SL-010	-	NIM-2-5772-030-DQ-3	NIM-2-5604-005-DQ-1	-
SL-011	-	NIM-2-5772-030-DQ-3	NIM-2-5210-001-DQ-1	-
SL-012	-	-	-	SPARE
SL-013	-	-	-	SPARE
SL-014	-	NIM-2-5772-030-DQ-3	NIM-2-5210-001-DQ-1	-
SL-015	-	NIM-2-5772-030-DQ-3	NIM-2-5210-001-DQ-1	-
SL-016	-	NIM-2-5772-030-DQ-3	NIM-2-5210-001-DQ-1	-
SL-017	-	-	-	SPARE
SL-018	-	-	-	SPARE
SL-019	-	NIM-2-5772-030-DQ-3	NIM-2-5210-001-DQ-1	-
SL-020	-	-	-	SPARE
SL-021	-	-	-	SPARE
SL-022	-	-	-	SPARE
SL-023	-	NIM-2-5774-003-DQ-3	NIM-2-5604-005-DQ-1	-
SL-024	-	-	-	-
SL-025	-	-	-	-
SL-026	-	-	-	-
SL-027	-	-	-	-
SL-028	-	-	-	-
SL-029	-	-	-	-
SL-030	-	-	-	-
SL-031	-	-	-	-

PIPE SUPPORT/ SLEEPER NUMBER	REFERENCE DRAWINGS			REMARKS
	STEELWORK DETAILS	SLEEPER/FOUNDATION DETAILS	LOCATION PLAN	
SL-032	-	-	-	-
SL-033	-	-	-	-
SL-034	-	-	-	-
SL-035	-	-	-	-
SL-036	-	-	-	-
SL-037	-	-	-	-
SL-038	-	-	-	-
SL-039	-	-	-	-
SL-040	-	-	-	-
SL-041	-	-	-	-
SL-042	-	-	-	-
SL-043	-	-	-	-
SL-044	-	-	-	-
SL-045	-	-	-	-
SL-046	-	-	-	-
SL-047	-	-	-	-
SL-048	-	-	-	-
SL-049	-	-	-	-
SL-050	-	-	-	-
SL-051	-	-	-	-
SL-052	-	-	-	-
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SL-054	-	-	-	-
SL-055	-	-	-	-
SL-056	-	-	-	-


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**APPROVED FOR
CONSTRUCTION**

 ورلي بارسونز - الصناعات العربية (محصاة) WorleyParsons - Arabian Industries (JV)		CONTRACT NO.: C31/0606		PROJ. NO.: PAIP00405	
		DESCRIPTION		AREA	S
1. CONTRACTOR SHALL REFER PIPING PLAN ,PRIOR TO FABRICATION, INSTALLATION OF PIPE SUPPORTS		DRAWING NUMBER		SERIAL	SH.
		DRAWING NUMBER		P	S
NOTES		REFERENCE DRAWINGS			


REV	DATE	DRAWN BY	TEAML	J.ENG.	CHECKED	DESCRIPTION	WBS No.	PROJ. ENG.	SIGNATURE
A	27.02.11	GCS	pe	✓		APPROVED FOR CONSTRUCTION	IN.09.011	OSE/28N	
O	26.02.11	GCS	KBR	GSB		ISSUED FOR COMMENTS	IN.09.011	OSE/28N	
PROJECT DRAWING REVISION									
IN CASE OF DEVIATIONS A MARKED UP PRINT SHALL BE SENT TO THE PROJECT ENGINEER									
AREA : NIMR							SCALE : NTS		
SUB AREA : PRODUCTION STATION							CAD DRAWING		
DRWG. TYPE : PIPE SUPPORTS							No. 05		
DESCRIPTION : INDEX SHEETS							شركة تنمية نفط عُمان		
							Petrochem Development Oman		
DRWG	AREA CODE	ENG SECT	SERIAL NUMBER	SHEET	PROJ CODE	DWG SIZE	REV.		
NO	NIM	2	5772	002	DQ	3	A		

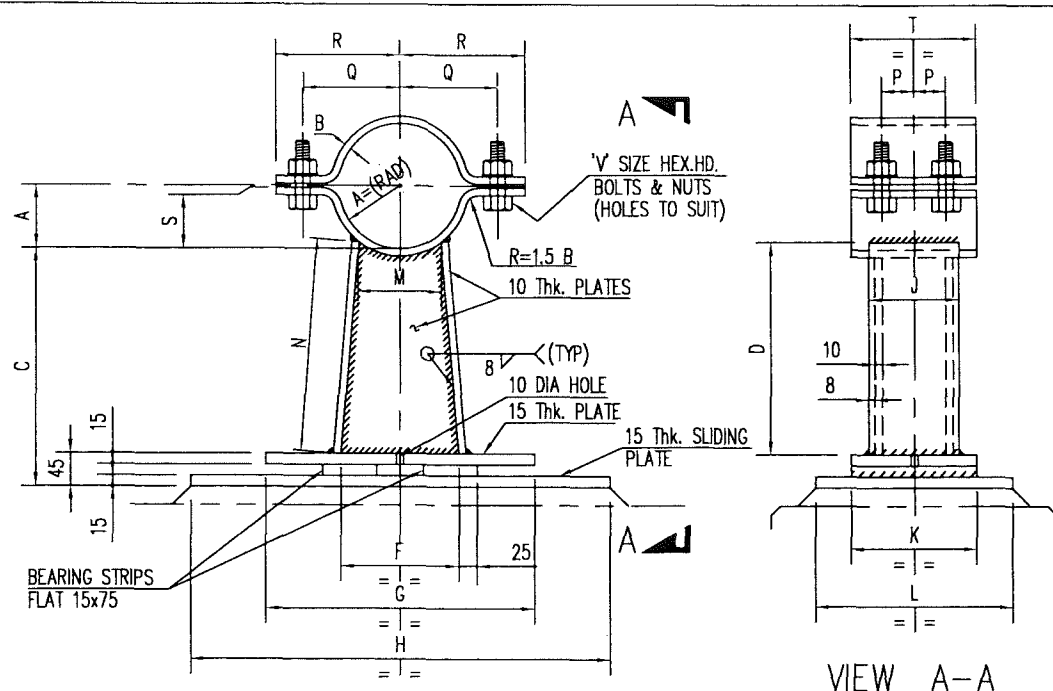


ELEVATION

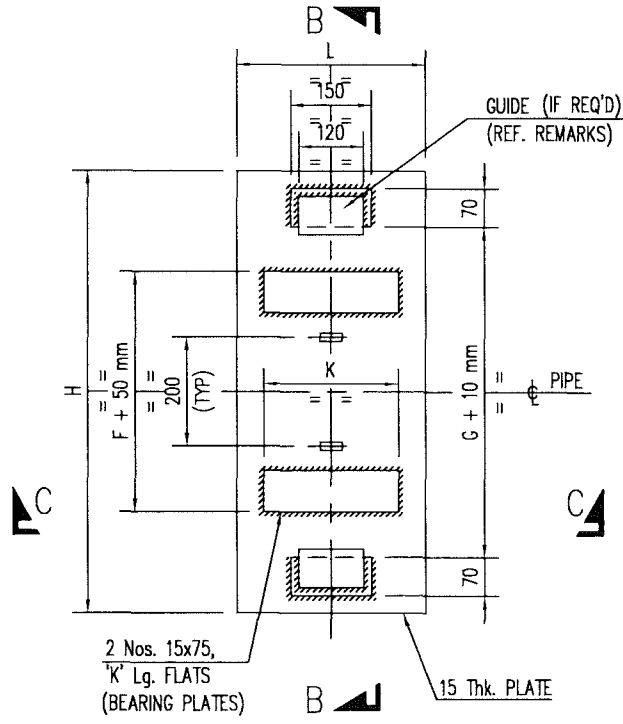


PLAN
SLIDING PLATE DETAILS

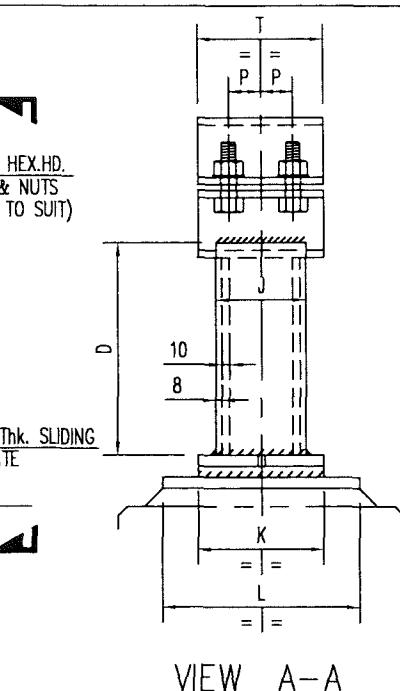

VIEW A-A

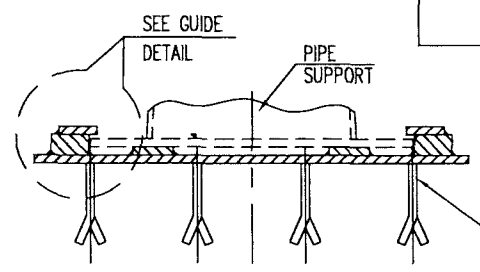

SECTION B-B

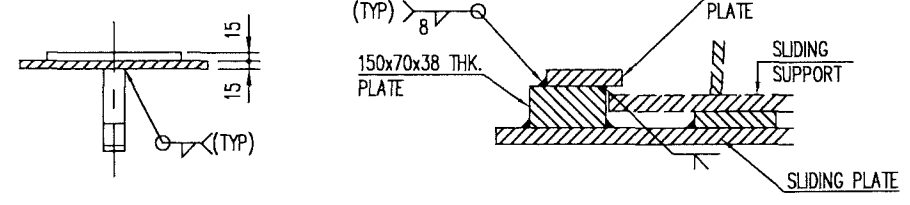

SECTION C-C

GUIDE DETAIL

* SUPPORT DETAIL SHOWN IS INDICATIVE ONLY FOR ACTUAL WELDED TO PIPE DETAILS REFER VENDOR DRG.

PIPE SUPPORTS	REFERENCE DRAWINGS	PIPE SIZE	BARREL SIZE	REMARKS
PS-001 *	NIM-2-5604-005-DQ-1	8"	8"	WITH GUIDE
PS-002 *		6"	6"	
PS-003		6"	6"	
PS-004		6"	6"	

SIZE DIM	PIPE				BARREL		
	4"	6"	8"	10"	6"	8"	10"
A	59	86	112	138	86	112	138
B	10	10	15	15	10	15	15
C	327	325	327	300	300	300	300
D	283	289	292	273	264	265	273
E	10	10	10	10	10	10	10
F	135	165	185	255	165	185	255
G	345	375	395	465	375	395	465
H	555	585	605	675	585	605	675
J	125	125	150	150	125	150	150
K	175	175	200	200	175	200	200
L	275	275	275	325	275	275	325
M	75	115	150	190	115	150	190
N	285	290	293	275	265	266	275
P	45	45	50	50	45	50	50
Q	108	136	162	195	136	162	195
R	146	174	200	220	174	200	220
S	55	82	107	135	82	107	130
T	175	175	200	200	175	200	200
U	3	3	3	3	3	3	3
V	M16x60	M20x80	M20x80	M20x80	M20x80	M20x80	M20x80
Nos. REQD.	-	2	-	-	-	-	-

SIZE DIM	PIPE / BARREL			
	12"	14"	16"	18"
A	164	180	205	231
B	15	15	15	15
C	300	300	300	300
D	280	283	290	299
E	10	10	10	10
F	310	325	390	425
G	520	535	600	635
H	730	745	810	845
J	150	175	175	175
K	200	250	250	250
L	325	350	350	350
M	225	245	280	320
N	283	286	295	303
P	50	60	60	60
Q	220	235	265	290
R	245	260	295	320
S	162	177	202	228
T	200	250	250	250
U	4	4	4	4
V	M20x80	M20x80	M20x80	M20x80
Nos. REQD.	-	-	-	-

M.T.O.			
DESCRIPTION	QUANTITY	UNITS	SAP No.
15x40 FLAT	1.80	m	1000132300
15x75 FLAT	1.10	m	1000132319
10 Thk. PLATE	0.66	m ²	1000062608
15 Thk. PLATE	0.85	m ²	1000080265
38 Thk. PLATE	0.09	m ²	1000122732
M16-60 Lg. BOLT WITH NUT & WASHER	-	PC	N.A.
M20-80 Lg. BOLT WITH NUT & WASHER	8	PC	N.A.

ic. number
TA2

APPROVED FOR
CONSTRUCTION

ورلي بارسونز - الصناعات العربية (محصاة)
WorleyParsons - Arabian Industries (JV)

CONTRACT NO.: C31/0606 PROJ. NO.: PAIP00405

REV	DATE	DRAWN BY	TEAM	J.ENG.	CHECKED	DESCRIPTION	WBS No.	PROJ. ENG.	SIGNATURE
A	27.02.11	GCS	RB	J.		APPROVED FOR CONSTRUCTION	IN.09.011	OSE/28N	
O	26.02.11	GCS	KBR	GSB		ISSUED FOR COMMENTS	IN.09.011	OSE/28N	




PROJECT DRAWING REVISION
IN CASE OF DEVIATIONS A MARKED UP PRINT SHALL BE SENT TO THE PROJECT ENGINEER

AREA : NIMR	SCALE : NTS	CAD DRAWING
SUB AREA : PRODUCTION STATION	NO. 05	
DRWG. TYPE : PIPE SUPPORTS		
DESCRIPTION : PS-001 TO PS-004		
NO	NIM 2 5772003DQ 3	A


- ALL DIMENSIONS ARE IN MILLIMETRES.
- ALL ELEVATIONS & CO-ORDINATES ARE IN METRES.
- ALL STEEL WORK TO BS EN 10025 GRADE S275 JR.
- ALL CONNECTIONS TO BE MADE USING 8mm CFW.
- ALL STEEL WORK TO RECEIVE CORROSION PROTECTION IN ACCORDANCE WITH DOCUMENT No. SP-1246-2

NOTES

REFERENCE DRAWINGS

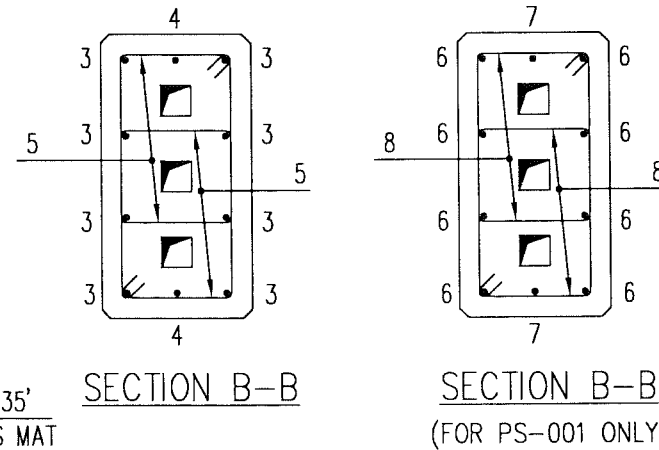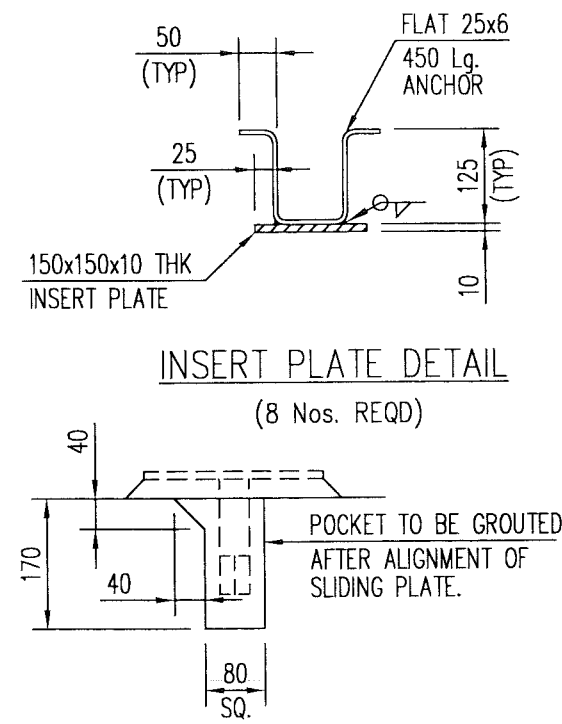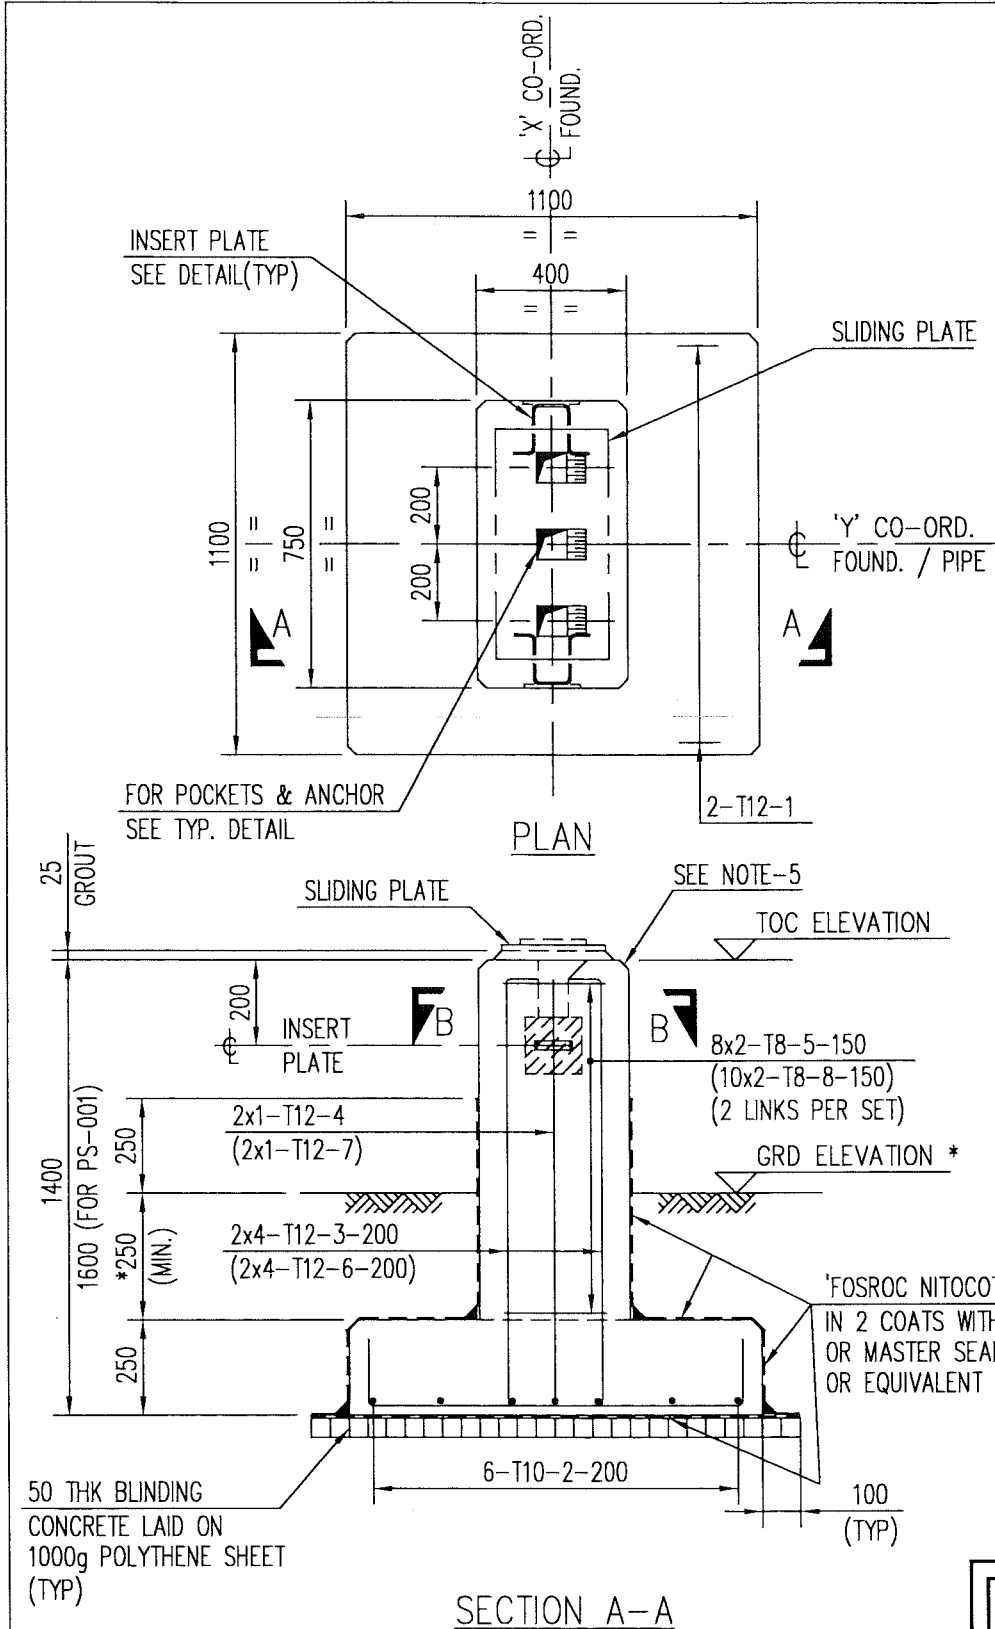

CONCRETE GRADE-35

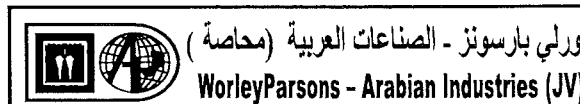

CONTRACT NO.: C31/0606 PROJ. NO.: PAIP00405

- ALL DIMENSIONS ARE IN MILLIMETRES AND ELEVATIONS IN METRES.
- CONCRETE TO BS 8110, GRADE 35 FOR REINFORCED CONCRETE, GRADE 10 FOR BLINDING CONCRETE USING OPC.
- 50mm COVER TO REINFORCEMENT, REINFORCEMENT TO BS 4449.
- ALL CONCRETE SURFACES IN CONTACT WITH SOIL AND TOP OF BLINDING CONCRETE SHALL BE TREATED WITH THREE COATS OF "FOSROC NITOCOTE PE135" WITH A DFT OF 600 MICRONS OR EQUIVALENT APPROVED.
- ALL EXPOSED CONCRETE SURFACES SHALL BE TREATED WITH TWO COATS OF "FOSROC DEKGUARD S" WITH A DFT OF 350 MICRONS OR ANY OTHER APPROVED EQUIVALENT.
- PIPE SUPPORTS-INDEX SHEET REFER DRG. No. NIM-2-5772-001-DQ-3
- FOR BAR BENDING SCHEDULE REFER DRG. No. NIM-2-5772-005-DQ-4

NOTES/REFERENCE DRAWINGS

M.T.O.			
DESCRIPTION	QUANTITY	UNITS	SAP No.
BLINDING CONCRETE	0.34	m ³	N.A.
CONCRETE GRADE 35	2.70	m ³	N.A.
CEMENT SAND GROUT	32.35	dm ³	N.A.
PROTECTION COATING	23.70	m ²	N.A.
REINFORCEMENT STEEL	146.42	kgs	N.A.
10 THK PLATE	0.20	m ²	1000062608
FLAT 25x6	3.60	m	1000062571
1000g POLYTHENE SHEET	6.80	m ²	N.A.

PIPE SUPPORT	REFERENCE DRAWINGS	*GRD. ELEVATION	TOC ELEVATION	ϕ CO-ORDINATES	
				'X'	'Y'
PS-001 **	NIM-2-5604-005-DQ-1	98.800	99.301	E 259.700	S 10.000
PS-002 **			99.299	E 261.852	S 10.000
PS-003			99.302	E 263.515	S 10.000
PS-004			99.302	E 267.121	S 10.000

NOTE: * DENOTES, SINCE GRADE ELEVATION VARIES, CONTRACTOR TO VERIFY ELEVATIONS AND DIMENSIONS AT SITE, PRIOR TO FABRICATION/CONSTRUCTION/INSTALLATION.

** TOC ELEVATION SHALL BE CHANGE ACCORDING TO VENDOR DETAIL


10. Amman
7 A2

APPROVED FOR
CONSTRUCTION

REV	DATE	DRAWN BY	CHECKED	DESCRIPTION	WBS No.	PROJ. ENG.	SIGNATURE
A	27.02.11	GCS	RB	APPROVED FOR CONSTRUCTION	IN.09.011	OSE/28N	
O	26.02.11	GCS	KBR	ISSUED FOR COMMENTS	IN.09.011	OSE/28N	

PROJECT DRAWING REVISION
IN CASE OF DEVIATIONS A MARKED UP PRINT SHALL BE SENT TO THE PROJECT ENGINEER

AREA	: NIMR	SCALE	: 1:20	CAD DRAWING
SUB AREA	: PRODUCTION STATION	NO.	05	
DRWG. TYPE	: PIPE SUPPORTS-FOUNDATION DETAILS			
DESCRIPTION	: PS-001 TO 004			
DRWG	AREA CODE	ENG SECT	SERIAL NUMBER	SHEET
NO	NIM	2	5772	004
				DQ
				3
				A

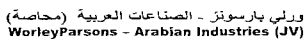

BAR BENDING SCHEDULE

JOB NO.: PAIP00238
PART ID.: PRODUCTION STATION
PS-001 TO 004

Document No.: NIM-2-5772-005-DQ-4

Revision No.: A

Prepared by: GCS

Checked by: PNG

Date: 27.02.11

REF. DWG NO.: NIM-2-5772-004-DQ-3

Total MTO for Rebars.

Dia. Of Bar	T6	T8	T10	T12	T16	T20	T25	T32
Length of Bar (m)		113.90	30.60	92.00				
Weight (Kgs)		45.56	18.98	81.88				

Total Weight (Kgs)

146.420

1c. Answer
TA2

[illegible]


This schedule complies with BS 8666 : 2005

All dimensions are in mm

Refer to Bar shape Code drawing

* Specified in multiples of 5 mm

† Specified in multiples of 25 mm

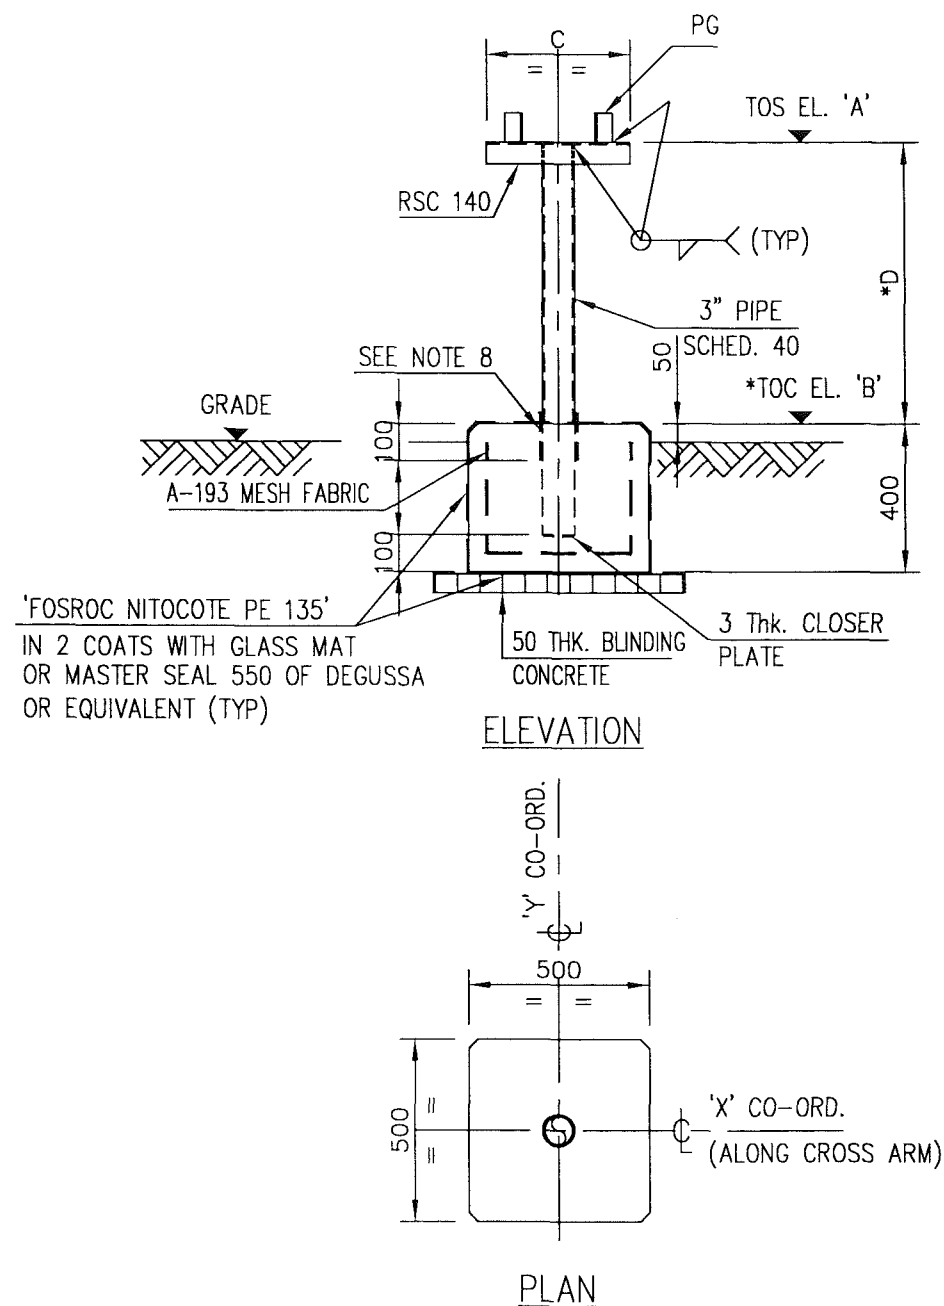

SUPPORT NUMBER	REFERENCE DRAWING	ELEVATIONS		DIMENSIONS		PIPE GUIDE	Nos. REQD.	CO-ORDINATES	
		A	*B	C	*D			X	Y
PS-006	NIM-2-5604-005-DQ-1	99.436	98.850	230	586	PG-2	1	E 259.700	S 9.250

NOTE: * DENOTES, SINCE GRADE ELEVATION VARIES, CONTRACTOR TO VERIFY ELEVATIONS AND DIMENSIONS AT SITE, PRIOR TO FABRICATION/CONSTRUCTION/INSTALLATION.

M T O			
DESCRIPTION	QUANTITY	UNITS	SAP No.
3" SCHEDULE 40 PIPE	0.90	m	1000051540
3 THK PLATE	0.06	m ²	1000062605
RSC 140	0.23	m	1000080366
A 193 MESH FABRIC	0.64	m ²	1000062697
BLINDING CONCRETE	0.02	m ³	N.A.
CONCRETE GRADE 35	0.10	m ³	N.A.
1000g POLYTHENE SHEET	0.50	m ²	N.A.
PROTECTIVE COATING	1.80	m ²	N.A.

ic. Amner
TA2

APPROVED FOR
CONSTRUCTION

- ALL DIMENSIONS ARE IN MILLIMETRES EXCEPT PIPE SIZE.
- ALL ELEVATIONS & CO-ORDINATES ARE IN METRES.
- ALL STEEL WORK TO BS EN 10025 GRADE S275 JR
- PIPE SECTION TO API 5L GR B.
- ALL CONNECTIONS TO BE MADE USING 5mm CFW.
- ALL STEEL WORK TO RECEIVE CORROSION PROTECTION IN ACCORDANCE WITH DOCUMENT No. SP-1246-2
- CONCRETE TO BS 8110, GRADE 35 FOR REINFORCED CONCRETE, GRADE 10 FOR PCC USING O.P.C
- TREATMENT OF POST FROM 30mm ABOVE TO 100mm IN TO CONCRETE.
 - PAINT STEEL SURFACE WITH ASPHALT.
 - APPLY ONE WRAP OF 10mm Thk. FELT.
 - PAINT WRAPPED FELT WITH ASPHALT.

ورلي بارسونز - الصناعات العربية (محاصة)
WorleyParsons - Arabian Industries (JV)

CONTRACT NO.: C31/0606 PROJ. NO.: PAIP00405

PIPE GUIDE DETAILS	NIM	2	5772	023	DQ	3
DESCRIPTION	AREA	S	SERIAL	SH.	P	S
DRAWING NUMBER						


NOTES

REFERENCE DRAWINGS

REV	DATE	DRAWN BY	CHECKED	DESCRIPTION	WBS No.	PROJ. ENG.	SIGNATURE
A	27.02.11	GCS	RB	APPROVED FOR CONSTRUCTION	IN.09.011	OSE/28N	
O	26.02.11	GCS	KBR	ISSUED FOR COMMENTS	IN.09.011	OSE/28N	

PROJECT DRAWING REVISION
IN CASE OF DEVIATIONS A MARKED UP PRINT SHALL BE SENT TO THE PROJECT ENGINEER

AREA	: NIMR	SCALE	: 1:20
SUB AREA	: PRODUCTION STATION	NO.	05
DRWG. TYPE	: PIPE SUPPORTS		
DESCRIPTION	: PS-006	DRWG	AREA CODE
		ENG SECT	SERIAL NUMBER
		SHEET	PROJ CODE
		DWG SIZE	REV.
		NO	NIM 2 5772 007 DQ 3 A

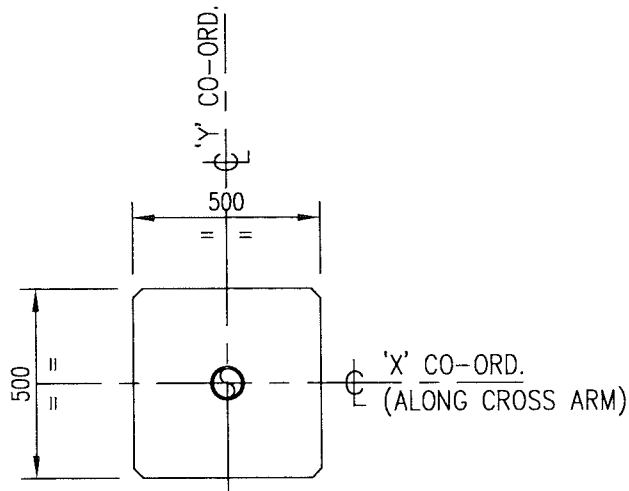



- ## NOTES


NOTE: * DENOTES, SINCE GRADE ELEVATION VARIES, CONTRACTOR TO VERIFY ELEVATIONS AND DIMENSIONS AT SITE, PRIOR TO FABRICATION/CONSTRUCTION/INSTALLATION.

k. Munn
TA2

APPROVED FOR
CONSTRUCTION

	A	27.02.11	GCS	PR	J.E.	APPROVED FOR CONSTRUCTION	IN.09.011	OSE /28N	
	O	26.02.11	GCS	KBR	GSB	ISSUED FOR COMMENTS	IN.09.011	OSE /28N	
وراء	REV	DATE	DRAWN BY	TEAM L.	J. ENG.	DESCRIPTION	WBS No.	PROJ. ENG.	SIGNATURE
				CHECKED				P D O APPROVAL	

PROJECT DRAWING REVISION													
IN CASE OF DEVIATIONS A MARKED UP PRINT SHALL BE SENT TO THE PROJECT ENGINEER													
AREA : NIMR						SCALE : 1:20 0 1 2 3 4 5 6 7 							
SUB AREA : PRODUCTION STATION						No. 05							
DRWG.TYPE : PIPE SUPPORTS						 شركة تنمية نفط عُمان Petro Development Oman							
DESCRIPTION : PS-007 & 009						DRWG	AREA CODE	ENG SECT	SERIAL NUMBER	SHEET	PROJ CODE	DRWG SIZE	REV.
						NO	NIM	2	5772	008	DQ	3	A

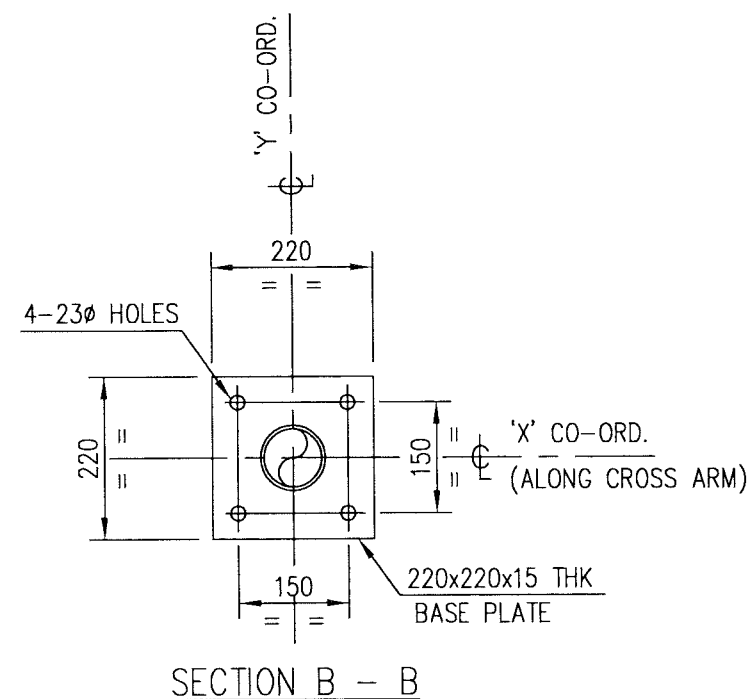

NOTE: * DENOTES, SINCE GRADE ELEVATION VARIES, CONTRACTOR TO VERIFY ELEVATIONS AND DIMENSIONS AT SITE, PRIOR TO FABRICATION/CONSTRUCTION/INSTALLATION.

1c. Murren
TA2

APPROVED FOR
CONSTRUCTION

	A	27.02.11	GCS	PB	WJ	APPROVED FOR CONSTRUCTION	IN.09.011	OSE/28N	
	O	26.02.11	GCS	KBR	GSB	ISSUED FOR COMMENTS	IN.09.011	OSE/28N	
	REV	DATE	DRAWN BY	TEAM L.	J.ENG.	DESCRIPTION	WBS No.	PROJ. ENG.	SIGNATURE
				CHECKED				P D O APPROVAL	



 ورلي بارسونز - الصناعات العربية (محصاة)
WorleyParsons - Arabian Industries (JV)

CONTRACT NO.: C31/0606	PROJ. NO.: PAIP00405
-------------------------------	-----------------------------

NOTES

PIPE GUIDE DETAIL	NIM	2	5772	023	DQ	3
DESCRIPTION	AREA	S	SERIAL	SH.	P	S
DRAWING NUMBER						
REFERENCE DRAWINGS						

PROJECT DRAWING REVISION									
IN CASE OF DEVIATIONS A MARKED UP PRINT SHALL BE SENT TO THE PROJECT ENGINEER									

AREA : NIMR

SUB AREA : PRODUCTION STATION

DRWG. TYPE : PIPE SUPPORTS

DESCRIPTION	: PS-008
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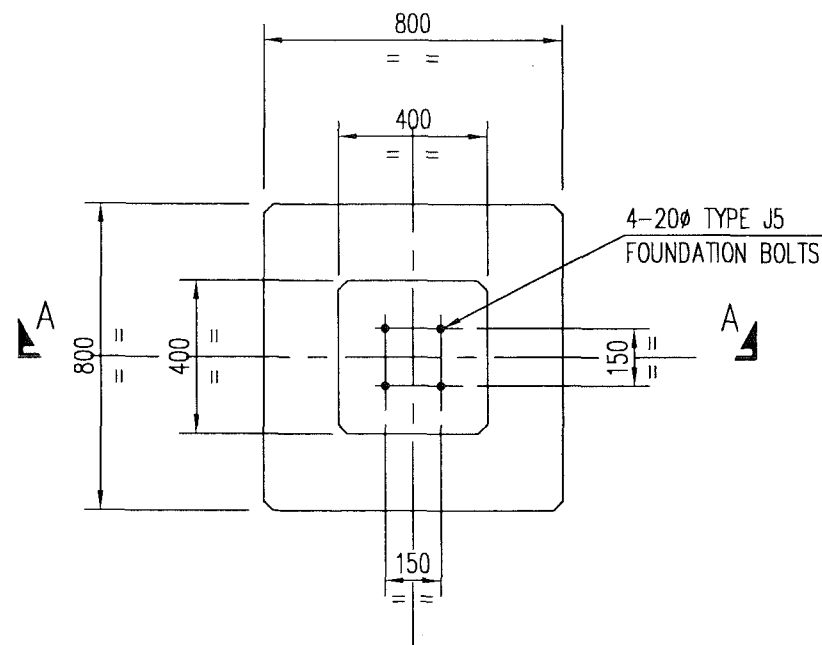
SCALE : 1:20	CAD DRAWING
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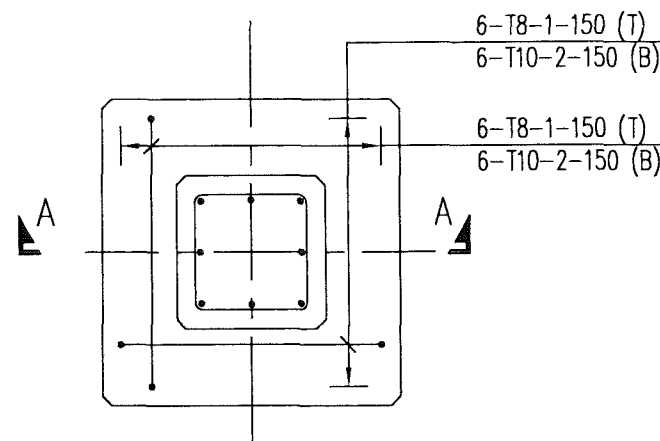
شركة تنمية نفط عُمان

Petroleum Development Oman


DRWG	AREA CODE	ENG SECT	SERIAL NUMBER	SHEET	PROJ CODE	DWG SIZE	REV.
NO	NIM	2	5772	009	DQ	3	A




PLAN
(17 Nos. REQD)




REINFORCEMENT PLAN

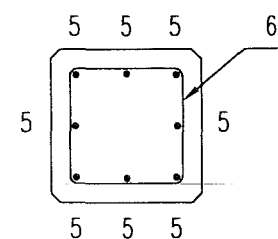


SECTION B - B
(ONLY FOR PS-011)

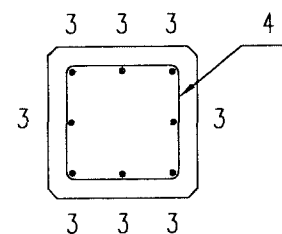

SECTION B - B
(ONLY FOR PS-018)

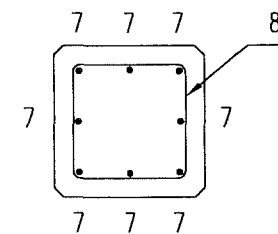

SECTION B - B
(ONLY FOR PS-018)

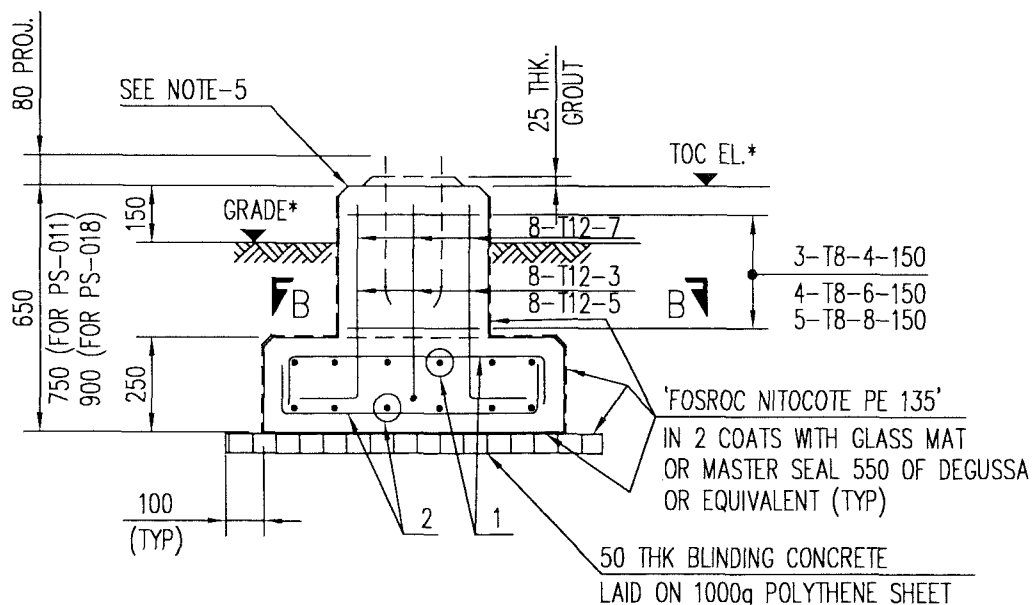

SECTION A - A

FOUNDATION DESIGNATION	REFERENCE DRAWING	NUMBERS REQUIRED	* TOC EL.
PS-008	NIM-2-5604-005-DQ-1	1	98.950
PS-010			
PS-011			
PS-013			
PS-014			
PS-015			
PS-016			
PS-017			
PS-018			
PS-021			
PS-022			
PS-023			
PS-024			
PS-025			
PS-026			
PS-033			97.490
PS-034			97.490

NOTE: * DENOTES, SINCE GRADE ELEVATION VARIES, CONTRACTOR TO VERIFY ELEVATIONS AND DIMENSIONS AT SITE, PRIOR TO FABRICATION/CONSTRUCTION/INSTALLATION.

M T O			
DESCRIPTION	QUANTITY	UNITS	SAP No.
BLINDING CONCRETE GRADE 10	0.85	m ³	N.A.
CONCRETE GRADE 35	3.90	m ³	N.A.
CEMENT SAND GROUT	45.23	lit	N.A.
REINFORCEMENT STEEL	312.43	Kg	N.A.
PROTECTIVE COATING	50.40	m ²	N.A.
20# FOUNDATION BOLT TYPE - J5	68	PCS	N.A.
1000g POLYTHENE SHEET	17.00	m ²	N.A.

(c. mmm)
7A2

APPROVED FOR
CONSTRUCTION

[THIS DRAWING IS BASED ON P.D.O. DRG. No. STD-2-3901-001-A3-D - TYPE 901]

- ALL DIMENSIONS ARE IN MILLIMETRES AND ELEVATIONS IN METRES.
- CONCRETE TO BS 8110, GRADE 35 FOR REINFORCED CONCRETE, GRADE 10 FOR BLINDING CONCRETE USING OPC.
- 50mm COVER TO REINFORCEMENT, REINFORCEMENT TO BS 4449.
- ALL EDGES SHALL HAVE A CHAMFER OF APPROX. 25mm.
- ALL EXPOSED CONCRETE SURFACES SHALL BE TREATED WITH TWO COATS OF "FOSROC DEKGUARD S" WITH A DFT OF 350 MICRONS OR ANY OTHER APPROVED EQUIVALENT.
- FOUNDATION BOLTS REFER DRG. No. STD-2-3950-001-A3
- FOR BAR BENDING SCHEDULE REFER DRG. No. NIM-2-5772-011-DQ-4

NOTES/REFERENCE DRAWINGS

WorleyParsons - Arabian Industries (JV)
 ورلي بارسونز - الصناعات العربية (محصاة)
 CONTRACT NO.: C31/0606 PROJ. NO.: PAIP00405

REV	DATE	DRAWN BY	TEAML.	J.ENG.	CHECKED	DESCRIPTION	WBS No.	PROJ. ENG.	SIGNATURE
A	27.02.11	GCS	KBR	GSB		APPROVED FOR CONSTRUCTION	IN.09.011	OSE/28N	
O	26.02.11	GCS	KBR	GSB		ISSUED FOR COMMENTS	IN.09.011	OSE/28N	

PROJECT DRAWING REVISION
IN CASE OF DEVIATIONS A MARKED UP PRINT SHALL BE SENT TO THE PROJECT ENGINEER

AREA	NIMR		SCALE : 1:20	CAD DRAWING			
SUB AREA	PRODUCTION STATION		NO. 05	شركة تنمية نفط عمان Petroleum Development Oman			
DRWG. TYPE	PIPE SUPPORTS-FOUNDATION DETAILS		NO	AREA CODE	ENG SECT	SERIAL NUMBER	SHEET
DESCRIPTION	PS-008,010,011,013 TO 018, 021 TO 026, 033 & 034		NO	NIM	2	5772	010 DQ
							3 A



BAR BENDING SCHEDULE

JOB NO.: PAIP00238
PART ID.: PRODUCTION STATION

Document No.: NIM-2-5772-011-DQ-4

Revision No.: A

Prepared by: GCS

Checked by: PNG

Date: 27.02.11

REF. DWG NO.: NIM-2-5772-010-DQ-3

Total MTO for Rebars.

Dia. Of Bar	T6	T8	T10	T12	T16	T20	T25	T32
Length of Bar (m)		262.95	188.70	101.40				
Weight (Kgs)		105.18	117.00	90.25				

9	57	1
Total Weight (Kgs)		

312 430

K. Miller
TA2

[illegible]


This schedule complies with BS 8666 : 2005

All dimensions are in mm


Refer to Bar shape Code drawing

* Specified in multiples of 5 mm


† Specified in multiples of 25 mm

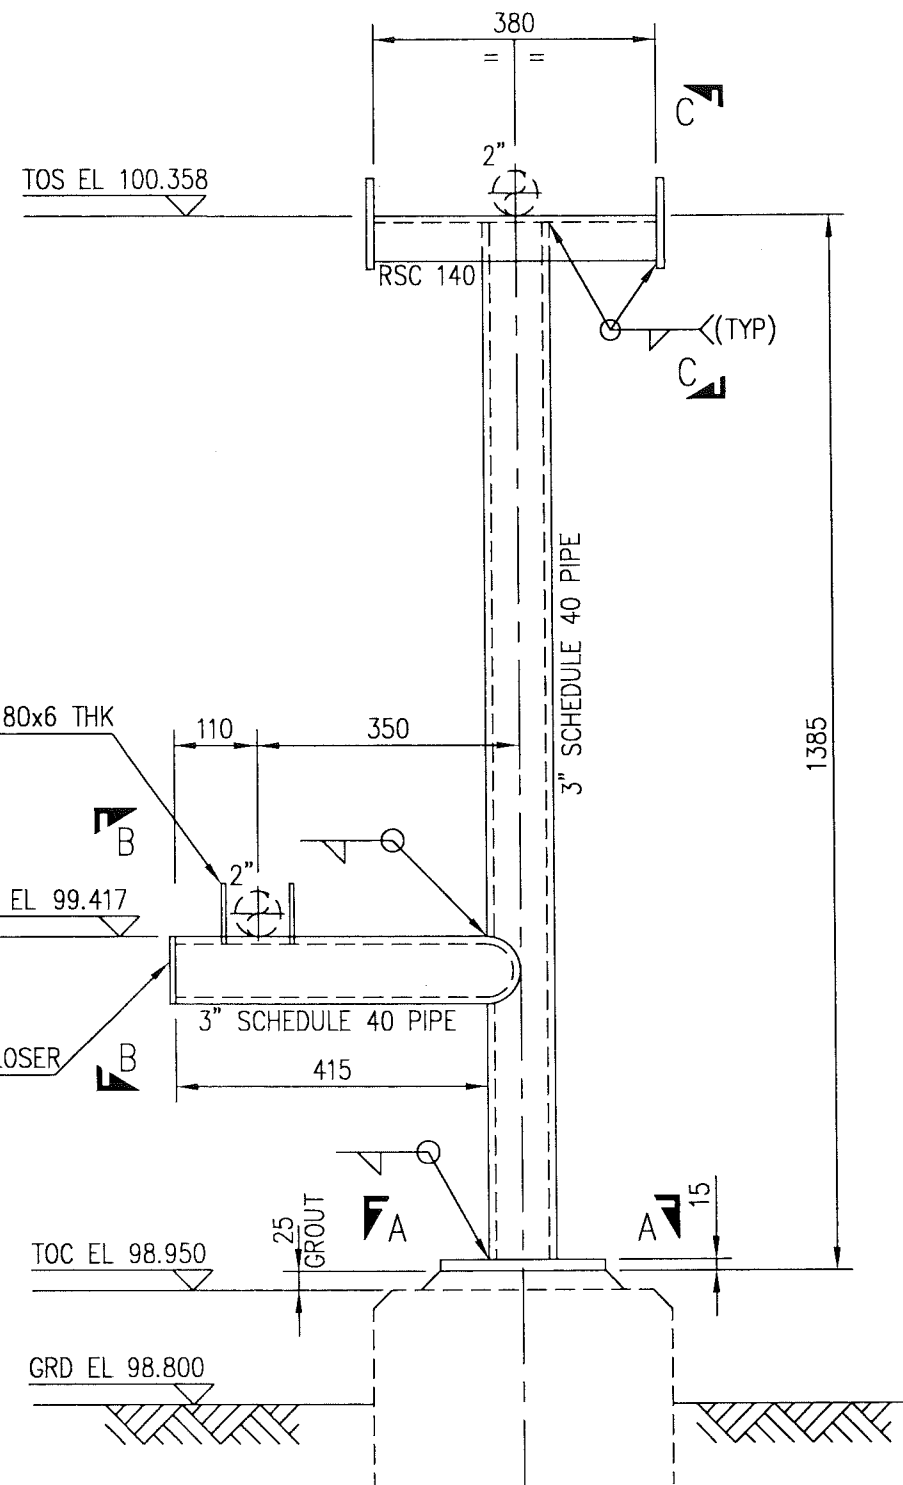


ELEVATION

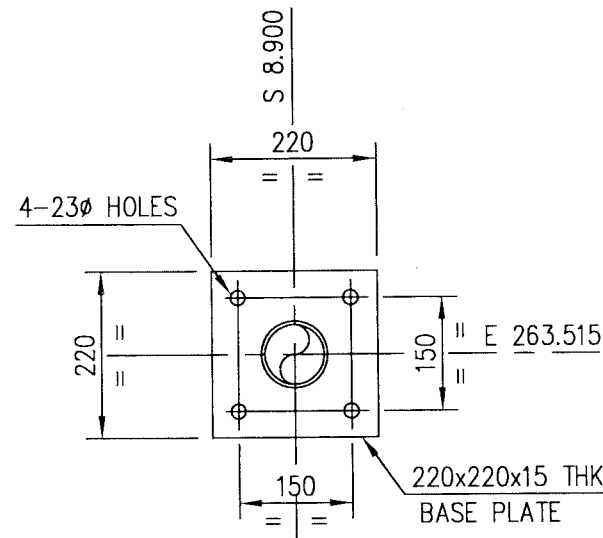

SECTION A - A

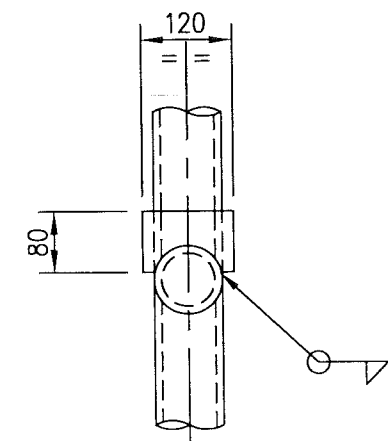

ELEVATION B - B

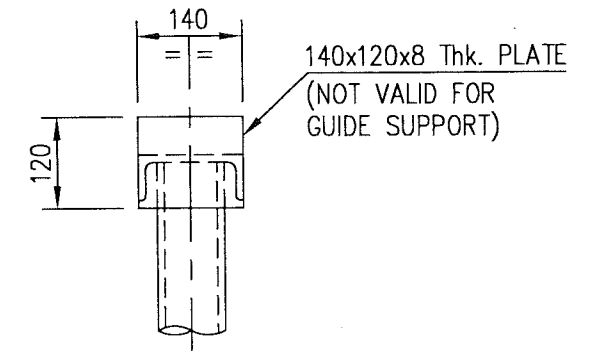

ELEVATION C - C

NOTE: * DENOTES, SINCE GRADE ELEVATION VARIES, CONTRACTOR TO VERIFY ELEVATIONS AND DIMENSIONS AT SITE, PRIOR TO FABRICATION/CONSTRUCTION/INSTALLATION.

M T O

DESCRIPTION	QUANTITY	UNITS	SAP No.
3" SCHEDULE 40 PIPE	1.85	m	1000051540
RSC 140	0.40	m	1000080366
15 THK PLATE	0.05	m ²	1000080265
8 THK PLATE	0.05	m ²	1000062607
FLAT 80x6	0.24	m	1000062576
3 THK CLOSER PLATE	0.06	m ²	1000062605

APPROVED FOR CONSTRUCTION

REV	DATE	DRAWN BY	CHECKED	DESCRIPTION	WBS No.	PROJ. ENG.	SIGNATURE
A	27.02.11	GCS	RB	APPROVED FOR CONSTRUCTION	IN.09.011	OSE/28N	
O	26.02.11	GCS	KBR	ISSUED FOR COMMENTS	IN.09.011	OSE/28N	

WorleyParsons - Arabian Industries (JV)

CONTRACT NO. : C31/0606 PROJ. NO. : PAIP00405

- ALL DIMENSIONS ARE IN MILLIMETRES.
- ALL ELEVATIONS & CO-ORDINATES ARE IN METRES.
- ALL STEEL WORK TO BS EN 10025 GRADE S275 JR
- PIPE SECTION TO API 5L GR B.
- ALL CONNECTIONS TO BE MADE USING 5mm CFW.
- ALL STEEL WORK TO RECEIVE CORROSION PROTECTION IN ACCORDANCE WITH DOCUMENT No. SP-1246-2

NOTES

DESCRIPTION	AREA	S	SERIAL	SH.	P	S
FOUNDATION DETAILS	NIM	2	5772	010	DQ	3

REFERENCE DRAWINGS

PROJECT DRAWING REVISION
IN CASE OF DEVIATIONS A MARKED UP PRINT SHALL BE SENT TO THE PROJECT ENGINEER

AREA : NIMR

SUB AREA : PRODUCTION STATION


DRWG. TYPE : PIPE SUPPORTS

DESCRIPTION : PS-010

SCALE : 1:20 CAD DRAWING

شركة تنمية نفط عُمان
Petroleum Development Oman

DRWG	AREA	ENG	SERIAL	SHEET	PROJ	DWG	REV.
NO	CODE	SECT	NUMBER	CODE	SIZE		
NIM	2	5772	012	DQ	3	A	

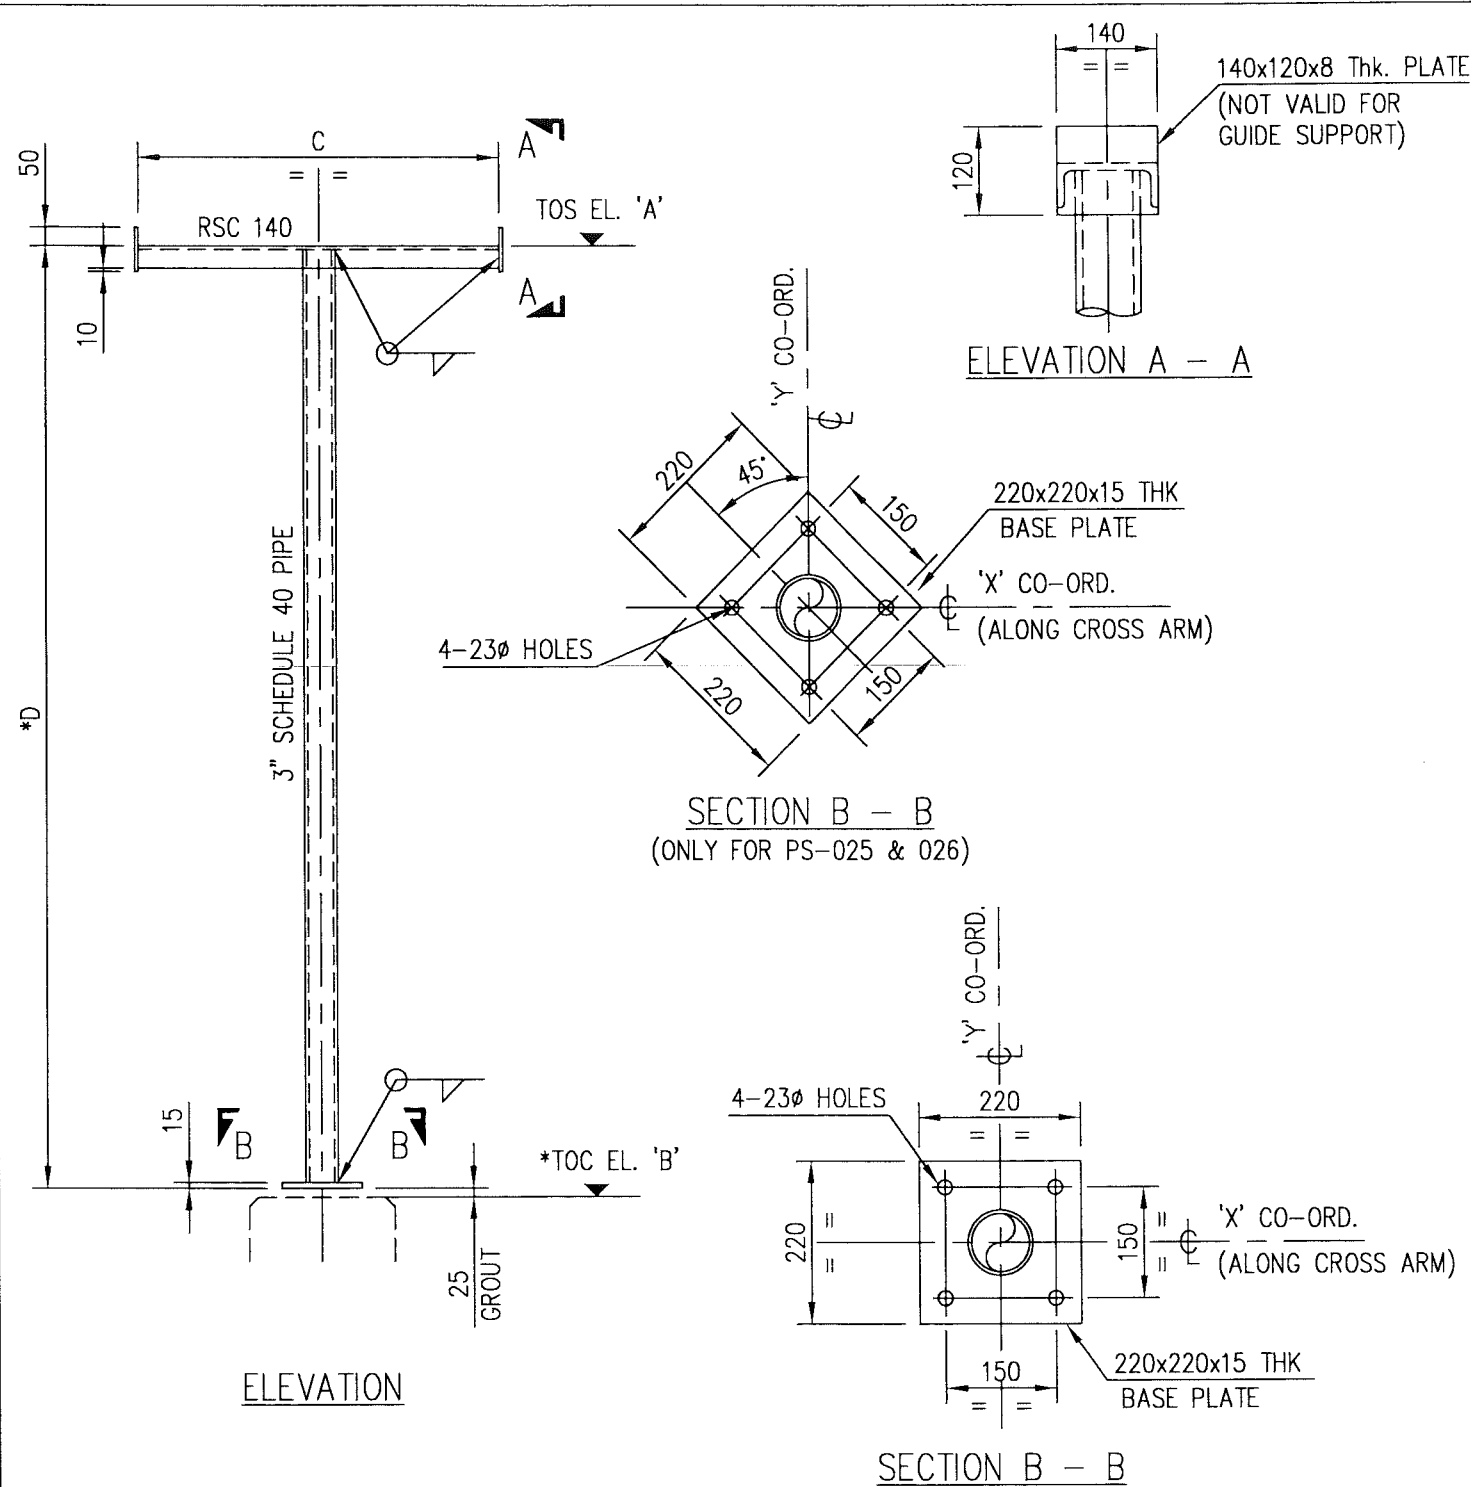

SUPPORT NUMBER	REFERENCE DRAWING	ELEVATIONS		DIMENSIONS		PIPE GUIDE	Nos. REQD.	CO-ORDINATES	
		A	* B	C	* D			X	Y
PS-011	NIM-2-5604-005-DQ-1	99.654	98.950	380	679	-	1	S 9.144	E 265.000
PS-014						-		E 264.000	S 3.200
PS-015						PG-6		E 258.500	S 3.200
PS-016						-		E 253.000	S 3.200
PS-017						-		E 247.750	S 3.200
PS-018						-		S 5.560	E 265.000
PS-021						PG-6		E 272.121	S 10.000
PS-022						PG-6		E 278.621	S 10.000
PS-023						PG-6		E 285.121	S 10.000
PS-024						-		E 292.121	S 10.000
PS-025						-		S 10.512	E 296.838
PS-026		99.359			384	-		S 13.182	E 300.232

NOTE: * DENOTES, SINCE GRADE ELEVATION VARIES, CONTRACTOR TO VERIFY ELEVATIONS AND DIMENSIONS AT SITE, PRIOR TO FABRICATION/CONSTRUCTION/INSTALLATION.

M T O			
DESCRIPTION	QUANTITY	UNITS	SAP No.
3" SCHEDULE 40 PIPE	7.70	m	1000051540
RSC 140	4.60	m	1000080366
15 THK PLATE	0.60	m ²	1000080265
8 THK PLATE	0.27	m ²	1000062607

APPROVED FOR CONSTRUCTION

REV	DATE	DRAWN BY	TEAM	J.ENG.	DESCRIPTION	WBS No.	PROJ. ENG.	SIGNATURE
A	27.02.11	GCS	RB	✓	APPROVED FOR CONSTRUCTION	IN.09.011	OSE/28N	
O	26.02.11	GCS	KBR	GSB	ISSUED FOR COMMENTS	IN.09.011	OSE/28N	


[THIS DRAWING IS BASED ON P.D.O. DRG. No. STD-2-3102-001-A3-C - TYPE 102]




CONTRACT NO.: C31/0606 PROJ. NO.: PAIP00405

1. ALL DIMENSIONS ARE IN MILLIMETRES.	PIPE GUIDE DETAILS	NIM	2	5772	023	DQ	3
2. ALL ELEVATIONS & CO-ORDINATES ARE IN METRES.	FOUNDATION DETAILS	NIM	2	5772	010	DQ	3
3. ALL STEEL WORK TO BS EN 10025 GRADE S275 JR							
4. PIPE SECTION TO API 5L GR B.							
5. ALL CONNECTIONS TO BE MADE USING 5mm CFW.							
6. ALL STEEL WORK TO RECEIVE CORROSION PROTECTION IN ACCORDANCE WITH DOCUMENT No. SP-1246-2							
NOTES	REFERENCE DRAWINGS						


PROJECT DRAWING REVISION				IN CASE OF DEVIATIONS A MARKED UP PRINT SHALL BE SENT TO THE PROJECT ENGINEER			
AREA	: NIMR			SUB AREA	: PRODUCTION STATION		
DRWG. TYPE	: PIPE SUPPORTS			DESCRIPTION	: PS-011,014,015,016,017,018,021,022,023,024,025 & 026		
SCALE	: 1:20			CAD DRAWING	: NO. 05		
DRWG	AREA CODE	ENG SECT	SERIAL NUMBER	SHEET	PROJ CODE	DWG SIZE	REV.
NO	NIM	2	5772	013	DQ	3	A

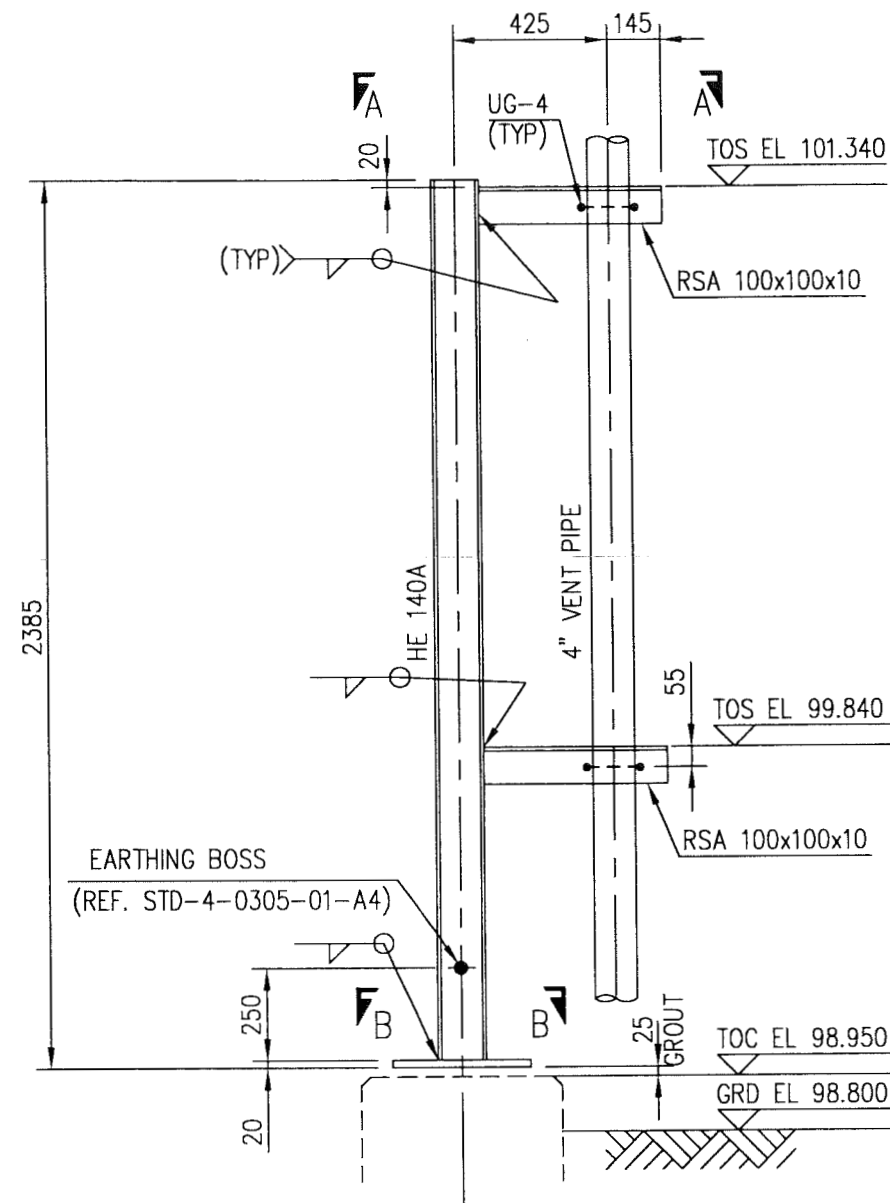

ELEVATION

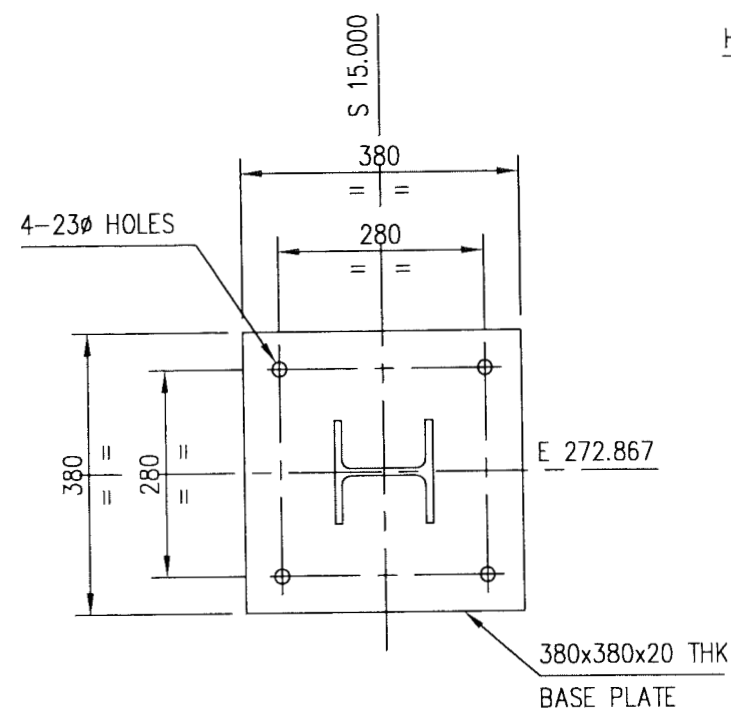

SECTION B - B

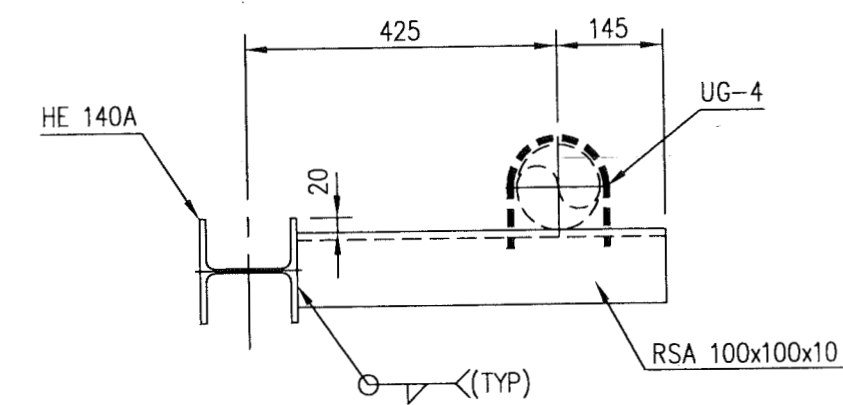

VIEW A - A
(SCALE 1:10)

M T O			
DESCRIPTION	QUANTITY	UNITS	SAP No.
HE 140A	2.40	m	1000080438
RSA 100x100x10	1.01	m	1000080322
20 THK PLATE	0.15	m ²	1000062610
EARTHING BOSS	1	PCS	N.A.

ic. number
7A2

APPROVED FOR
CONSTRUCTION

REV	DATE	DRAWN BY	TEAM L.	J. ENG.	CHECKED	DESCRIPTION	WBS No.	PROJ. ENG.	SIGNATURE
A	27.02.11	GCS	RB	✓		APPROVED FOR CONSTRUCTION	IN.09.011	OSE/28N	
O	26.02.11	GCS	KBR	GSB		ISSUED FOR COMMENTS	IN.09.011	OSE/28N	

ورلي بارسونز - الصناعات العربية (محاصة)
WorleyParsons - Arabian Industries (JV)
 CONTRACT NO.: C31/0606 PROJ. NO.: PAIP00405

1. ALL DIMENSIONS ARE IN MILLIMETRES.
2. ALL ELEVATIONS & CO-ORDINATES ARE IN METRES.
3. ALL STEEL WORK TO BS EN 10025 GRADE S275 JR.
4. ALL CONNECTIONS TO BE MADE USING 6mm CFW.
5. ALL STEEL WORK TO RECEIVE CORROSION PROTECTION IN ACCORDANCE WITH DOCUMENT No. SP-1246-2

NOTES


'U' BOLT PIPE GRIPPED	NIM	2	5772	022	DQ	3
FOUNDATION DETAILS	NIM	2	5772	017	DQ	3
FOUNDATION LOCATION PLAN	NIM	2	5604	005	DQ	1
DESCRIPTION	AREA	S	SERIAL	SH.	P	S
DRAWING NUMBER						
REFERENCE DRAWINGS						

PROJECT DRAWING REVISION
IN CASE OF DEVIATIONS A MARKED UP PRINT SHALL BE SENT TO THE PROJECT ENGINEER


AREA	: NIMR
SUB AREA	: PRODUCTION STATION
DRWG. TYPE	: PIPE SUPPORTS
DESCRIPTION	: PS-027 & PS-028

SCALE : 1:20
 0 1 2 3 4 5 6 7
شركة تنمية نفط عُمان
Petroleum Development Oman


DRWG	AREA CODE	ENG SECT	SERIAL NUMBER	SHEET	PROJ CODE	DWG SIZE	REV.
NO	NIM	2	5772	016	DQ	3	A

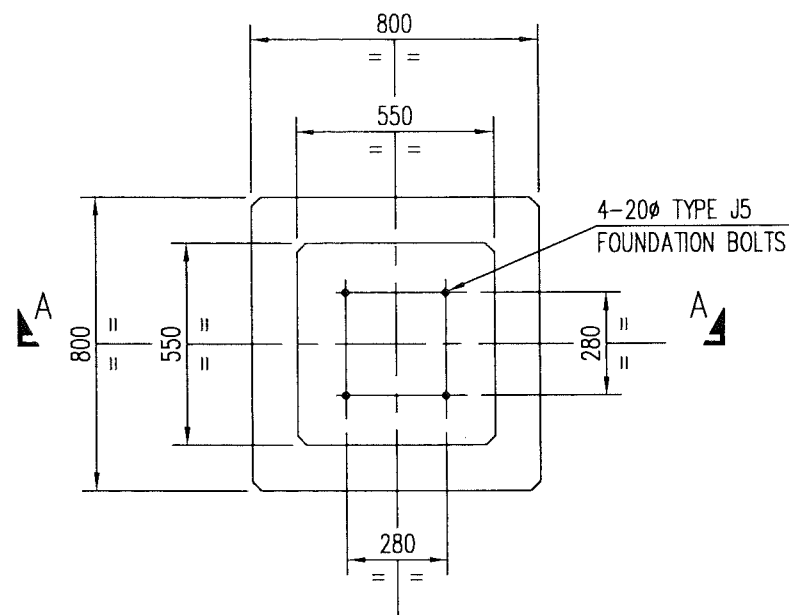


PLAN
(1 No. REQD)

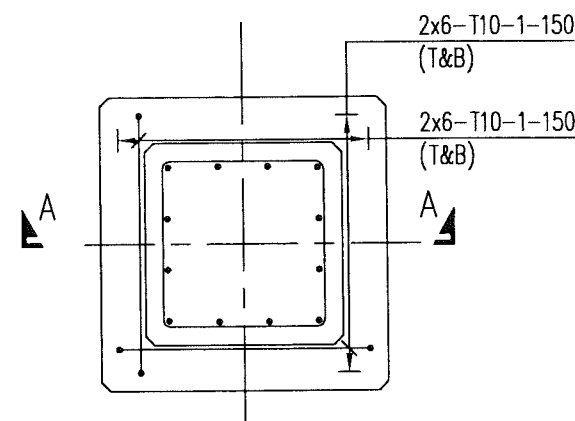

REINFORCEMENT PLAN

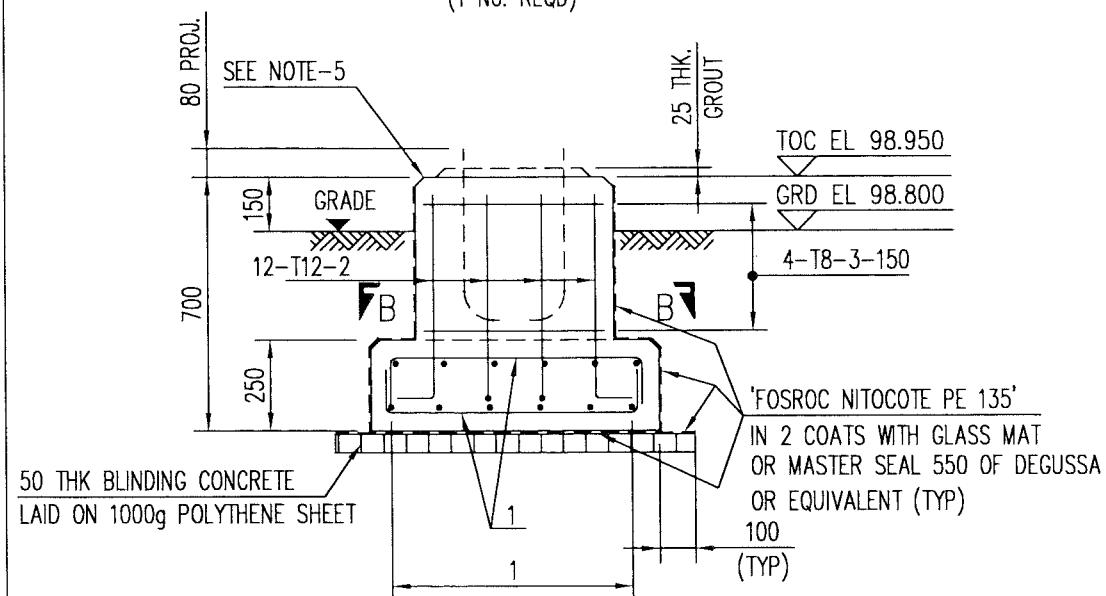

SECTION A - A

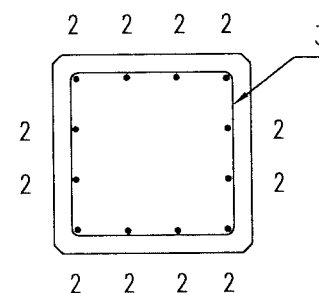

SECTION B - B

M T O			
DESCRIPTION	QUANTITY	UNITS	SAP No.
BLINDING CONCRETE GRADE 10	0.05	m ³	N.A.
CONCRETE GRADE 35	0.03	m ³	N.A.
CEMENT SAND GROUT	5.26	lit	N.A.
REINFORCEMENT STEEL	24.41	Kg	N.A.
PROTECTIVE COATING	3.15	m ²	N.A.
20mm FOUNDATION BOLT TYPE - J5	4	PCS	N.A.
1000g POLYTHENE SHEET	1.00	m ²	N.A.

NOTE: * DENOTES, SINCE GRADE ELEVATION VARIES, CONTRACTOR TO VERIFY ELEVATIONS AND DIMENSIONS AT SITE, PRIOR TO FABRICATION/CONSTRUCTION/INSTALLATION.

APPROVED FOR
CONSTRUCTION

		ورلي بارسونز - الصناعات العربية (محصاة) WorleyParsons - Arabian Industries (JV)	
CONTRACT NO. : C31/0606		PROJ. NO. : PAIP00405	

- ALL DIMENSIONS ARE IN MILLIMETRES AND ELEVATIONS IN METRES.
- CONCRETE TO BS 8110, GRADE 35 FOR REINFORCED CONCRETE, GRADE 10 FOR BLINDING CONCRETE USING OPC.
- 50mm COVER TO REINFORCEMENT, REINFORCEMENT TO BS 4449.
- ALL EDGES SHALL HAVE A CHAMFER OF APPROX. 25mm.
- ALL EXPOSED CONCRETE SURFACES SHALL BE TREATED WITH TWO COATS OF "FOSROC DEKGUARD S" WITH A DFT OF 350 MICRONS OR ANY OTHER APPROVED EQUIVALENT.
- FOUNDATION BOLTS REFER DRG. No. STD-2-3950-001-A3
- FOR BAR BENDING SCHEDULE REFER DRG. No. NIM-2-5772-018-DQ-4
- FOR FOUNDATIONLOCATION PLAN REFER DRG. No. NIM-2-5604-005-DQ-1

NOTES/REFERENCE DRAWINGS

REV	DATE	DRAWN BY	TEAML	J.ENG.	CHECKED	DESCRIPTION	WBS No.	PROJ. ENG.	SIGNATURE
A	27.02.11	GCS	RB	Y		APPROVED FOR CONSTRUCTION	IN.09.011	OSE/28N	
O	26.02.11	GCS	KBR	GSB		ISSUED FOR COMMENTS	IN.09.011	OSE/28N	

PROJECT DRAWING REVISION
IN CASE OF DEVIATIONS A MARKED UP PRINT SHALL BE SENT TO THE PROJECT ENGINEER

AREA	NIMR		SCALE : 1:20	CAD DRAWING	
SUB AREA	PRODUCTION STATION		No. 05	شركة تنمية نفط عمان Petroleum Development Oman	
DRWG. TYPE	PIPE SUPPORTS		DRWG	AREA CODE	ENG SECT
DESCRIPTION	PS-027 & PS-028		SERIAL NUMBER	SHEET	PROJ CODE
			NO	NIM 2 5772 017 DQ 3	REV.



BAR BENDING SCHEDULE

JOB NO.: PAIP00238
PART ID.: PRODUCTION STATION
 PS-027 & 028

Document No.: NIM-2-5772-018-DQ-4
Revision No.: A
Prepared by: GCS
Checked by: PNG *RL*
Date: 27.02.11

REF. DWG NO.: NIM-2-5772-017-DQ-3

Total MTO for Rebars.

Dia. Of Bar	T6	T8	T10	T12	T16	T20	T25	T32
Length of Bar (m)		7.90	22.20	8.40				
Weight (Kgs)		3.16	13.77	7.48				


1	2	3	100
Total Weight (Kgs)																																																																																																			

24 410

[illegible]

1c. Munnies
TA2

This schedule complies with BS 8666 : 2005
All dimensions are in mm
Refer to Bar shape Code drawing
* Specified in multiples of 5 mm
† Specified in multiples of 25 mm

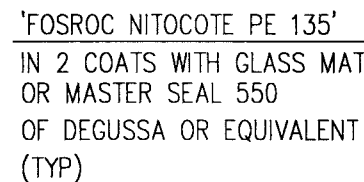

NOTE: * DENOTES, SINCE GRADE ELEVATION VARIES, CONTRACTOR TO VERIFY ELEVATIONS AND DIMENSIONS AT SITE, PRIOR TO FABRICATION/CONSTRUCTION/INSTALLATION.

1c. Minutes
TA2


APPROVED FOR
CONSTRUCTION

- 

 ورلي بارسونز - الصناعات العربية (محصاة)
WorleyParsons - Arabian Industries (JV)

	A	27.02.11	GCS	BB	VH	APPROVED FOR CONSTRUCTION	IN.09.011	OSE/28N	
	O	26.02.11	GCS	KBR	GSB	ISSUED FOR COMMENTS	IN.09.011	OSE/28N	
ورل	REV	DATE	DRAWN BY	TEAM L.	J. ENG.	DESCRIPTION	WBS No.	PROJ. ENG.	SIGNATURE
				CHECKED				P D O APPROVAL	

PROJECT DRAWING REVISION									
IN CASE OF DEVIATIONS A MARKED UP PRINT SHALL BE SENT TO THE PROJECT ENGINEER									
AREA : NIMR						SCALE : 1:20 0 1 2 3 4 5 6 7			
SUB AREA : PRODUCTION STATION						No. 05			
DRWG.TYPE : PIPE SUPPORTS						C.A.D. DRAWING			
DESCRIPTION : PS-029 & 030						شركة تنمية نفط عُمان Petroleum Development Oman			
DRWG		AREA CODE	ENG SECT	SERIAL NUMBER		SHEET	PROJ CODE	DWG SIZE	REV.
NO		NIM	2	5772		019	DQ	3	A

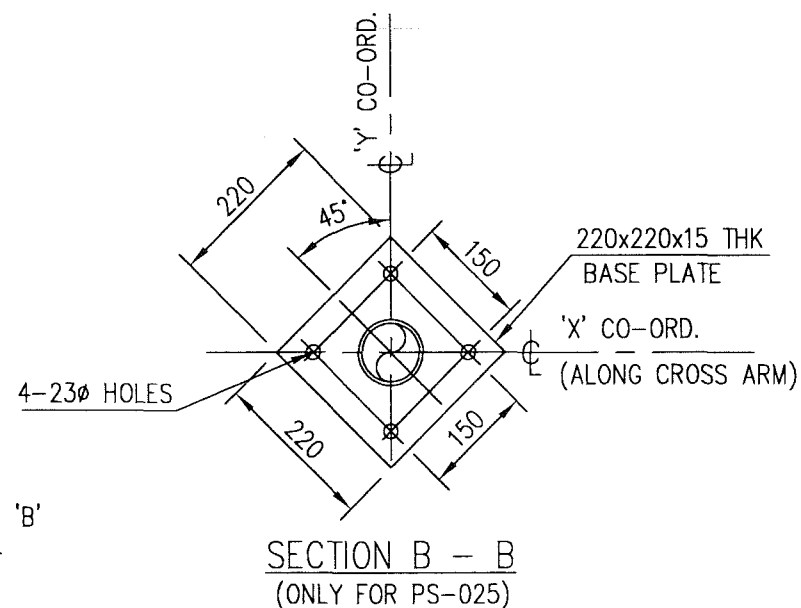

NOTE: * DENOTES, SINCE GRADE ELEVATION VARIES, CONTRACTOR TO VERIFY ELEVATIONS AND DIMENSIONS AT SITE, PRIOR TO FABRICATION/CONSTRUCTION/INSTALLATION.

1c. Munnies
TA2

APPROVED FOR
CONSTRUCTION


A	27.02.11	GCS	<i>BR</i>	<i>YH</i>	APPROVED FOR CONSTRUCTION	IN.09.011	OSE/28N	
O	26.02.11	GCS	KBR	GSB	ISSUED FOR COMMENTS	IN.09.011	OSE/28N	
REV	DATE	DRAWN BY	TEAM L.	J.ENG.	DESCRIPTION	WBS No.	PROJ. ENG.	SIGNATURE
			CHECKED				P D O APPROVAL	




 وورلي بارسونز - الصناعات العربية (مخاصة)
 WorleyParsons - Arabian Industries (JV)

CONTRACT NO. : C31/0606	PROJ. NO. : PAIP00405
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PROJECT DRAWING REVISION	
IN CASE OF DEVIATIONS A MARKED UP PRINT SHALL BE SENT TO THE PROJECT ENGINEER	

3	AREA : NIMR			SCALE : 1:20		CAD DRAWING							
	SUB AREA : PRODUCTION STATION			NO. 05			شركة تنمية نفط عُمان Petroleum Development Oman						
S	DRWG. TYPE : PIPE SUPPORTS					DRWG	AREA CODE	ENG SECT	SERIAL NUMBER	SHEET	PROJ CODE	DWG SIZE	REV.
	DESCRIPTION : PS-033 & PS-034					NO	NIM 2 5772 020 DQ					3	A

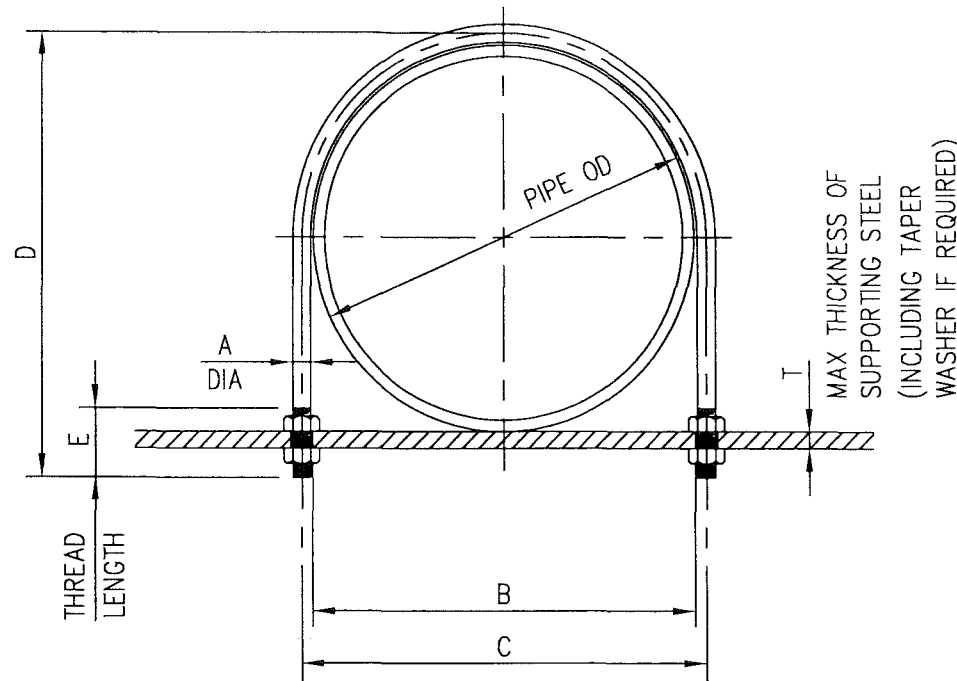

ELEVATION

MATERIAL GUIDE

BAR		NUTS	
SIZE	SAP No.	SIZE	SAP No.
8	1000080335	M8	1000063795
10	1000062586	M10	1000063796
16	1000062588	M16	1000063798
20	N.A.	M20	1000063799
24	N.A.	M24	1000120055

[THIS DRAWING IS BASED ON P.D.O. DRG. No. STD-2-3818-001-A3-C - TYPE 818]

- ALL DIMENSIONS ARE IN MILLIMETRES.
- EACH BOLT TO BE SUPPLIED WITH 4 NUTS.
- MATERIAL-BOLTS TO BS EN 10025 GR S275 JR
NUTS TO ISO 898/11 GR 8
- U-BOLT CORROSION PROTECTION SHALL COMPLY WITH SP-1246-2

NOTES



CONTRACT NO.: C31/0606 PROJ. NO.: PAIP00405

DESCRIPTION

DRAWING NUMBER

REFERENCE DRAWINGS


PIPE GUIDE DESIGNATION	NOMINAL PIPE SIZE		PIPE OD	DIMENSIONS						Nos. REQD.
	INCHES	MM		A	B	C	D	E	T	
UB-0.5	1/2"	15	21.3	8	32	40	45	30	10	-
UB-0.75	3/4"	20	26.7	8	37	45	55	35	10	-
UB-1	1"	25	33.4	8	42	50	60	35	10	-
UB-1.5	1 1/2"	40	48.3	10	55	65	85	45	16	-
UB-2	2"	50	60.3	10	70	80	100	45	16	1
UB-3	3"	80	88.9	16	94	110	140	60	19	-
UB-4	4"	100	114.3	16	124	140	165	60	19	1
UB-6	6"	150	168.3	20	175	195	225	70	19	-
UB-8	8"	200	219.1	20	230	250	275	70	19	-
UB-10	10"	250	273.0	20	285	305	335	75	22	-
UB-12	12"	300	323.9	20	335	355	385	75	22	-
UB-14	14"	350	355.6	24	366	390	425	80	22	-
UB-16	16"	400	406.4	24	416	440	475	80	22	-
UB-18	18"	450	457.0	24	471	495	525	80	22	-
UB-20	20"	500	508.0	24	521	545	575	80	22	-
UB-24	24"	600	610.0	24	621	645	675	80	22	-
UB-28	28"	700	711.2	24	721	745	775	80	22	-
UB-30	30"	750	762.0	24	771	795	825	80	22	-


ic. Amner
TA2

APPROVED FOR
CONSTRUCTION

REV	DATE	DRAWN BY	TEAM L.	J. ENG.	CHECKED	DESCRIPTION	WBS No.	PROJ. ENG.	SIGNATURE
A	27.02.11	GCS	DR	VB		APPROVED FOR CONSTRUCTION	IN.09.011	OSE/28N	
O	26.02.11	GCS	KBR	GSB		ISSUED FOR COMMENTS	IN.09.011	OSE/28N	

PROJECT DRAWING REVISION
IN CASE OF DEVIATIONS A MARKED UP PRINT SHALL BE SENT TO THE PROJECT ENGINEER

AREA : NIMR				SCALE : — 0 1 2 3 4 5 6 7								CAD DRAWING															
SUB AREA : PRODUCTION STATION				NO. 05		 شركة تنمية نفط عُمان Petroleum Development Oman																					
DRWG. TYPE : PIPE SUPPORTS				DRWG										AREA CODE		ENG SECT		SERIAL NUMBER		SHEET		PROJ CODE		DWG SIZE		REV.	
DESCRIPTION : 'U' BOLT (PIPE NOT GRIPPED) DETAILS				NO										NIM		2		5772		021		DQ		3		A	

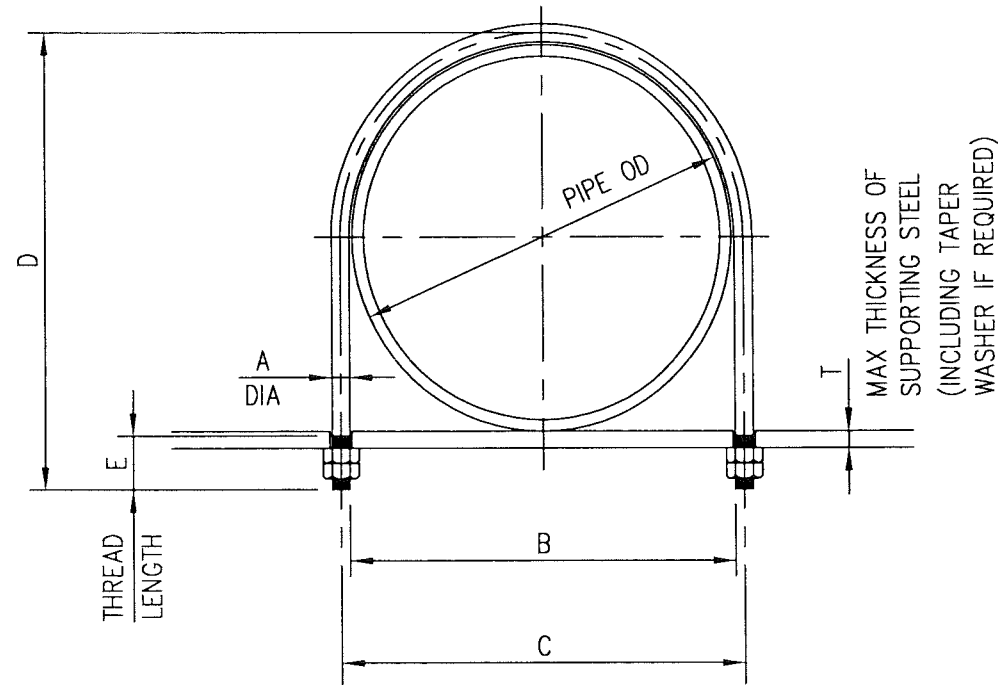

ELEVATION

PIPE GUIDE DESIGNATION	NOMINAL PIPE SIZE		PIPE OD	DIMENSIONS						Nos. REQD.
	INCHES	MM		A	B	C	D	E	T	
UG-0.5	1/2"	15	21.3	8	22	30	50	25	10	-
UG-0.75	3/4"	20	26.7	8	27	35	60	25	10	-
UG-1	1"	25	33.4	8	37	45	65	25	10	-
UG-1.5	1 1/2"	40	48.3	10	50	60	90	35	16	-
UG-2	2"	50	60.3	10	65	75	100	35	16	1
UG-3	3"	80	88.9	16	89	105	150	50	19	-
UG-4	4"	100	114.3	16	119	135	175	50	19	2
UG-6	6"	150	168.3	20	170	190	235	55	19	-
UG-8	8"	200	219.1	20	225	245	295	60	19	-
UG-10	10"	250	273.0	20	280	300	350	60	22	-
UG-12	12"	300	323.9	20	330	350	400	60	22	-
UG-14	14"	350	355.6	24	361	385	440	65	22	-
UG-16	16"	400	406.4	24	411	435	490	65	22	-
UG-18	18"	450	457.0	24	461	485	540	70	22	-
UG-20	20"	500	508.0	24	516	540	590	70	22	-
UG-24	24"	600	610.0	24	616	640	700	70	22	-
UG-28	28"	700	711.2	24	711	735	800	70	22	-
UG-30	30"	750	762.0	24	766	790	850	70	22	-

MATERIAL GUIDE					
BAR		NUTS		LOCKNUTS	
SIZE	SAP NO No.	SIZE	SAP NO:	SIZE	SAP No.
8	1000080335	M8	1000063795	M8	1000080222
10	1000062586	M10	1000063796	M10	1000063819
16	1000062588	M16	1000063798	M16	1000063820
20	N.A.	M20	1000063799	M20	1000063821
24	N.A.	M24	1000120055	M24	1000120066

10. Amner
A2

APPROVED FOR
CONSTRUCTION

[THIS DRAWING IS BASED ON P.D.O. DRG. No.
STD-2-3817-001-A3-D - TYPE 817]


ورلي بارسونز - الصناعات العربية (محاصة)
WorleyParsons - Arabian Industries (JV)
 CONTRACT NO.: **C31/0606** PROJ. NO.: **PAIP00405**


REV	DATE	DRAWN BY	CHECKED	DESCRIPTION	WBS No.	PROJ. ENG.	SIGNATURE
A	27.02.11	GCS	PR	APPROVED FOR CONSTRUCTION	IN.09.011	OSE/28N	
O	26.02.11	GCS	KBR	ISSUED FOR COMMENTS	IN.09.011	OSE/28N	



PROJECT DRAWING REVISION
IN CASE OF DEVIATIONS A MARKED UP PRINT SHALL BE SENT TO THE PROJECT ENGINEER

- ALL DIMENSIONS ARE IN MILLIMETRES.
- EACH BOLT TO BE SUPPLIED WITH 2 NUTS & 2 LOCKNUTS.
- MATERIAL-BOLTS TO BS EN 10025 GR S275 JR NUTS TO ISO 898/11 GR 8
- U-BOLT CORROSION PROTECTION SHALL COMPLY WITH SP-1246-2

NOTES

REFERENCE DRAWINGS

AREA	: NIMR	SCALE	: 0 1 2 3 4 5 6 7
SUB AREA	: PRODUCTION STATION	NO.	05
DRWG. TYPE	: PIPE SUPPORTS	 شركة تنمية نفط عُمان Petrochem Development Oman	
DESCRIPTION	: 'U' BOLT (PIPE NOT GRIPPED) DETAILS		
DRWG	AREA CODE	ENG SECT	SERIAL NUMBER
NO	NIM	2	5772 022 DQ
			3 A

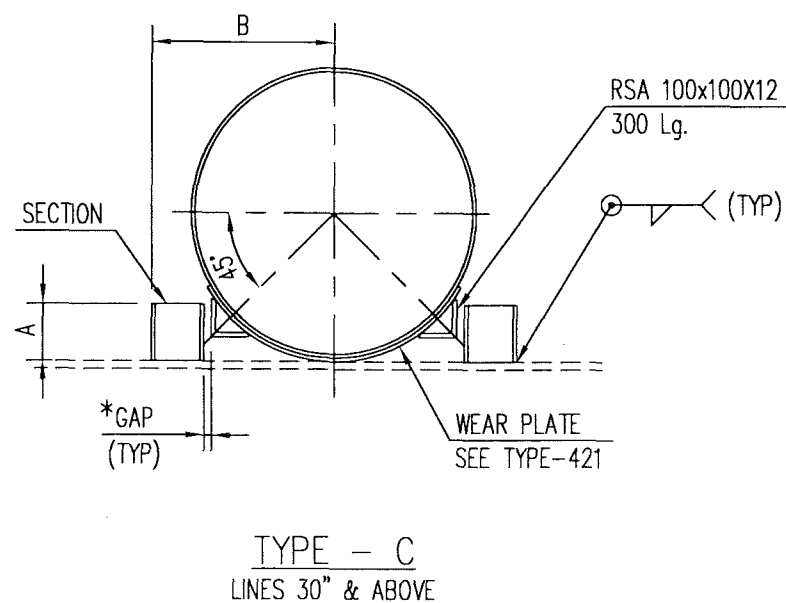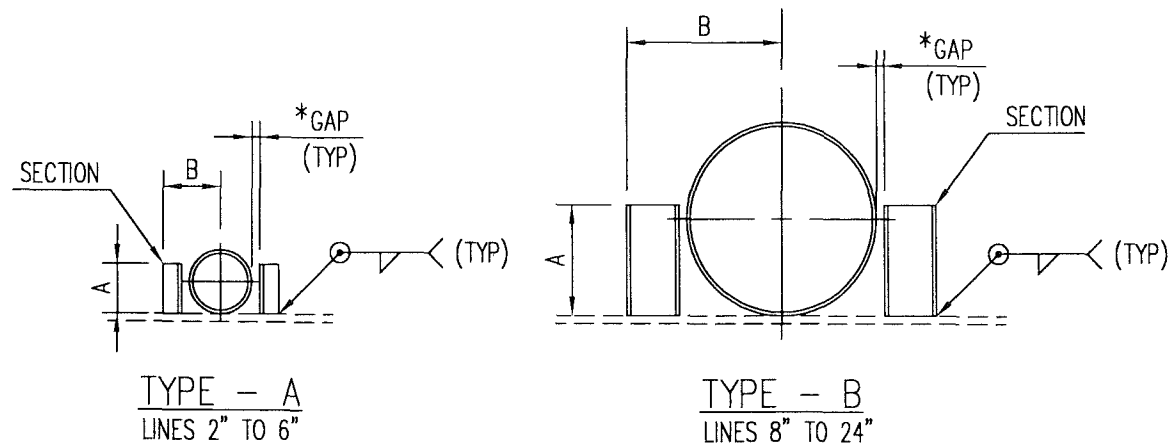

* - GAP SHALL BE AS PER PIPING GA.
IF NOT SPECIFIED IT SHALL BE 2mm

FOR LOCATION REFER PIPING GA.

PIPE GUIDE DESIGNATION	NOMINAL PIPE SIZE		PIPE OD	DIMENSIONS		SECTION	Nos. REQD.
	INCHES	MM		A	B		
PG-2	2"	50	60.3	55	82	RSA 50x50x6	3
PG-3	3"	80	88.9	80	97	RSA 50x50x6	-
PG-4	4"	100	114.3	80	110	RSA 50x50x6	3
PG-6	6"	150	168.3	110	137	RSA 50x50x6	5
PG-8	8"	200	219.1	160	212	RSC 100	-
PG-10	10"	250	273.0	160	239	RSC 100	-
PG-12	12"	300	323.9	230	264	RSC 100	-
PG-14	14"	350	355.6	230	280	RSC 100	-
PG-16	16"	400	406.4	230	306	RSC 100	-
PG-18	18"	450	457.0	260	371	RSC 140	-
PG-20	20"	500	508.0	290	396	RSC 140	-
PG-24	24"	600	610.0	340	447	RSC 140	-
PG-30	30"	750	762.0	150	464	RSC 140	-
PG-32	32"	800	813.0	150	492	RSC 140	-
PG-40	40"	1000	1016.0	200	588	RSC 160	-

M T O

DESCRIPTION	QUANTITY	UNITS	SAP No.
RSC 160	-	m	1000062643
RSC 140	-	m	1000080366
RSC 100	-	m	1000145612
RSA 100x100x12	-	m	1000142036
RSA 50x50x6	1.70	m	1000062629

APPROVED FOR CONSTRUCTION

[THIS DRAWING IS BASED ON P.D.O. DRG. No. STD-2-3604-001-A3-C - TYPE 604]

ورلي بارسونز - الصناعات العربية (محصاة)
WorleyParsons - Arabian Industries (JV)
 CONTRACT NO.: C31/0606 PROJ. NO.: PAIP00405

REV	DATE	DRAWN BY	TEAML	J.ENG.	CHECKED	DESCRIPTION	WBS No.	PROJ. ENG.	SIGNATURE
A	27.02.11	GCS	RB	✓		APPROVED FOR CONSTRUCTION	IN.09.011	OSE/28N	
O	26.02.11	GCS	KBR	GSB		ISSUED FOR COMMENTS	IN.09.011	OSE/28N	

PROJECT DRAWING REVISION
IN CASE OF DEVIATIONS A MARKED UP PRINT SHALL BE SENT TO THE PROJECT ENGINEER

- ALL DIMENSIONS ARE IN MILLIMETRES EXCEPT PIPE SIZE
- ALL STEEL WORK EXCEPT REINFORCING PLATE TO TO BS EN 10025 GR S275 JR
- ALL CONNECTIONS TO BE MADE USING 6mm CFW.
- STEELWORK CORROSION PROTECTION SHALL COMPLY WITH SP-1246-2

DESCRIPTION	AREA	S	SERIAL	SH.	P	S


NOTES	REFERENCE DRAWINGS

AREA : NIMR
 SUB AREA : PRODUCTION STATION No. 05
 DRWG. TYPE : PIPE SUPPORTS
 DESCRIPTION : PIPE GUIDE DETAILS


SCALE : NTS
 CAD DRAWING
 0 1 2 3 4 5 6 7

شركة تنمية نفط عُمان
 Petroleum Development Oman


DRWG	AREA CODE	ENG SECT	SERIAL NUMBER	SHEET	PROJ CODE	DWG SIZE	REV.
NO	NIM	2	5772	023	DQ	3	A

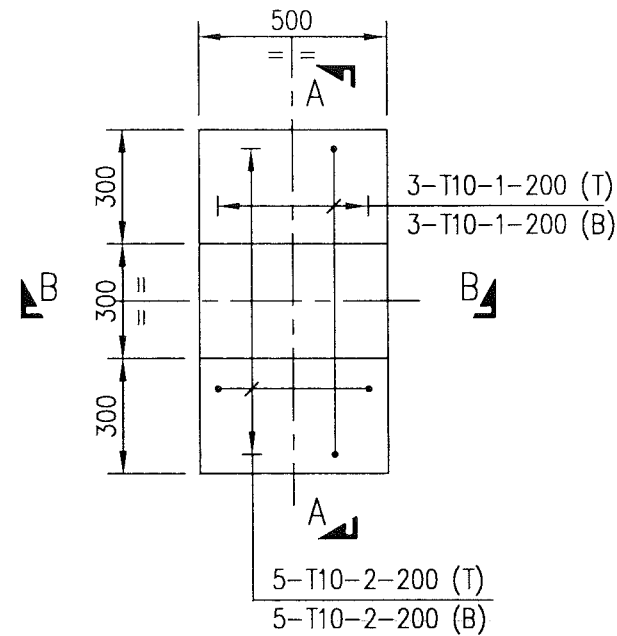


PLAN
(2 Nos. REQD)

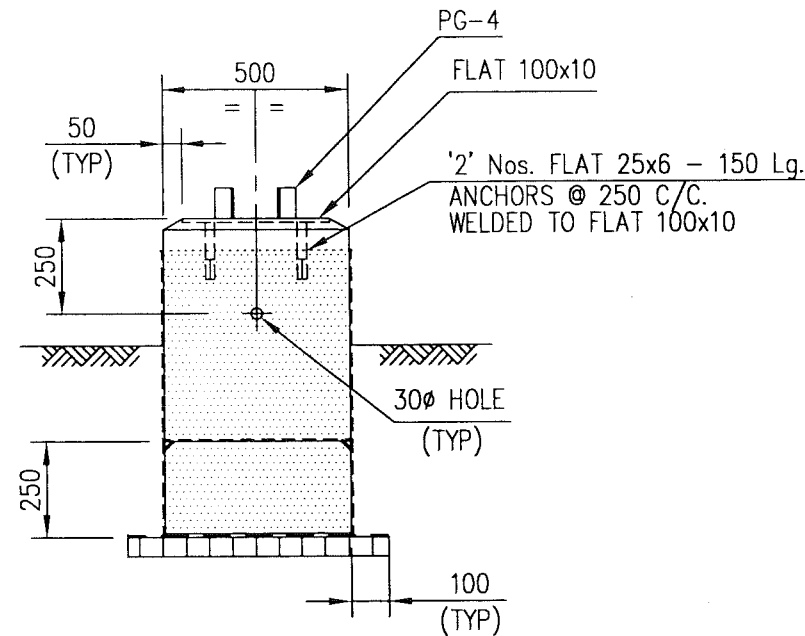

SECTION B-B

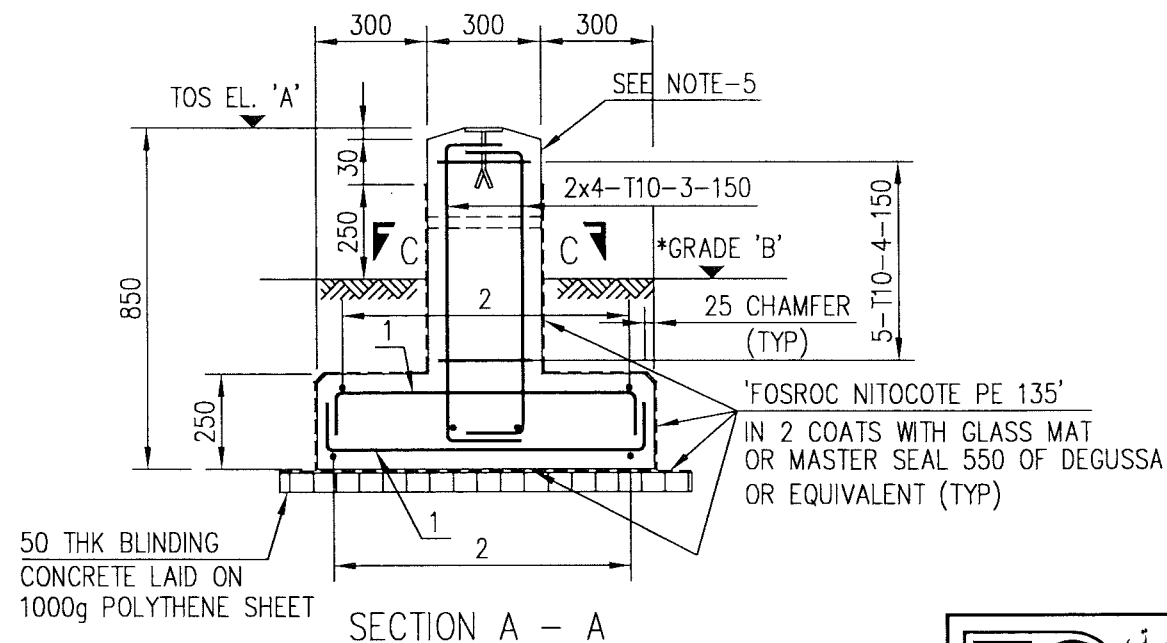

SECTION A - A

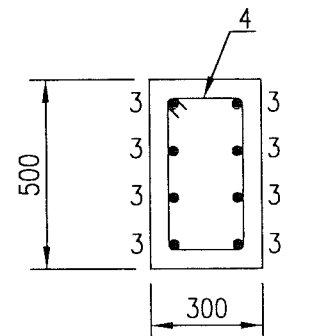

SECTION C-C

SLEEPER TYPE	LOCATION DRAWING	ELEVATIONS		PIPE GUIDE	Nos. REQD.
		A	* B		
SL-001	NIM-2-5604-005-DQ-1	99.134	98.800	PG-4	1
SL-002	NIM-2-5604-005-DQ-1	99.123	98.800	PG-4	1

NOTE: * DENOTES, SINCE GRADE ELEVATION VARIES, CONTRACTOR TO VERIFY ELEVATIONS AND DIMENSIONS AT SITE, PRIOR TO FABRICATION/CONSTRUCTION/INSTALLATION.

M.T.O.			
DESCRIPTION	QUANTITY	UNITS	SAP No.
BLINDING CONCRETE	0.80	m ³	N.A.
CONCRETE GRADE 35	0.41	m ³	N.A.
FLAT 100x10	0.80	m	1000062581
FLAT 25x6	0.60	m	1000062571
REINFORCEMENT STEEL	37.05	Kg	N.A.
PROTECTIVE COATING	5.30	m ²	N.A.
POLYTHENE SHEET 1000g	1.60	m ²	N.A.

10. 11/11/2011
T.A.2

APPROVED FOR
CONSTRUCTION

REV	DATE	DRAWN BY	TEAM L.	J. ENG.	CHECKED	DESCRIPTION	WBS No.	PROJ. ENG.	SIGNATURE
A	27.02.11	GCS	BB	J.		APPROVED FOR CONSTRUCTION	IN.09.011	OSE/28N	
O	26.02.11	GCS	KBR	GSB		ISSUED FOR COMMENTS	IN.09.011	OSE/28N	
								P D O APPROVAL	

ورلي بارسونز - الصناعات العربية (محاصة)
WorleyParsons - Arabian Industries (JV)
 CONTRACT NO.: C31/0606 PROJ. NO.: PAIP00405

- ALL DIMENSIONS ARE IN MILLIMETRES AND ELEVATIONS IN METRES.
- CONCRETE TO BS 8110, GRADE 35 FOR REINFORCED CONCRETE, GRADE 10 FOR BLINDING CONCRETE USING OPC.
- 50mm COVER TO REINFORCEMENT, REINFORCEMENT TO BS 4449.
- TANGS WELDED TO WEAR PLATE USING 6mm CFW. AND EXPOSED STEEL WORK TO BE PAINTED IN ACC. WITH SP-1246-2
- ALL EXPOSED CONCRETE SURFACES SHALL BE TREATED WITH TWO COATS OF "FOSROC DEKGUARD S" WITH A DFT OF 350 MICRONS OR ANY OTHER APPROVED EQUIVALENT.
- FOR BAR BENDING SCHEDULE REFER DRG. No. NIM-2-5772-025-DQ-4
- PIPE GUIDE DETAILS REFER DRG NO. NIM-2-5572-023-DQ-3

NOTES/REFERENCE DRAWINGS

PROJECT DRAWING REVISION									
IN CASE OF DEVIATIONS A MARKED UP PRINT SHALL BE SENT TO THE PROJECT ENGINEER									
AREA	: NIMR					SCALE : 1:20			
SUB AREA	: NIMR SLUDGE PIT SYSTEM UPGRADE					CAD DRAWING			
DRWG. TYPE	: PIPE SUPPORTS-SLEEPER DETAILS					No. 05			
DESCRIPTION	: SL-001 & 002					No. 05			
DRWG	AREA CODE	ENG SECT	SERIAL NUMBER	SHEET	PROJ CODE	DWG SIZE	REV.		
NO	NIM	2	5772	024	DQ	3	A		

BAR BENDING SCHEDULE

JOB NO.: PAIP00405
PART ID.: NIMR SLUDGE PIT SYSTEM UPGRADE
SL-001&002

Document No.: NIM-2-5772-025-DQ-4

Revision No.: A

Prepared by: GCS

Checked by: PNG *RB*

Date: 27.02.11

REF. DWG NO.: NIM-2-5772-024-DQ-3

Total MTO for Rebars.

Dia. Of Bar	T6	T8	T10	T12	T16	T20	T25	T32
Length of Bar (m)			59.75					
Weight (Kgs)			37.05					

5	57	1
Total Weight (Kgs)		

37.050

[illegible]

1c. Number
- 2A2





This schedule complies with BS 8666 : 2005

All dimensions are in mm

Refer to Bar shape Code drawing

* Specified in multiples of 5 mm

† Specified in multiples of 25 mm

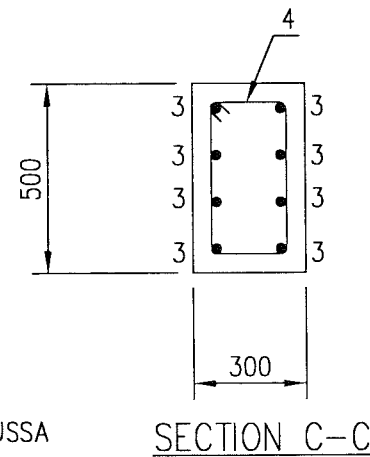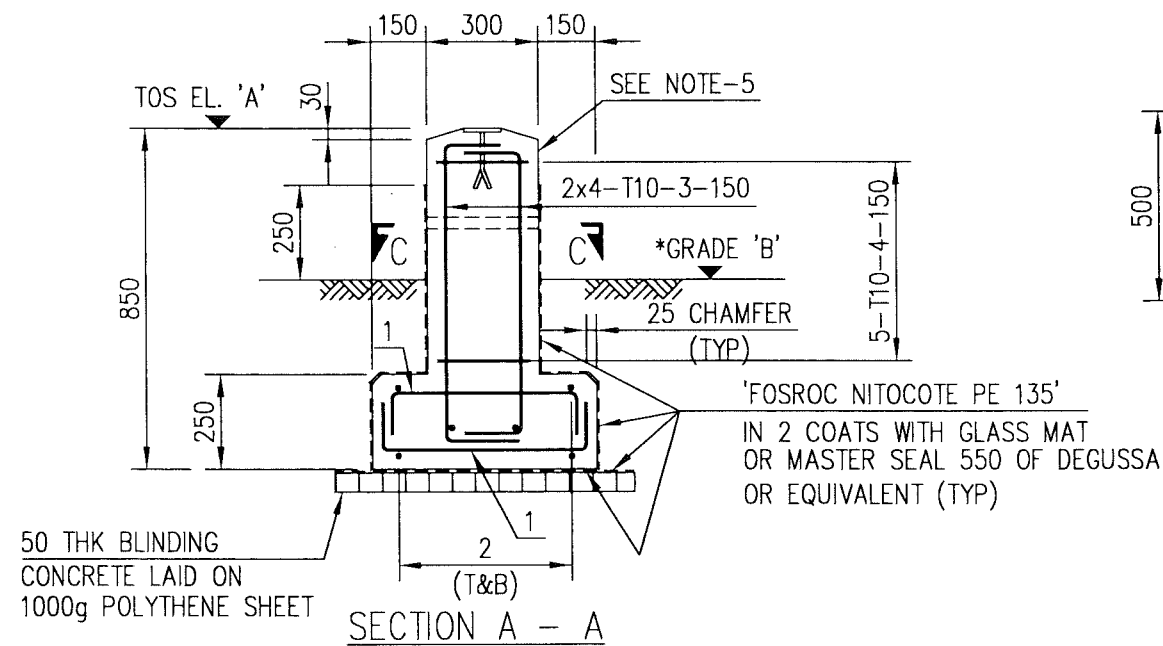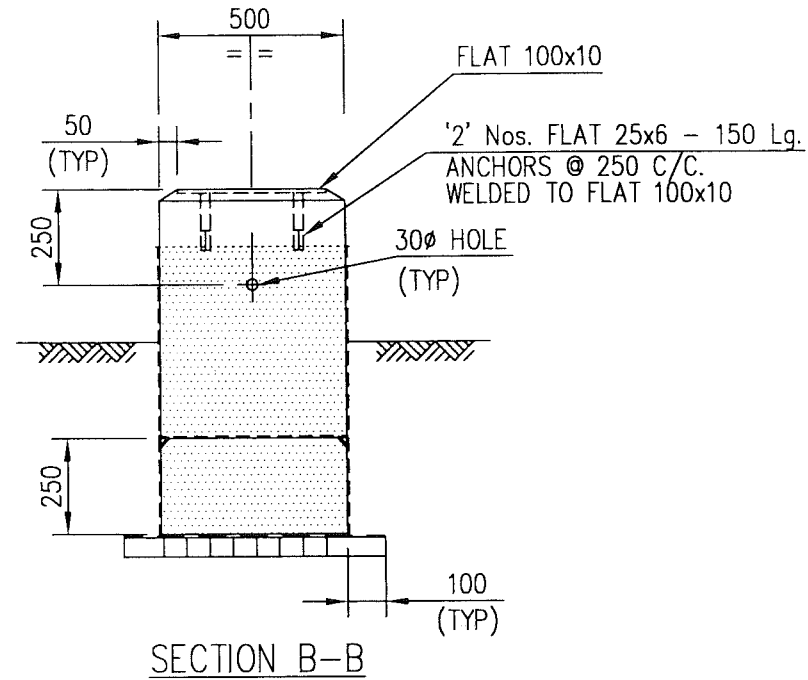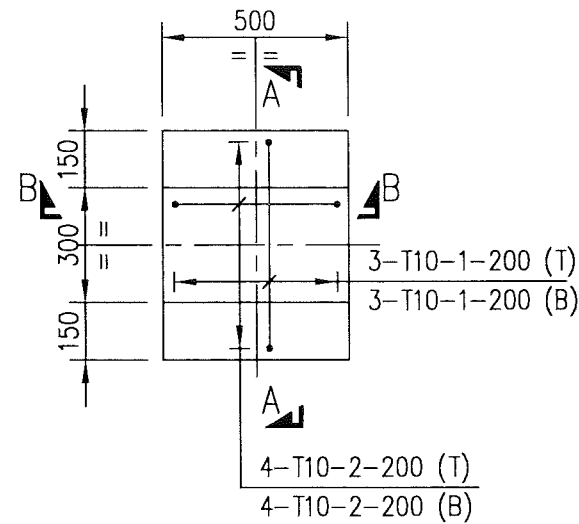

SLEEPER TYPE	LOCATION DRAWING	ELEVATIONS		PIPE GUIDE	Nos. REQD.
		A	* B		
SL-003	NIM-2-5604-005-DQ-1	99.147	98.800	-	1
SL-005	NIM-2-5604-005-DQ-1	99.100	98.800	-	1

NOTE: * DENOTES, SINCE GRADE ELEVATION VARIES, CONTRACTOR TO VERIFY ELEVATIONS AND DIMENSIONS AT SITE, PRIOR TO FABRICATION/CONSTRUCTION/INSTALLATION.

M.T.O.			
DESCRIPTION	QUANTITY	UNITS	SAP No.
BLINDING CONCRETE	0.06	m ³	N.A.
CONCRETE GRADE 35	0.35	m ³	N.A.
FLAT 100x10	0.80	m	1000062581
FLAT 25x6	0.60	m	1000062571
REINFORCEMENT STEEL	27.06	Kg	N.A.
PROTECTIVE COATING	4.25	m ²	N.A.
POLYTHENE SHEET 1000g	1.15	m ²	N.A.

K. Ammer
TA2

APPROVED FOR
CONSTRUCTION

REV	DATE	DRAWN BY	TEAM L.	J. ENG.	CHECKED	DESCRIPTION	WBS No.	PROJ. ENG.	SIGNATURE
A	27.02.11	GCS	RB	✓		APPROVED FOR CONSTRUCTION	IN.09.011	OSE/28N	
0	26.02.11	GCS	KBR	GSB		ISSUED FOR COMMENTS	IN.09.011	OSE/28N	

ورلي بارسونز - الصناعات العربية (محاصة)
WorleyParsons - Arabian Industries (JV)
 CONTRACT NO.: C31/0606 PROJ. NO.: PAIP00405

- ALL DIMENSIONS ARE IN MILLIMETRES AND ELEVATIONS IN METRES.
- CONCRETE TO BS 8110, GRADE 35 FOR REINFORCED CONCRETE, GRADE 10 FOR BLINDING CONCRETE USING OPC.
- 50mm COVER TO REINFORCEMENT, REINFORCEMENT TO BS 4449.
- TANGS WELDED TO WEAR PLATE USING 6mm CFW. AND EXPOSED STEEL WORK TO BE PAINTED IN ACC. WITH SP-1246-2
- ALL EXPOSED CONCRETE SURFACES SHALL BE TREATED WITH TWO COATS OF "FOSROC DEKGUARD S" WITH A DFT OF 350 MICRONS OR ANY OTHER APPROVED EQUIVALENT.
- FOR BAR BENDING SCHEDULE REFER DRG. No. NIM-2-5772-027-DQ-4

NOTES/REFERENCE DRAWINGS

PROJECT DRAWING REVISION
IN CASE OF DEVIATIONS A MARKED UP PRINT SHALL BE SENT TO THE PROJECT ENGINEER

AREA	: NIMR	SCALE : 1:20	CAD DRAWING
SUB AREA	: NIMR SLUDGE PIT SYSTEM UPGRADE	No. 05	
DRWG. TYPE	: PIPE SUPPORTS-SLEEPER DETAILS		
DESCRIPTION	: SL-003 & SL-005		
DRWG	AREA CODE	ENG SECT	SERIAL NUMBER
NO	NIM 2 5772 026 DQ	3	A

BAR BENDING SCHEDULE

JOB NO.: PAIP00405
PART ID.: NIMR SLUDGE PIT SYSTEM UPGRADE
SL-003&005

Document No.: NIM-2-5772-027-DQ-4

Revision No.: A

Prepared by: GCS

Checked by: PNG PL

Date: 27.02.11

REF. DWG NO.: NIM-2-5772-026-DQ-3

Total MTO for Rebars.

Dia. Of Bar	T6	T8	T10	T12	T16	T20	T25	T32
Length of Bar (m)			43.65					
Weight (Kgs)			27.07					

Total Weight (Kgs)

27.070

1c. Number
- A2

[illegible]

This schedule complies with BS 8666 : 2005


All dimensions are in mm

Refer to Bar shape Code drawing


* Specified in multiples of 5 mm

† Specified in multiples of 25 mm


BAR BENDING SCHEDULE

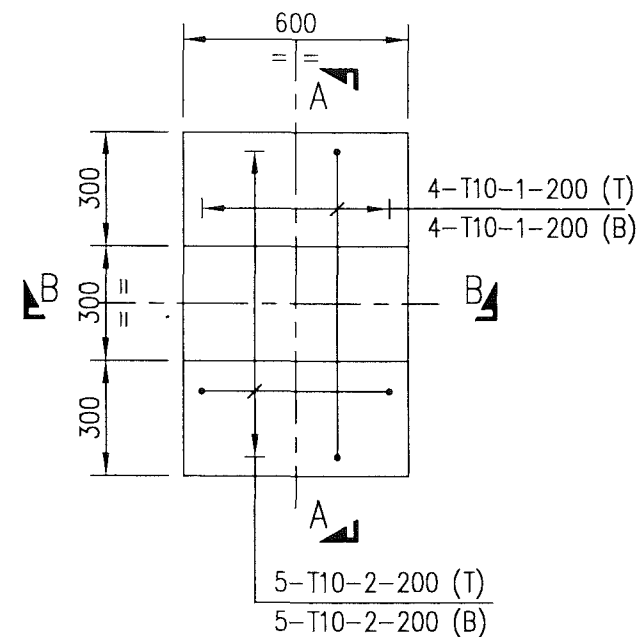


PLAN
(6 Nos. REQD)

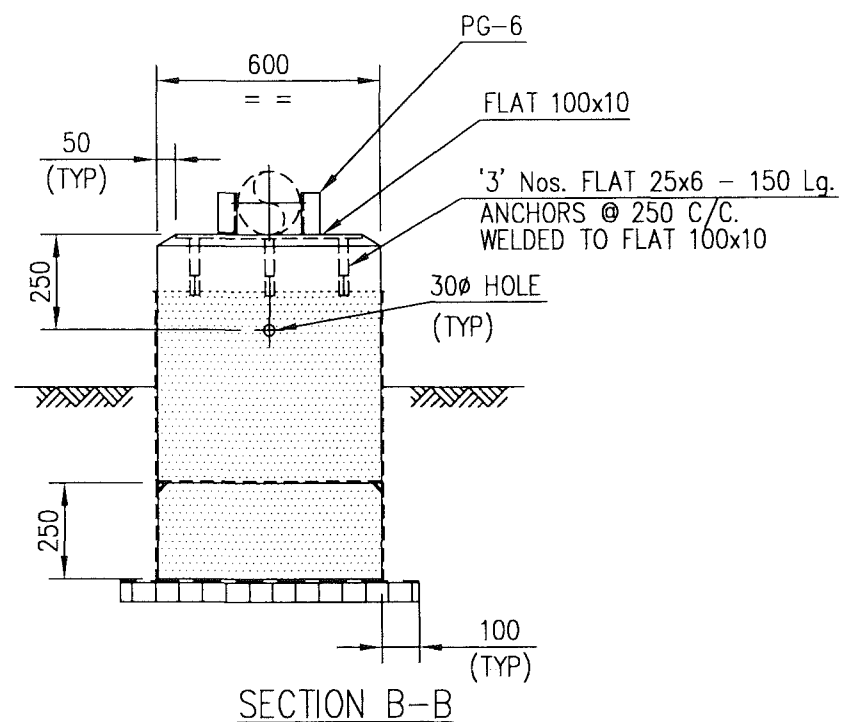

SECTION B-B

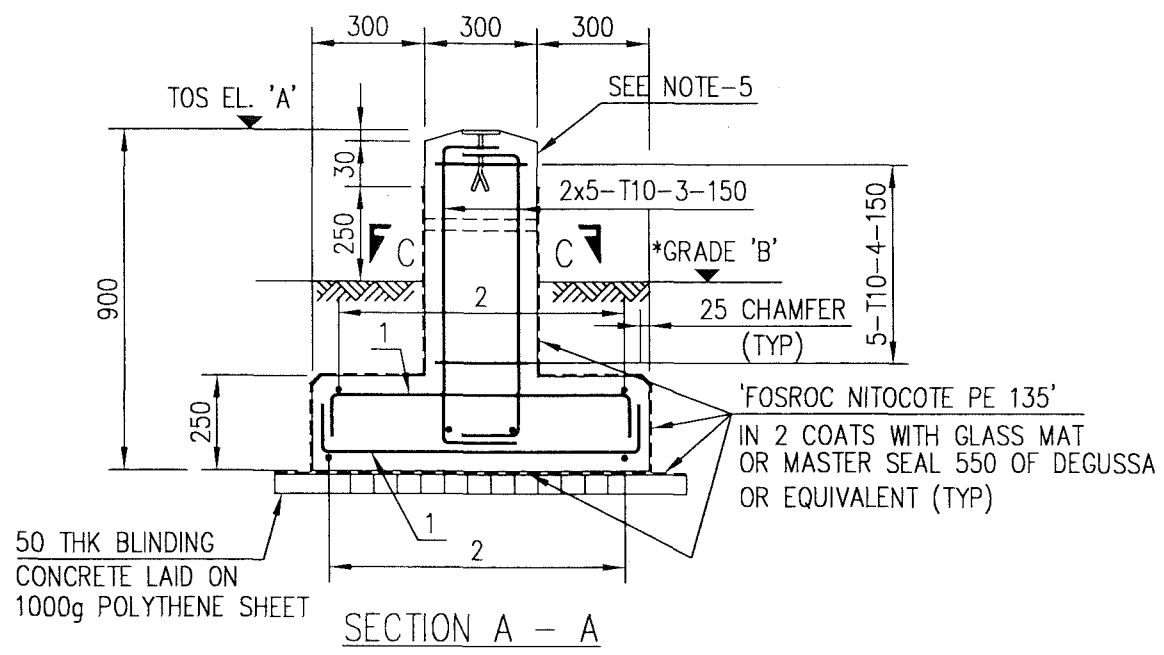

SECTION A - A

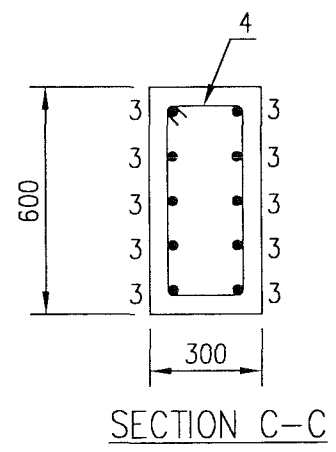


SECTION C-C

SLEEPER TYPE	LOCATION DRAWING	ELEVATIONS		PIPE GUIDE	Nos. REQD.
		A	* B		
SL-010	NIM-2-5210-001-DQ-1	98.600	98.200	-	1
SL-011				PG-6	
SL-014				-	
SL-015				-	
SL-016				-	
SL-019				-	

NOTE: * DENOTES, SINCE GRADE ELEVATION VARIES, CONTRACTOR TO VERIFY ELEVATIONS AND DIMENSIONS AT SITE, PRIOR TO FABRICATION/CONSTRUCTION/INSTALLATION.

M.T.O.			
DESCRIPTION	QUANTITY	UNITS	SAP No.
BLINDING CONCRETE	0.264	m ³	N.A.
CONCRETE GRADE 35	1.51	m ³	N.A.
FLAT 100x10	3.00	m	1000062581
FLAT 25x6	2.70	m	1000062571
REINFORCEMENT STEEL	137.55	Kg	N.A.
PROTECTIVE COATING	17.36	m ²	N.A.
POLYTHENE SHEET 1000g	5.30	m ²	N.A.


APPROVED FOR CONSTRUCTION


ورلي بارسونز - الصناعات العربية (محصاة)
WorleyParsons - Arabian Industries (JV)
 CONTRACT NO.: C31/0606 PROJ. NO.: PAIP00405

REV	DATE	DRAWN BY	TEAM L	J.ENG.	DESCRIPTION	WBS No.	PROJ. ENG.	SIGNATURE
A	27.02.11	GCS	RB	GSB	APPROVED FOR CONSTRUCTION	IN.09.011	OSE/28N	
O	26.02.11	GCS	KBR	GSB	ISSUED FOR COMMENTS	IN.09.011	OSE/28N	
					CHECKED		P D O APPROVAL	


1. ALL DIMENSIONS ARE IN MILLIMETRES AND ELEVATIONS IN METRES.
2. CONCRETE TO BS 8110, GRADE 35 FOR REINFORCED CONCRETE, GRADE 10 FOR BLINDING CONCRETE USING OPC.
3. 50mm COVER TO REINFORCEMENT, REINFORCEMENT TO BS 4449.
4. TANGS WELDED TO WEAR PLATE USING 6mm CFW. AND EXPOSED STEEL WORK TO BE PAINTED IN ACC. WITH SP-1246-2
5. ALL EXPOSED CONCRETE SURFACES SHALL BE TREATED WITH TWO COATS OF "FOSROC DEKGUARD S" WITH A DFT OF 350 MICRONS OR ANY OTHER APPROVED EQUIVALENT.
6. FOR BAR BENDING SCHEDULE REFER DRG. No. NIM-2-5772-031-DQ-4
7. PIPE GUIDE DETAILS REFER DRG NO. NIM-2-5572-023-DQ-3

NOTES/REFERENCE DRAWINGS

PROJECT DRAWING REVISION
 IN CASE OF DEVIATIONS A MARKED UP PRINT SHALL BE SENT TO THE PROJECT ENGINEER
 AREA : NIMR
 SUB AREA : NIMR SLUDGE PIT SYSTEM UPGRADE No. 05
 DRWG TYPE : PIPE SUPPORTS-SLEEPER DETAILS
 DESCRIPTION : SL-010, 011, 014, 015, 016 & 019
 SCALE : 1:20 CAD DRAWING

 شركة تنمية نفط عُمان
 Petroleum Development Oman
 DRWG AREA ENG SERIAL SHEET PROJ DWG REV.
 NO CODE SECT NUMBER CODE SIZE
 NIM 2 5772 030 DQ 3 A

BAR BENDING SCHEDULE

JOB NO.: PAIP00405
PART ID.: NIMR SLUDGE PIT SYSTEM UPGRADE
SLEEPER SUPPORTS

Document No.: NIM-2-5772-031-DQ-4
Revision No.: A
Prepared by: GCS
Checked by: PNG 
Date: 27.02.11

REF. DWG NO.: NIM-2-5772-030-DQ-3

Total MTO for Rebars.

Dia. Of Bar	T6	T8	T10	T12	T16	T20	T25	T32
Length of Bar (m)			221.85					
Weight (Kgs)			137.55					

Total Weight (Kgs)

137 550

11-MY new
TA2

[illegible]

This schedule complies with BS 8666 : 2005

All dimensions are in mm

Refer to Bar shape Code drawing

* Specified in multiples of 5 mm

† Specified in multiples of 25 mm.

PIPE SUPPORT/ SLEEPER NUMBER	REFERENCE DRAWINGS			REMARKS
	STEELWORK DETAILS	SLEEPER/FOUNDATION DETAILS	LOCATION PLAN	
PS-051	NIM-2-5772-033-DQ-3	NIM-2-5772-034-DQ-3	NIM-2-5166-001-DQ-1	-
PS-052	NIM-2-5772-036-DQ-3	NIM-2-5772-037-DQ-3		-
PS-053	NIM-2-5772-039-DQ-3	NIM-2-5772-040-DQ-3		-
PS-054	NIM-2-5772-039-DQ-3	NIM-2-5772-040-DQ-3		-
PS-055	NIM-2-5772-042-DQ-3	NIM-2-5772-037-DQ-3		-
PS-056				SPARE
PS-057	NIM-2-5772-039-DQ-3	NIM-2-5772-040-DQ-3	NIM-2-5166-001-DQ-1	-
PS-058				-
PS-059				-
PS-060				-
PS-061				-
PS-062				-
PS-063				SPARE
PS-064	NIM-2-5772-045-DQ-3	NIM-2-5772-043-DQ-3	NIM-2-5166-001-DQ-1	-
PS-065	NIM-2-5772-046-DQ-3	NIM-2-5772-043-DQ-3		-
PS-066	NIM-2-5775-006-DQ-1	-		-
PS-067	NIM-2-5772-047-DQ-3		NIM-3-5085-001-DQ-1	-
PS-068	NIM-2-5775-006-DQ-1	-	NIM-2-5166-001-DQ-1	-
PS-069	NIM-2-5775-006-DQ-1	-		-
PS-070	NIM-2-5772-039-DQ-3	NIM-2-5772-040-DQ-3		-
PS-071	NIM-2-5772-046-DQ-3	NIM-2-5772-043-DQ-3		-
PS-072	NIM-2-5772-045-DQ-3	NIM-2-5772-043-DQ-3		-
PS-073	NIM-2-5772-045-DQ-3	NIM-2-5772-043-DQ-3		-
PS-074				SPARE
PS-075				SPARE
PS-076	NIM-2-5772-048-DQ-3	NIM-2-5772-049-DQ-3	NIM-2-5166-001-DQ-1	-
PS-077				-
PS-078				-
PS-079				-
PS-080				-
PS-081				-

PIPE SUPPORT/ SLEEPER NUMBER	REFERENCE DRAWINGS			REMARKS
	STEELWORK DETAILS	SLEEPER/FOUNDATION DETAILS	LOCATION PLAN	
PS-082	NIM-2-5772-048-DQ-3	NIM-2-5772-049-DQ-3	NIM-2-5166-001-DQ-1	-
PS-083				-
PS-084				-
PS-085				-
PS-086	NIM-2-5772-052-DQ-3		NIM-2-5167-001-DQ-1	-
PS-087	NIM-2-5772-051-DQ-3	NIM-2-5772-049-DQ-3	NIM-2-5167-001-DQ-1	-
U BOLT DET.	NIM-2-5772-055-DQ-3	-	-	
-	-	-	-	
-	-	-	-	
SL-001	-	NIM-2-5774-005-DQ-3	NIM-2-5166-001-DQ-1	-
SL-002	-	NIM-2-5772-053-DQ-3		-
SL-003	-			-
SL-004	-			-
SL-005	-		NIM-2-5167-001-DQ-1	-
SL-006	-			-
SL-007	-			-
SL-008	-			-
SL-009	-		NIM-2-5166-001-DQ-1	-
SL-010	-		NIM-2-5166-001-DQ-1	-

10. Annex
TA 2
**APPROVED FOR
CONSTRUCTION**

REV	DATE	DRAWN BY	TEAM L	J.ENG.	CHECKED	DESCRIPTION	WBS No.	PROJ. ENG.	SIGNATURE
A	27.02.11	GCS	RB	✓		APPROVED FOR CONSTRUCTION	IN.09.011	OSE/28N	
0	26.02.11	GCS	KBR	GSB		ISSUED FOR COMMENTS	IN.09.011	OSE/28N	




1. CONTRACTOR SHALL REFER PIPING PLAN ,PRIOR TO FABRICATION, INSTALLATION OF PIPE SUPPORTS												
NOTES	DESCRIPTION	AREA	S	SERIAL	SH.	P	S					
		DRAWING NUMBER										
NOTES	REFERENCE DRAWINGS											


PROJECT DRAWING REVISION									
IN CASE OF DEVIATIONS A MARKED UP PRINT SHALL BE SENT TO THE PROJECT ENGINEER									
AREA : NIMR						SCALE : NTS			
SUB AREA : PRODUCTION STATION						CAD DRAWING			
DRWG. TYPE : PIPE SUPPORTS (RECEIVER)						No. 05			
DESCRIPTION : INDEX SHEETS									
						DRWG	AREA CODE	ENG SECT	SERIAL NUMBER
							SHEET	PROJ CODE	DWG SIZE
						NO	NIM 2 5772 032 DQ		3 A




شركة تنمية نفط عُمان
Petroleum Development Oman

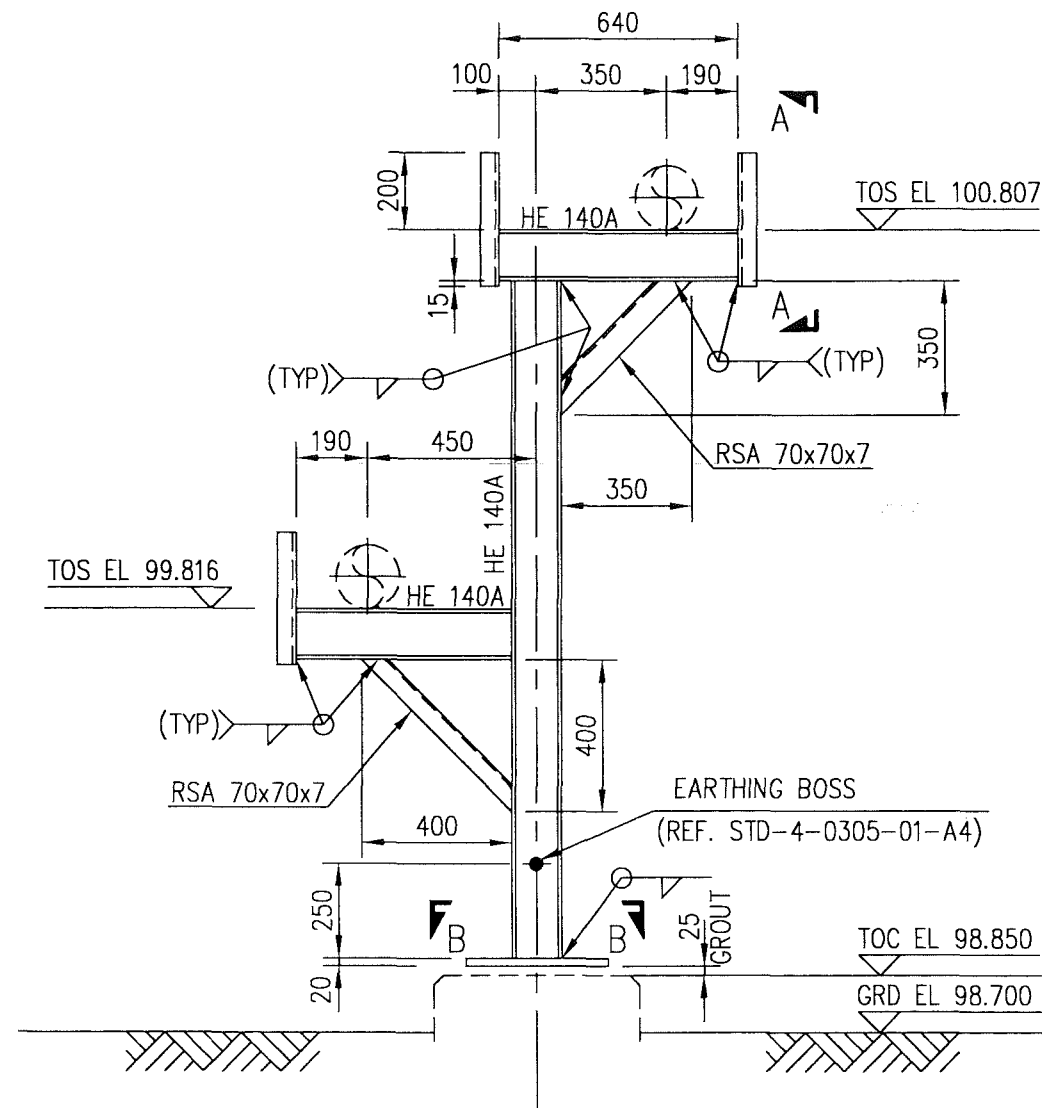

ELEVATION

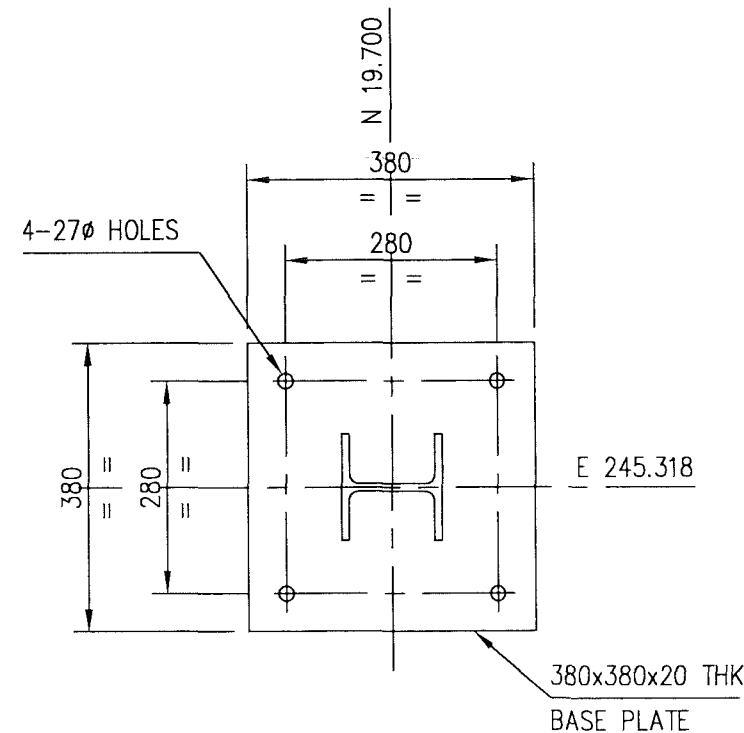

SECTION B - B

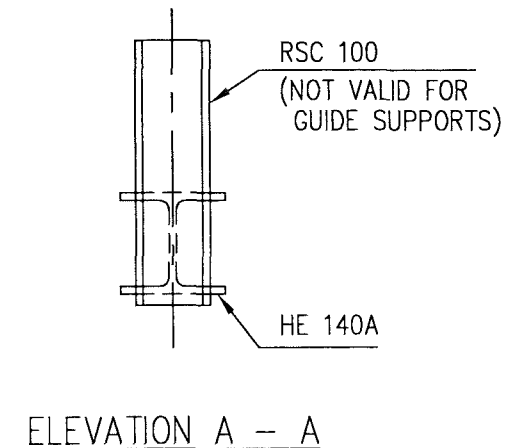


ELEVATION A - A

M T O			
DESCRIPTION	QUANTITY	UNITS	SAP No.
HE 140A	3.00	m	1000080438
RSC 100	1.15	m	1000145612
RSA 70x70x7	1.05	m	1000080321
20 THK PLATE	0.15	m ²	1000062610
EARTHING BOSS	1	PCS	N.A.

NOTE: * DENOTES, SINCE GRADE ELEVATION VARIES, CONTRACTOR TO VERIFY ELEVATIONS AND DIMENSIONS AT SITE, PRIOR TO FABRICATION/CONSTRUCTION/INSTALLATION.

1c. Am new
7 A2

APPROVED FOR
CONSTRUCTION

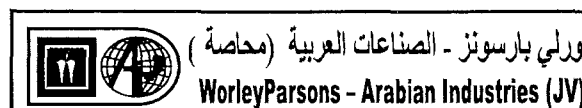

CONTRACT NO.: C31/0606 PROJ. NO.: PAIP00405

REV	DATE	DRAWN BY	TEAM L.	J. ENG.	CHECKED	DESCRIPTION	WBS No.	PROJ. ENG.	SIGNATURE
A	27.02.11	GCS	RB	Y		APPROVED FOR CONSTRUCTION	IN.09.011	OSE/28N	
O	26.02.11	GCS	KBR	GSB		ISSUED FOR COMMENTS	IN.09.011	OSE/28N	
						PROJECT DRAWING REVISION	IN CASE OF DEVIATIONS A MARKED UP PRINT SHALL BE SENT TO THE PROJECT ENGINEER		


- ALL DIMENSIONS ARE IN MILLIMETRES.
- ALL ELEVATIONS & CO-ORDINATES ARE IN METRES.
- ALL STEEL WORK TO BS EN 10025 GRADE S275 JR
- PIPE SECTION TO API 5L GR B.
- ALL CONNECTIONS TO BE MADE USING 5mm CFW.
- ALL STEEL WORK TO RECEIVE CORROSION PROTECTION IN ACCORDANCE WITH DOCUMENT No. SP-1246-2

NOTES


DESCRIPTION	AREA	S	SERIAL	SH.	P	S
FOUNDATION DETAILS	NIM	2	5772	034	DQ	3
FOUNDATION LOCATION PLAN	NIM	2	5166	001	DQ	1
DRAWING NUMBER						

REFERENCE DRAWINGS


AREA : NIMR		SCALE : 1:20		CAD DRAWING			
SUB AREA : PRODUCTION STATION		No. 05					
DRWG. TYPE : PIPE SUPPORTS							
DESCRIPTION : PS-051							

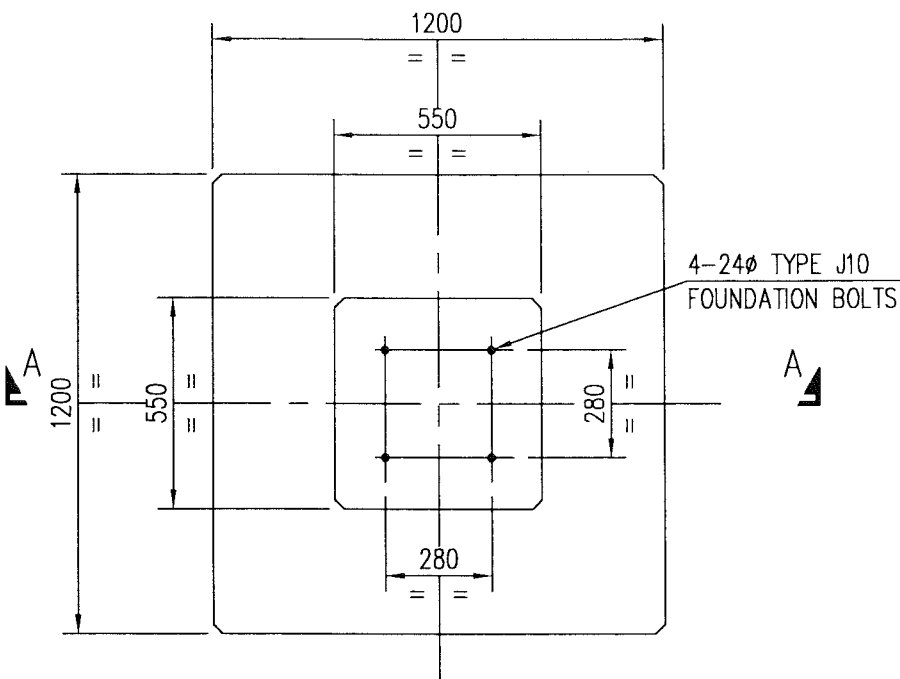


PLAN

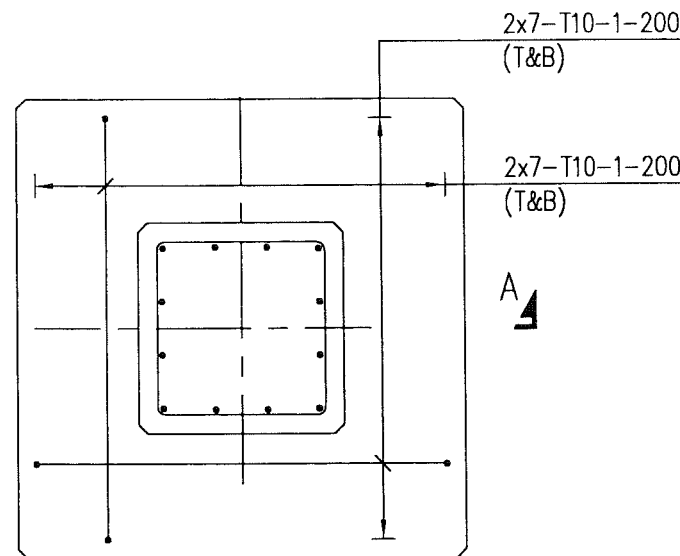

REINFORCEMENT PLAN

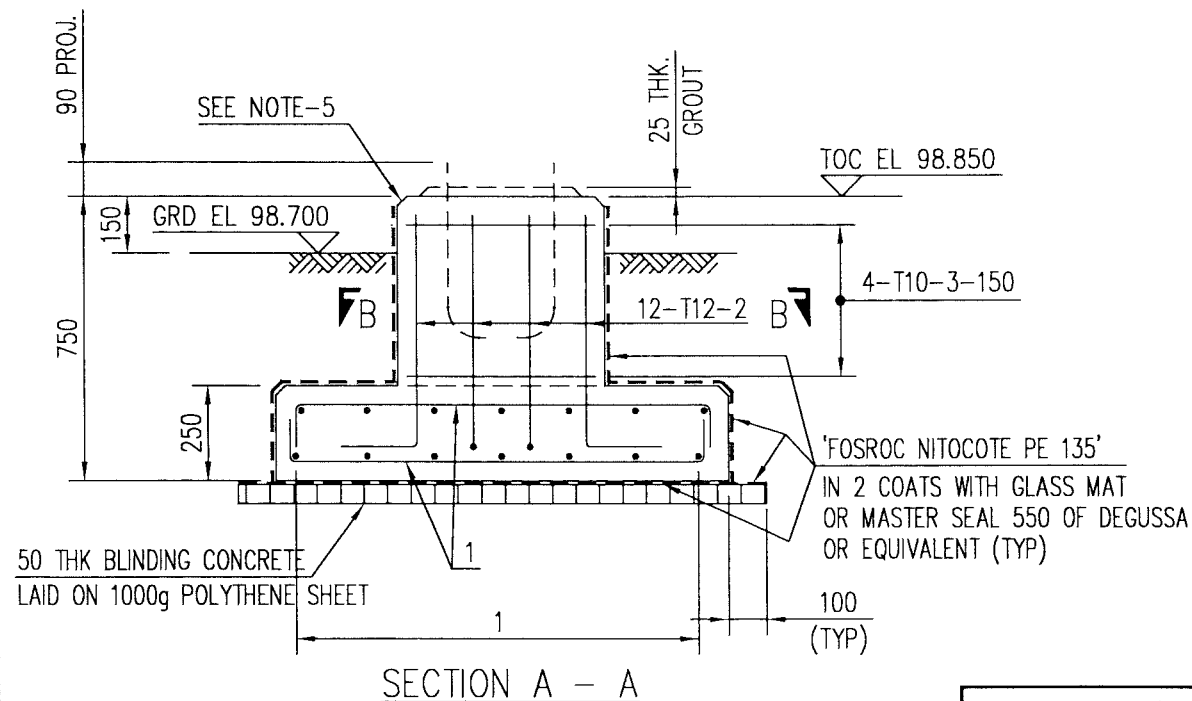

SECTION A - A

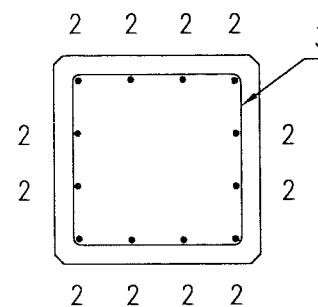

SECTION B - B

M T O			
DESCRIPTION	QUANTITY	UNITS	SAP No.
BLINDING CONCRETE GRADE 10	0.10	m ³	N.A.
CONCRETE GRADE 35	0.51	m ³	N.A.
CEMENT SAND GROUT	5.90	lit	N.A.
REINFORCEMENT STEEL	36.72	Kg	N.A.
PROTECTIVE COATING	5.40	m ²	N.A.
24φ FOUNDATION BOLT TYPE - J10	4	PCS	N.A.
1000g POLYTHENE SHEET	1.96	m ²	N.A.

NOTE: * DENOTES, SINCE GRADE ELEVATION VARIES, CONTRACTOR TO VERIFY ELEVATIONS AND DIMENSIONS AT SITE, PRIOR TO FABRICATION/CONSTRUCTION/INSTALLATION.

ic. Amner
7A2

APPROVED FOR
CONSTRUCTION

[THIS DRAWING IS BASED ON P.D.O. DRG. No.
STD-2-3904-001-A3-D - TYPE 904]

ورلي بارسونز - الصناعات العربية (محصاة)
WorleyParsons - Arabian Industries (JV)
CONTRACT NO.: C31/0606 PROJ. NO.: PAIP00405

- ALL DIMENSIONS ARE IN MILLIMETRES AND ELEVATIONS IN METRES.
- CONCRETE TO BS 8110, GRADE 35 FOR REINFORCED CONCRETE, GRADE 10 FOR BLINDING CONCRETE USING OPC.
- 50mm COVER TO REINFORCEMENT, REINFORCEMENT TO BS 4449.
- ALL EDGES SHALL HAVE A CHAMFER OF APPROX. 25mm.
- ALL EXPOSED CONCRETE SURFACES SHALL BE TREATED WITH TWO COATS OF "FOSROC DEKGUARD S" WITH A DFT OF 350 MICRONS OR ANY OTHER APPROVED EQUIVALENT.
- FOUNDATION BOLTS REFER DRG. No. STD-2-3950-001-A3
- FOR BAR BENDING SCHEDULE REFER DRG. No. NIM-2-5772-035-DQ-4
- FOUNDATION LOCATION PLAN REFER DRG. No. NIM-2-5166-001-DQ-1

NOTES/REFERENCE DRAWINGS

REV	DATE	DRAWN BY	TEAM L.	J. ENG.	CHECKED	DESCRIPTION	WBS No.	PROJ. ENG.	SIGNATURE
A	27.02.11	GCS	RB	✓		APPROVED FOR CONSTRUCTION	IN.09.011	OSE/28N	
0	26.02.11	GCS	KBR	GSB		ISSUED FOR COMMENTS	IN.09.011	OSE/28N	

PROJECT DRAWING REVISION
IN CASE OF DEVIATIONS A MARKED UP PRINT SHALL BE SENT TO THE PROJECT ENGINEER

AREA	: NIMR	SCALE : 1:20	CAD DRAWING
SUB AREA	: PRODUCTION STATION	NO. 05	
DRWG. TYPE	: PIPE SUPPORTS-FOUNDATION DETAILS		
DESCRIPTION	: PS-051		
DRWG	AREA CODE	ENG SECT	SERIAL NUMBER
NO	NIM 2 5772 034 DQ	3	A

BAR BENDING SCHEDULE

JOB NO.: PAIP00238
PART ID.: PRODUCTION STATION

Document No.: NIM-2-5772-035-DQ-4

Revision No.: A

Prepared by: GCS

Checked by: PNG RR

Date: 27.02.11

REF. DWG NO.: NIM-2-5772-034-DQ-3

Total MTO for Rebars.

Dia. Of Bar	T6	T8	T10	T12	T16	T20	T25	T32
Length of Bar (m)			45.00	9.90				
Weight (Kgs)			27.90	8.82				

Total Weight (Kgs)

36.720

1c. Number
7A2

[illegible]


This schedule complies with BS 8666 : 2005



All dimensions are in mm.

Refer to Bar shape Code drawing

* Specified in multiples of 5 mm

† Specified in multiples of 25 mm


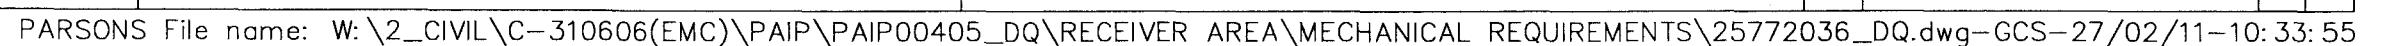


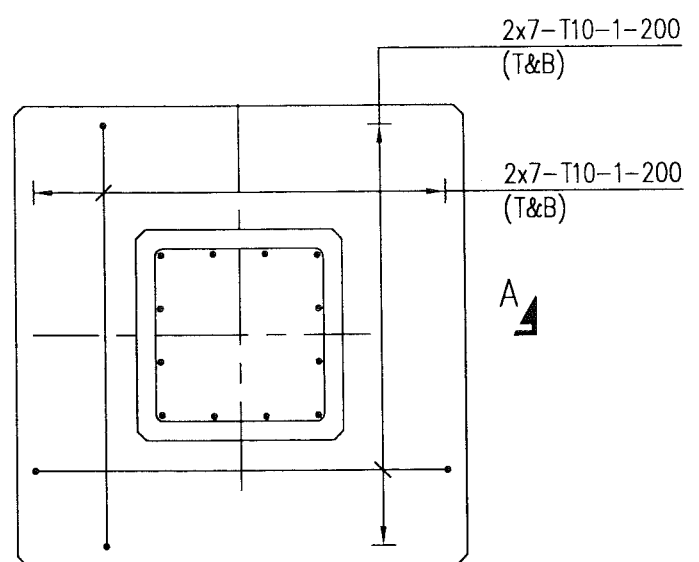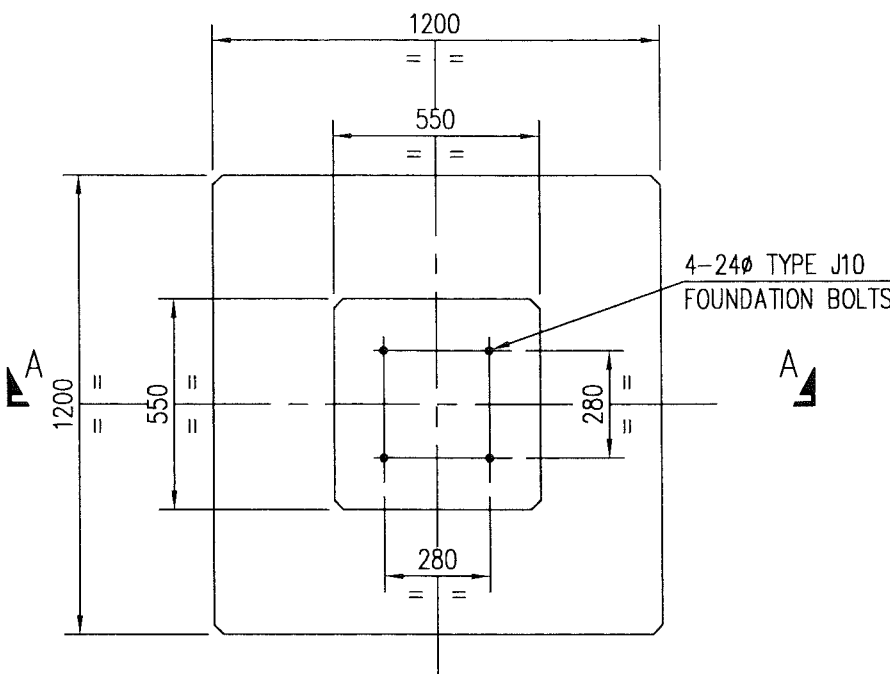


REINFORCEMENT PLAN

M T O			
DESCRIPTION	QUANTITY	UNITS	SAP No.
BLINDING CONCRETE GRADE 10	0.20	m ³	N.A.
CONCRETE GRADE 35	1.20	m ³	N.A.
CEMENT SAND GROUT	11.80	lit	N.A.
REINFORCEMENT STEEL	84.20	Kg	N.A.
PROTECTIVE COATING	12.01	m ²	N.A.
24Ø FOUNDATION BOLT TYPE - J10	8	PCS	N.A.
1000g POLYTHENE SHEET	4.00	m ²	N.A.

NOTE: * DENOTES, SINCE GRADE ELEVATION VARIES, CONTRACTOR TO VERIFY ELEVATIONS AND DIMENSIONS AT SITE, PRIOR TO FABRICATION/CONSTRUCTION/INSTALLATION.

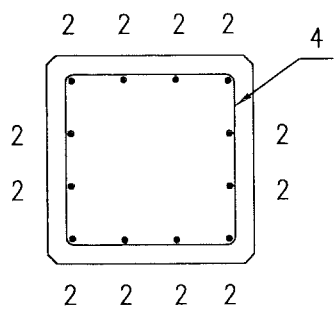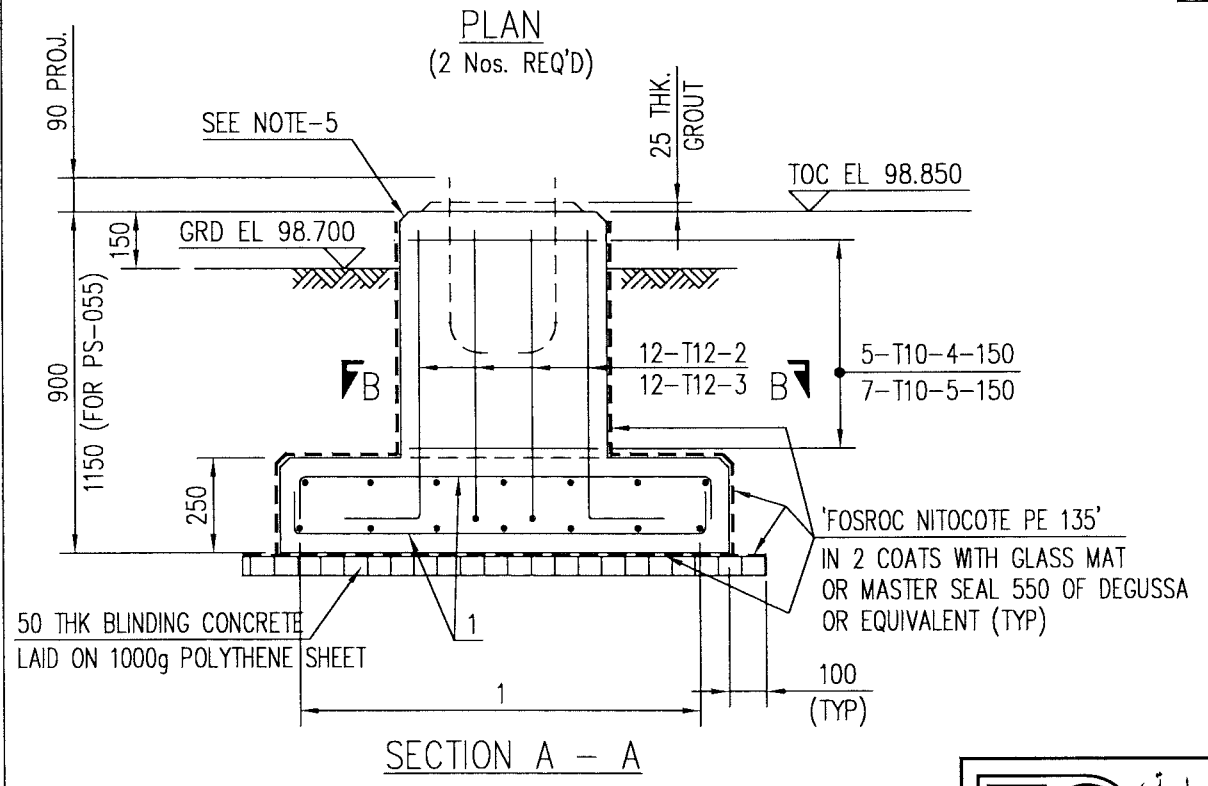

SECTION B - B

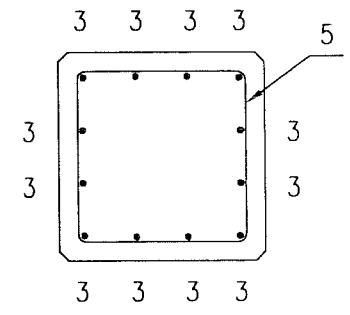

SECTION B - B
(FOR PS-055 ONLY)

10. Am new
7A2

APPROVED FOR
CONSTRUCTION

REV	DATE	DRAWN BY	TEAML.	J.ENG.	CHECKED	DESCRIPTION	WBS No.	PROJ. ENG.	SIGNATURE
A	27.02.11	GCS	RB	✓		APPROVED FOR CONSTRUCTION	IN.09.011	OSE/28N	
O	26.02.11	GCS	KBR	GSB		ISSUED FOR COMMENTS	IN.09.011	OSE/28N	

ورلي پارسونز - الصناعات العربية (محصاة)
WorleyParsons - Arabian Industries (JV)
 CONTRACT NO.: C31/0606 PROJ. NO.: PAIP00405

1. ALL DIMENSIONS ARE IN MILLIMETRES AND ELEVATIONS IN METRES.
2. CONCRETE TO BS 8110, GRADE 35 FOR REINFORCED CONCRETE, GRADE 10 FOR BLINDING CONCRETE USING OPC.
3. 50mm COVER TO REINFORCEMENT, REINFORCEMENT TO BS 4449.
4. ALL EDGES SHALL HAVE A CHAMFER OF APPROX. 25mm.
5. ALL EXPOSED CONCRETE SURFACES SHALL BE TREATED WITH TWO COATS OF "FOSROC DEKGUARD S" WITH A DFT OF 350 MICRONS OR ANY OTHER APPROVED EQUIVALENT.
6. FOUNDATION BOLTS REFER DRG. No. STD-2-3950-001-A3
7. FOR BAR BENDING SCHEDULE REFER DRG. No. NIM-2-5772-038-DQ-4
8. FOUNDATION LOCATION PLAN REFER DRG. No. NIM-2-5166-001-DQ-1

NOTES/REFERENCE DRAWINGS

PROJECT DRAWING REVISION

IN CASE OF DEVIATIONS A MARKED UP PRINT SHALL BE SENT TO THE PROJECT ENGINEER

AREA : NIMR	SCALE : 1:20	CAD DRAWING	
SUB AREA : PRODUCTION STATION	NO. 05	شركة تنمية نفط عُمان Petroleum Development Oman	
DRWG. TYPE : PIPE SUPPORTS-FOUNDATION DETAILS	DESCRIPTION : PS-052 & 055	DRWG	AREA CODE
		ENG SECT	SERIAL NUMBER
		SHEET	PROJ CODE
		DWG SIZE	REV.
		NO	NIM 2 5772 037 DQ 3 A

BAR BENDING SCHEDULE

JOB NO.: PAIP00238
PART ID.: PRODUCTION STATION

Document No.: NIM-2-5772-038-DQ-4

Revision No.: A

Prepared by: GCS

Checked by: PNG *RL*

Date: 27.02.11

REF. DWG NO.: NIM-2-5772-037-DQ-3

Total MTO for Rebars.

Dia. Of Bar	T6	T8	T10	T12	T16	T20	T25	T32
Length of Bar (m)			97.90	26.40				
Weight (Kgs)			60.70	23.50				

Total Weight (Kgs)

84.200

1c. Annexes
-A2

[illegible]


This schedule complies with BS 8666 : 2005

All dimensions are in mm


Refer to Bar shape Code drawing

* Specified in multiples of 5 mm


† Specified in multiples of 25 mm

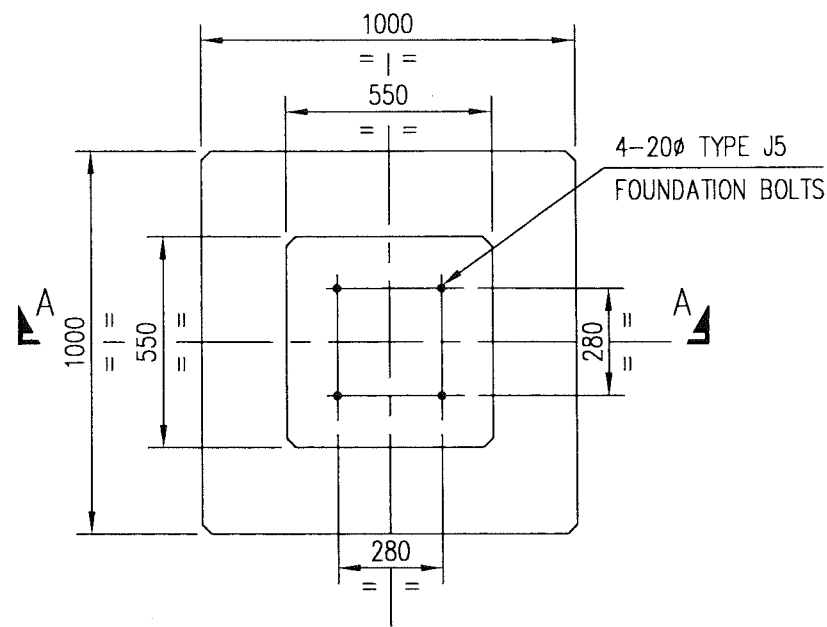


PLAN

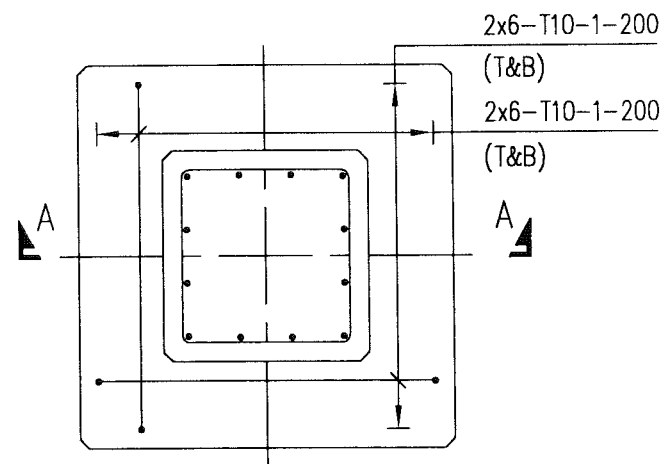

REINFORCEMENT PLAN

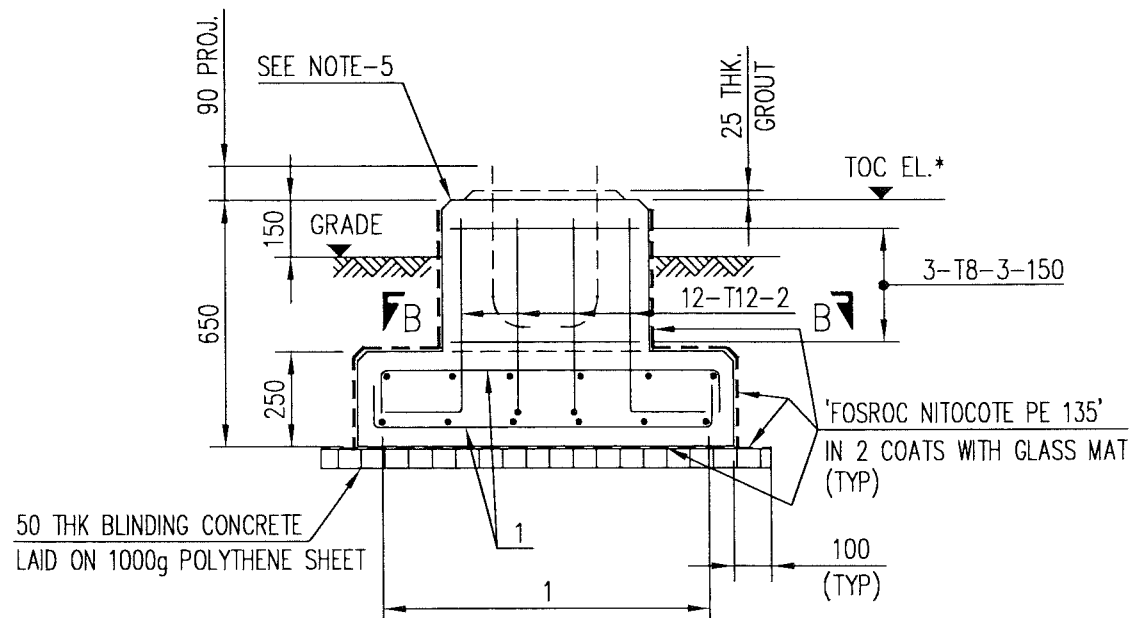

SECTION A - A

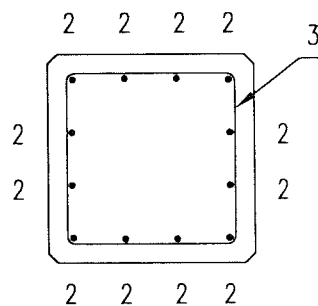

SECTION B - B

FOUNDATION DESIGNATION	REFERENCE DRAWING	NUMBERS REQUIRED	*TOC EL.
PS-053	NIM-2-5166-001-DQ-1	1	98.850
PS-054			99.160
PS-057			99.160
PS-058			
PS-059			
PS-060			
PS-061			
PS-062			
PS-070			

NOTE: * DENOTES, SINCE GRADE ELEVATION VARIES, CONTRACTOR TO VERIFY ELEVATIONS AND DIMENSIONS AT SITE, PRIOR TO FABRICATION/CONSTRUCTION/INSTALLATION.

M T O			
DESCRIPTION	QUANTITY	UNITS	SAP No.
BLINDING CONCRETE GRADE 10	0.65	m ³	N.A.
CONCRETE GRADE 35	3.34	m ³	N.A.
CEMENT SAND GROUT	47.35	lit	N.A.
REINFORCEMENT STEEL	241.68	Kg	N.A.
PROTECTIVE COATING	36.20	m ²	N.A.
20# FOUNDATION BOLT TYPE - J5	36	PCS	N.A.
1000g POLYTHENE SHEET	13.00	m ²	N.A.

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A2

APPROVED FOR
CONSTRUCTION

[THIS DRAWING IS BASED ON P.D.O. DRG. No. STD-2-3903-001-A3-E - TYPE 903]

- ALL DIMENSIONS ARE IN MILLIMETRES AND ELEVATIONS IN METRES.
- CONCRETE TO BS 8110, GRADE 35 FOR REINFORCED CONCRETE, GRADE 10 FOR BLINDING CONCRETE USING OPC.
- 50mm COVER TO REINFORCEMENT, REINFORCEMENT TO BS 4449.
- ALL EDGES SHALL HAVE A CHAMFER OF APPROX. 25mm.
- ALL EXPOSED CONCRETE SURFACES SHALL BE TREATED WITH TWO COATS OF "FOSROC DEKGUARD S" WITH A DFT OF 350 MICRONS OR ANY OTHER APPROVED EQUIVALENT.
- FOUNDATION BOLTS REFER DRG. No. STD-2-3950-001-A3
- FOR BAR BENDING SCHEDULE REFER DRG. No. NIM-2-5772-041-DQ-3

NOTES/REFERENCE DRAWINGS



CONTRACT NO.: C31/0606 PROJ. NO.: PAIP00405

REV	DATE	DRAWN BY	CHECKED	DESCRIPTION	WBS No.	PROJ. ENG.	SIGNATURE
A	27.02.11	GCS	RB	APPROVED FOR CONSTRUCTION	IN.09.011	OSE/28N	
O	26.02.11	GCS	KBR	ISSUED FOR COMMENTS	IN.09.011	OSE/28N	

PROJECT DRAWING REVISION
IN CASE OF DEVIATIONS A MARKED UP PRINT SHALL BE SENT TO THE PROJECT ENGINEER

AREA : NIMR	SCALE : 1:20	CAD DRAWING
SUB AREA : PRODUCTION STATION	NO. 05	
DRWG. TYPE : PIPE SUPPORTS-FOUNDATION DETAILS		
DESCRIPTION : PS-053, 054, 057 TO 062 & 070		
DRWG	AREA CODE	ENG SECT
SERIAL NUMBER	SHEET	PROJ CODE
DWG SIZE	REV.	
NO	NIM 2 5772 040 DQ 3	A

BAR BENDING SCHEDULE

JOB NO.: PAIP00238
PART ID.: PRODUCTION STATION

Document No.: NIM-2-5772-041-DQ-4

Revision No.: A

Prepared by: GCS

Checked by: PNG *RB*

Date: 27.02.11

REF. DWG NO.: NIM-2-5772-040-DQ-3

Total MTO for Rebars.

Dia. Of Bar	T6	T8	T10	T12	T16	T20	T25	T32
Length of Bar (m)		53.33	243.00	78.30				
Weight (Kgs)		21.33	150.66	69.69				

Total Weight (Kgs)

241.680

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TA2

[illegible]




This schedule complies with BS 8666 : 2005

All dimensions are in mm

Refer to Bar shape Code drawing

* Specified in multiples of 5 mm

† Specified in multiples of 25 mm

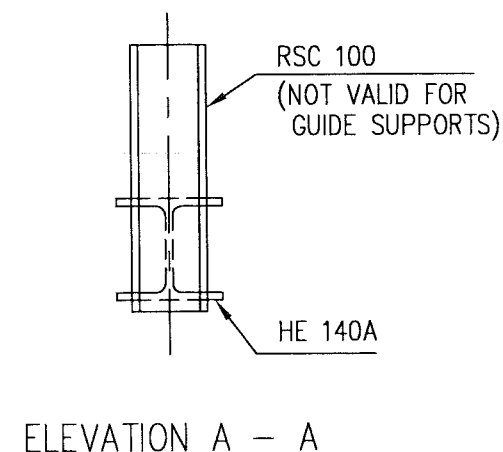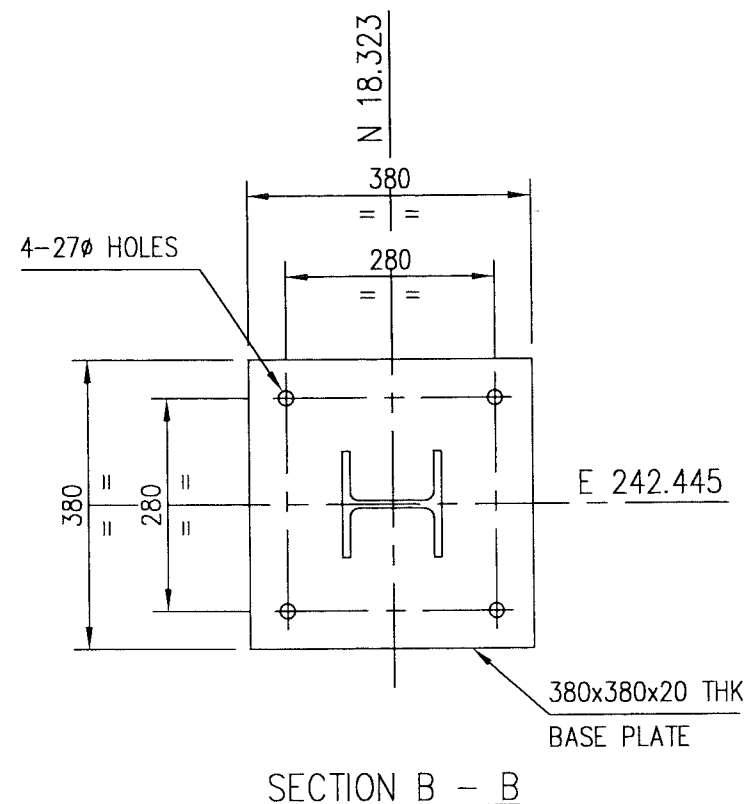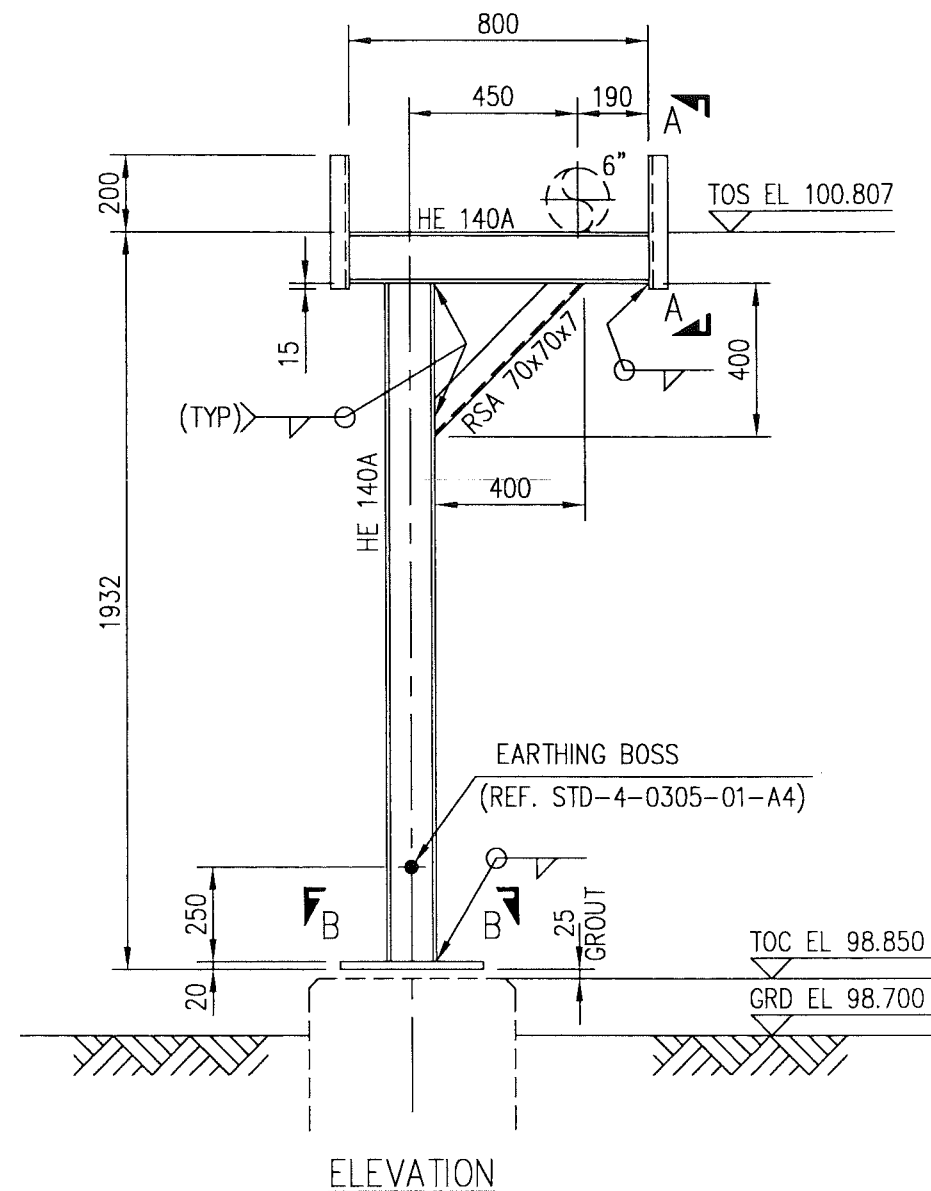

M T O			
DESCRIPTION	QUANTITY	UNITS	SAP No.
HE 140A	2.60	m	1000080438
RSC 100	0.70	m	1000145612
RSA 70x70x7	0.60	m	1000080321
20 THK PLATE	0.14	m ²	1000062610
EARTHING BOSS	1	PCS	N.A.

NOTE: * DENOTES, SINCE GRADE ELEVATION VARIES, CONTRACTOR TO VERIFY ELEVATIONS AND DIMENSIONS AT SITE, PRIOR TO FABRICATION/CONSTRUCTION/INSTALLATION.

10.11.2011
TA2

APPROVED FOR
CONSTRUCTION

REV	DATE	DRAWN BY	TEAM L.	J. ENG.	CHECKED	DESCRIPTION	WBS No.	PROJ. ENG.	SIGNATURE
A	27.02.11	GCS	RB	Y		APPROVED FOR CONSTRUCTION	IN.09.011	OSE/28N	
O	26.02.11	GCS	KBR	GSB		ISSUED FOR COMMENTS	IN.09.011	OSE/28N	


 ورلي بارسونز - الصناعات العربية (محاصة)
WorleyParsons - Arabian Industries (JV)
 CONTRACT NO.: C31/0606 PROJ. NO.: PAIP00405

- ALL DIMENSIONS ARE IN MILLIMETRES.
- ALL ELEVATIONS & CO-ORDINATES ARE IN METRES.
- ALL STEEL WORK TO BS EN 10025 GRADE S275 JR
- PIPE SECTION TO API 5L GR B.
- ALL CONNECTIONS TO BE MADE USING 5mm CFW.
- ALL STEEL WORK TO RECEIVE CORROSION PROTECTION IN ACCORDANCE WITH DOCUMENT No. SP-1246-2

FOUNDATION DETAILS	NIM	2	5772	037	DQ	3
DESCRIPTION	AREA	S	SERIAL	SH.	P	S
DRAWING NUMBER						

NOTES


REFERENCE DRAWINGS

PROJECT DRAWING REVISION
IN CASE OF DEVIATIONS A MARKED UP PRINT SHALL BE SENT TO THE PROJECT ENGINEER


AREA	: NIMR	SCALE : 1:20	CAD DRAWING
SUB AREA	: PRODUCTION STATION	NO. 05	
DRWG. TYPE	: PIPE SUPPORTS		
DESCRIPTION	: PS-055		
DRWG.	AREA CODE	ENG SECT	SERIAL NUMBER
NO	NIM	2	5772 042 DQ
			3 A

BAR BENDING SCHEDULE


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ELEVATION

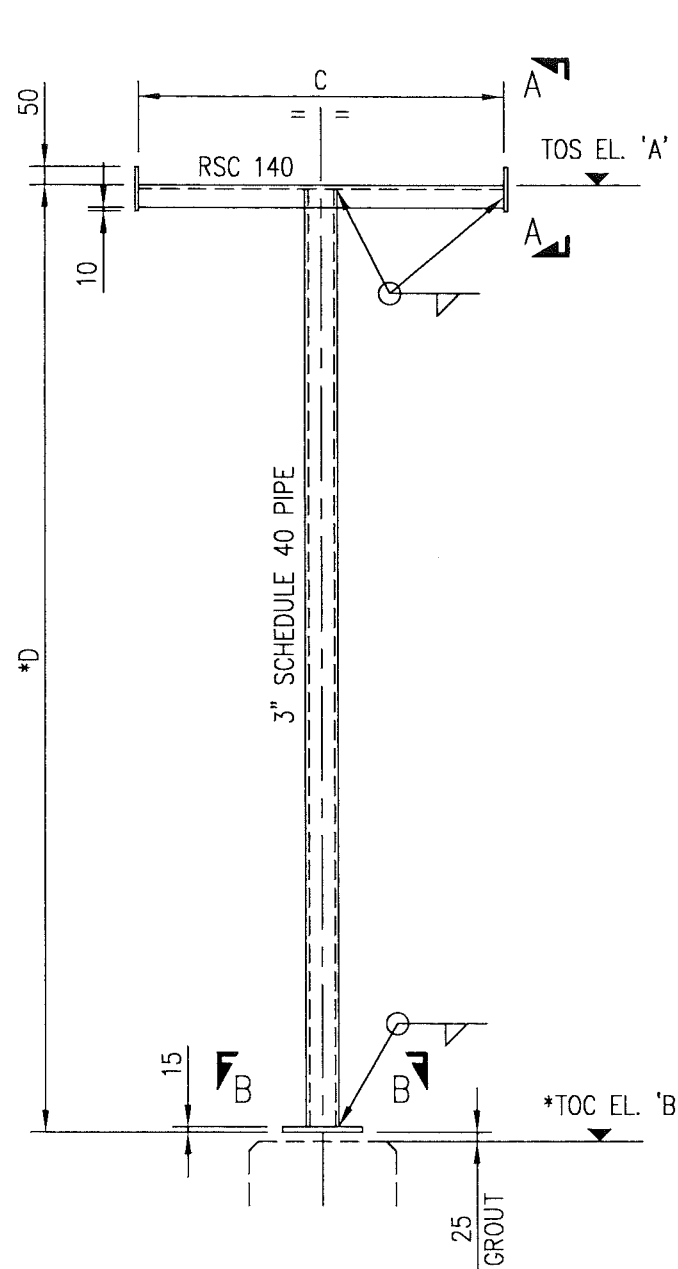

ELEVATION A - A

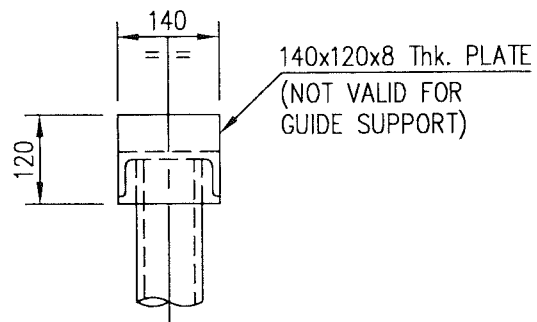

SECTION B - B

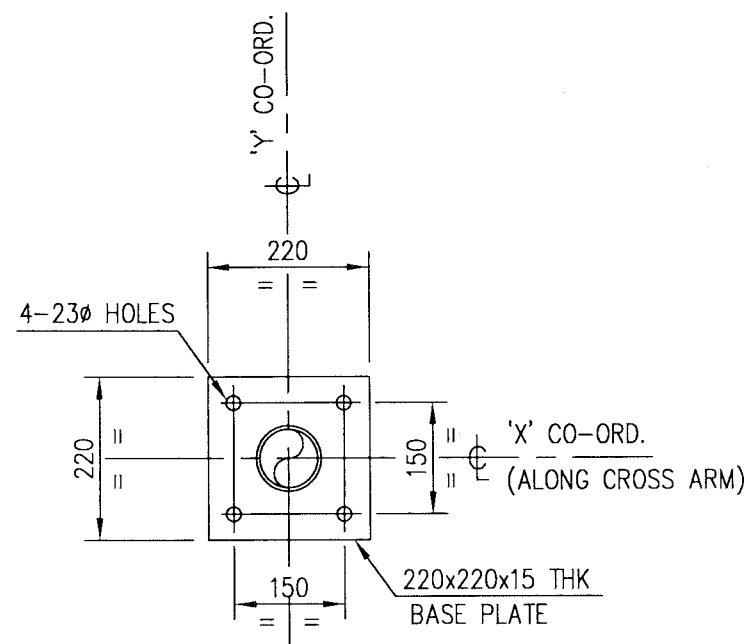SUPPORT NUMBER	REFERENCE DRAWING	ELEVATIONS		DIMENSIONS		PIPE GUIDE	Nos. REQD.	CO-ORDINATES	
		A	* B	C	* D			X	Y
PS-076	NIM-2-5166-001-DQ-1	99.050	98.695	380	330	-	1	E 255.000	N 5.750
PS-077			98.695			-		E 259.700	
PS-078			98.695			-		E 265.100	
PS-079			98.695			-		E 269.750	
PS-080			98.545		480	-		E 276.000	
PS-081			98.545			-		E 282.000	
PS-082			98.545			-		E 289.000	
PS-083			98.545			-		E 296.000	
PS-084			98.395		630	-		E 303.000	
PS-085			98.395		630	-		E 310.000	

NOTE: * DENOTES, SINCE GRADE ELEVATION VARIES, CONTRACTOR TO VERIFY ELEVATIONS AND DIMENSIONS AT SITE, PRIOR TO FABRICATION/CONSTRUCTION/INSTALLATION.

M T O			
DESCRIPTION	QUANTITY	UNITS	SAP No.
3" SCHEDULE 40 PIPE	4.40	m	1000051540
RSC 140	4.00	m	1000080366
15 THK PLATE	0.50	m ²	1000080265
8 THK PLATE	0.35	m ²	1000062607

(Signature)
TA2

APPROVED FOR
CONSTRUCTION

[THIS DRAWING IS BASED ON P.D.O. DRG. No.
STD-2-3102-001-A3-C - TYPE 102]



CONTRACT NO.: C31/0606 PROJ. NO.: PAIP00405

- ALL DIMENSIONS ARE IN MILLIMETRES.
- ALL ELEVATIONS & CO-ORDINATES ARE IN METRES.
- ALL STEEL WORK TO BS EN 10025 GRADE S275 JR
- PIPE SECTION TO API 5L GR B.
- ALL CONNECTIONS TO BE MADE USING 5mm CFW.
- ALL STEEL WORK TO RECEIVE CORROSION PROTECTION IN ACCORDANCE WITH DOCUMENT No. SP-1246-2

NOTES


FOUNDATION DETAILS		NIM	2	5772	049	DQ	3
DESCRIPTION		AREA	S	SERIAL	SH.	P	S
DRAWING NUMBER							

REFERENCE DRAWINGS


REV	DATE	DRAWN BY	TEAM L.	J. ENG.	CHECKED	DESCRIPTION	WBS No.	PROJ. ENG.	SIGNATURE
A	27.02.11	GCS	RB	JS		APPROVED FOR CONSTRUCTION	IN.09.011	OSE/28N	
O	26.02.11	GCS	KBR	GSB		ISSUED FOR COMMENTS	IN.09.011	OSE/28N	

PROJECT DRAWING REVISION
IN CASE OF DEVIATIONS A MARKED UP PRINT SHALL BE SENT TO THE PROJECT ENGINEER


AREA	: NIMR		SCALE : 1:20	CAD DRAWING		
SUB AREA	: PRODUCTION STATION		No. 05	شركة تنمية نفط عُمان		
DRWG. TYPE	: PIPE SUPPORTS			Petroleum Development Oman		
DESCRIPTION	: PS-076 TO PS-085			DRWG	AREA CODE	ENG SECT
				SERIAL NUMBER	SHEET	PROJ CODE
				DWG SIZE	REV.	
NO	NIM 2 5772 048 DQ 3 A					

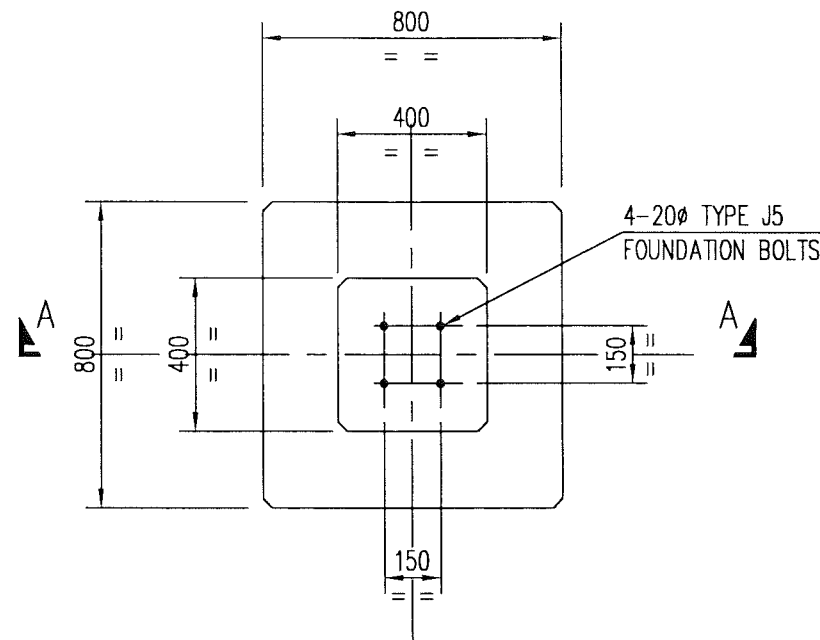


PLAN
(11 Nos. REQ'D)

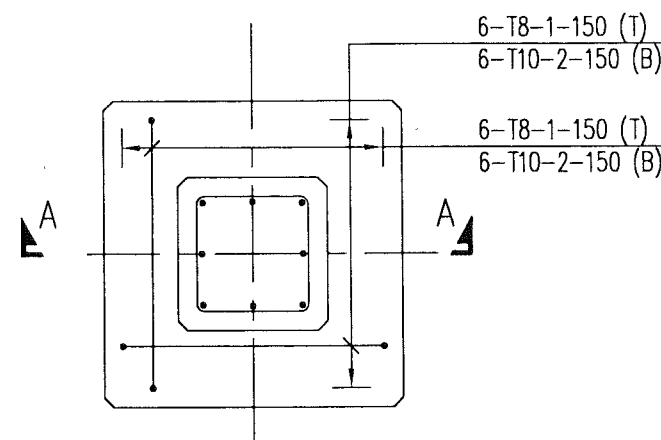

REINFORCEMENT PLAN

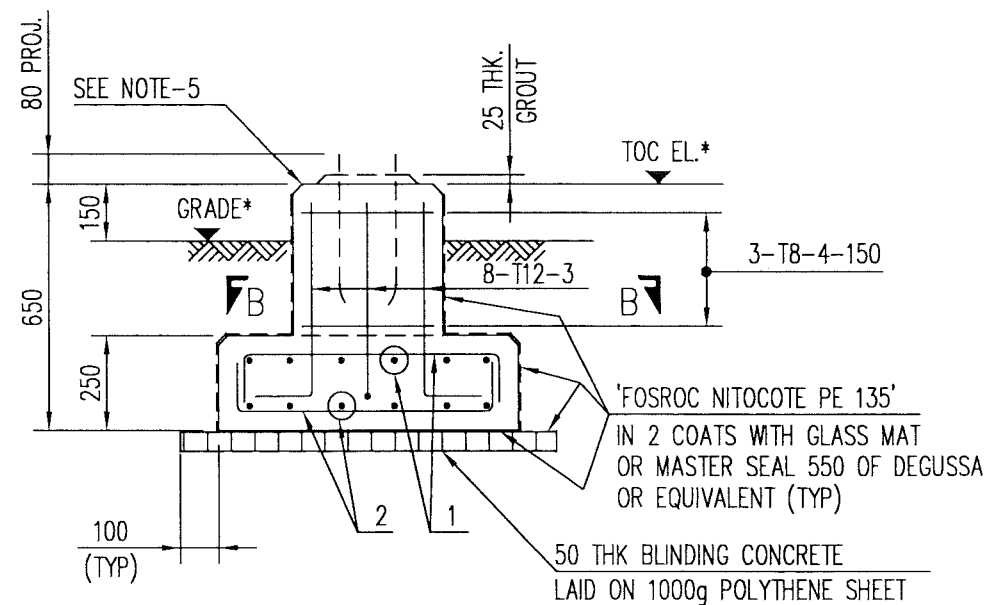

SECTION A - A

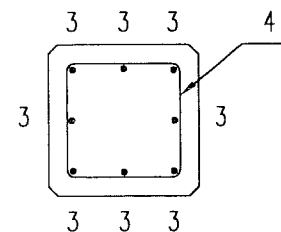

SECTION B - B

FOUNDATION DESIGNATION	REFERENCE DRAWING	NUMBERS REQUIRED	* TOC EL.
PS-076	NIM-2-5166-001-DQ-1	1	98.695
PS-077			98.695
PS-078			98.695
PS-079			98.695
PS-080			98.545
PS-081			98.545
PS-082			98.545
PS-083			98.545
PS-084			98.395
PS-085			98.395
PS-087	NIM-2-5167-001-DQ-1		98.375

NOTE: * DENOTES, SINCE GRADE ELEVATION VARIES, CONTRACTOR TO VERIFY ELEVATIONS AND DIMENSIONS AT SITE, PRIOR TO FABRICATION/CONSTRUCTION/INSTALLATION.

M T O			
DESCRIPTION	QUANTITY	UNITS	SAP No.
BLINDING CONCRETE GRADE 10	0.55	m ³	N.A.
CONCRETE GRADE 35	2.50	m ³	N.A.
CEMENT SAND GROUT	29.30	lit	N.A.
REINFORCEMENT STEEL	199.49	Kg	N.A.
PROTECTIVE COATING	32.12	m ²	N.A.
20φ FOUNDATION BOLT TYPE - J5	44	PCS	N.A.
1000g POLYTHENE SHEET	11.00	m ²	N.A.

10. Annex
A2

APPROVED FOR
CONSTRUCTION

[THIS DRAWING IS BASED ON P.D.O. DRG. No.
STD-2-3901-001-A3-D - TYPE 901]


 ورلي بارسونز - الصناعات العربية (مخاصة)
WorleyParsons - Arabian Industries (JV)
 CONTRACT NO.: C31/0606 PROJ. NO.: PAIP00405

- ALL DIMENSIONS ARE IN MILLIMETRES AND ELEVATIONS IN METRES.
- CONCRETE TO BS 8110, GRADE 35 FOR REINFORCED CONCRETE, GRADE 10 FOR BLINDING CONCRETE USING OPC.
- 50mm COVER TO REINFORCEMENT, REINFORCEMENT TO BS 4449.
- ALL EDGES SHALL HAVE A CHAMFER OF APPROX. 25mm.
- ALL EXPOSED CONCRETE SURFACES SHALL BE TREATED WITH TWO COATS OF "FOSROC DEKGUARD S" WITH A DFT OF 350 MICRONS OR ANY OTHER APPROVED EQUIVALENT.
- FOUNDATION BOLTS REFER DRG. No. STD-2-3950-001-A3
- FOR BAR BENDING SCHEDULE REFER DRG. No. NIM-2-5772-050-DQ-4

NOTES/REFERENCE DRAWINGS

REV	DATE	DRAWN BY	TEAM L.	J. ENG.	CHECKED	DESCRIPTION	WBS No.	PROJ. ENG.	SIGNATURE
A	27.02.11	GCS	RB	Y		APPROVED FOR CONSTRUCTION	IN.09.011	OSE/28N	
O	26.02.11	GCS	KBR	GSB		ISSUED FOR COMMENTS	IN.09.011	OSE/28N	

PROJECT DRAWING REVISION
IN CASE OF DEVIATIONS A MARKED UP PRINT SHALL BE SENT TO THE PROJECT ENGINEER

AREA : NIMR	SCALE : 1:20	CAD DRAWING
SUB AREA : PRODUCTION STATION	No. 05	
DRWG. TYPE : PIPE SUPPORTS-FOUNDATION DETAILS		
DESCRIPTION : PS-076 TO 085 & 087		
DRWG	AREA CODE	ENG SECT
SERIAL NUMBER	SHEET	PROJ CODE
DWG SIZE	REV.	
NO	NIM 2 5772 049 DQ	3 A

BAR BENDING SCHEDULE

JOB NO.: PAIP00238
PART ID.: PRODUCTION STATION

Document No.: NIM-2-5772-050-DQ-4
Revision No.: A
Prepared by: GCS
Checked by: PNG *[Signature]*
Date: 27.02.11

REF. DWG NO.: NIM-2-5772-049-DQ-3

Total MTO for Rebars.

Dia. Of Bar	T6	T8	T10	T12	T16	T20	T25	T32
Length of Bar (m)		167.48	122.10	63.80				
Weight (Kgs)		66.99	75.71	56.79				

Total Weight (Kgs)

199,490

[illegible]

10. Number
TA2

This schedule complies with BS 8666 : 2005

All dimensions are in mm


Refer to Bar shape Code drawing

* Specified in multiples of 5 mm


† Specified in multiples of 25 mm

M T O			
DESCRIPTION	QUANTITY	UNITS	SAP No.
3" SCHEDULE 40 PIPE	0.25	m	1000051540
RSC 140	0.70	m	1000080366
15 THK PLATE	0.05	m ²	1000080265
8 THK PLATE	0.10	m ²	1000062607


NOTE: * DENOTES, SINCE GRADE ELEVATION VARIES, CONTRACTOR TO VERIFY ELEVATIONS AND DIMENSIONS AT SITE, PRIOR TO FABRICATION/CONSTRUCTION/INSTALLATION.

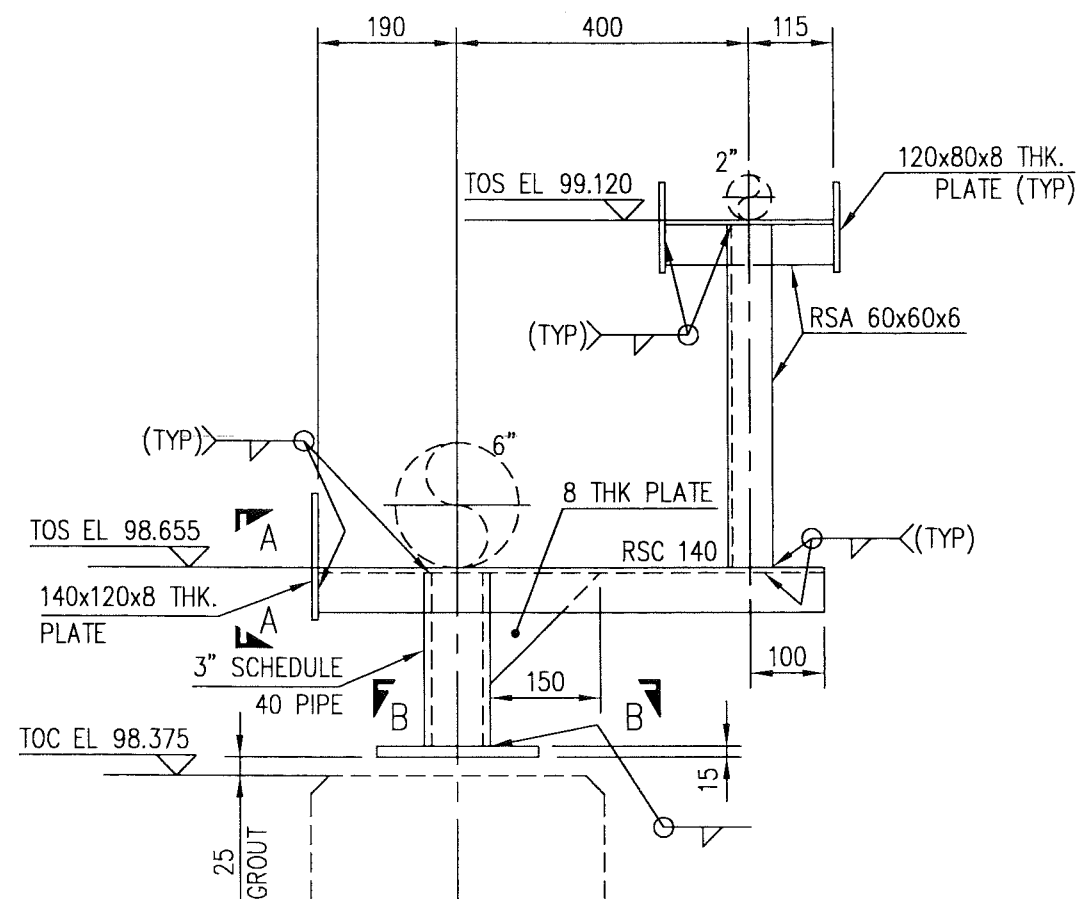

ELEVATION

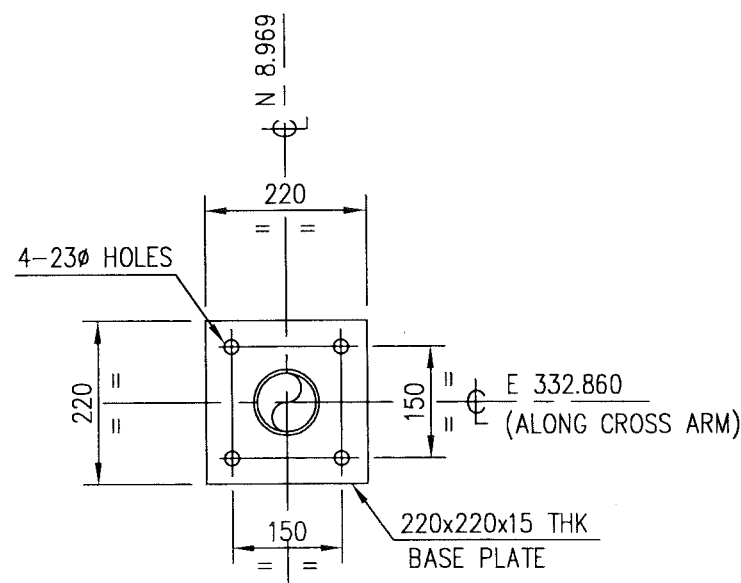

SECTION B-B

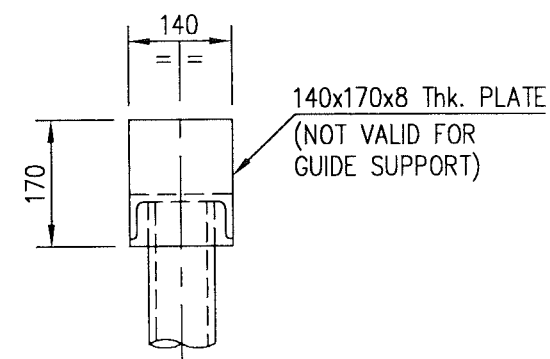

ELEVATION A-A

APPROVED FOR
CONSTRUCTION



CONTRACT NO.: C31/0606 PROJ. NO.: PAIP00405

- ALL DIMENSIONS ARE IN MILLIMETRES.
- ALL ELEVATIONS & CO-ORDINATES ARE IN METRES.
- ALL STEEL WORK TO BS EN 10025 GRADE S275 JR
- PIPE SECTION TO API 5L GR B.
- ALL CONNECTIONS TO BE MADE USING 5mm CFW.
- ALL STEEL WORK TO RECEIVE CORROSION PROTECTION IN ACCORDANCE WITH DOCUMENT No. SP-1246-2

NOTES

FOUNDATION DETAILS

NIM 2 5772 049 DQ 3

DESCRIPTION

DRAWING NUMBER

REFERENCE DRAWINGS

REV	DATE	DRAWN BY	TEAML	J.ENG.	CHECKED	DESCRIPTION	WBS No.	PROJ. ENG.	SIGNATURE
A	27.02.11	GCS	RE	J.		APPROVED FOR CONSTRUCTION	IN.09.011	OSE/28N	
O	26.02.11	GCS	KBR	GSB		ISSUED FOR COMMENTS	IN.09.011	OSE/28N	

PROJECT DRAWING REVISION
IN CASE OF DEVIATIONS A MARKED UP PRINT SHALL BE SENT TO THE PROJECT ENGINEER

AREA : NIMR

SUB AREA : NIMR SLUDGE PIT SYSTEMS NO. 16

DRWG. TYPE : PIPE SUPPORTS

DESCRIPTION : PS-087

SCALE : 1:10 CAD DRAWING

شركة تنمية نفط عُمان
Petrochem Development Oman

DRWG AREA ENG SERIAL SHEET PROJ DWG REV.

NO NIM 2 5772 051 DQ 3 A



PLAN

NOTE: ✕ DENOTES, SINCE GRADE ELEVATION VARIES, CONTRACTOR TO VERIFY ELEVATIONS AND DIMENSIONS AT SITE, PRIOR TO FABRICATION/CONSTRUCTION/INSTALLATION.

k. Munnies
7A2

APPROVED FOR
CONSTRUCTION

A	27.02.11	GCS	RB	✓	APPROVED FOR CONSTRUCTION	IN.09.011	OSE /28N		
O	26.02.11	GCS	KBR	GSB	ISSUED FOR COMMENTS	IN.09.011	OSE /28N		
J9	REV	DATE	DRAWN BY	TEAM L.	J.ENG.	DESCRIPTION	WBS No.	PROJ. ENG.	SIGNATURE
				CHECKED				P D O APPROVAL	

[illegible]


IN CASE OF DEVIATIONS A MARKED UP PRINT SHALL BE SENT TO THE PROJECT ENGINEER

1. ALL DIMENSIONS ARE IN MILLIMETRES.
2. ALL ELEVATIONS & CO-ORDINATES ARE IN METRES.
3. ALL STEEL WORK TO BS EN 10025 GRADE S275 JR
4. PIPE SECTION TO API 5L GR B.
5. ALL CONNECTIONS TO BE MADE USING 5mm CFW.
6. ALL STEEL WORK TO RECEIVE CORROSION PROTECTION
IN ACCORDANCE WITH DOCUMENT No. SP-1246-2

'U' BOLT (PIPE NOT GRIPPED) DETAILS	NIM	2	5772	052	DQ	3
DESCRIPTION	AREA	S	SERIAL	SH.	P	S
	DRAWING NUMBER					

NOTES

REFERENCE DRAWINGS

3	AREA : NIMR		SCALE : 1:20		CAD DRAWING																	
			0 1 2 3 4 5 6 7																			
	SUB AREA : PRODUCTION STATION		NO. 05		 شركة تنمية نفط عُمان Petroleum Development Oman																	
S	DRWG. TYPE : PIPE SUPPORTS				<table><tr><th>DRWG</th><th>AREA CODE</th><th>ENG SECT</th><th>SERIAL NUMBER</th><th>SHEET</th><th>PROJ CODE</th><th>DRWG SIZE</th><th>REV.</th></tr><tr><td>NO</td><td>NIM</td><td>2</td><td>5772</td><td>052</td><td>DQ</td><td>3</td><td>A</td></tr></table>		DRWG	AREA CODE	ENG SECT	SERIAL NUMBER	SHEET	PROJ CODE	DRWG SIZE	REV.	NO	NIM	2	5772	052	DQ	3	A
DRWG	AREA CODE	ENG SECT	SERIAL NUMBER	SHEET	PROJ CODE	DRWG SIZE	REV.															
NO	NIM	2	5772	052	DQ	3	A															
	DESCRIPTION : PS-086																					




NOTES/REFERENCE DRAWINGS

NOTE: * DENOTES, SINCE GRADE ELEVATION VARIES, CONTRACTOR TO VERIFY ELEVATIONS AND DIMENSIONS AT SITE, PRIOR TO FABRICATION/CONSTRUCTION/INSTALLATION.

APPROVED FOR
CONSTRUCTION

PROJECT DRAWING REVISION

AREA : NIMR		SCALE : 1:20		SHEET DRAWING						
SUB AREA : PRODUCTION STATION		No. 05		 شركة تنمية نفط عُمان Petroleum Development Oman						
DRWG.TYPE : PIPE SUPPORTS-SLEEPER DETAILSS		DRWG		AREA CODE	ENG SECT	SERIAL NUMBER	SHEET	PROJ CODE	DWG SIZE	REV
DESCRIPTION : SL-002 TO SL-010		NO		NIM 2 5772 053 DQ			3	A		



BAR BENDING SCHEDULE

JOB NO.: PAIP00238
PART ID.: PRODUCTION STATION

Document No.: NIM-2-5772-054-DQ-4

Revision No.: A

Prepared by: GCS

Checked by: PNG

Date: 27.02.11

REF. DWG NO.: NIM-2-5772-053-DQ-3

Total MTO for Rebars.

Dia. Of Bar	T6	T8	T10	T12	T16	T20	T25	T32
Length of Bar (m)			177.95					
Weight (Kgs)			110.33					

Total Weight (Kgs)

110.330

K. Munn
TA2

[illegible]


This schedule complies with BS 8666 : 2005

All dimensions are in mm

Refer to Bar shape Code drawing

* Specified in multiples of 5 mm

† Specified in multiples of 25 mm

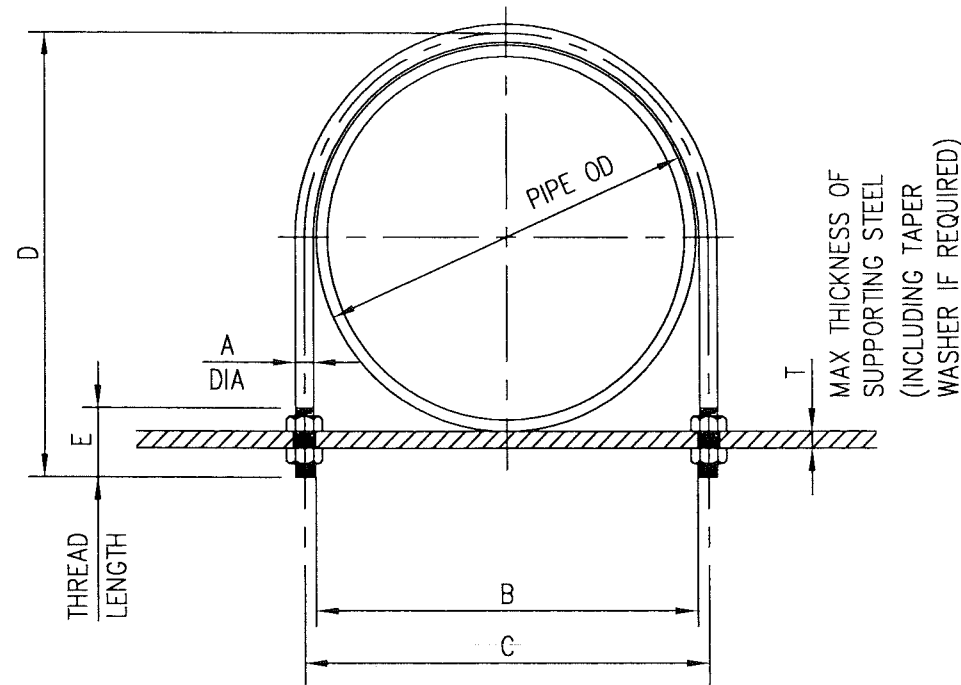

ELEVATION


MATERIAL GUIDE

BAR		NUTS	
SIZE	SAP No.	SIZE	SAP No.
8	1000080335	M8	1000063795
10	1000062586	M10	1000063796
16	1000062588	M16	1000063798
20	N.A.	M20	1000063799
24	N.A.	M24	1000120055

[THIS DRAWING IS BASED ON P.D.O. DRG. No. STD-2-3818-001-A3-C - TYPE 818]

- ALL DIMENSIONS ARE IN MILLIMETRES.
- EACH BOLT TO BE SUPPLIED WITH 2 NUTS & 2 LOCKNUTS.
- MATERIAL-BOLTS TO BS EN 10025 GR S275 JR NUTS TO ISO 898/11 GR 8
- U-BOLT CORROSION PROTECTION SHALL COMPLY WITH SP-1246-2

NOTES

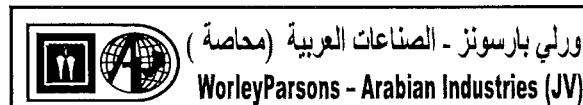

CONTRACT NO.: C31/0606 PROJ. NO.: PAIP00405

DESCRIPTION

DRAWING NUMBER

REFERENCE DRAWINGS

PIPE GUIDE DESIGNATION	NOMINAL PIPE SIZE		PIPE OD	DIMENSIONS						Nos. REQD.
	INCHES	MM		A	B	C	D	E	T	
UB-0.5	1/2"	15	21.3	8	32	40	45	30	10	-
UB-0.75	3/4"	20	26.7	8	37	45	55	35	10	1
UB-1	1"	25	33.4	8	42	50	60	35	10	-
UB-1.5	1 1/2"	40	48.3	10	55	65	85	45	16	-
UB-2	2"	50	60.3	10	70	80	100	45	16	3
UB-3	3"	80	88.9	16	94	110	140	60	19	-
UB-4	4"	100	114.3	16	124	140	165	60	19	-
UB-6	6"	150	168.3	20	175	195	225	70	19	-
UB-8	8"	200	219.1	20	230	250	275	70	19	-
UB-10	10"	250	273.0	20	285	305	335	75	22	-
UB-12	12"	300	323.9	20	335	355	385	75	22	-
UB-14	14"	350	355.6	24	366	390	425	80	22	-
UB-16	16"	400	406.4	24	416	440	475	80	22	-
UB-18	18"	450	457.0	24	471	495	525	80	22	-
UB-20	20"	500	508.0	24	521	545	575	80	22	-
UB-24	24"	600	610.0	24	621	645	675	80	22	-
UB-28	28"	700	711.2	24	721	745	775	80	22	-
UB-30	30"	750	762.0	24	771	795	825	80	22	-

lc. Amman
TA2






APPROVED FOR
CONSTRUCTION

REV	DATE	DRAWN BY	TEAML	J.ENG.	CHECKED	DESCRIPTION	WBS No.	PROJ. ENG.	SIGNATURE
A	27.02.11	GCS	RR	✓		APPROVED FOR CONSTRUCTION	IN.09.011	OSE/28N	
O	26.02.11	GCS	KBR	GSB		ISSUED FOR COMMENTS	IN.09.011	OSE/28N	

PROJECT DRAWING REVISION
IN CASE OF DEVIATIONS A MARKED UP PRINT SHALL BE SENT TO THE PROJECT ENGINEER

AREA	: NIMR	SCALE	: 0 1 2 3 4 5 6 7	CAD DRAWING
SUB AREA	: PRODUCTION STATION	No.	05	
DRWG. TYPE	: PIPE SUPPORTS			
DESCRIPTION	: 'U' BOLT (PIPE NOT GRIPPED) DETAILS			
DRWG	AREA CODE	ENG SECT	SERIAL NUMBER	SHEET
NO	NIM	2	5772	055
				DQ
				3
				A

PLANT NORTH

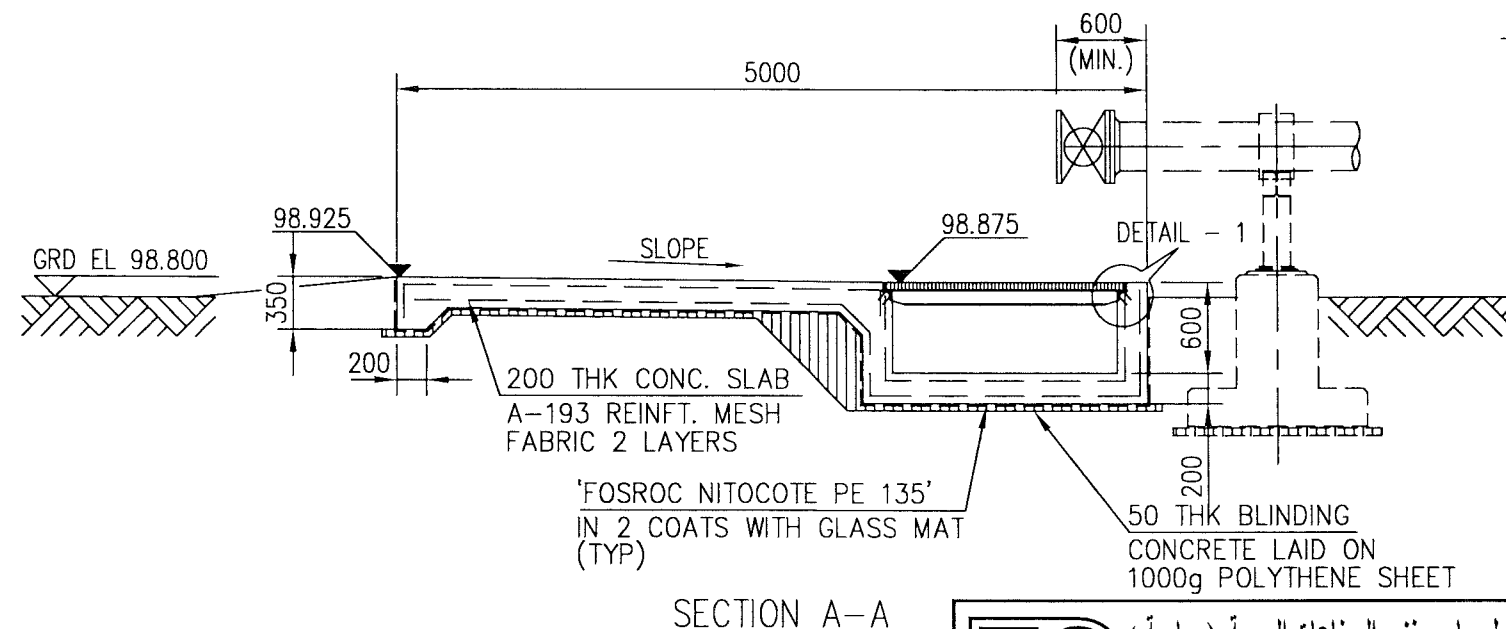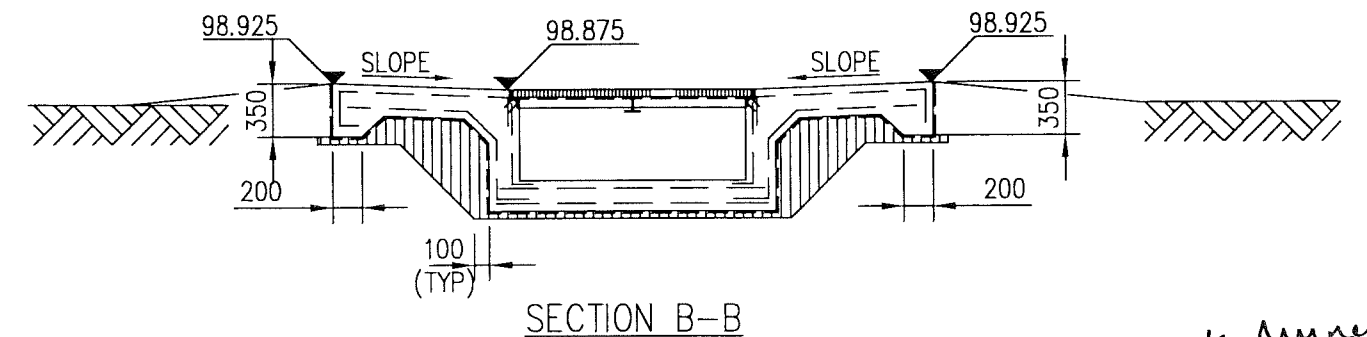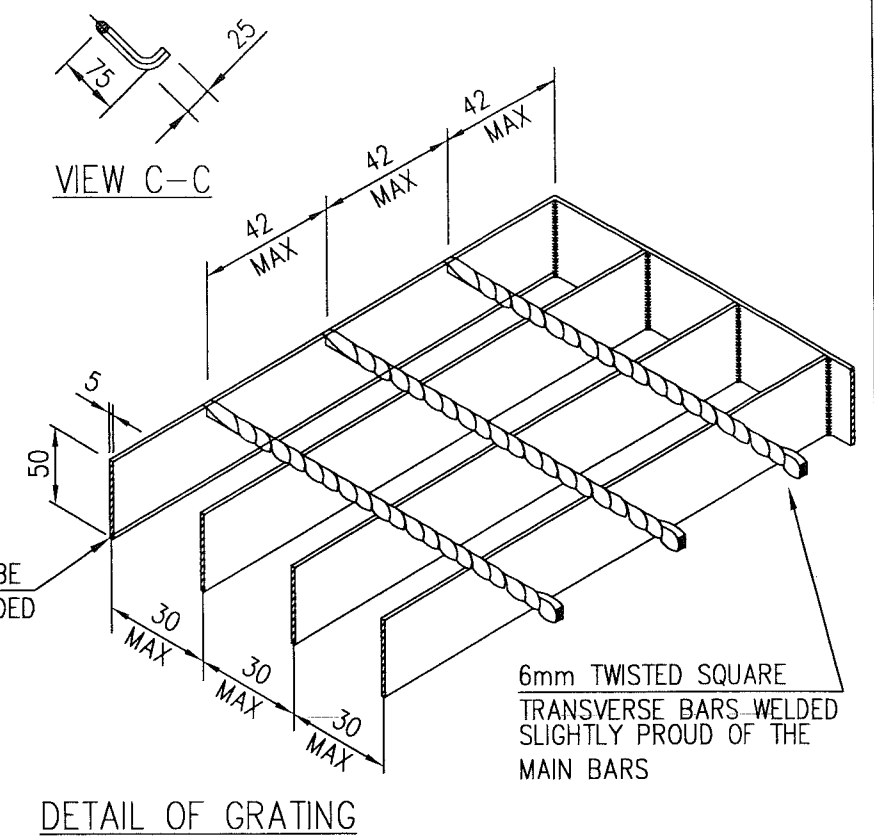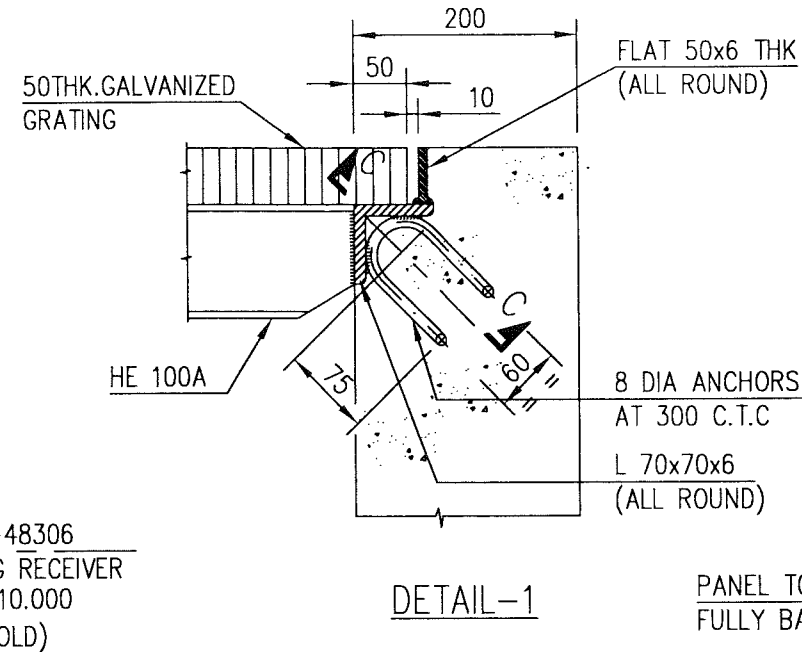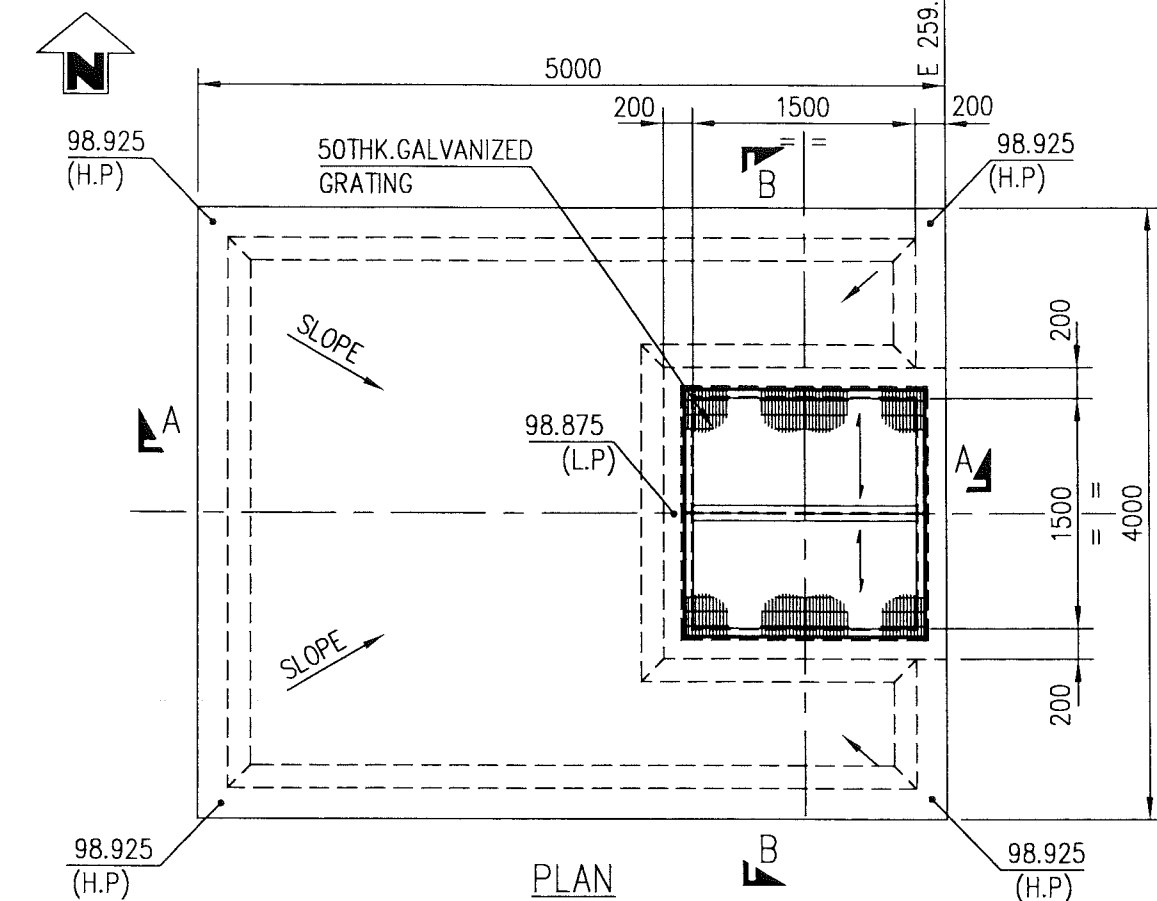

APPROVED FOR CONSTRUCTION

REV	DATE	DRAWN BY	CHECKED	DESCRIPTION	WBS No.	PROJ. ENG.	SIGNATURE
A	27.02.11	GCS	RB	APPROVED FOR CONSTRUCTION	IN.09.011	OSE/28N	
O	26.02.11	JRP	KBR	ISSUED FOR COMMENTS	IN.09.011	OSE/28N	

ورلي بارسونز - الصناعات العربية (محاصة)
WorleyParsons - Arabian Industries (JV)

CONTRACT NO.: C31/0606 PROJ. NO.: PAIP00405

4. FOUNDATION LOCATION PLAN	REF. DRG. NO. NIM-2-5604-001-DQ-1
3. GEN. NOTES, LEG. & ABBREVIATION (STEEL)	REF. DRG. No. NIM-2-5771-002-DQ-3
2. GEN. NOTES, LEGEND & ABBRE. (CONC)	REF. DRG. No. NIM-2-5771-001-DQ-3
1. ALL CO-ORDINATES, ELEVATION ARE IN METERS AND ALL DIMENSIONS ARE IN mm.	


REV	DATE	APPROVED BY	DESCRIPTION	WBS NO.	PROJ. ENG.	SPEC. ENG.

PROJECT DRAWING REVISION						
IN CASE OF DEVIATIONS A MARKED UP PRINT SHALL BE SENT TO THE PROJECT ENGINEER						
AREA	: NIMR					
SUB AREA	: NIMR SLUDGE PIT SYSTEM UPGRADE No. 16					
DRWG. TYPE	: CIVIL DETAILS					
DESCRIPTION	: SPILL PIT AND HARD STRAND FOR 8" PIG RECEIVER					


SCALE : 1:50 CAD DRAWING						
شركة تنمية نفط عُمان Petroleum Development Oman						
DRWG	AREA CODE	ENG SECT	SERIAL NUMBER	SHEET	PROJ CODE	REV.
NO	NIM	2	5773	001	DQ	3 A

M.T.O.


DESCRIPTION	QUANTITY	UNITS	SAP No.
BINDING CONCRETE	0.46	m ³	N.A.
CONCRETE GRADE 25	4.60	m ³	N.A.
PROTECTIVE COATING	28.35	m ²	N.A.
R20 REINF BAR	7.80	m	1000076442
8 THK PLATE	0.11	m ²	1000062607
4" PIPE SCHEDULE 80	3.35	m	1000051546
2" PIPE SCHEDULE 80	1.00	m	1000051538
4" 90° ELBOW PIPE SCHEDULE 80	3	m	1000051546
RSA 60x60x6	9.50	m	1000080320
FLAT 25x6	9.50	m	1000062571
R8 REINF BAR	8.00	m	1000133574
10 DIA BAR	5.40	m	1000062586
REINFORCEMENT STEEL	220.61	kg	N.A.
POLYTHENE SHEET 1000g	9.20	m ²	N.A.
RSA 80x80x8	4.50	m	1000062630
FLAT 40x6	4.05	m	1000080324
6 THK CHECKERED PLATE	5.45	m ²	N.A.

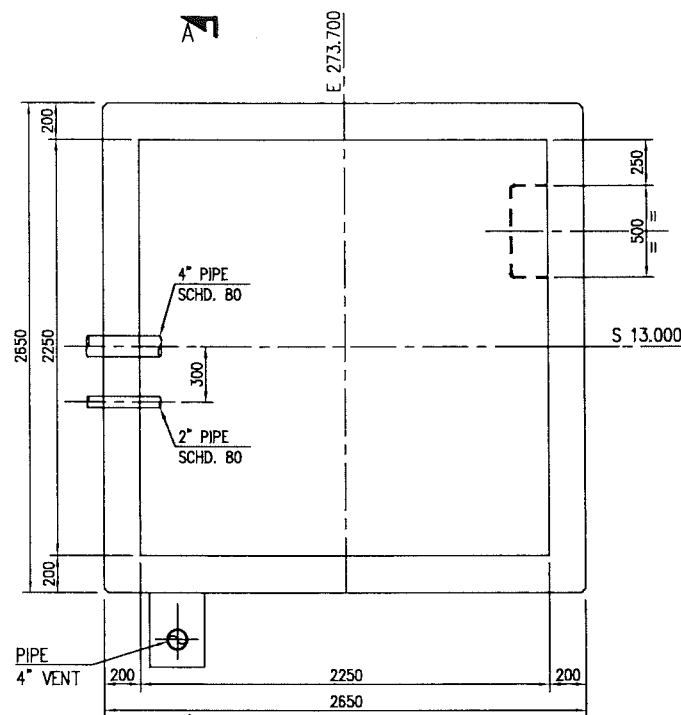



TOP PLAN

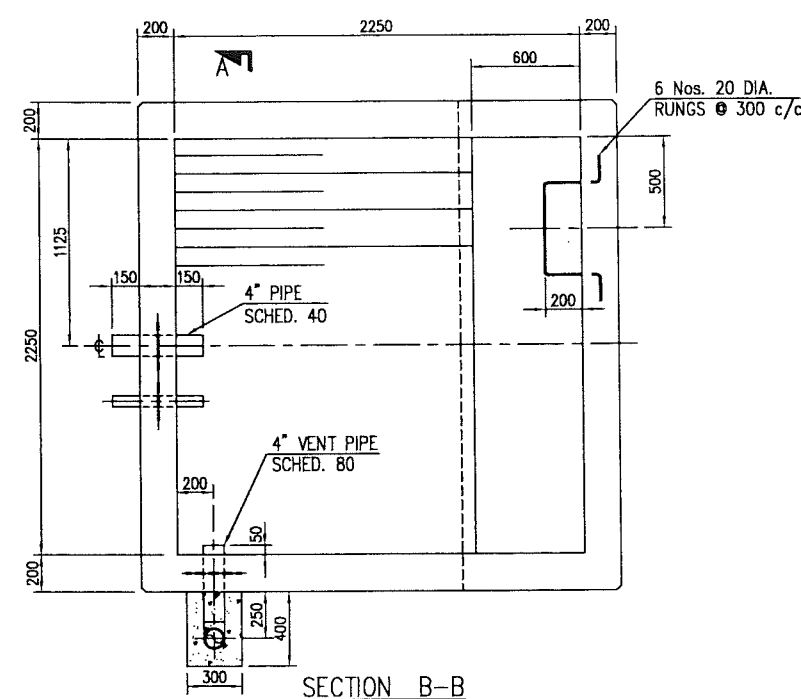


SECTION B-B

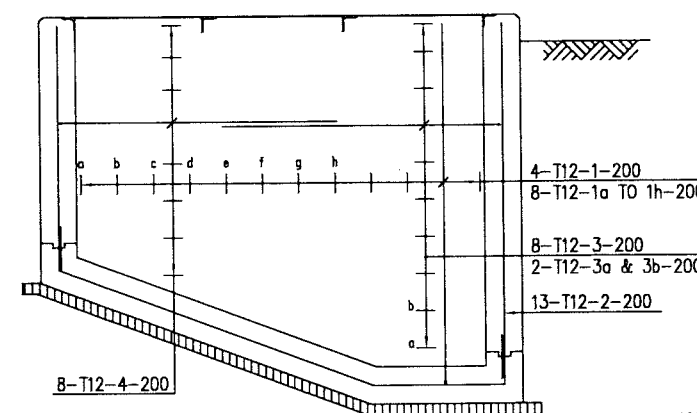



SECTION C-C

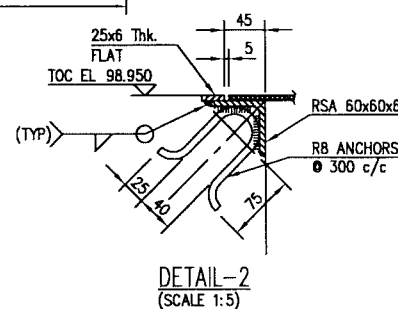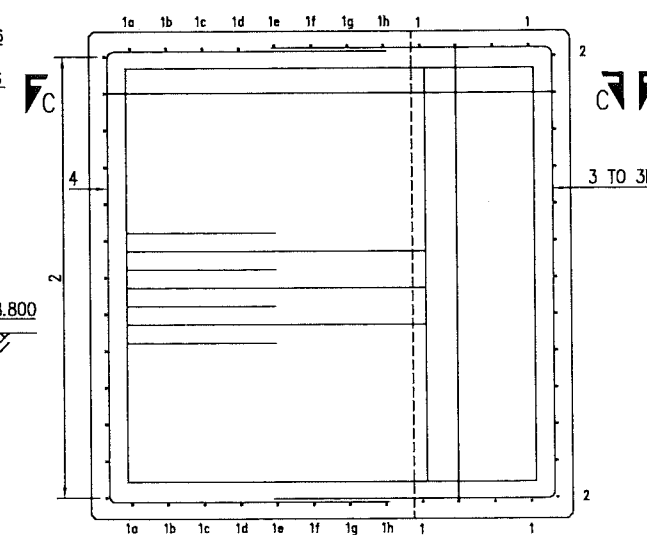DETAIL-2
(SCALE 1:5)


REINF'T BOT. PLAN

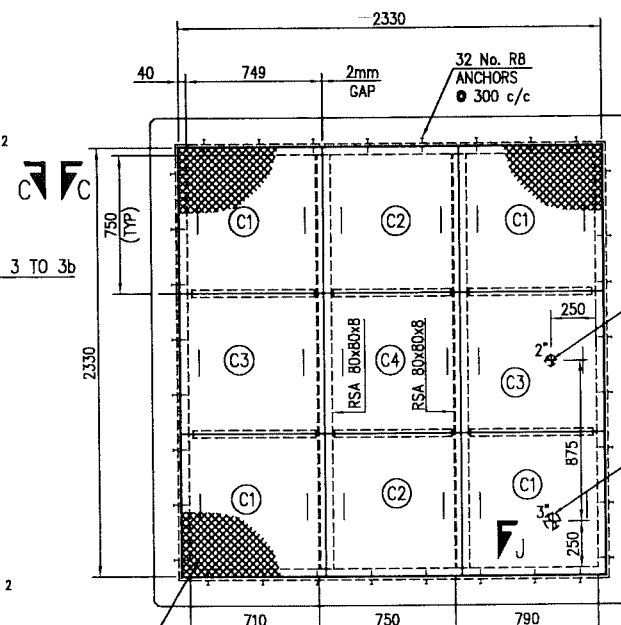

REINF'T TOP PLAN

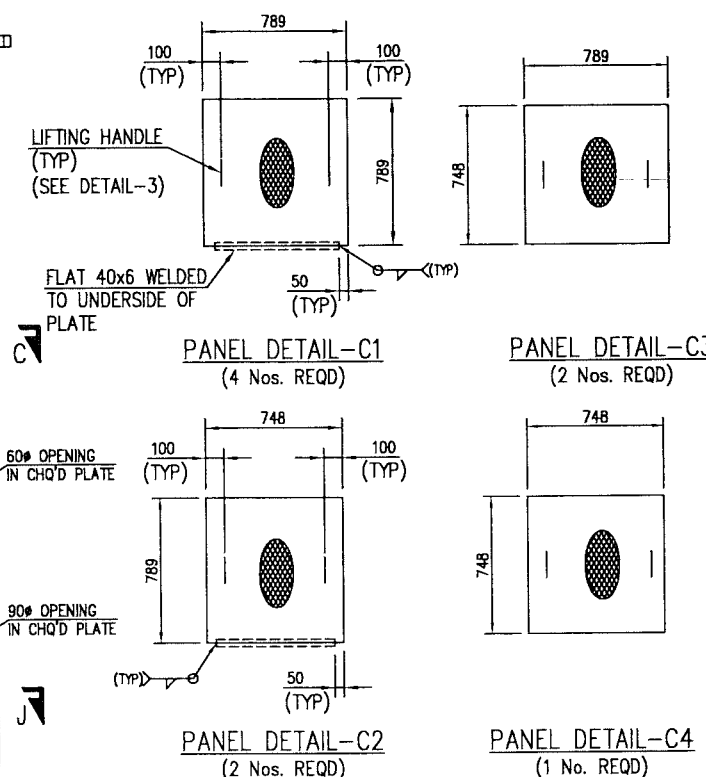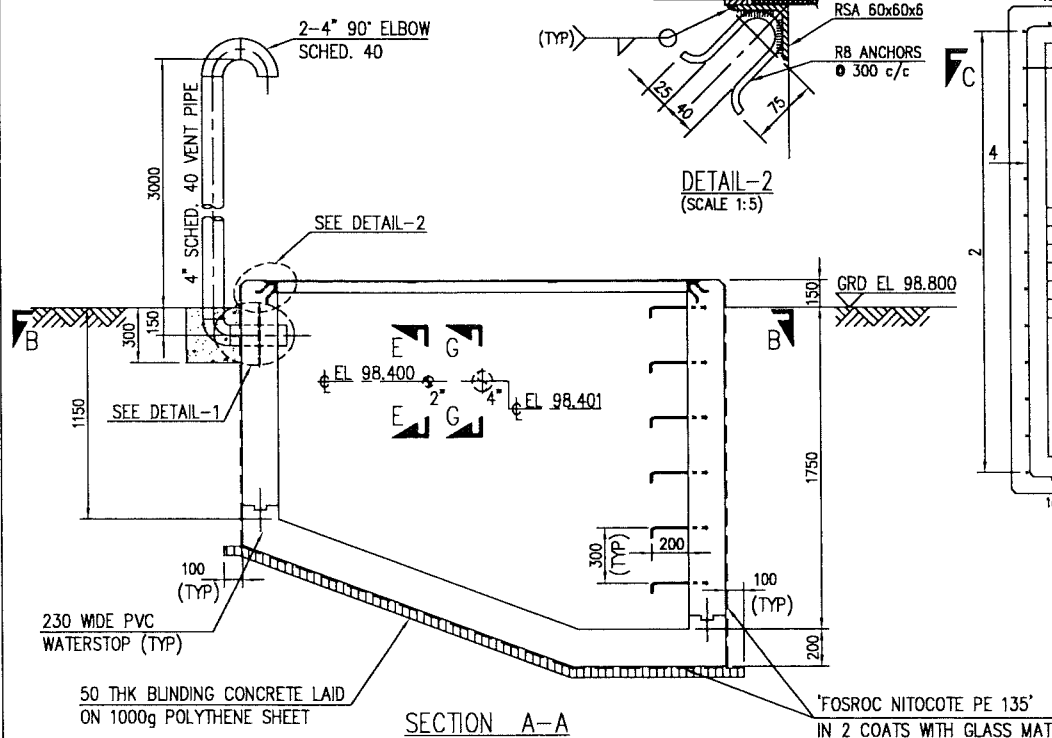
PANEL DETAIL-C1
(4 Nos. REQD)PANEL DETAIL-C3
(2 Nos. REQD)PANEL DETAIL-C2
(2 Nos. REQD)PANEL DETAIL-C4
(1 No. REQD)

SECTION A-A

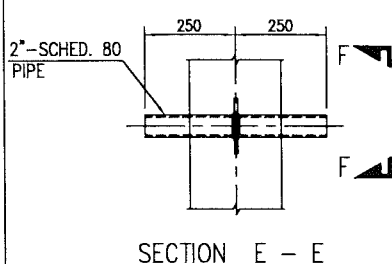
'FOSROC NITOCOTE PE 135'
IN 2 COATS WITH GLASS MAT

SECTION E-E


VIEW E-E

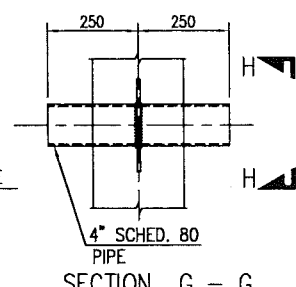


SECTION G-G

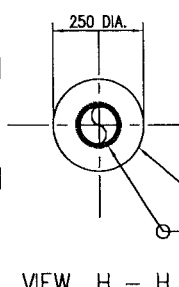



VIEW H-H

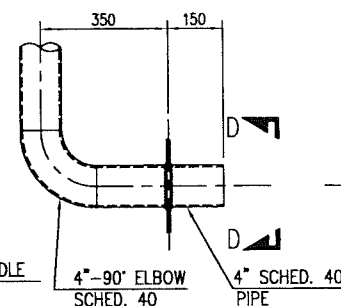

DETAIL-1

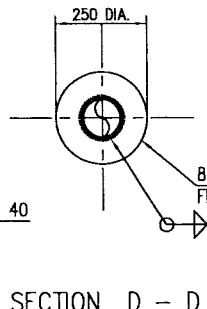

SECTION D-D

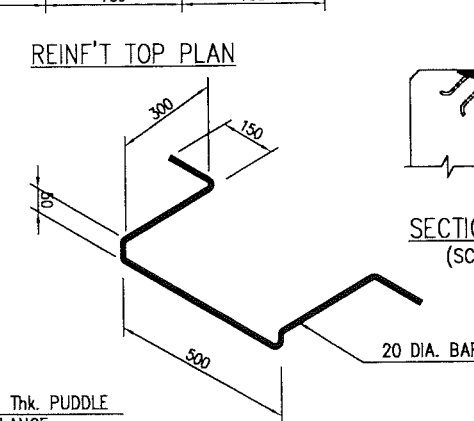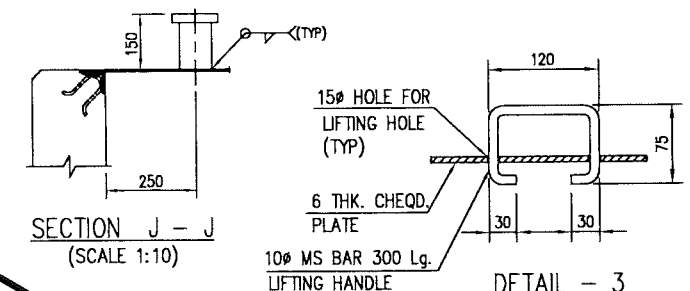DETAIL OF RUNG
(6 Nos. REQD)SECTION J-J
(SCALE 1:10)DETAIL-3
TYP. LIFTING HANDLE DETAIL
(SCALE 1:5)

CONCRETE GRADE 25

APPROVED FOR CONSTRUCTION

2. NOTCH IN MANHOLE OPENING TO BE FILLED WITH 1:3 MORTAR AFTER POSITIONING THE FRAME.
1. ALL DIMENSIONS ARE IN MM, ELEVATIONS & CO-ORDINATES ARE IN METERS

NOTES


REFERENCE DRAWINGS

MASTER DRAWING REVISION
IN CASE OF DEVIATIONS MARKED UP PRINT SHALL BE SENT TO COASTAL DESIGN OFFICE

PARSONS File name: W:\2_CIVIL\C-310606(EMC)\PAIP\PAIP00405_DQ\RECEIVER AREA\25774001_DQ.dwg-GCS-27/02/11-10:31:30

BAR BENDING SCHEDULE

JOB NO.: PAIP00405
PART ID.: PRODUCTION STATION
DRAIN PIT

Document No.: NIM-2-5774-002-DQ-4
Revision No.: A
Prepared by: GCS
Checked by: PNG 
Date: 27.02.11

REF. DWG NO.: NIM-2-5774-001-DQ-3

Total MTO for Rebars.

Dia. Of Bar	T6	T8	T10	T12	T16	T20	T25	T32
Length of Bar (m)				247.86				
Weight (Kgs)				220.61				

Total Weight (Kgs)

220.610

1c. Minerals
→ A2

[illegible]


This schedule complies with BS 8666 : 2005

All dimensions are in mm.



Refer to Bar shape Code drawing

* Specified in multiples of 5 mm


† Specified in multiples of 25 mm

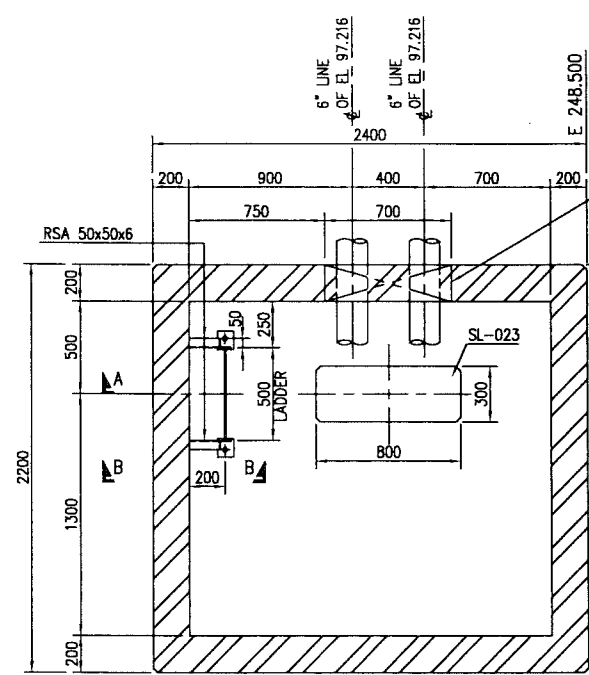


NOTE
AFTER INSTALLATION OF PIPE OPENING GAP
SHALL FILLED WITH CEMENT MORTAR

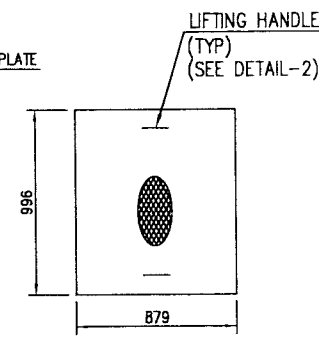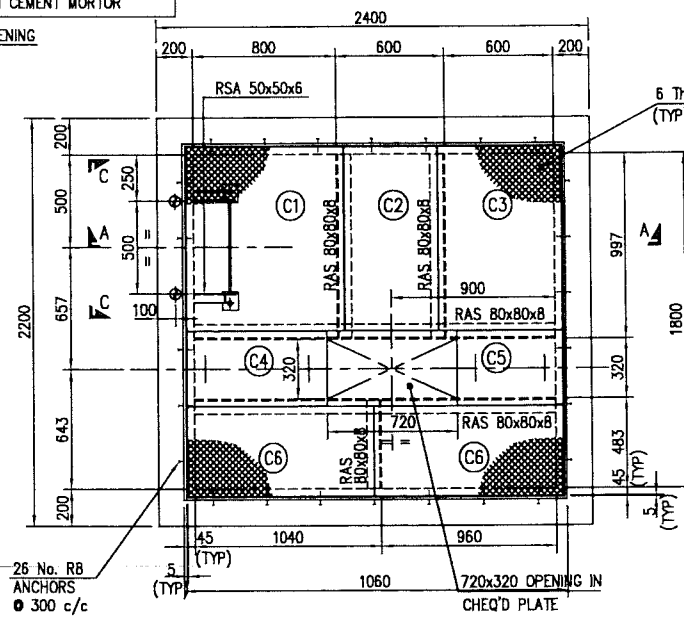


PANEL DETAIL-C1
(1 No. REQD)

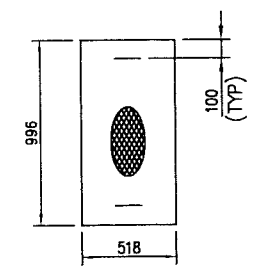


PANEL DETAIL-C2
(1 No. REQD)

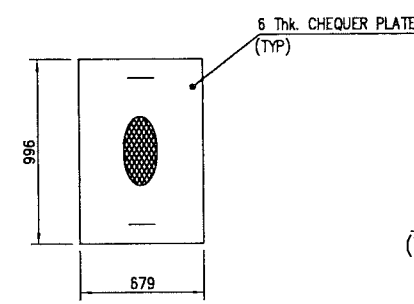


PANEL DETAIL-C3
(1 No. REQD)

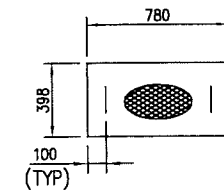


PANEL DETAIL-C4
(1 No. REQD)

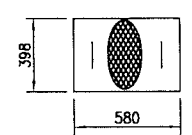


PANEL DETAIL-C5
(1 No. REQD)

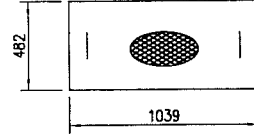


PANEL DETAIL-C6
(2 No. REQD)

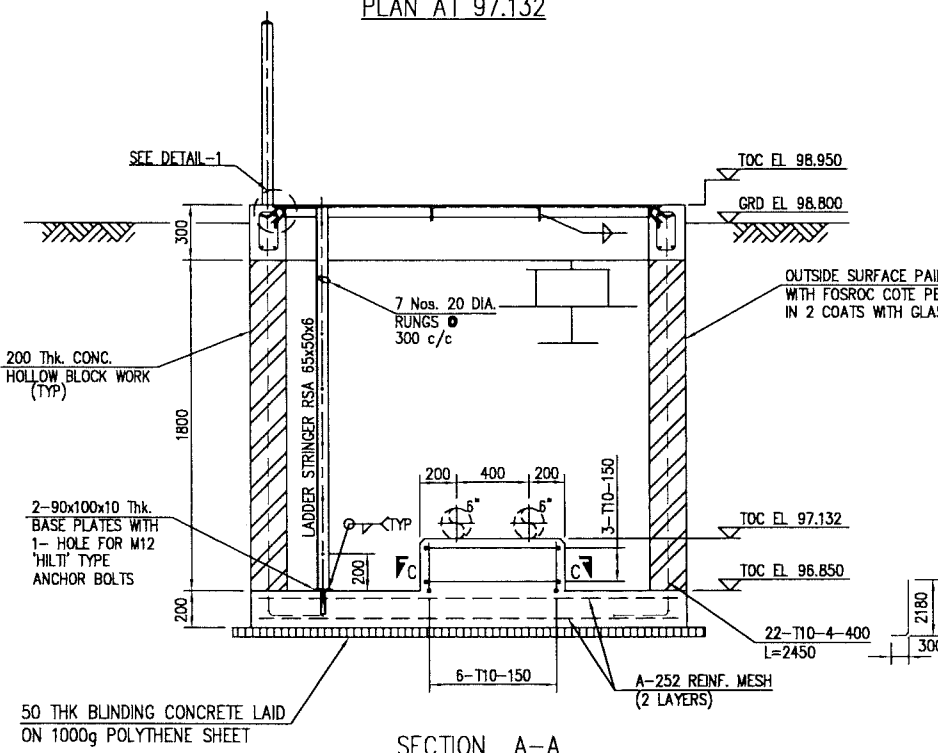


SECTION A-A

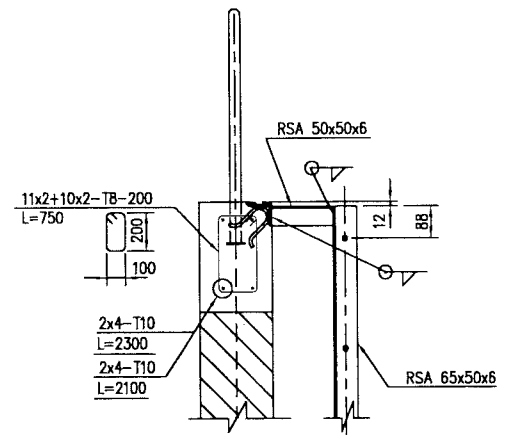


SECTION B-B

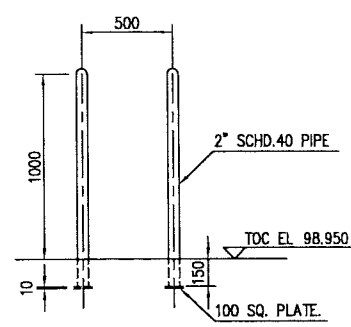


VIEW C-C

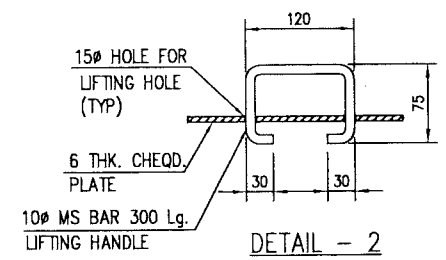

DETAIL - 2
TYP. LIFTING HANDLE DETAIL
(SCALE 1:5)

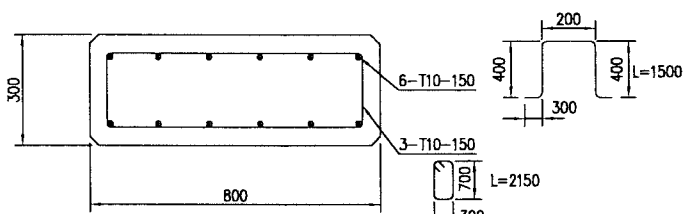

SECTION C-C

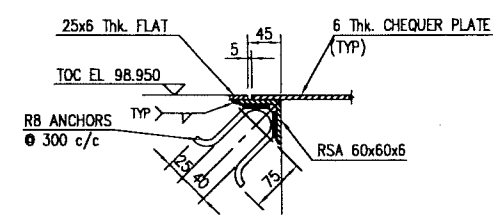

DETAIL-1
(1:5)




M.T.O.			
DESCRIPTION	QUANTITY	UNITS	SAP No.
BLINDING CONCRETE	0.32	m ³	N.A.
CONCRETE GRADE 25	1.65	m ³	N.A.
200 THK. HOLLOW BLOCK WORK	3.03	m ³	N.A.
FLAT 25x6	7.95	m	1000062571
10 THK PLATE	0.05	m ²	1000062608
CHECKERED PLATE	3.70	m ²	N.A.
RSA 50x50x6	0.35	m	1000062629
RSA 60x60x6	7.95	m	1000080320
RSA 65x50x5	4.20	m	1000132091
RSA 80x80x8	6.50	m	1000062630
R8 REINF BAR	6.50	m	1000133574
R20 REINF BAR	3.60	m	1000076442
T8 REINF BAR	31.50	m	1000133551
T10 REINF BAR	104.60	m	1000080336
A 252 MESH FABRIC	9.70	m ²	1000141508
M12 HSB WITH NUT & WASHER 60 Lg	2	PCS	N.A.
POLYTHENE SHEET 1000g	6.24	m ²	N.A.
PROTECTIVE COATING	25.50	m ²	N.A.
R10 REINF BAR	3.60	m	1000133577
2" PIPE SCHEDULE 40	2.30	m	1000051537

NOTES			
1. ALL DIMENSIONS ARE IN MM, ELEVATIONS & CO-ORDINATES ARE IN METERS			
REFERENCE DRAWINGS			
PIPING PLAN	NIM	3	5390
FOUNDATION LOCATION PLAN	NIM	2	5604
GENERAL NOTES, LEGEND & ABBREVIATIONS STEEL	NIM	2	5771
GENERAL NOTES, LEGEND & ABBREVIATIONS CONC.	NIM	2	5771
MASTER DRAWING REVISION			
NO.	DATE	DESCRIPTION	BY
1	27.02.11	ISSUED FOR CONSTRUCTION	GCS
2	28.02.11	ISSUED FOR COMMENTS	GCS
PROJECT DRAWING REVISION			
NO.	DATE	DESCRIPTION	BY
1	27.02.11	ISSUED FOR CONSTRUCTION	GCS
2	28.02.11	ISSUED FOR COMMENTS	GCS
IN CASE OF DEVIATIONS A MARKED UP PRINT SHALL BE SENT TO THE PROJECT ENGINEER			
AREA	NIMR	NO.	05
SUB AREA	PRODUCTION STATION	NO.	05
DESCRIPTION	CIVIL DETAILS	NO.	05
DESCRIPTION	FLANGE PIT	NO.	05
NO.	NIM 2 5774 003 DQ 1 A	NO.	05

CONTRACT NO.: C31/0606 PROJ. NO.: PAIP00405

PARSONS File name: W:\2_CIVIL\310606(EMC)\PAIP\PAIP00405_DQ\RECEIVER AREA\25774003_DQ.dwg-GCS-27/02/11-10:31:32

M.T.O.		
DESCRIPTION	QUANTITY	UNITS
BLINDING CONCRETE	0.06	m ³
CONCRETE GRADE 25	0.08	m ³
PROTECTION COATING	1.60	m ²
12 THK. FLEXCELL	0.15	m
A-252 REINF. MESH	0.60	m ²
1000g POLYTHENE SHEET	1.22	m ²

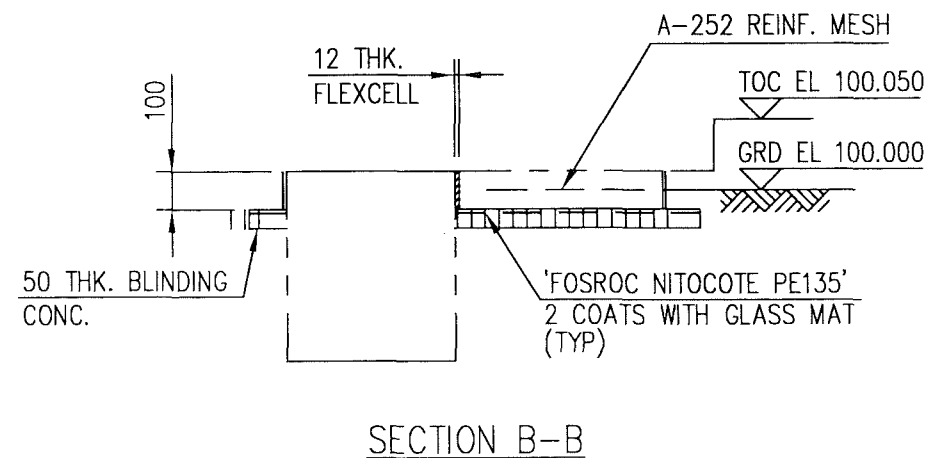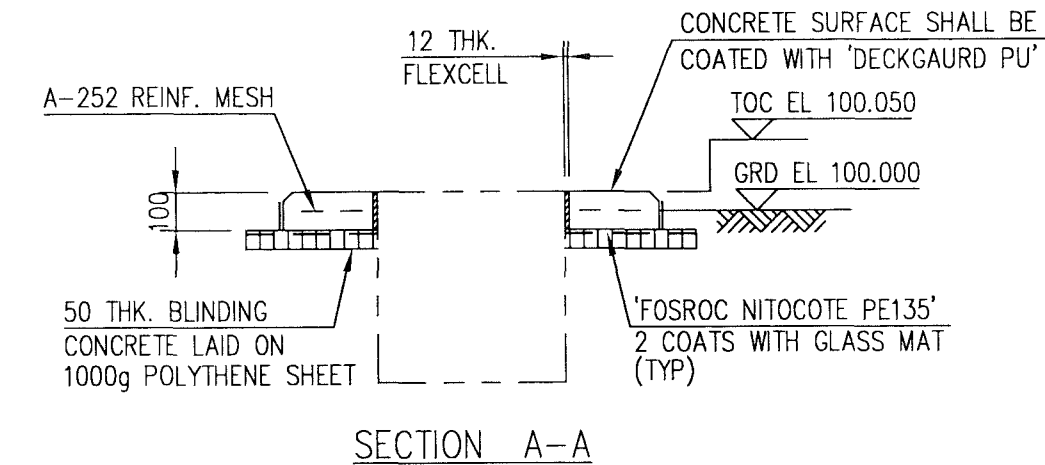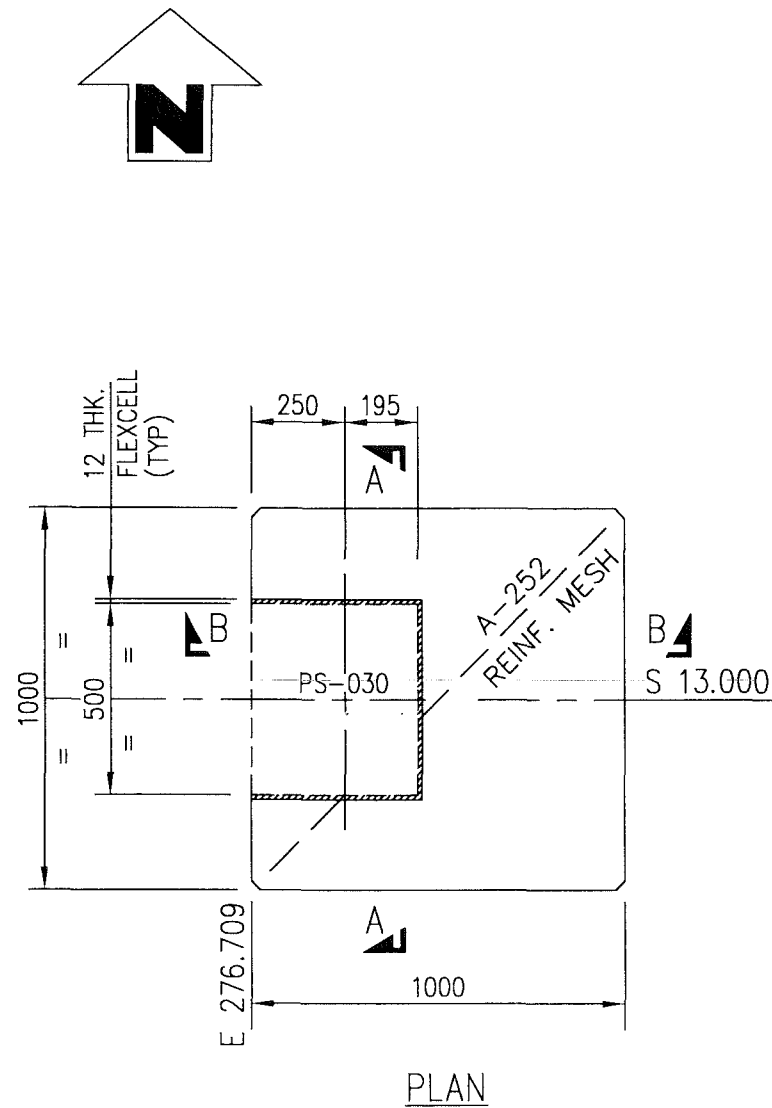

U. Amner
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APPROVED FOR
CONSTRUCTION

ورلي بارسونز - الصناعات العربية (محاصة) WorleyParsons - Arabian Industries (JV)	
CONTRACT NO. : C31/0606	PROJ. NO. : PAIP00405

REV	DATE	DRAWN BY	TEAM L	J. ENG.	CHECKED	DESCRIPTION	WBS No	PROJ. ENG.	SIGNATURE
A	27.02.11	GCS	RE	J		APPROVED FOR CONSTRUCTION	IN.09.011	OSE/28N	
0	28.12.10	JRP				ISSUED FOR COMMENTS	IN.09.011	OSE/28N	
P D O APPROVAL									


PROJECT DRAWING REVISION
IN CASE OF DEVIATIONS A MARKED UP PRINT SHALL BE SENT TO THE PROJECT ENGINEER

2. FOUNDATION LOCATION PLAN REF. DRG. No;									
NIM-2-5604-001-DQ-1	-	-	-	-	-	-	-	-	-
1. GEN. NOTES, LEGEND AND ABBREVIATIONS (CONC.)	REV	DATE	APPROVED BY	DESCRIPTION	B.I.NO.	PROJ.ENG.	SPEC.ENG.		
REF. DRG. No: NIM-2-5771-001-DQ-3									


AREA : NIMR	SCALE : 1:20	CAD DRAWING
SUB AREA : NIMR SLUDGE PIT SYSTEM UPGRADE NO. 16	شركة تنمية نفط عُمان Petroleum Development Oman	
DRWG. TYPE : CIVIL DETAIL	DRWG	AREA CODE
DESCRIPTION : HARD STAND	ENG SECT	SERIAL NUMBER
	SHEET	PROJ CODE
	DWG SIZE	REV.
	NO	NIM 2 5774 004 DQ 3 A

NOTES/REFERENCE DRAWINGS
IN CASE OF DEVIATIONS MARKED UP PRINT SHALL BE SENT TO COASTAL DESIGN OFFICE


MASTER DRAWING REVISION

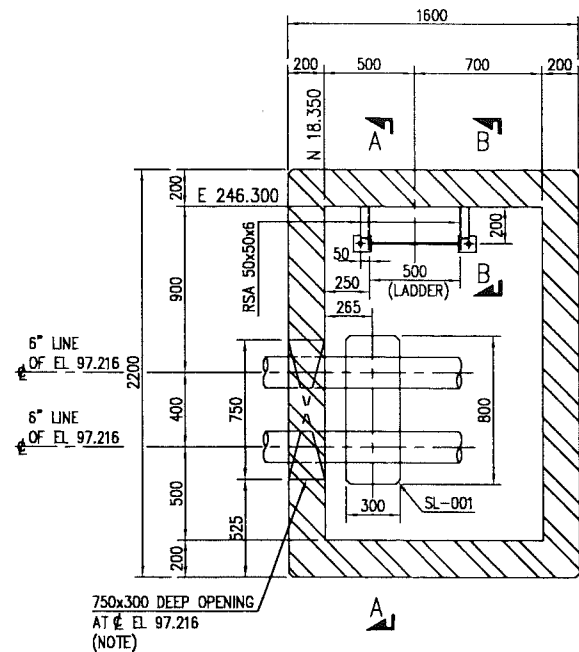


PLAN AT 97.132

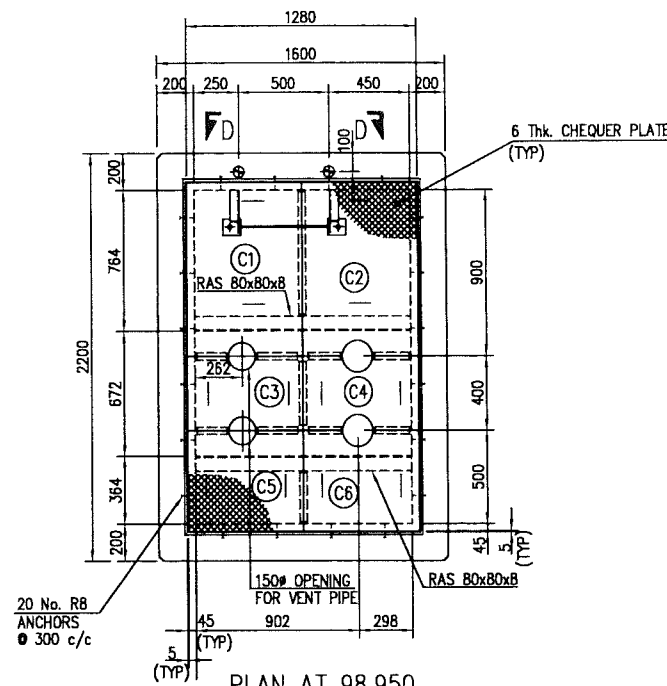


PLAN AT 98.950

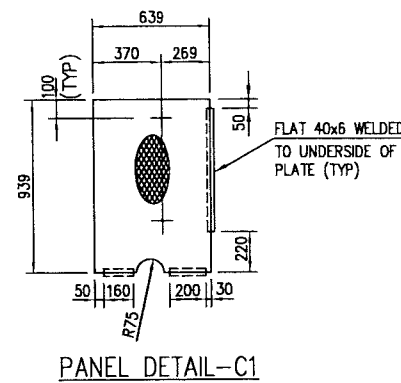


PANEL DETAIL-C1

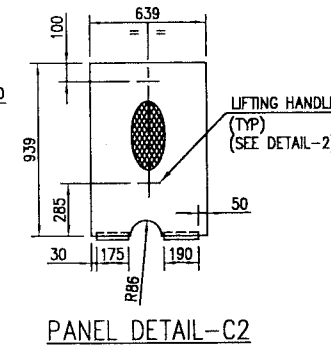


PANEL DETAIL-C2

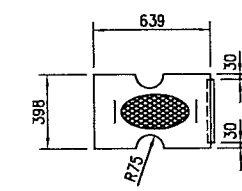


PANEL DETAIL-C3

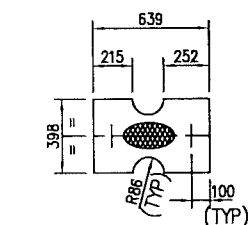


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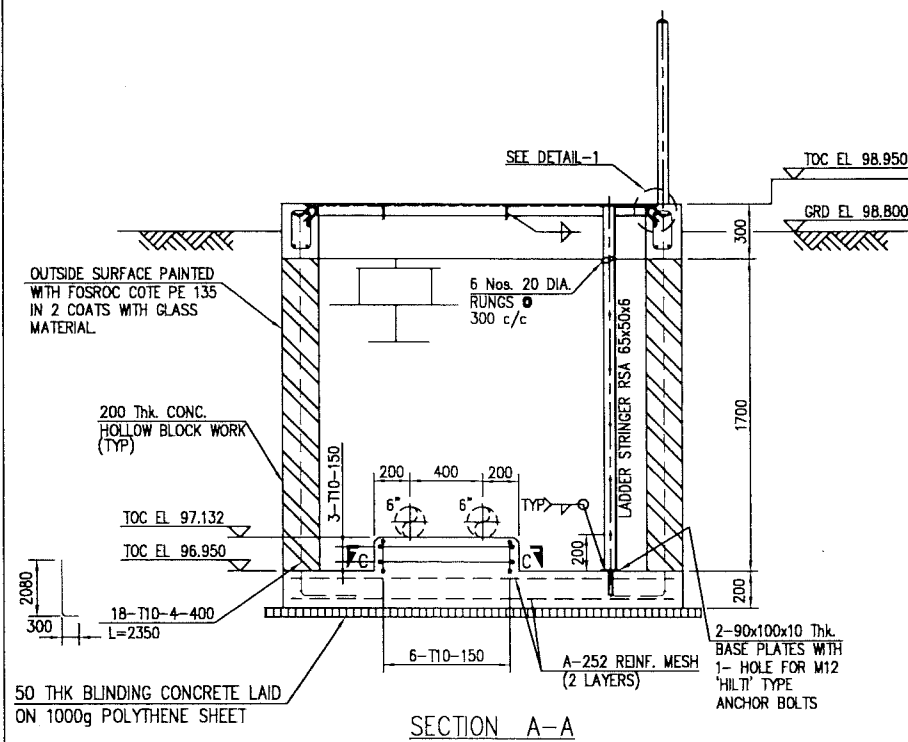
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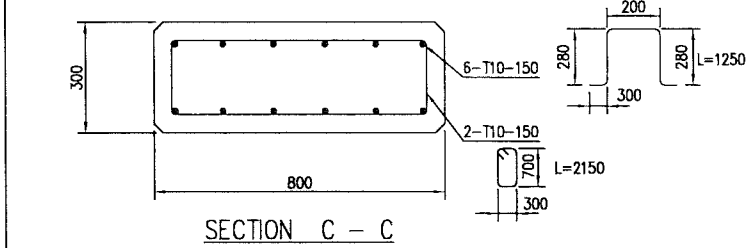
PANEL DETAIL-C6

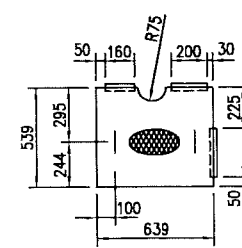


VIEW D - D

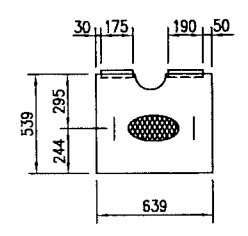


SECTION A-A

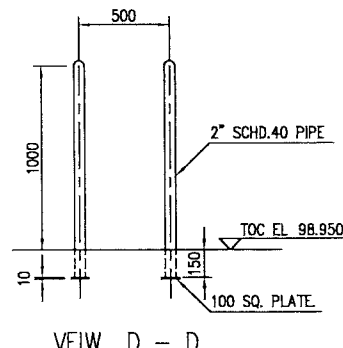


SECTION C - C

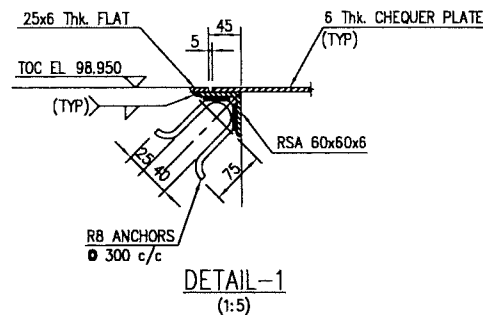

DETAIL-1
(1:5)

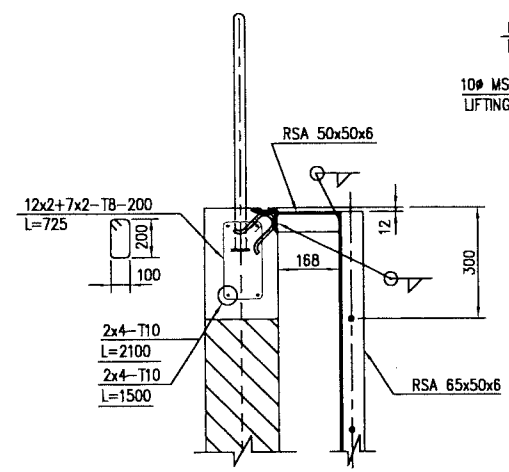

SECTION B - B

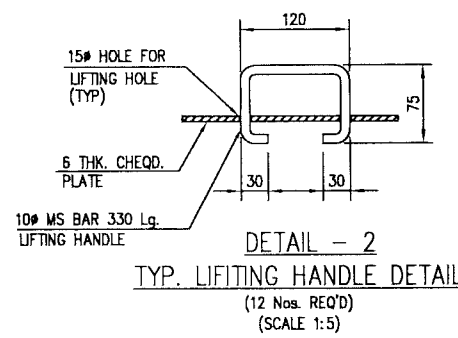

DETAIL - 2
TYP. LIFTING HANDLE DETAIL
(12 Nos. REQ'D)
(SCALE 1:5)

M.T.O.			
DESCRIPTION	QUANTITY	UNITS	SAP No.
BLINDING CONCRETE	0.22	m ³	N.A.
CONCRETE GRADE 25	1.20	m ³	N.A.
200 THK. HOLLOW BLOCK WORK	2.32	m ³	N.A.
FLAT 25x6	6.50	m	1000062571
FLAT 40x6	2.50	m	1000080324
10 THK PLATE	0.05	m ²	1000062608
CHECKERED PLATE	2.40	m ²	N.A.
RSA 50x50x6	0.35	m	1000062629
RSA 60x60x6	6.50	m	1000080320
RSA 65x50x5	4.00	m	1000132091
RSA 80x80x8	2.40	m	1000062630
R8 REINF BAR	5.00	m	1000133574
R20 REINF BAR	3.10	m	1000076442
T8 REINF BAR	27.60	m	1000133551
T10 REINF BAR	83.00	m	1000080336
A 252 MESH FABRIC	6.30	m ²	1000141508
M12 HSB WITH NUT & WASHER 60 Lg	2	PCS	N.A.
POLYTHENE SHEET 1000g	4.32	m ²	N.A.
PROTECTIVE COATING	19.30	m ²	N.A.
R10 REINF BAR	40.00	m	1000133577
2" PIPE SCHEDULE 40	2.30	m	1000051537

1. ALL DIMENSIONS ARE IN MM, ELEVATIONS & CO-ORDINATES ARE IN METERS

REFERENCE DRAWINGS

MASTER DRAWING REVISION
IN CASE OF DEVIATIONS MARKED UP PRINT SHALL BE SENT TO COASTAL DESIGN OFFICE


WorleyParsons - Arabian Industries (JV)
CONTRACT NO.: C31/0606 PROJ. NO.: PAIP00405

REV	DATE	BY	CHECKED	DESCRIPTION	ISS. NO.	PROJ. ENG.	SIGNATURE
A	27.02.11	GCS		APPROVED FOR CONSTRUCTION	IN.09.01	OSE/28N	
O	28.02.11	GCS		ISSUED FOR COMMENTS	IN.09.01	OSE/28N	


PROJECT DRAWING REVISION			
AREA	NO.	DESCRIPTION	REVISION
NIMR	05	PRODUCTION STATION	
CIVIL DETAILS		FLANGE PIT	
NIM 2 5774-005DQ 1 A			

10. Annex
TA 2

APPROVED FOR CONSTRUCTION

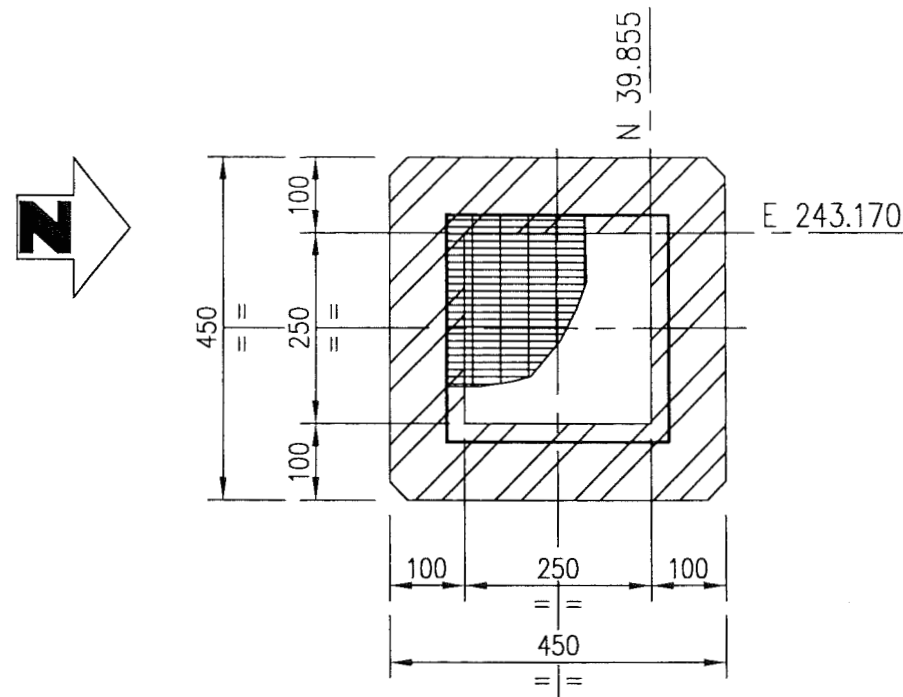

PLAN

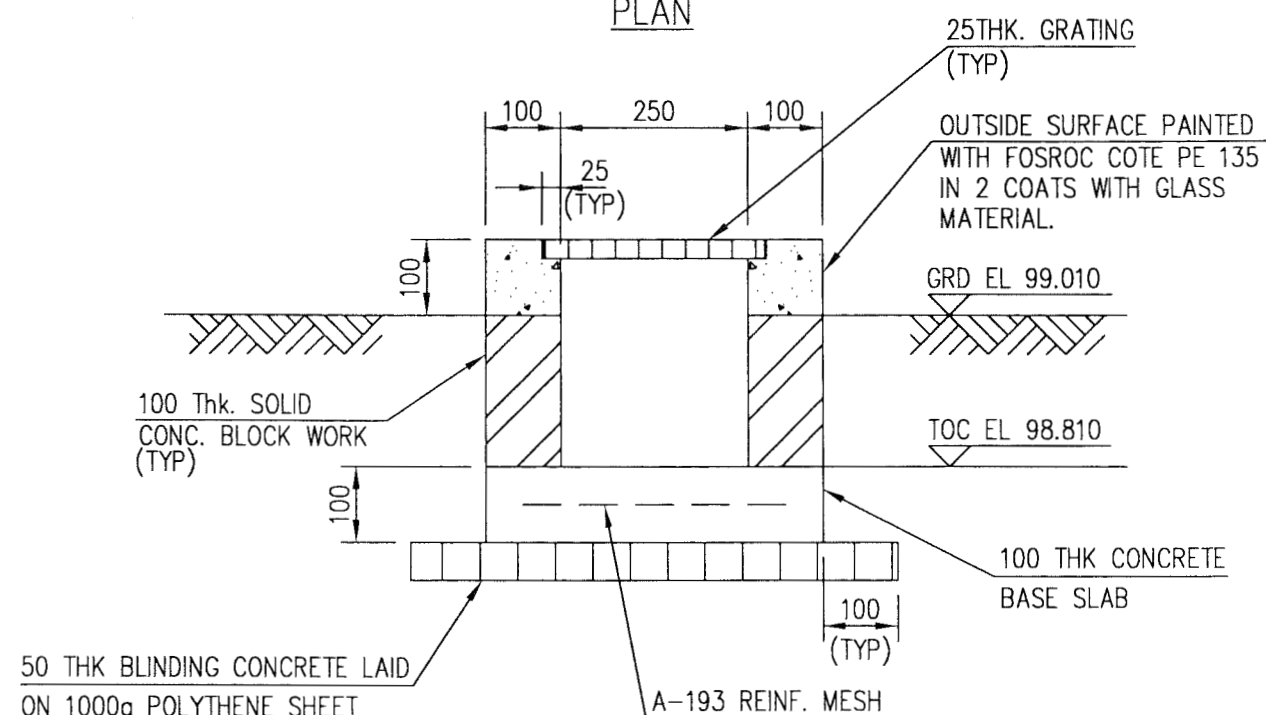

SECTION A - A



 ورلي بارسونز - الصناعات العربية (محاصة)
 WorleyParsons - Arabian Industries (JV)


CONTRACT NO.: C31/0606 PROJ. NO.: PAIP00405

2. ALL EXPOSED CONCRETE SURFACES SHALL BE TREATED WITH 2 COATS OF "FOSROC DEKGUARD S" WITH A DFT OF 350 MICRONS OR ANY OTHER APPROVED EQUIVALENT.							
1. ALL DIMENSIONS ARE IN MM, LEVELS ARE IN METERS.	REV	DATE	APPROVED BY	DESCRIPTION	WBS NO.	PROJ.ENG.	SPEC.ENG.


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A	27.02.11	GCS	RB	W		APPROVED FOR CONSTRUCTION	IN.09.011	OSE/28N	
O	26.02.11	GCS	KBR	GSB		ISSUED FOR COMMENTS	IN.09.011	OSE/28N	

PROJECT DRAWING REVISION
IN CASE OF DEVIATIONS A MARKED UP PRINT SHALL BE SENT TO THE PROJECT ENGINEER


AREA : NIMR		SCALE : 1:20 0 1 2 3 4 5 6 7								CAD DRAWING	
SUB AREA : PRODUCTION STATION		NO. 05		 <div>شركة تنمية نفط عُمان</div> <div>Petroleum Development Oman</div>							
DRWG. TYPE : CIVIL DETAILS				DRWG	AREA CODE	ENG SECT	SERIAL NUMBER	SHEET	PROJ CODE	DWG SIZE	REV
DESCRIPTION : COLLECTION PIT				NO	NIM	2	5774	006	DQ	3	A

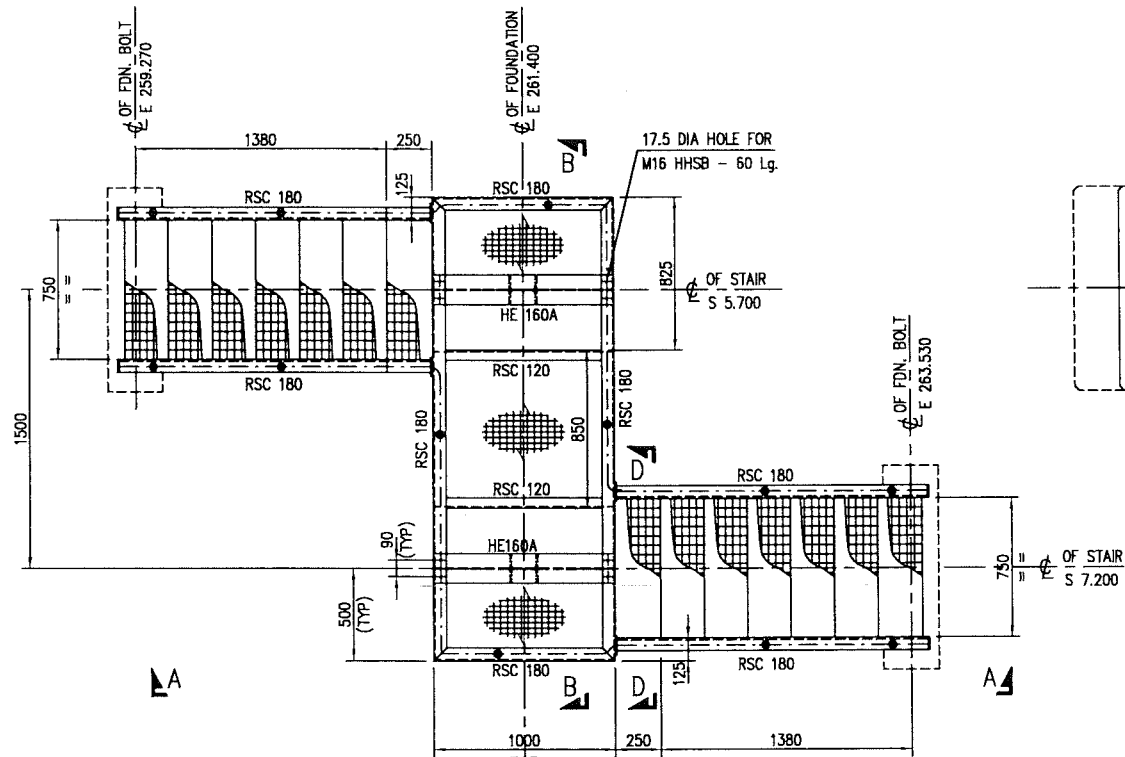


PLAN

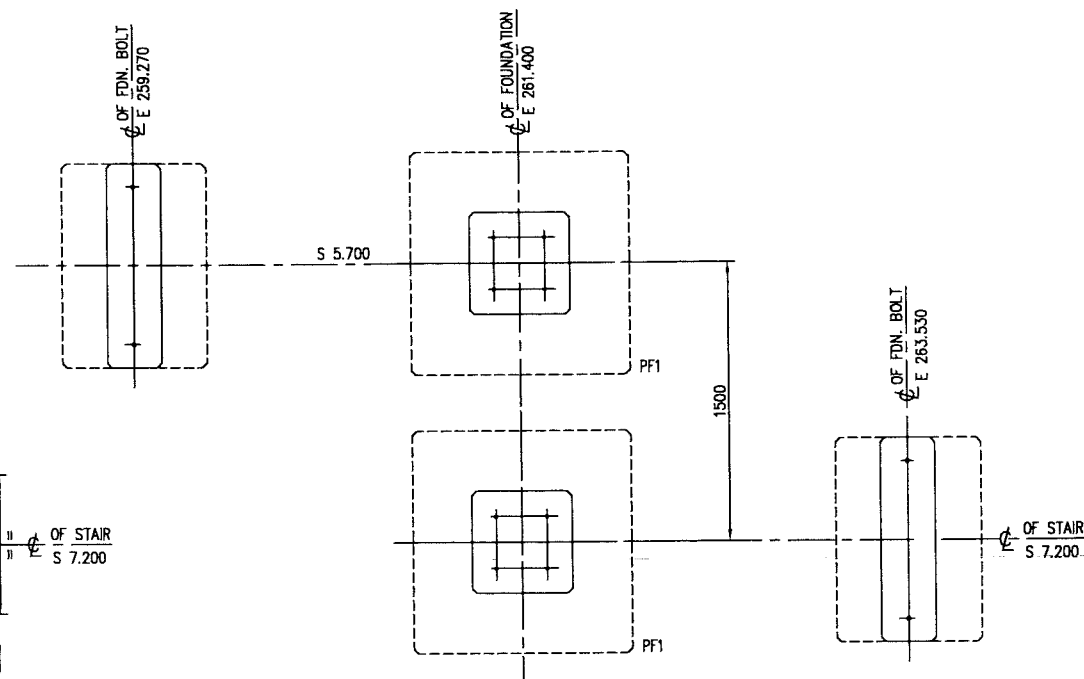


FOUNDATION PLAN

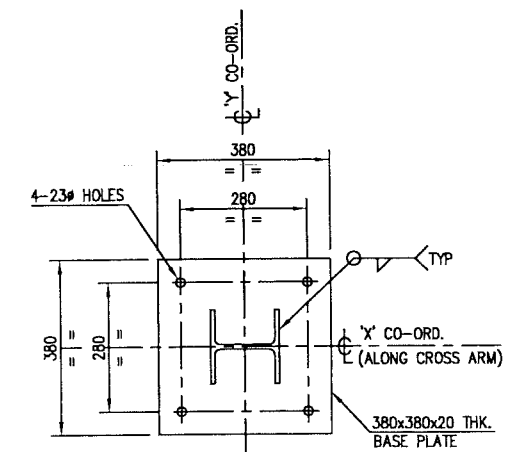


SECTION C - C
(2 Nos. REQD)
(SCALE 1:10)

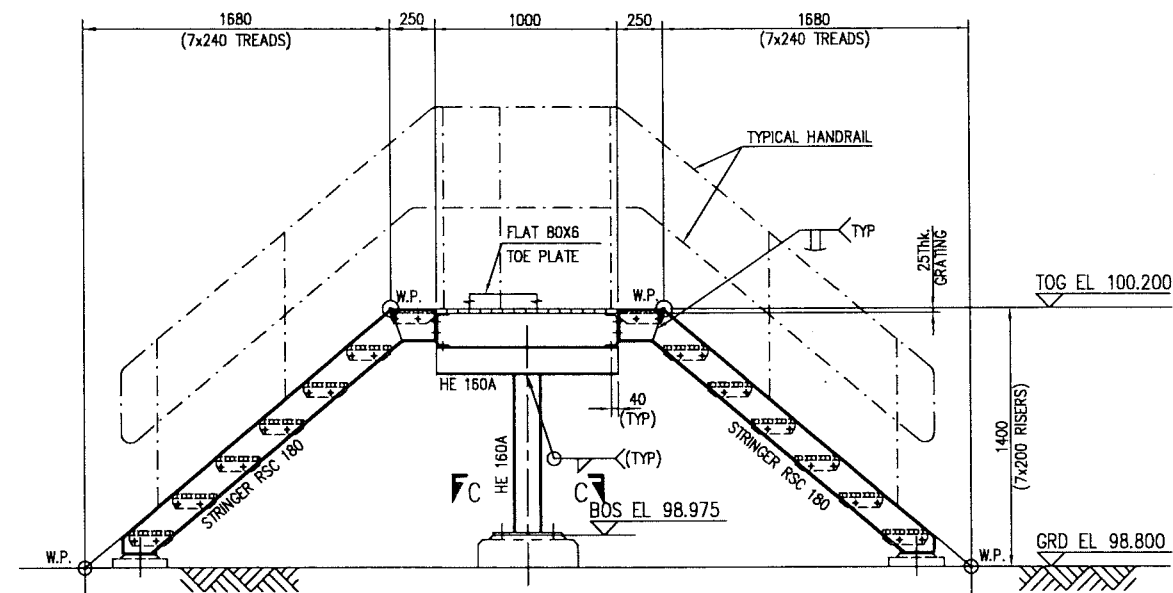

SECTION A-A

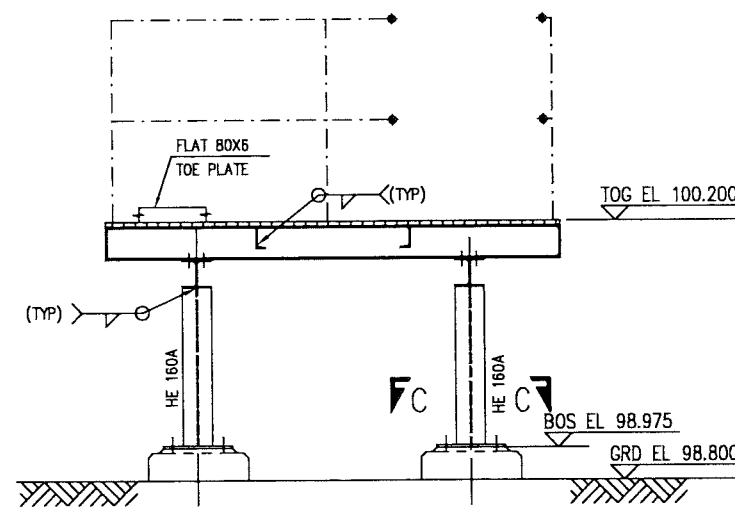


SECTION B-B

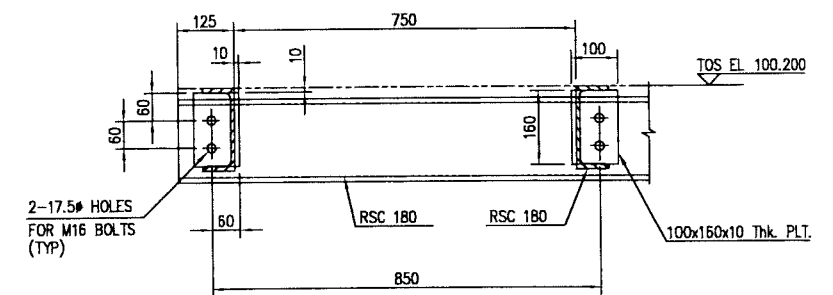

SECTION D - D
(SCALE 1:10)

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APPROVED FOR
CONSTRUCTION

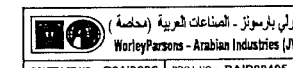

CONTRACT NO.: C310606 PROJ. NO.: PAIP00405

REV	DATE	EXPLAIN BY	CHECKED	DESCRIPTION	WBS NO	PROJ. ENG.	SIGNATURE
A	27.02.11	GCS	✓	APPROVED FOR CONSTRUCTION	IN.09.011	OSE/28N	
O	26.02.11	GCS	✓	ISSUED FOR COMMENTS	IN.09.011	OSE/28N	

PROJECT DRAWING REVISION				IN CASE OF DEVIATIONS A MARKED UP PRINT SHALL BE SENT TO THE PROJECT ENGINEER			
AREA	NIMR	NO	05	CAD DRAWING			
SUB AREA : PRODUCTION STATION				شركة تنمية نفط عمان Petroleum Development Oman			
DESCRIPTION : STRUCTURE STEEL DETAILS				DWG. NO. NIM 2 5775 001 DQ 1 A			
DESCRIPTION : PLATFORM MK'D P1							

DESCRIPTION	AREA	SERIAL	SH	P	REV	DATE	APPROVED BY	DESCRIPTION	WBS NO	PROJ. ENG.	SIGNATURE
PIPING PLAN	NIM	3	2120	001	DQ 1						
PLATFORM FOUNDATION MK'D PF1	NIM	2	5775	002	DQ 3						
FOUNDATION LOCATION PLAN	NIM	2	5604	005	DQ 1						
TYPICAL GRATING DETAILS	NIM	2	5771	004	DQ 3						
TYPICAL STAIR & HANDRAILING	NIM	2	5771	003	DQ 3						
GENERAL NOTE, LEGEND & ABBREVIATIONS STEEL	NIM	2	5771	002	DQ 3						


DESCRIPTION	AREA	SERIAL	SH	P	REV	DATE	APPROVED BY	DESCRIPTION	WBS NO	PROJ. ENG.	SIGNATURE
PIPING PLAN	NIM	3	2120	001	DQ 1						
PLATFORM FOUNDATION MK'D PF1	NIM	2	5775	002	DQ 3						
FOUNDATION LOCATION PLAN	NIM	2	5604	005	DQ 1						
TYPICAL GRATING DETAILS	NIM	2	5771	004	DQ 3						
TYPICAL STAIR & HANDRAILING	NIM	2	5771	003	DQ 3						
GENERAL NOTE, LEGEND & ABBREVIATIONS STEEL	NIM	2	5771	002	DQ 3						

1. ALL DIMENSIONS ARE IN MILLIMETRES AND ELEVATIONS IN METRES.


REFERENCE DRAWINGS

MASTER DRAWING REVISION
IN CASE OF DEVIATIONS MARKED UP PRINT SHALL BE SENT TO COASTAL DESIGN OFFICE


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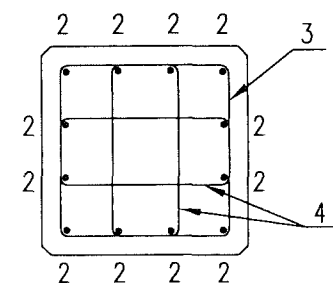
PLAN
(2 Nos. REQ'D)

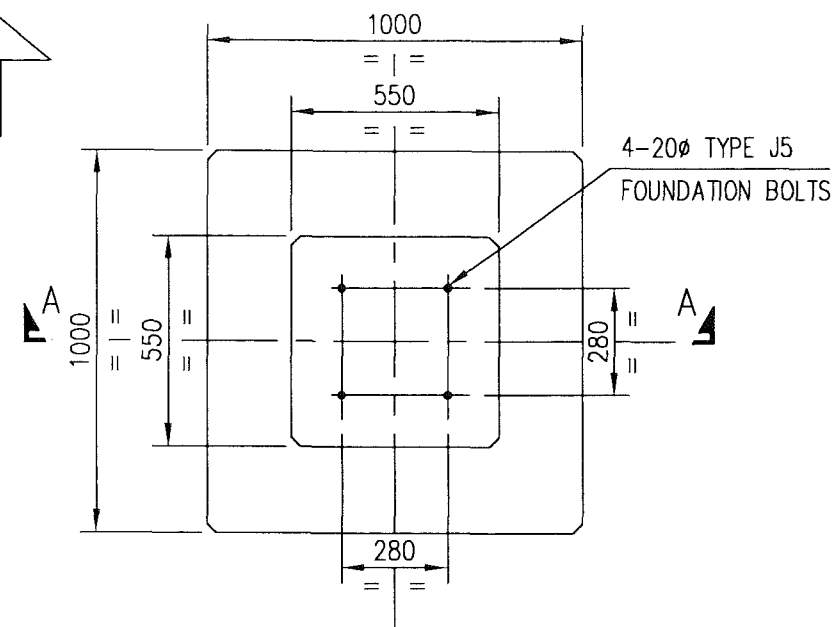

REINFORCEMENT PLAN

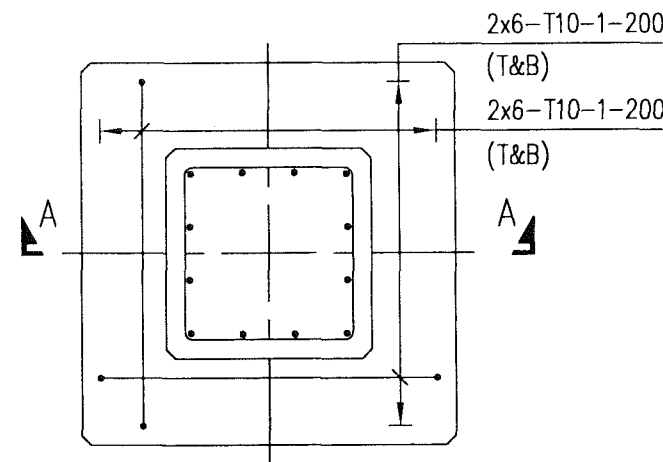

SECTION A - A

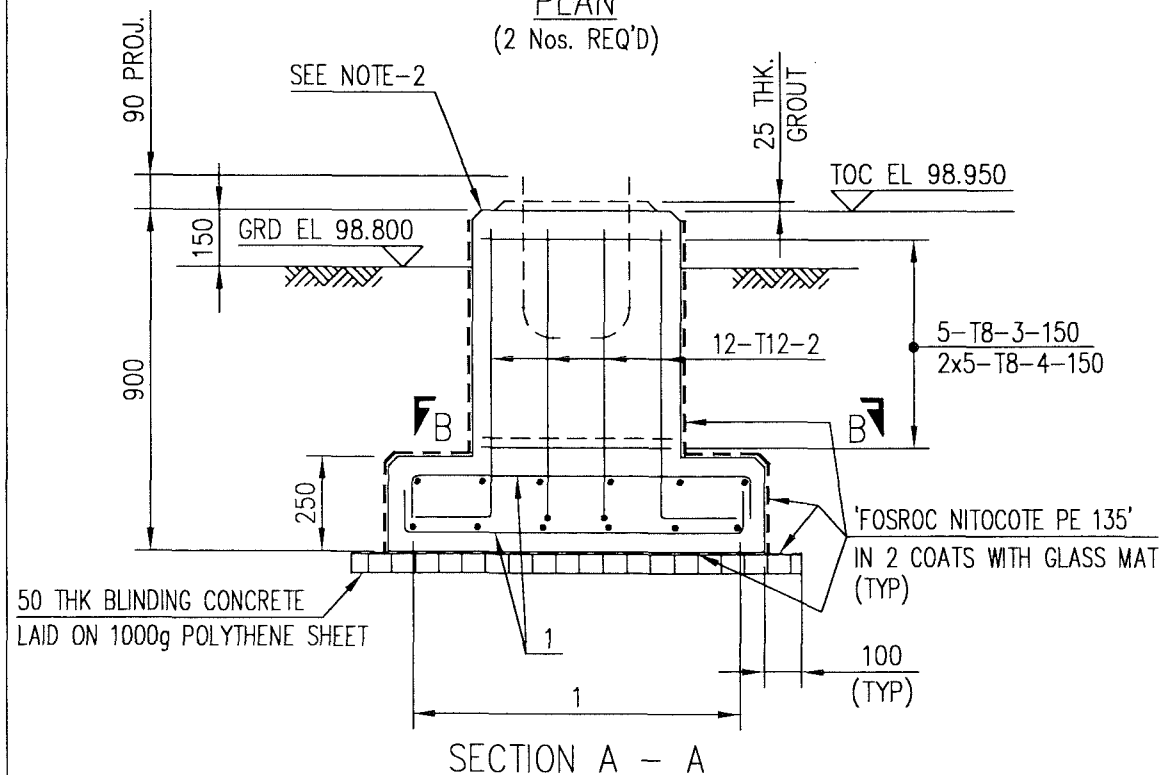

SECTION B - B

M T O

DESCRIPTION	QUANTITY	UNITS	SAP No.
BLINDING CONCRETE GRADE 10	0.15	m ³	N.A.
CONCRETE GRADE 35	0.90	m ³	N.A.
CEMENT SAND GROUT	10.60	lit	N.A.
REINFORCEMENT STEEL	73.61	Kg	N.A.
PROTECTIVE COATING	9.20	m ²	N.A.
20φ FOUNDATION BOLT TYPE - J5	8	PCS	N.A.
1000g POLYTHENE SHEET	2.90	m ²	N.A.

NOTE: * DENOTES, SINCE GRADE ELEVATION VARIES, CONTRACTOR TO VERIFY ELEVATIONS AND DIMENSIONS AT SITE, PRIOR TO FABRICATION/CONSTRUCTION/INSTALLATION.

REFERENCE DRGS: -

1. GEN.NOTES, LEGEND & ABBREVIATIONS (CONG.) - NIM -2-5771-001-DQ-3
2. PLATFORM P1 DETAILS - NIM -2-5775-001-DQ-1
3. FOUND BOLTS - STD -2-3950-001-00-3
4. BAR BENDING SCHEDULE - NIM -2-5775-003-DQ-4
5. FOUNDATION LOCATION PLAN - NIM -2-5604-005-DQ-1

CONCRETE GRADE-35

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APPROVED FOR
CONSTRUCTION



CONTRACT NO.: C31/0606 PROJ. NO.: PAIP00405

2. ALL EXPOSED CONCRETE SURFACES SHALL BE TREATED WITH TWO COATS OF "FOSROC DEKGUARD S" WITH A DFT OF 350 MICRONS OR ANY OTHER APPROVED EQUIVALENT.

1. ALL DIMENSIONS ARE IN MILLIMETRES AND ELEVATIONS IN METRES.

NOTES/REFERENCE DRAWINGS

MASTER DRAWING REVISION
IN CASE OF DEVIATIONS MARKED UP PRINT SHALL BE SENT TO COASTAL DESIGN OFFICE

REV	DATE	DRAWN BY	TEAM	J.ENG.	CHECKED	DESCRIPTION	WBS No.	PROJ. ENG.	SIGNATURE
A	27.02.11	GCS	RA	✓		APPROVED FOR CONSTRUCTION	IN.09.011	OSE/28N	
O	26.02.11	GCS	KBR	GSB		ISSUED FOR COMMENTS	IN.09.011	OSE/28N	

PROJECT DRAWING REVISION
IN CASE OF DEVIATIONS A MARKED UP PRINT SHALL BE SENT TO THE PROJECT ENGINEER

AREA : NIMR

SUB AREA : PRODUCTION STATION

DRWG.TYPE : CIVIL DETAILS

DESCRIPTION : PLATFORM FOUNDATION MK'D PF1

SCALE : 1:20
CAD DRAWING

شركة تنمية نفط عُمان
Petroleum Development Oman

DRWG	AREA CODE	ENG SECT	SERIAL NUMBER	SHEET	PROJ CODE	DWG SIZE	REV.
NO	NIM	2	5775	002	DQ	3	A

BAR BENDING SCHEDULE

JOB NO.: PAIP00238
PART ID.: PRODUCTION STATION
PLATFORM-P1

Document No.: NIM-2-5775-003-DQ-4

Revision No.: A

Prepared by: GCS

Checked by: PNG *RR*

Date: 27.02.11

REF. DWG NO.: NIM-2-5775-002-DQ-3

Total MTO for Rebars.

Dia. Of Bar	T6	T8	T10	T12	T16	T20	T25	T32
Length of Bar (m)		48.25	54.00	23.40				
Weight (Kgs)		19.30	33.48	20.83				

Total Weight (Kgs)

73.610

1c. Number
TA2

[illegible]


This schedule complies with BS 8666 : 2005

All dimensions are in mm


Refer to Bar shape Code drawing

* Specified in multiples of 5 mm


† Specified in multiples of 25 mm

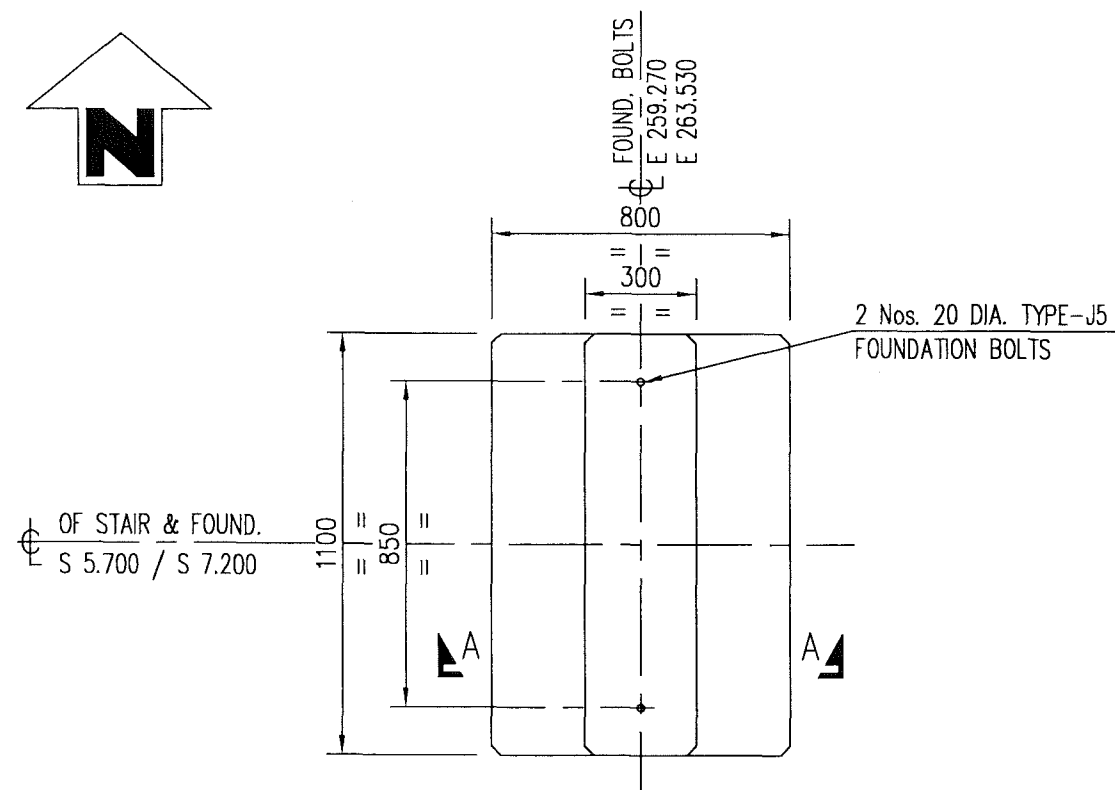

PLAN
(2 Nos. REQ'D)

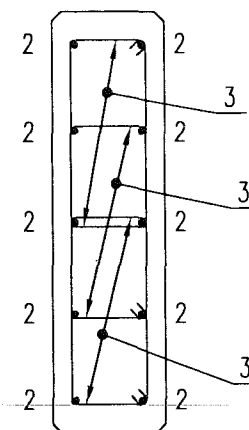

SECTION B-B

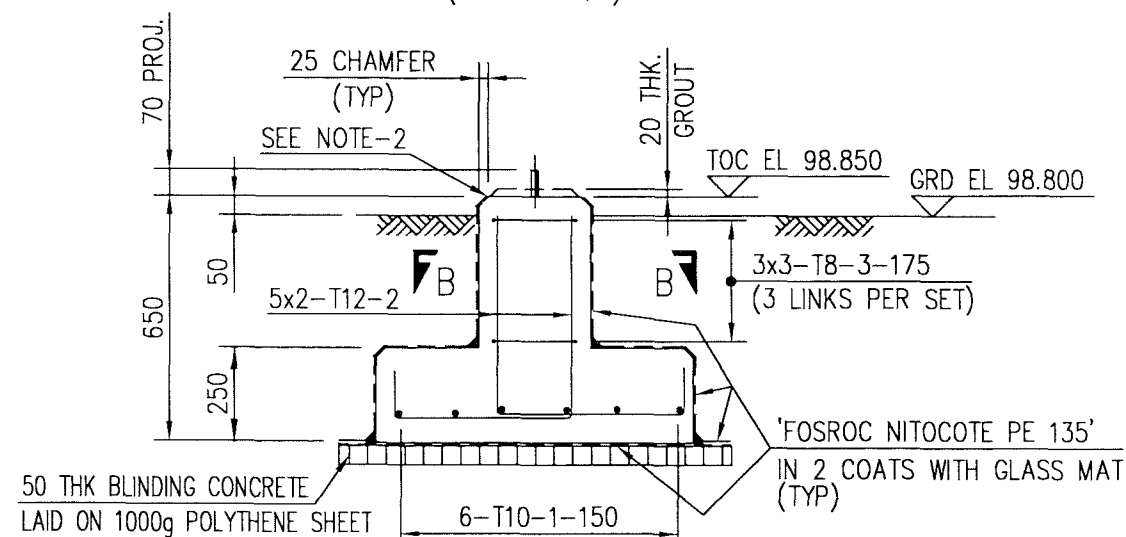

SECTION A-A

M.T.O.

DESCRIPTION	QUANTITY	UNITS	SAP No.
BLINDING CONCRETE	0.13	m ³	N.A.
CONCRETE GRADE 35	0.71	m ³	N.A.
CEMENT SAND GROUT	4.62	L ^t	N.A.
FOUNDATION BOLTS	4	PCS	N.A.
PROTECTIVE COATING	7.84	m ²	N.A.
REINFORCEMENT STEEL	41.04	kg	N.A.
POLYTHENE SHEET 1000g	2.60	m ²	N.A.

NOTE: * DENOTES, SINCE GRADE ELEVATION VARIES, CONTRACTOR TO VERIFY ELEVATIONS AND DIMENSIONS AT SITE, PRIOR TO FABRICATION/CONSTRUCTION/INSTALLATION.


REFERENCE DRGS: -

1. GEN.NOTES, LEGEND & ABBREVIATIONS (CONC.) NIM -2-5771-001-DQ-3
2. FOUND BOLTS STD -2-3950-001-00-3
3. BAR BENDING SCHEDULE NIM -2-5775-005-DQ-4
4. FOUNDATION LOCATION PLAN NIM -2-5604-005-DQ-1

CONCRETE GRADE-35

10. Miners
TA2

APPROVED FOR
CONSTRUCTION

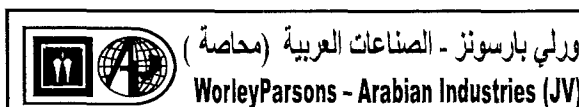

CONTRACT NO.: C31/0606 PROJ. NO.: PAIP00405

REV	DATE	DRAWN BY	CHECKED	DESCRIPTION	WBS No.	PROJ. ENG.	SIGNATURE
A	27.02.11	GCS	RB	APPROVED FOR CONSTRUCTION	IN.09.011	OSE/28N	
O	26.02.11	GCS	KBR	ISSUED FOR COMMENTS	IN.09.011	OSE/28N	

PROJECT DRAWING REVISION

IN CASE OF DEVIATIONS A MARKED UP PRINT SHALL BE SENT TO THE PROJECT ENGINEER

2. ALL EXPOSED CONCRETE SURFACES SHALL BE TREATED WITH TWO COATS OF "FOSROC DEKGUARD S" WITH A DFT OF 350 MICRONS OR ANY OTHER APPROVED EQUIVALENT.

1. ALL DIMENSIONS ARE IN MILLIMETRES AND ELEVATIONS IN METRES.

AREA : NIMR


SUB AREA : PRODUCTION STATION

NO. 05

DRWG. TYPE : CIVIL DETAILS

DESCRIPTION : STAIR FOUNDATION MK'D SF1

SCALE : 1:20 CAD DRAWING

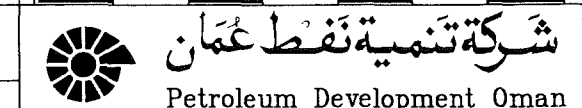

DRWG	AREA CODE	ENG SECT	SERIAL NUMBER	SHEET	PROJ CODE	DWG SIZE	REV.
NO	NIM	2	5775004	DQ	3	A	

MASTER DRAWING REVISION
IN CASE OF DEVIATIONS MARKED UP PRINT SHALL BE SENT TO COASTAL DESIGN OFFICE

PARSONS File name: W:\2_CIVIL\C-310606(EMC)\PAIP\PAIP00405_DQ\RECEIVER AREA\25775004_DQ.dwg-GCS-27/02/11-10:31:38

BAR BENDING SCHEDULE

JOB NO.: PAIP00238
PART ID.: PRODUCTION STATION
STAIR FOUNDATION

Document No.: NIM-2-5775-005-DQ-4

Revision No.: A

Prepared by: GCS

Checked by: PNG

Date: 27.02.11

REF. DWG NO.: NIM-2-5775-004-DQ-3

Total MTO for Rebars.

Dia. Of Bar	T6	T8	T10	T12	T16	T20	T25	T32
Length of Bar (m)		28.80	15.30	22.50				
Weight (Kgs)		11.52	9.49	20.03				

Total Weight (Kgs)

41.040

1c. Movers
TA2

[illegible]



This schedule complies with BS 8666 : 2005

All dimensions are in mm


Refer to Bar shape Code drawing

* Specified in multiples of 5 mm



† Specified in multiples of 25 mm

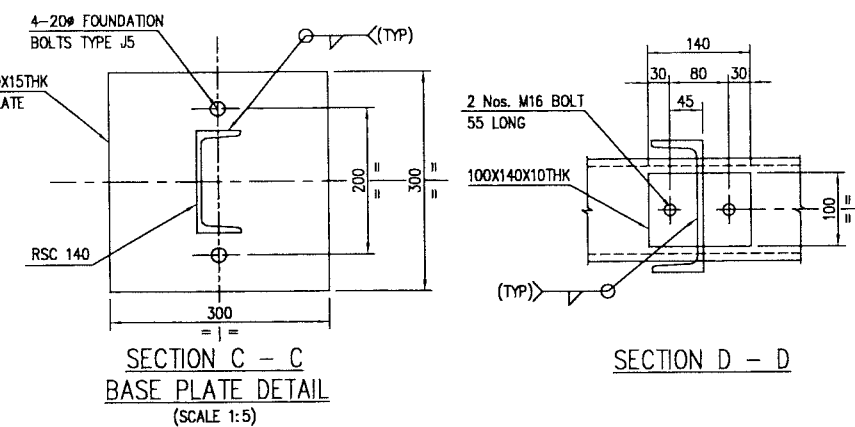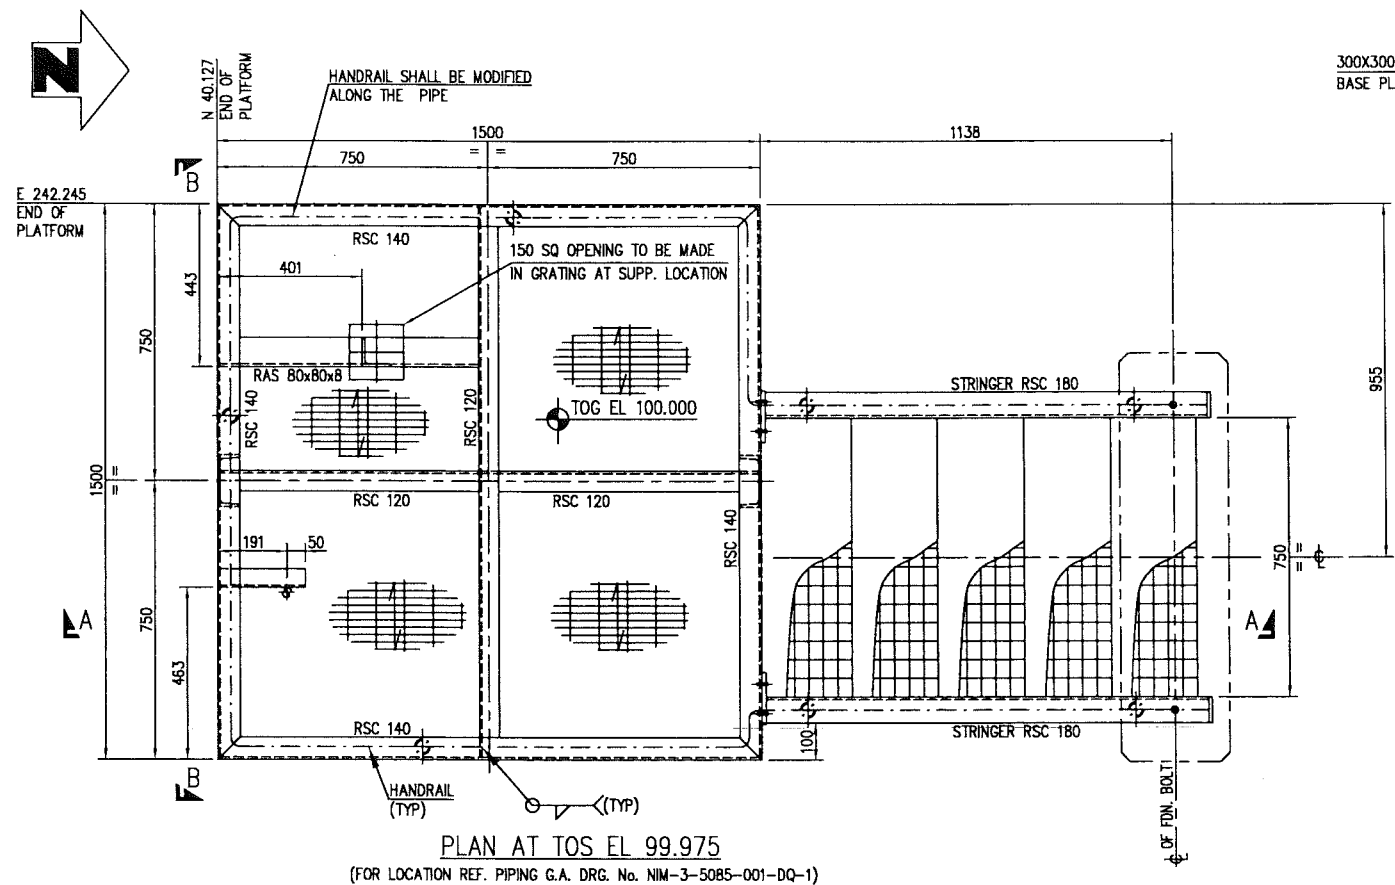

M.T.O.			
DESCRIPTION	QUANTITY	UNITS	SAP No.
RSC 180	3.20	m	1000080367
RSC 140	7.30	m	1000080366
RSC 120	3.00	m	1000080365
RSA 50x50x6	0.42	m	1000062630
RSA 70x70x7	3.35	m	1000080321
RSA 80x80x8	2.20	m	1000062629
1-1/4" PIPE SCHEDULE 40	16.70	m	N.A
1" PIPE SCHEDULE 40	7.00	m	1000051530
25 THK. GRATING	2.25	m ²	N.A
25 THK. STAIR TREAD	5	PCS	N.A
FLAT 80x6	4.90	m	1000062575
FLAT 60x10	1.35	m	1000132245
15 THK. PLATE	0.18	m ²	1000080265
10 THK. PLATE	0.03	m ²	1000062608
8 THK. PLATE	0.05	m ²	1000062607
M12 HSB WITH NUT & WASHER 45 Lg	20	PCS	N.A
M16 HSB WITH NUT & WASHER 55 Lg	18	PCS	N.A

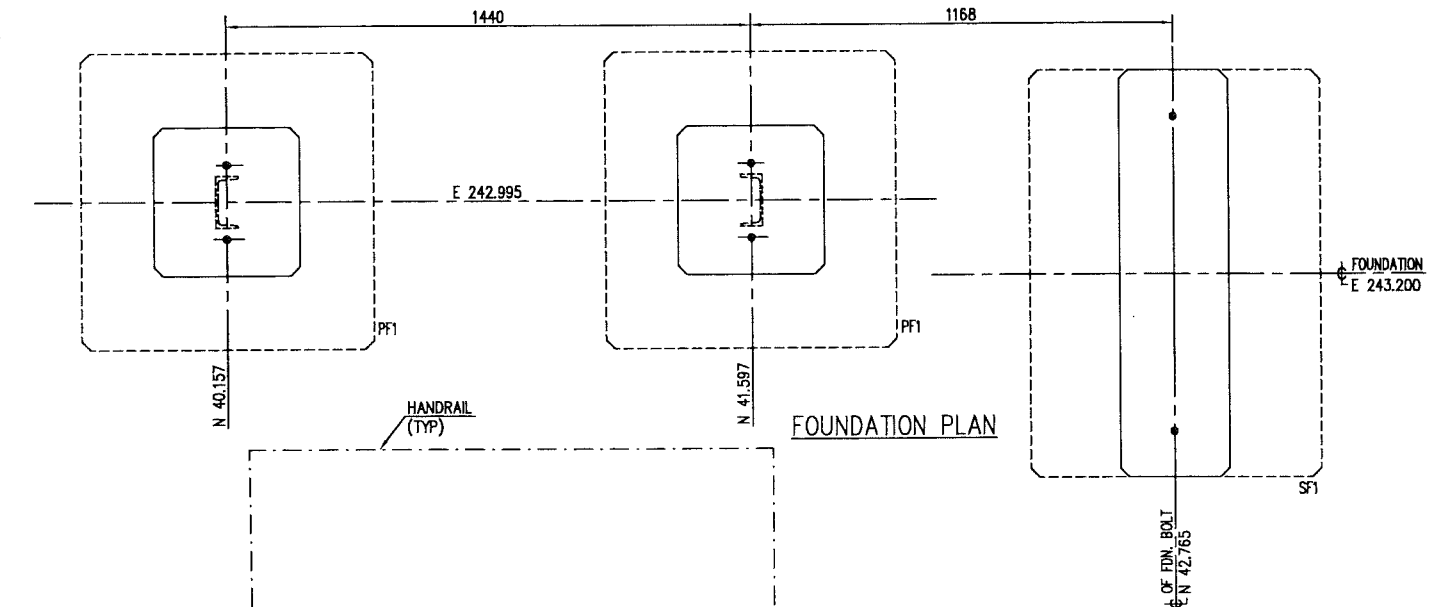


NOTE: * DENOTES, SINCE GRADE ELEVATION VARIES, CONTRACTOR TO VERIFY ELEVATIONS AND DIMENSIONS AT SITE, PRIOR TO FABRICATION/CONSTRUCTION/INSTALLATION.

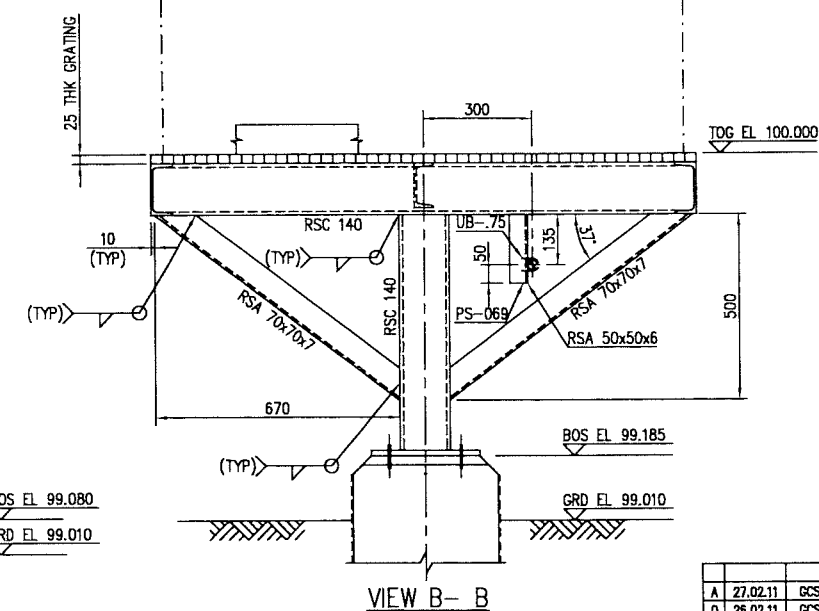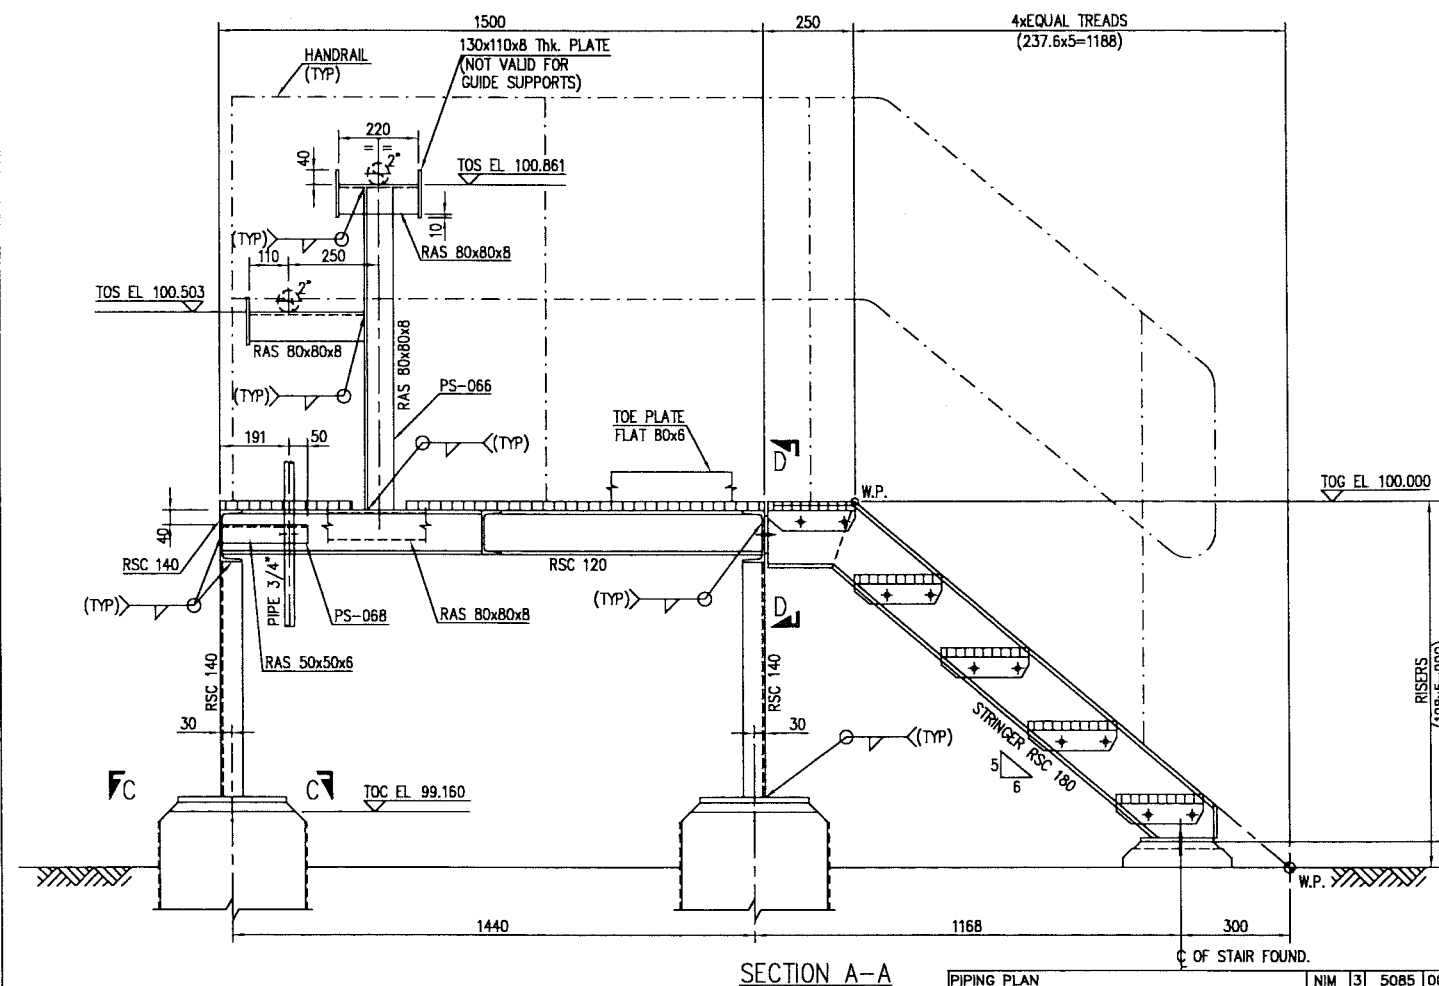


DESCRIPTION	AREA	SERIAL	SH	P	S
PIPING PLAN	NIM	3	5085	001	DQ 1
STAIR FOUNDATION MKD - SF1	NIM	2	5775	010	DQ 3
FOUNDATION DETAILS	NIM	2	5775	007	DQ 3
FOUNDATION LOCATION PLAN	NIM	2	5166	001	DQ 1
TYPICAL DETAIL OF GRATING	NIM	2	5771	004	DQ 3
TYPICAL DETAIL OF STAIR & HANDRAIL	NIM	2	5771	003	DQ 3
GEN. NOTES, LEGEND & ABBREVIATIONS (STEEL)	NIM	2	5771	002	DQ 3


DESCRIPTION	AREA	SERIAL	SH	P	S
PIPING PLAN	NIM	3	5085	001	DQ 1
STAIR FOUNDATION MKD - SF1	NIM	2	5775	010	DQ 3
FOUNDATION DETAILS	NIM	2	5775	007	DQ 3
FOUNDATION LOCATION PLAN	NIM	2	5166	001	DQ 1
TYPICAL DETAIL OF GRATING	NIM	2	5771	004	DQ 3
TYPICAL DETAIL OF STAIR & HANDRAIL	NIM	2	5771	003	DQ 3
GEN. NOTES, LEGEND & ABBREVIATIONS (STEEL)	NIM	2	5771	002	DQ 3

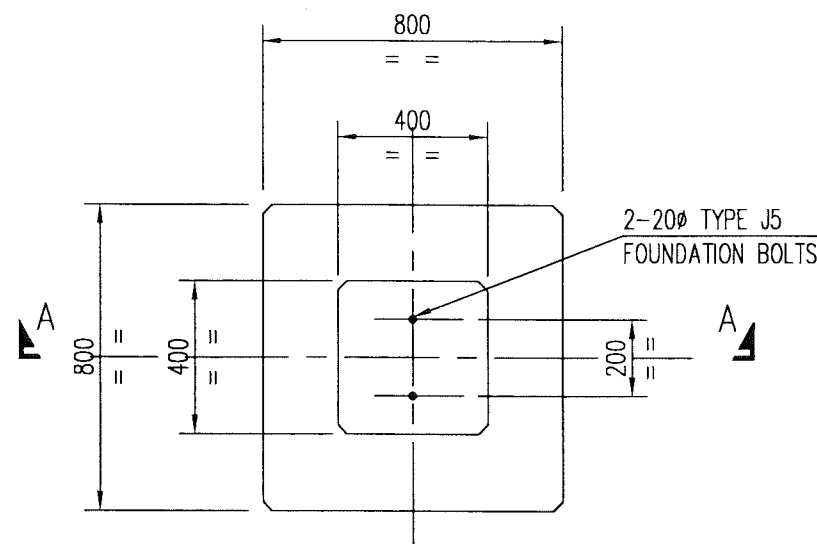


PLAN
(4 Nos. REQD.)

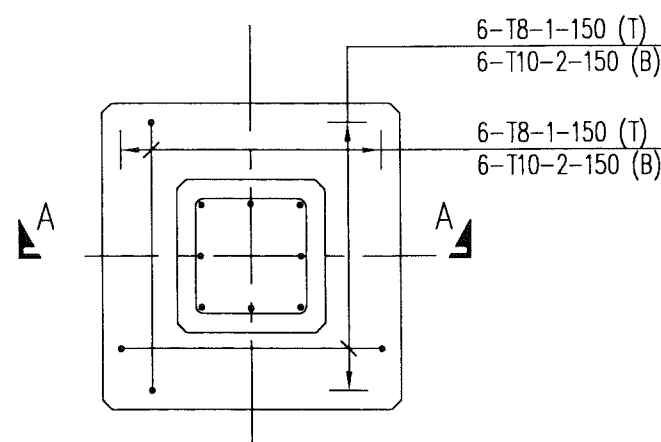

REINFORCEMENT PLAN

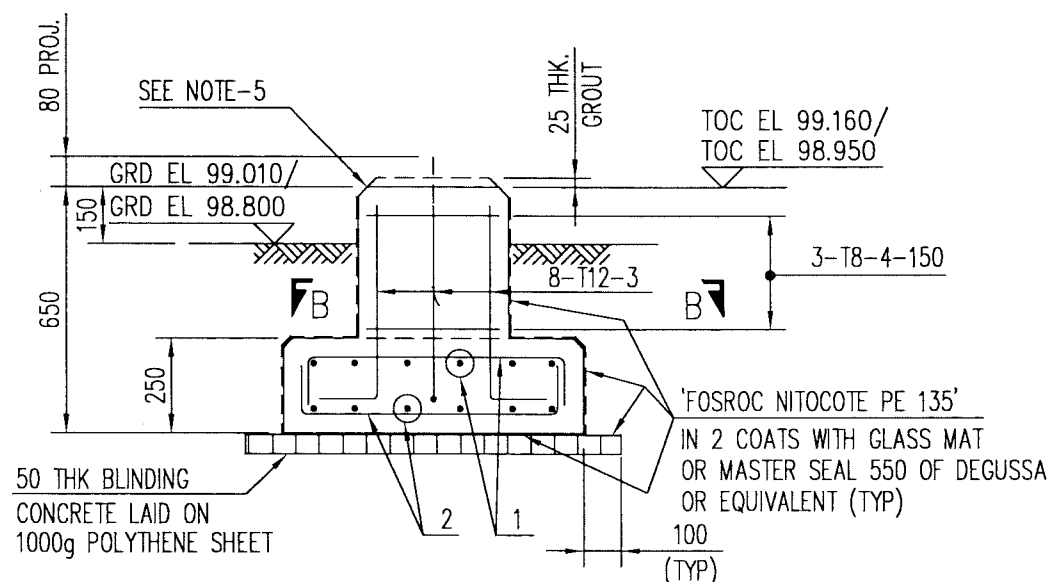

SECTION A - A

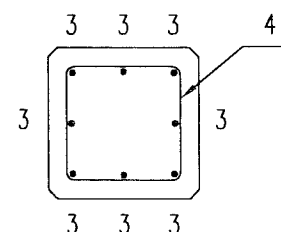

SECTION B - B

CONCRETE GRADE 35

M T O


DESCRIPTION	QUANTITY	UNITS	SAP No.
BLINDING CONCRETE GRADE 10	0.20	m ³	N.A.
CONCRETE GRADE 35	0.90	m ³	N.A.
CEMENT SAND GROUT	12.88	lit	N.A.
REINFORCEMENT STEEL	72.54	Kg	N.A.
PROTECTIVE COATING	11.68	m ²	N.A.
20φ FOUNDATION BOLT TYPE - J5	8	PCS	N.A.
1000g POLYTHENE SHEET	4.00	m ²	N.A.

NOTE: * DENOTES, SINCE GRADE ELEVATION VARIES, CONTRACTOR TO VERIFY ELEVATIONS AND DIMENSIONS AT SITE, PRIOR TO FABRICATION/CONSTRUCTION/INSTALLATION.

REFERENCE DRGS:-

- GENERAL NOTES, LEGEND & ABBREV. (CONC.) - NIM-2-5771-001-DQ-3
- FOUNDATION BOLTS - STD-2-3950-001-00-3
- PLATFORM DETAILS - NIM-2-5775-006-DQ-1
- PLATFORM DETAILS - NIM-2-5775-009-DQ-1
- LOCATION PLAN - NIM-2-5166-001-DQ-1
- BBS - NIM-2-5775-008-DQ-4

APPROVED FOR
CONSTRUCTION

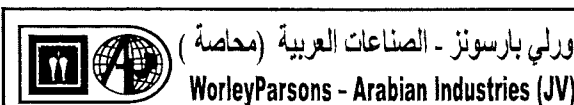

CONTRACT NO.: C31/0606 PROJ. NO.: PAIP00405

REV	DATE	DRAWN BY	TEAM L.	J. ENG.	CHECKED	DESCRIPTION	WBS No.	PROJ. ENG.	SIGNATURE
A	27.02.11	GCS	RB	Y		APPROVED FOR CONSTRUCTION	IN.09.011	OSE/28N	
0	26.02.11	GCS	KBR	GSB		ISSUED FOR COMMENTS	IN.09.011	OSE/28N	

PROJECT DRAWING REVISION

IN CASE OF DEVIATIONS A MARKED UP PRINT SHALL BE SENT TO THE PROJECT ENGINEER

2. ALL EXPOSED CONCRETE SURFACES SHALL BE TREATED WITH 2 COATS OF "FOSROC DEKGUARD S" WITH A DFT OF 350 MICRONS OR ANY OTHER APPROVED EQUIVALENT.							
1. ALL DIMENSIONS ARE IN MM, LEVELS ARE IN METERS.	REV	DATE	APPROVED BY	DESCRIPTION	WBS NO.	PROJ. ENG.	SPEC. ENG.

AREA : NIMR

SUB AREA : PRODUCTION STATION

DRWG. TYPE : CIVIL DETAILS

DESCRIPTION : FOUNDATION DETAILS MK'D-PF1

SCALE : 1:20 CAD DRAWING



DRWG	AREA CODE	ENG SECT	SERIAL NUMBER	SHEET	PROJ CODE	DWG SIZE	REV.
NO	NIM	2	5775	007	DQ	3	A



JOB NO.: PAIP00238
PART ID.: NIMR SLUDGE PIT SYSTEMS
PLATFORM-P3 & P4


Date: 27.02.11

Dia. Of Bar	T6	T8	T10	T12	T16	T20	T25	T32
Length of Bar (m)		60.90	44.40	23.20				
Weight (Kgs)		24.36	27.53	20.65				

72.540


1c. Murren
→ A2

Sheet No.: 1 of 1

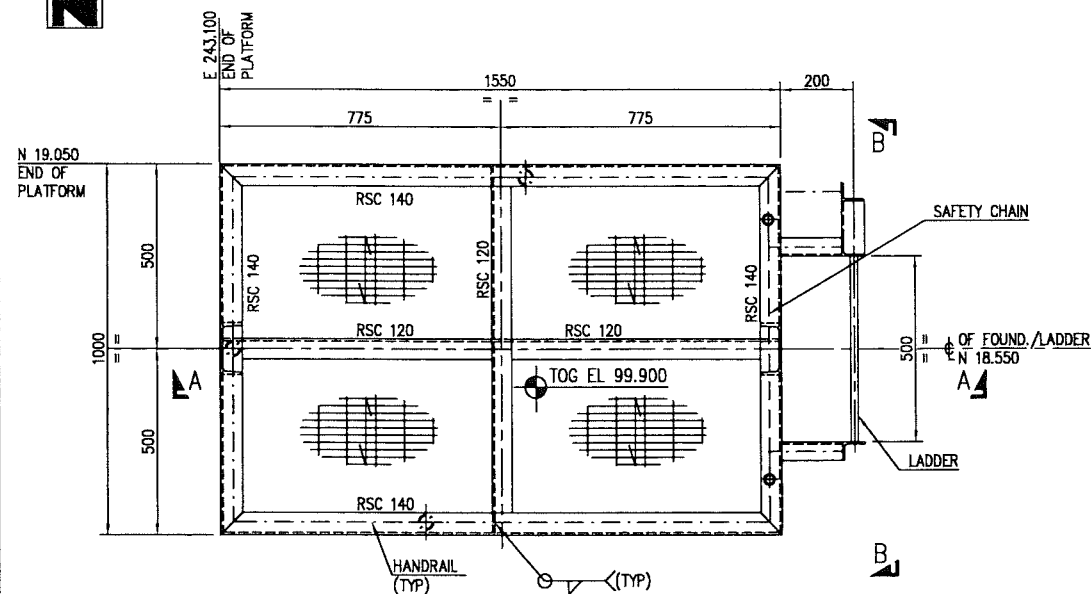


PLAN AT TOS EL 99.875



(FOR LOCATION REF. PIPING G.A. DRG. No. NIM-3-5391-001-DQ-1)

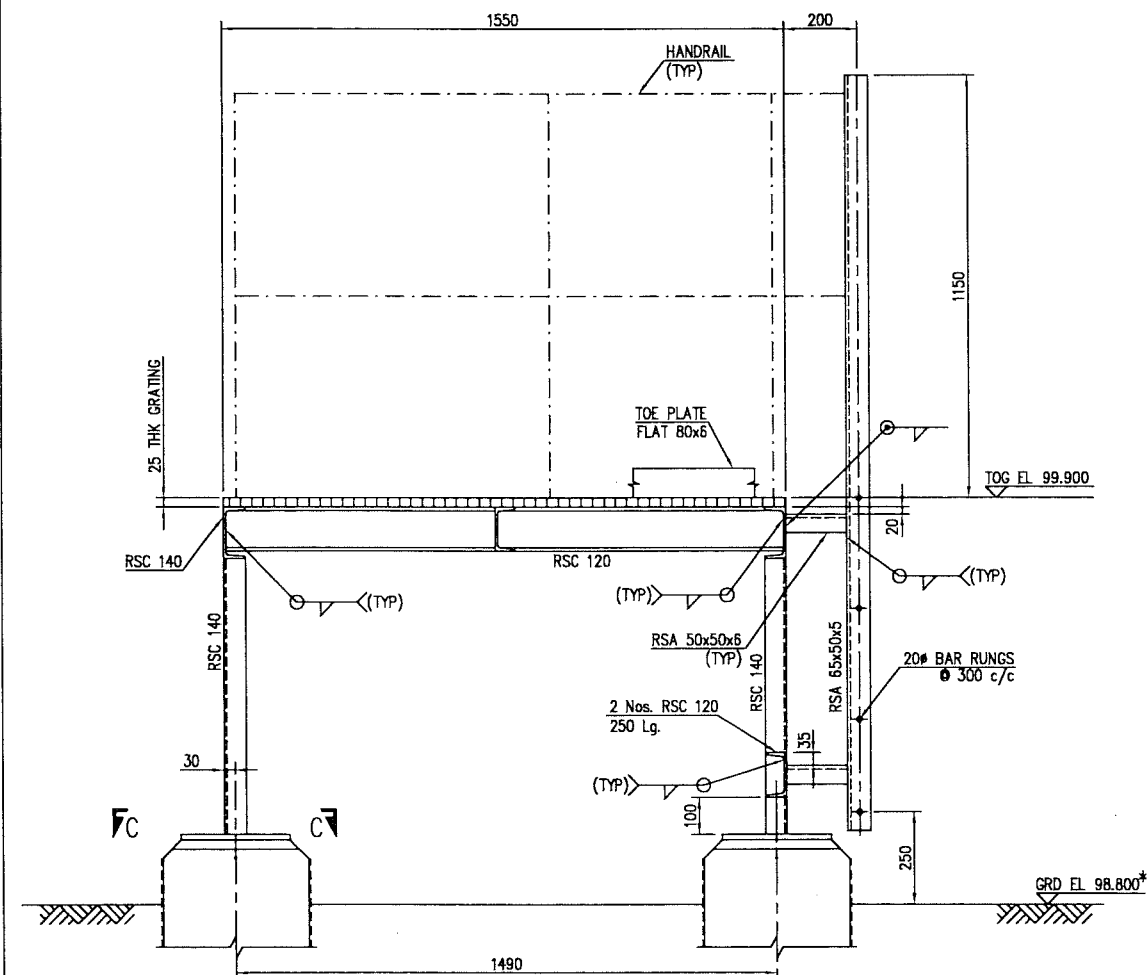

SECTION A-A

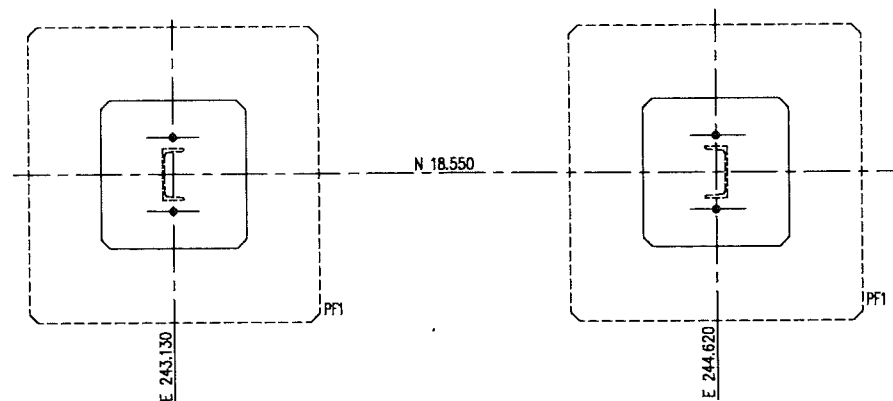

FOUNDATION PLAN

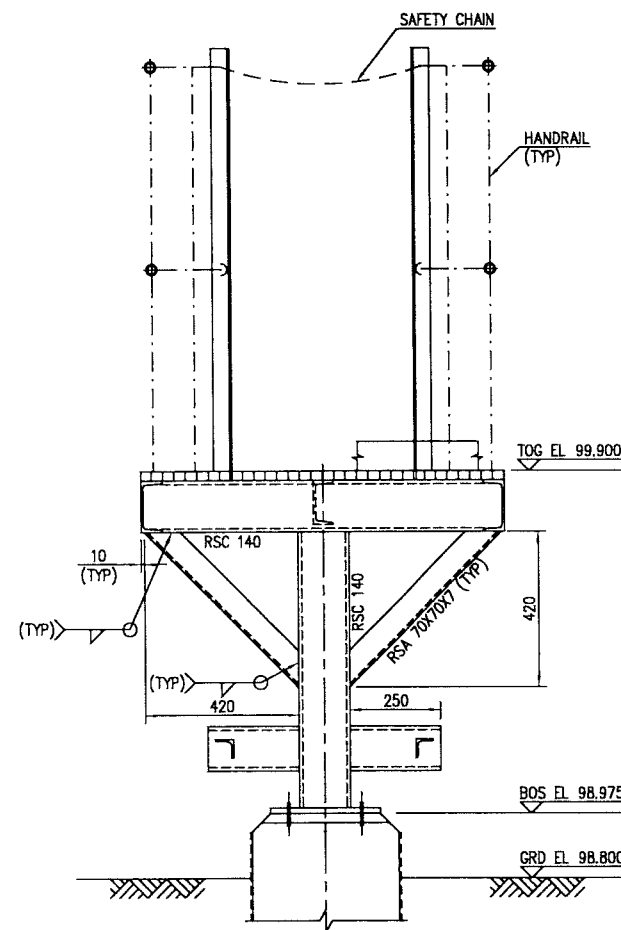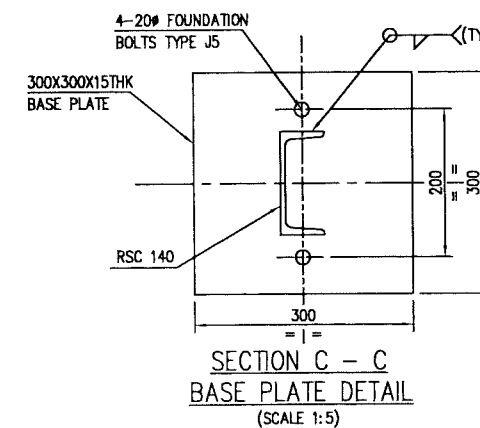

VIEW B-B

(LADDER NOT SHOWN FOR CLARITY)


1. ALL DIMENSIONS ARE IN MILLIMETRES AND ELEVATIONS IN METRES.

NOTES

PIPING PLAN	NIM	3	5391	001	DQ	1
FOUNDATION DETAILS	NIM	2	5775	007	DQ	3
FOUNDATION LOCATION PLAN	NIM	2	5166	001	DQ	1
TYPICAL LADDER DETAILS (FRONT ENTRY)	NIM	3	5771	006	DQ	3
TYPICAL DETAIL OF GRATING	NIM	2	5771	004	DQ	3
TYPICAL DETAIL OF STAIR & HANDRAIL	NIM	2	5771	003	DQ	3
GEN. NOTES, LEGEND & ABBREVIATIONS (STEEL)	NIM	2	5771	002	DQ	3

REFERENCE DRAWINGS

MASTER DRAWING REVISION
IN CASE OF DEVIATIONS MARKED UP PRINT SHALL BE SENT TO COASTAL DESIGN OFFICE

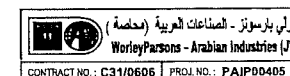

CONTRACT NO.: C310606 PROJ. NO.: PAIP00405

REV	DATE	BY	TEAM	CHKD	DESCRIPTION	REV NO	PROJ. ENR.	SIGNATURE	P.D.O. APPROVAL
A	27.02.11	GCS	KBR	GSB	APPROVED FOR CONSTRUCTION		IN.09.011	OSE/2BN	
O	26.02.11	GCS	KBR	GSB	ISSUED FOR COMMENTS		IN.09.011	OSE/2BN	
PROJECT DRAWING REVISION									
IN CASE OF DEVIATIONS A MARKED UP PRINT SHALL BE SENT TO THE PROJECT ENGINEER									
AREA	NIMR								
SUB AREA	PRODUCTION STATION								
DRWG. TYPE	STRUCTURAL STEEL DETAILS								
DESCRIPTION	PLATFORM MK'D-P2								
NO	NIM 2 5775 009 DQ 1 A								

ic. Amner
TA2

APPROVED FOR
CONSTRUCTION

BAR BENDING SCHEDULE

JOB NO.: PAIP00238
PART ID.: NIMR SLUDGE PIT SYSTEMS
STAIR FOUNDATION

Document No.: NIM-2-5775-011-DQ-4

Revision No.: A

Prepared by: GCS

Checked by: PNG

Date: 27.02.11

REF. DWG NO.: NIM-2-5775-010-DQ-3

Total MTO for Rebars.

Dia. Of Bar	T6	T8	T10	T12	T16	T20	T25	T32
Length of Bar (m)		14.40	7.65	11.25				
Weight (Kgs)		5.76	4.75	10.02				

Total Weight (Kgs)

20.530

K. Munn
TA2

[illegible]

This schedule complies with BS 8666 : 2005

All dimensions are in mm


Refer to Bar shape Code drawing

* Specified in multiples of 5 mm

† Specified in multiples of 25 mm

Mechanical Drawings

PAIP00405- Nimr Sludge Pit Up gradation.

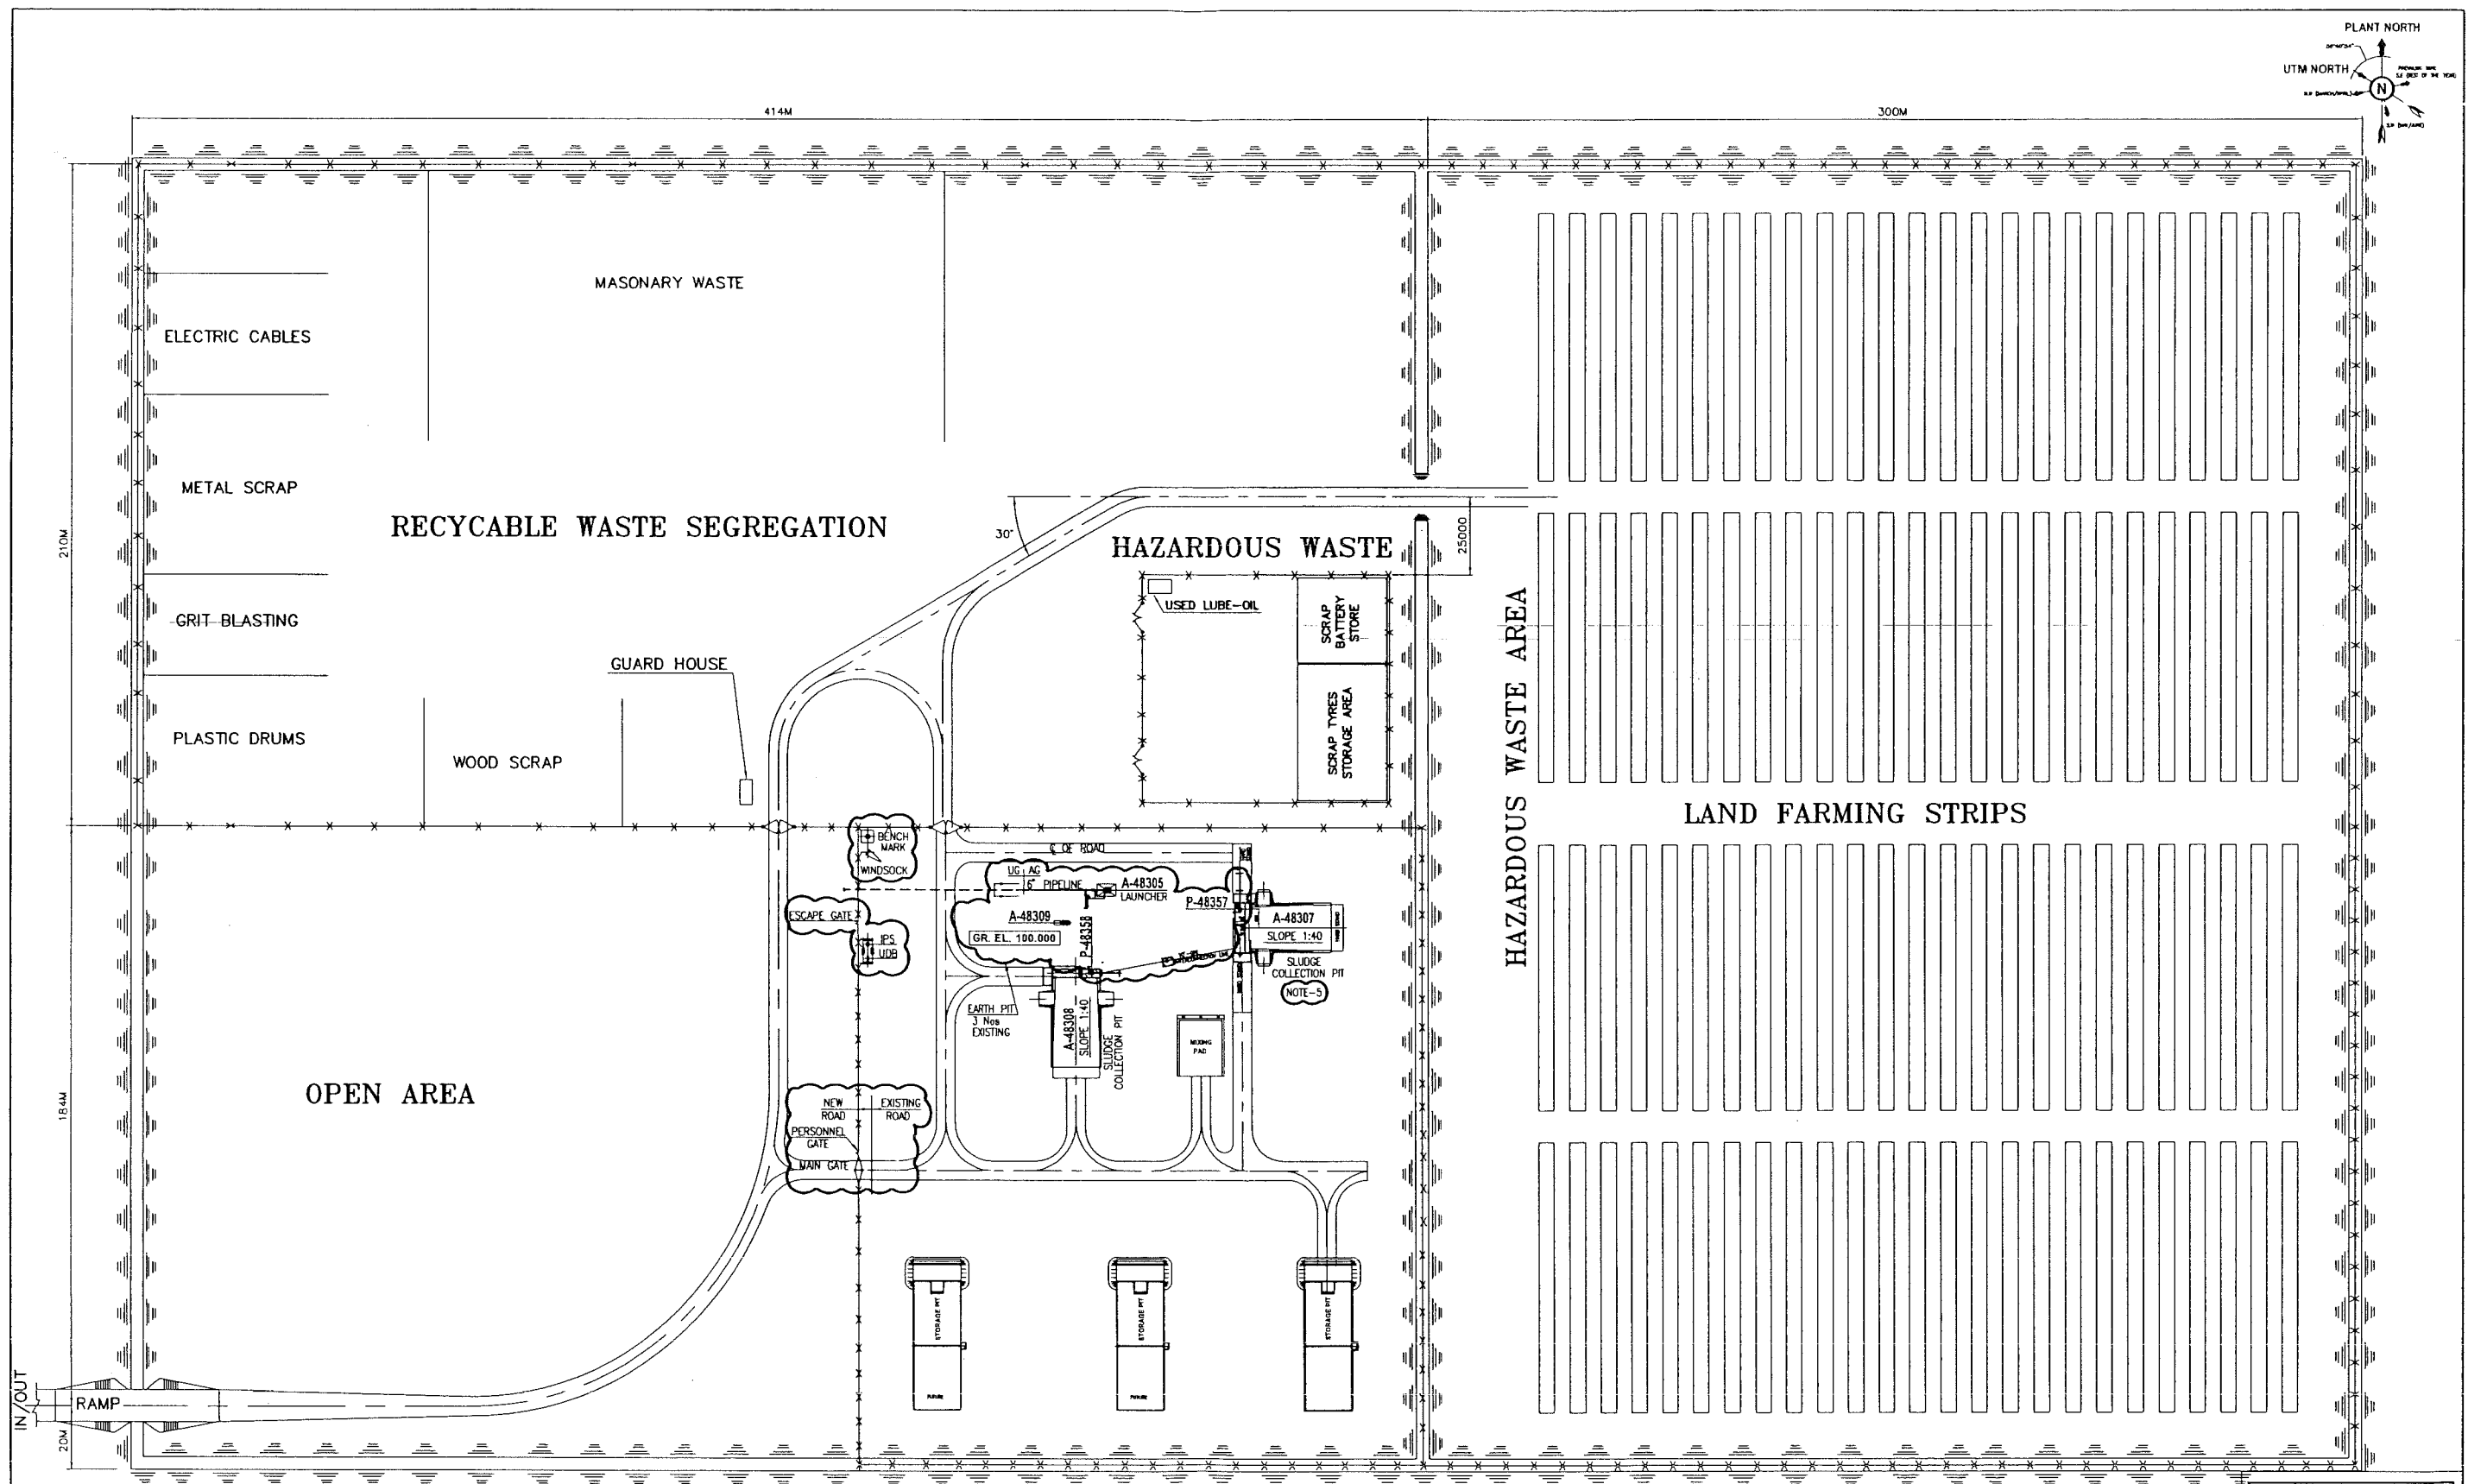


SCOPE OF PROJECT
WBS NO.
NIM.IN.09.011

THIS DRAWING IS MADE BASED ON
WBS No.01.223
PROJ. CODE- 4T

DESCRIPTION : ISSUED FOR IDB			
REV.	0.1	DRN. BY	MIS
		CHKD. BY	VNB
DATE	APR.'10	APPRO. BY	HOD

APPROVED FOR
CONSTRUCTION

B	APR.'11	MIS	APPROVED FOR CONSTRUCTION	IN.05.011	OSE/28N
A	JAN.'11	MIS	APPROVED FOR DESIGN	IN.05.011	OSE/28N
Q	JUL.'10	MIS	ISSUED FOR COMMENTS	IN.05.011	OSE/27N
REV	DATE	DRAWN BY	DESCRIPTION	WES. NO.	PROJ. ENG. SIGNATURE


 (محاصة) الصناعات العربية - وورلي بارسونز
 WorleyParsons-Arabian Industries (

CONTRACT NO.: C31/0606 PROJ. NO.: PAIP00405

PROJECT DRAWING REVISION												
IN CASE OF DEVIATIONS A MARKED UP PRINT SHALL BE SENT TO THE PROJECT ENGINEER												
DATE	NIMR				SCALE: 1:1000				CAD DRAWING			
					0	1	2	3	4	5	6	7

SUB AREA	CONTR. IND. & RES. AREA	NO. 05	شركة تنمية نفط عمان Petroleum Development Oman
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OVERALL LOT PLAN		DWG	AREA	ENG	SERIAL	SHEET	PROJ	DWG	REV.
DESCRIPTION		NO	CODE	SET	NUMBER		CODE	SIZE	
LAYOUT OF WASTE MANAGEMENT COMPLEX		NIM	1	9982	001DQ	1	B		


5. AS-BUILT INFORMATION OF NEW SLUDGE PIT ADDED.
4. EXISTING FENCE TO BE RE-USED.
3. FENCE TO BE DIMINISHED & REUSED AT NEW LOCATION.
2. GRADE ELEVATION 100.000 m. IS EQUAL TO EL. (HOLD) ABOVE M.S.L.
1. ALL CO-ORDINATES & ELEVATION ARE IN m AND DIMENSIONS ARE IN mm.

DRAWING CONTROL INDEX	NIM	1	2635	300	00	
KEY PLAN FOR PLOT PLAN	NIM	1	3709	001	00	
MIXING PAD DETAILS.	NIM	2	9993	001		
SLUDGE COLLECTION FACILITY, G.A. & DETAILS.	NIM	2	9992	001		
OVERALL LAYOUT CONTRACTOR'S CAMP AREA.	NIM	1	9981	001		

DESCRIPTION	AREA	S	SERIAL	DL	P
	DRAWING NUMBER				
REFERENCE DRAWINGS					

REV	DATE	APPROVED BY	DESCRIPTION	SHEET NO.	PROLOG	SPEC
					FOR APPROVAL	
MASTER DRAWING REVISION						
IN CASE OF DEVIATIONS MARKED UP PRINT SHALL BE SENT TO COASTAL DESIGN OFFICE						

W:\3_Piping\WPA-PDO EMC JOBS (C310608)\PROJECTS\PAIP-PROJECT-JOBS\PAIP00405_DQ\19982001_DQ.dwg 04-APR-2011 2:57:25 PM Mohd, Sheikh

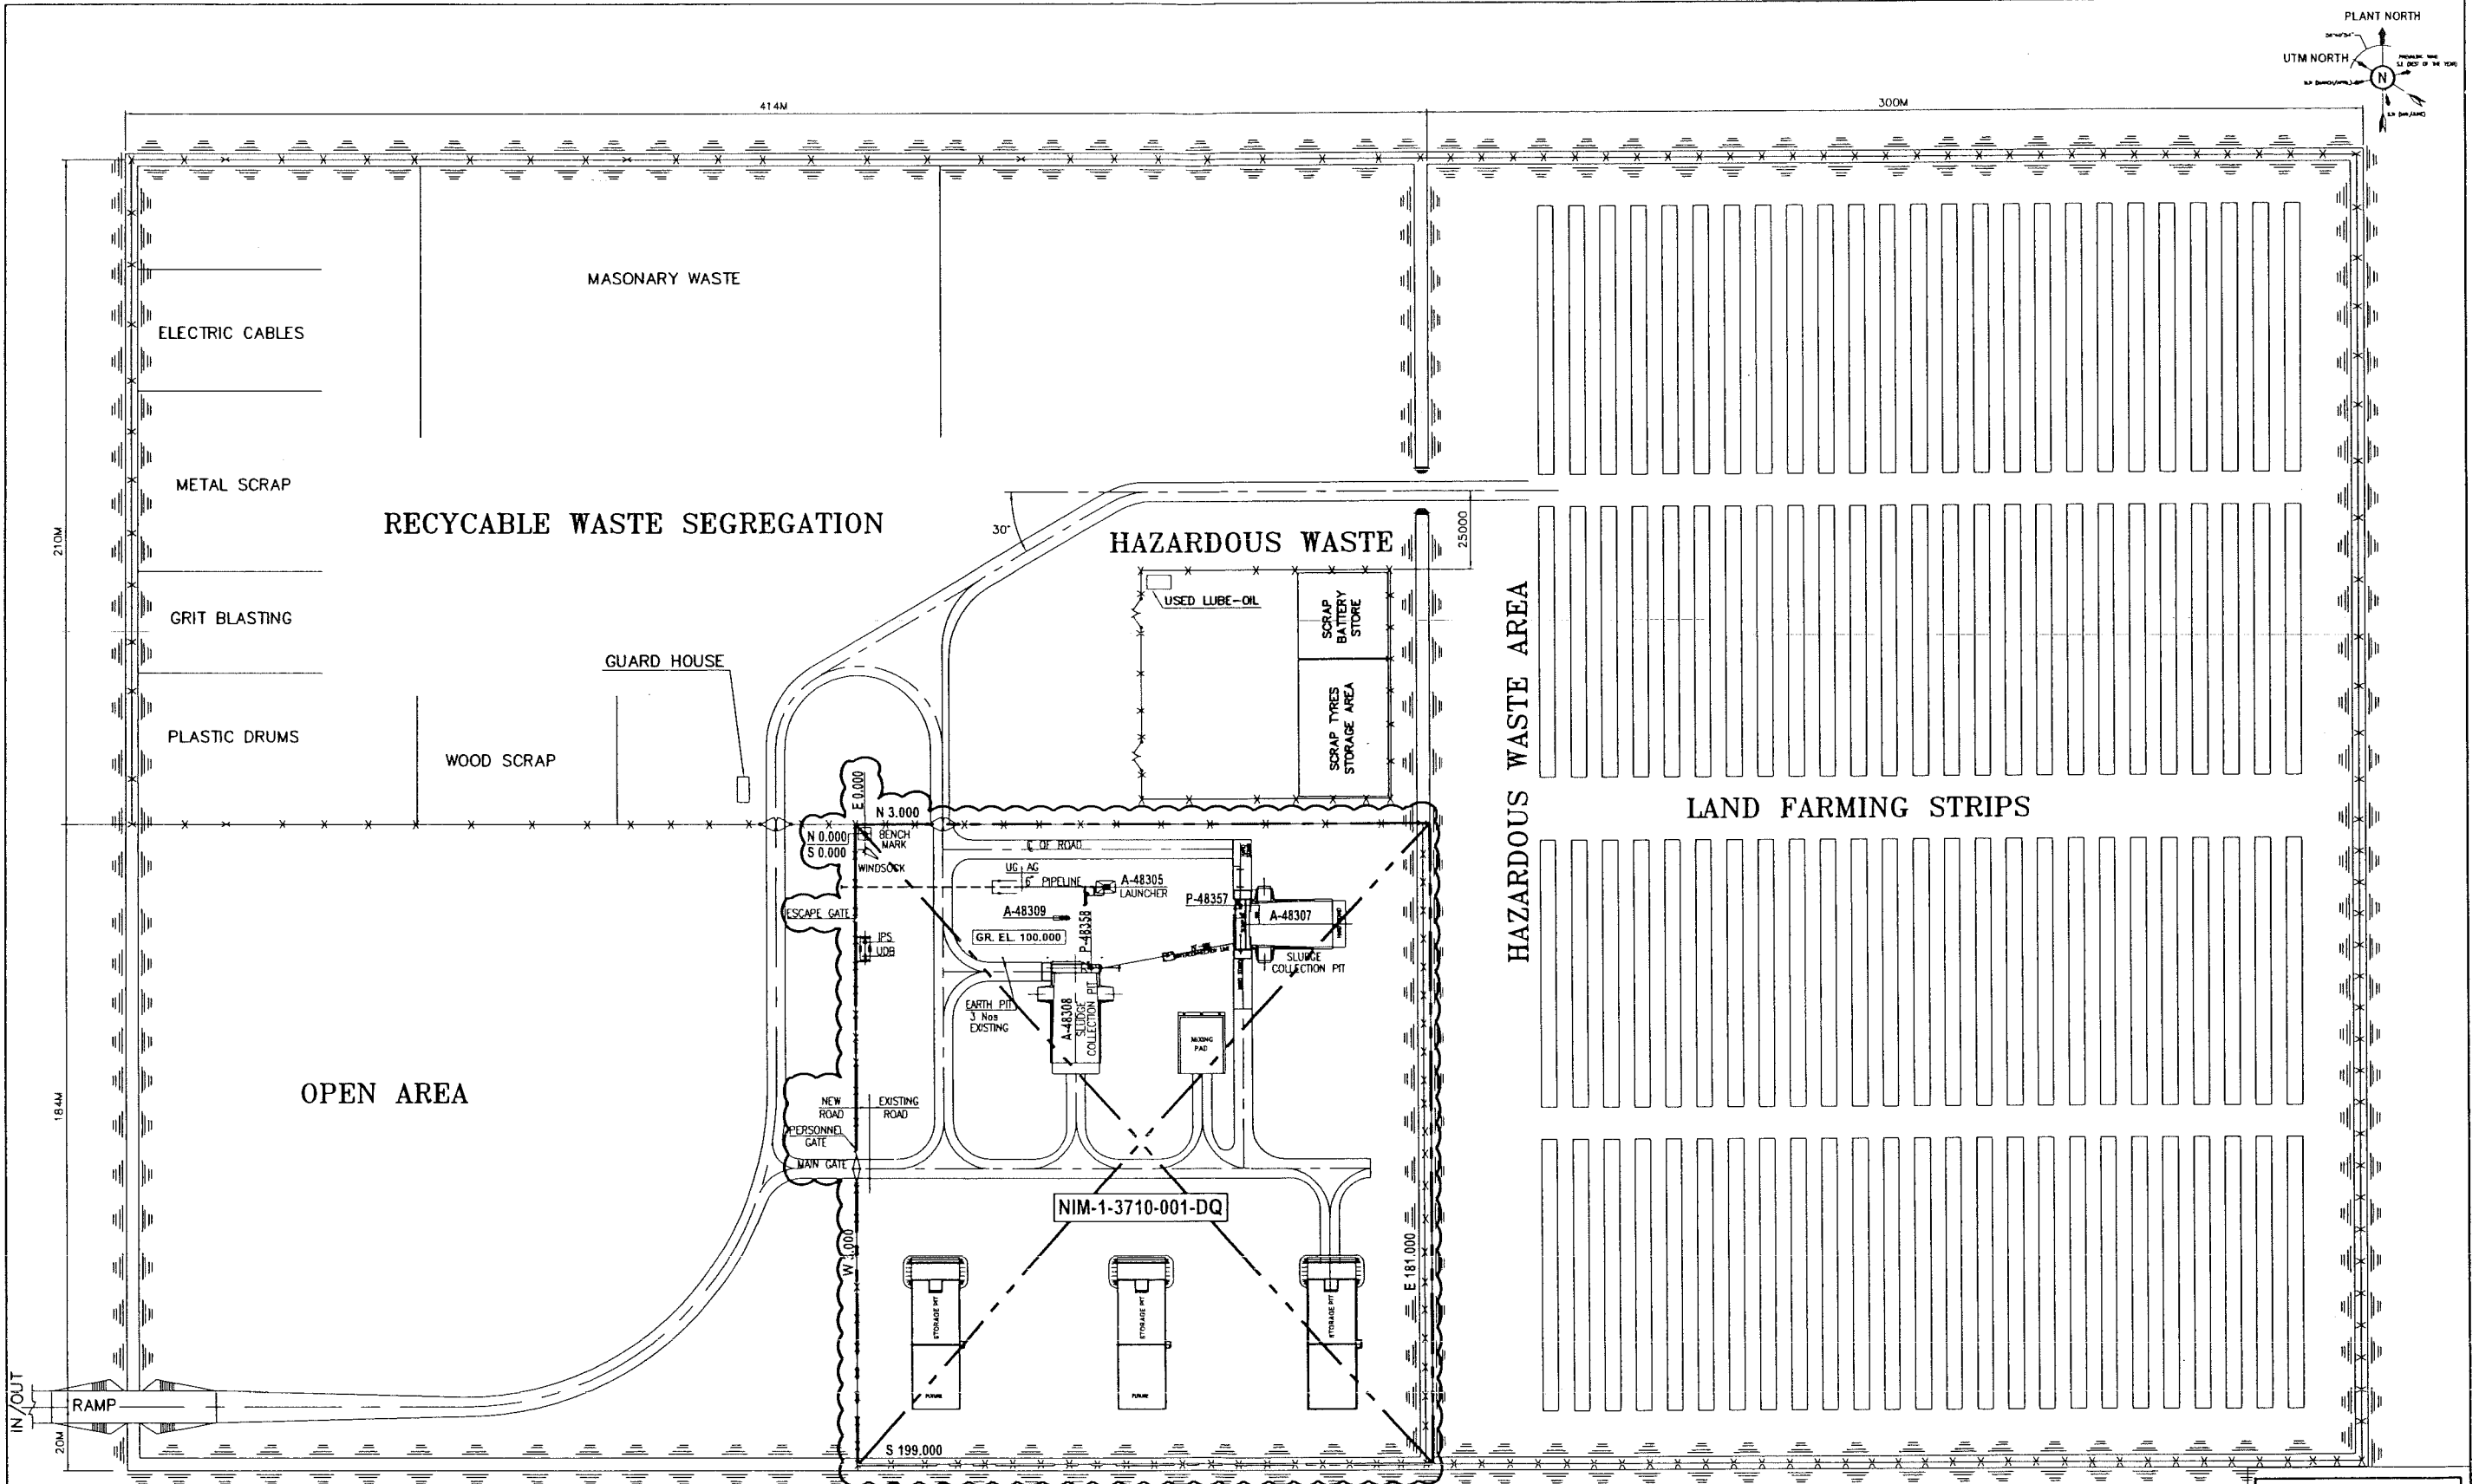

LEGEND:-

- INDICATES DRAWING EXISTS FOR AREAS
- INDICATES DRAWING NUMBER ONLY ALLOCATED FOR AREAS

DO NOT USE THIS DRG. AS PLOT PLAN

SCOPE OF PROJECT
WBS NO. NIM.IN.09.011

THIS DRAWING IS MADE NEW FOR
WBS No. NIM.IN.09.011
PROJ. CODE- DQ

REV.	DATE	BY	CHKD. BY	APPD. BY	DESCRIPTION
0.1	JUN '10	MIS	WMB	HOD	ISSUED FOR JOB

CONTRACT NO. : C31/0606 PROJ. NO. : PAIP00405

APPROVED FOR CONSTRUCTION

IN CASE OF DEVIATIONS A MARKED UP PRINT SHALL BE SENT TO THE PROJECT ENGINEER

AREA : NIMR

SUB AREA : CONTR. IND. & RES. AREA

KEY PLAN FOR PLOT PLAN

LAYOUT OF WASTE MANAGEMENT COMPLEX

SCALE : 1:1000

NO. 05

WorleyParsons-Arabian Industries (JV)

PROJECT DRAWING REVISION

REV.	DATE	BY	CHKD.	APPD.	DESCRIPTION
B	APR '11	MIS	WMB	JA	APPROVED FOR CONSTRUCTION
A	JAN '11	MIS	WMB	JA	APPROVED FOR DESIGN
0	JUL '10	MIS	WMB	ANP	ISSUED FOR COMMENTS

IN CASE OF DEVIATIONS MARKED UP PRINT SHALL BE SENT TO COASTAL DESIGN OFFICE



NOTES

2. GRADE ELEVATION 100.000 m. IS EQUAL TO EL. (HOLD) ABOVE M.S.L.

1. ALL CO-ORDINATES & ELEVATION ARE IN m AND DIMENSIONS ARE IN mm.

REFERENCE DRAWINGS

NO.	DESCRIPTION	DATE	BY	CHKD.	APPD.
NIM 1 2635 300 DQ 4					
NIM 1 9982 001 DQ 1					

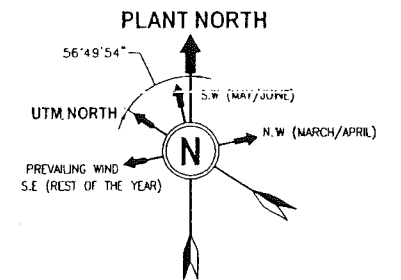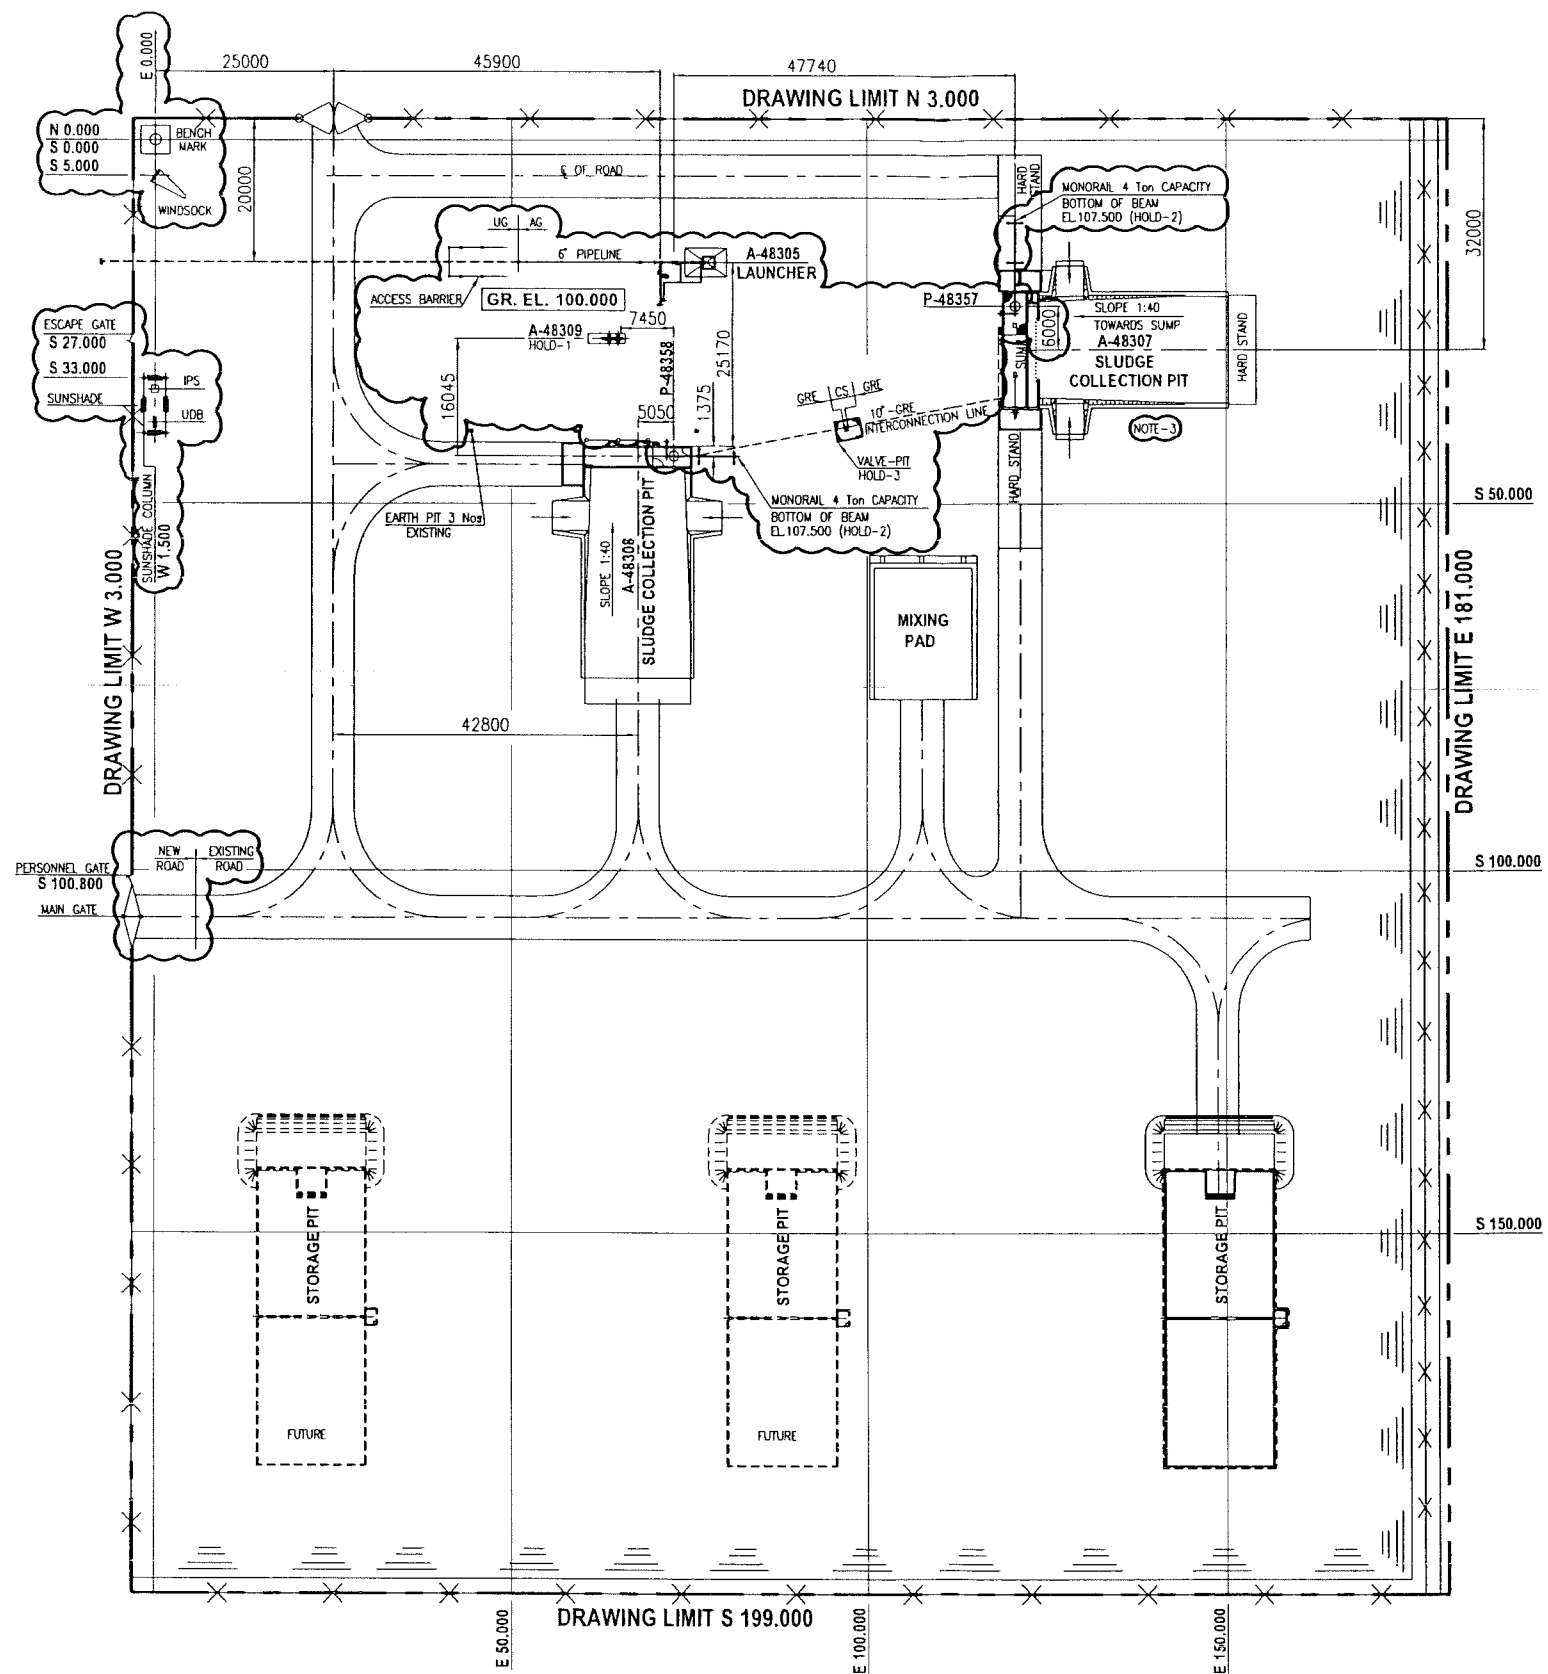

EQUIPMENT DATA	
EQPT. TAG NO.	DESCRIPTION
A-48307	SLUDGE COLLECTION PIT
A-48308	SLUDGE COLLECTION PIT
A-48305	PIG-LAUNCHER
A-48309	OXYGEN SCAVENGER SKID
P-48357	SLUDGE OIL TRANSFER PUMP
P-48358	SLUDGE OIL TRANSFER PUMP



SCOPE OF PROJECT
WBS NO.
NIM.IN.09.011

THIS DRAWING IS MADE NEW FOR
WBS No.NIM.IN.09.011
PROJ. CODE - DQ

DESCRIPTION : ISSUED FOR IDB									
REV.	DATE	DRN. BY	CHKD. BY	APPRD. BY	DATE	REV.	DATE	DRN. BY	CHKD. BY
0.1	MAY'10	MSB	VMB	HDD		B	APR'11	MIS	WMB
					A	JAN'11	MIS	WMB	JA
					O	JUL'10	MIS	WMB	NNP
					APPROVED FOR CONSTRUCTION				
					APPROVED FOR DESIGN				
					ISSUED FOR COMMENTS				
					PROJECT DRAWING REVISION				
					IN CASE OF DEVIATIONS A MARKED UP PRINT SHALL BE SENT TO THE PROJECT ENGINEER				

CONTRACT NO.: C31/0606 PROJ. NO.: PAIP00405									
AREA	SUB AREA	DRWG TYPE	DESCRIPTION	WBS NO.	PROJ. NO.	SPEC. NO.	PROJ. NO.	SPEC. NO.	PROJ. NO.
NIMR	WASTE MANAGEMENT COMPLEX	PLOT PLAN	SLUDGE COLLECTION AREA						
NO. NIM 1 3710 001 DQA1 B				SCALE: 1:500					

NOTES									
3. AS-BUILT INFORMATION OF NEW SLUDGE PIT ADDED.									
2. GRADE ELEVATION 100.000 m. IS EQUAL TO EL. HOLD ABOVE M.S.L.									
1. ALL CO-ORDINATES & ELEVATIONS ARE IN m. AND DIMENSIONS ARE IN mm.									
HOLD: -									

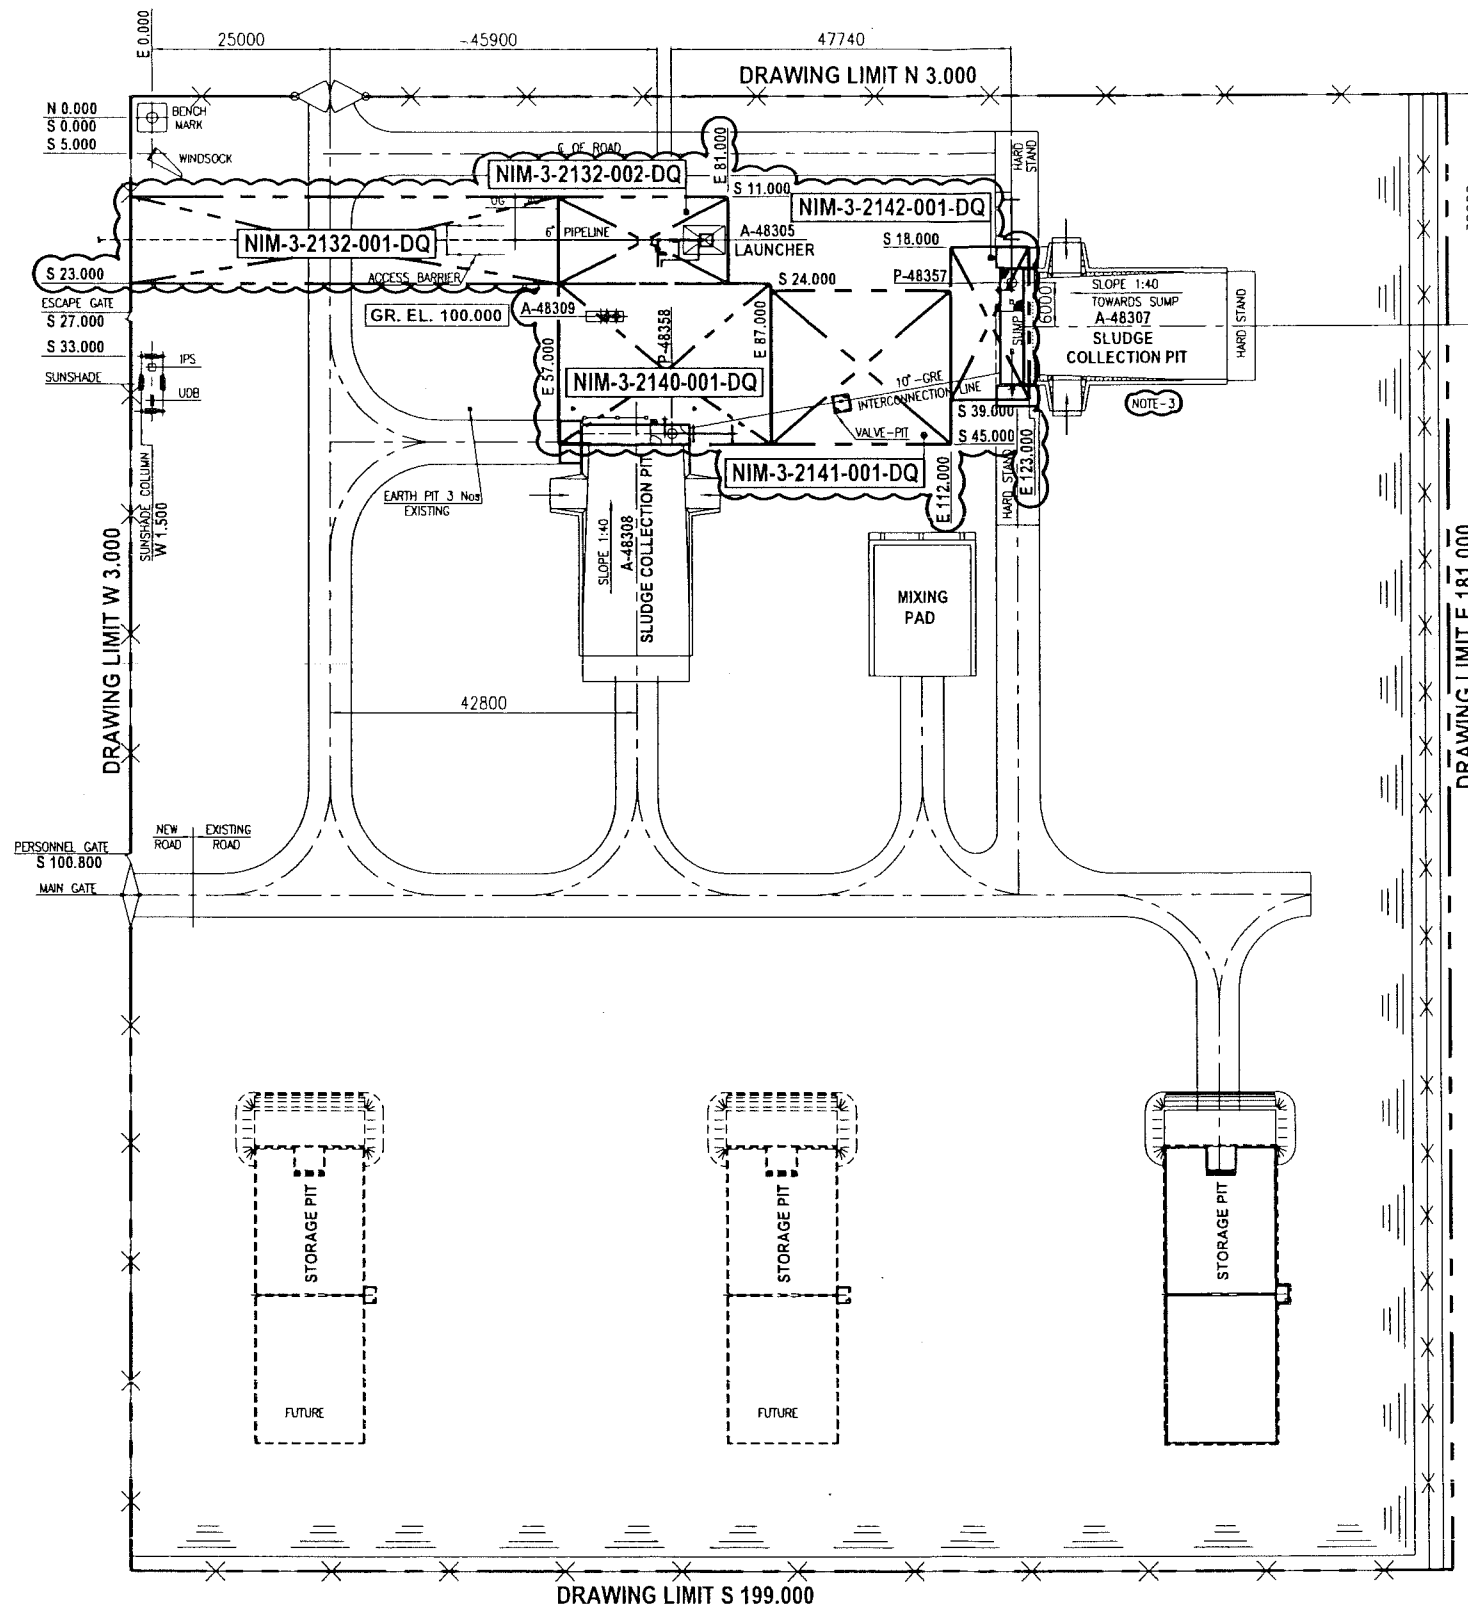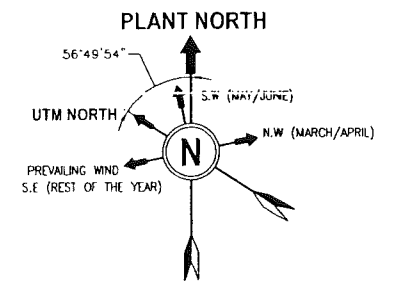

EQUIPMENT DATA	
EQPT. TAG NO.	DESCRIPTION
A-48307	SLUDGE COLLECTION PIT
A-48308	SLUDGE COLLECTION PIT
A-48305	PIG LAUNCHER
A-48309	OXYGEN SCAVENGER SKID
P-48357	SLUDGE OIL TRANSFER PUMP
P-48358	SLUDGE OIL TRANSFER PUMP

APPROVED FOR
CONSTRUCTION

THIS IS KEY PLAN ONLY AND
NOT TO BE USE AS A PLOT PLAN

SCOPE OF PROJECT
WBS NO.
NIM.IN.09.011

THIS DRAWING IS MADE NEW FOR
WBS No. NIM.IN.09.011
PROJ. CODE - DQ

DESCRIPTION : ISSUED FOR I.D.R.		REV. 0.1		DATE NOV.10		CHKD. BY VMB		APPRD. BY HJ		A APR.11		MIS		APPROVED FOR CONSTRUCTION		IN.09.011		OSE/28N	
CONTRACT NO. : C310606		PROJ. NO. : PAIP00405		DATE DEC.10		CHKD. BY VMB		APPRD. BY HJ		A APR.11		MIS		APPROVED FOR COMMENTS		IN.09.011		OSE/28N	
WorleyParsons-Arabian Industries (WPI)		WorleyParsons-Arabian Industries (WPI)		DATE DEC.10		CHKD. BY VMB		APPRD. BY HJ		A APR.11		MIS		APPROVED FOR COMMENTS		IN.09.011		OSE/28N	
PROJECT DRAWING REVISION		IN CASE OF DEVIATIONS A MARKED UP PRINT SHALL BE SENT TO THE PROJECT ENGINEER		SCALE : 1:500		CAD DRAWING		NO. 05		SUB AREA : NIMR SLUDGE PIT		DESCRIPTION : PIPING KEY PLAN		SLUDGE COLLECTION AREA		NO. NIM 3 2137 001 DQ A1 A			

3. AS-BUILT INFORMATION OF NEW SLUDGE PIT ADDED.
2. GRADE ELEVATION 100.000 m. IS EQUAL TO EL. HOLD ABOVE M.S.L.
1. ALL CO-ORDINATES & ELEVATIONS ARE IN m. AND DIMENSIONS ARE IN mm.

NOTES

HOLD: --

DESCRIPTION	DRAWING NUMBER	DATE	APPROVED BY
DRAWING CONTROL INDEX	NIM 1 2635	300 DO 4	
PLOT PLAN	NIM 1 3710	001 DO 1	
OVERALL PLOT PLAN	NIM 1 9982	001 DO 1	

DESCRIPTION	DRAWING NUMBER	DATE	APPROVED BY
REFERENCE DRAWINGS	NIM 1 2635	300 DO 4	
	NIM 1 3710	001 DO 1	
	NIM 1 9982	001 DO 1	

DESCRIPTION	DRAWING NUMBER	DATE	APPROVED BY
MASTER DRAWING REVISION	NIM 1 2635	300 DO 4	
	NIM 1 3710	001 DO 1	
	NIM 1 9982	001 DO 1	

DESCRIPTION	DRAWING NUMBER	DATE	APPROVED BY
IN CASE OF DEVIATIONS MARKED UP PRINT SHALL BE SENT TO COASTAL DESIGN OFFICE	NIM 1 2635	300 DO 4	
	NIM 1 3710	001 DO 1	
	NIM 1 9982	001 DO 1	




MATCHLINE S 23.000
FOR CONT. REFER PIPELINE DRG. NIM-3-2132-002-DQ

S 24.000

DRAWING LIMIT E 57.000

MATCHLINE E 87.000
C.O.D. NIM-3-2141-001-DQ

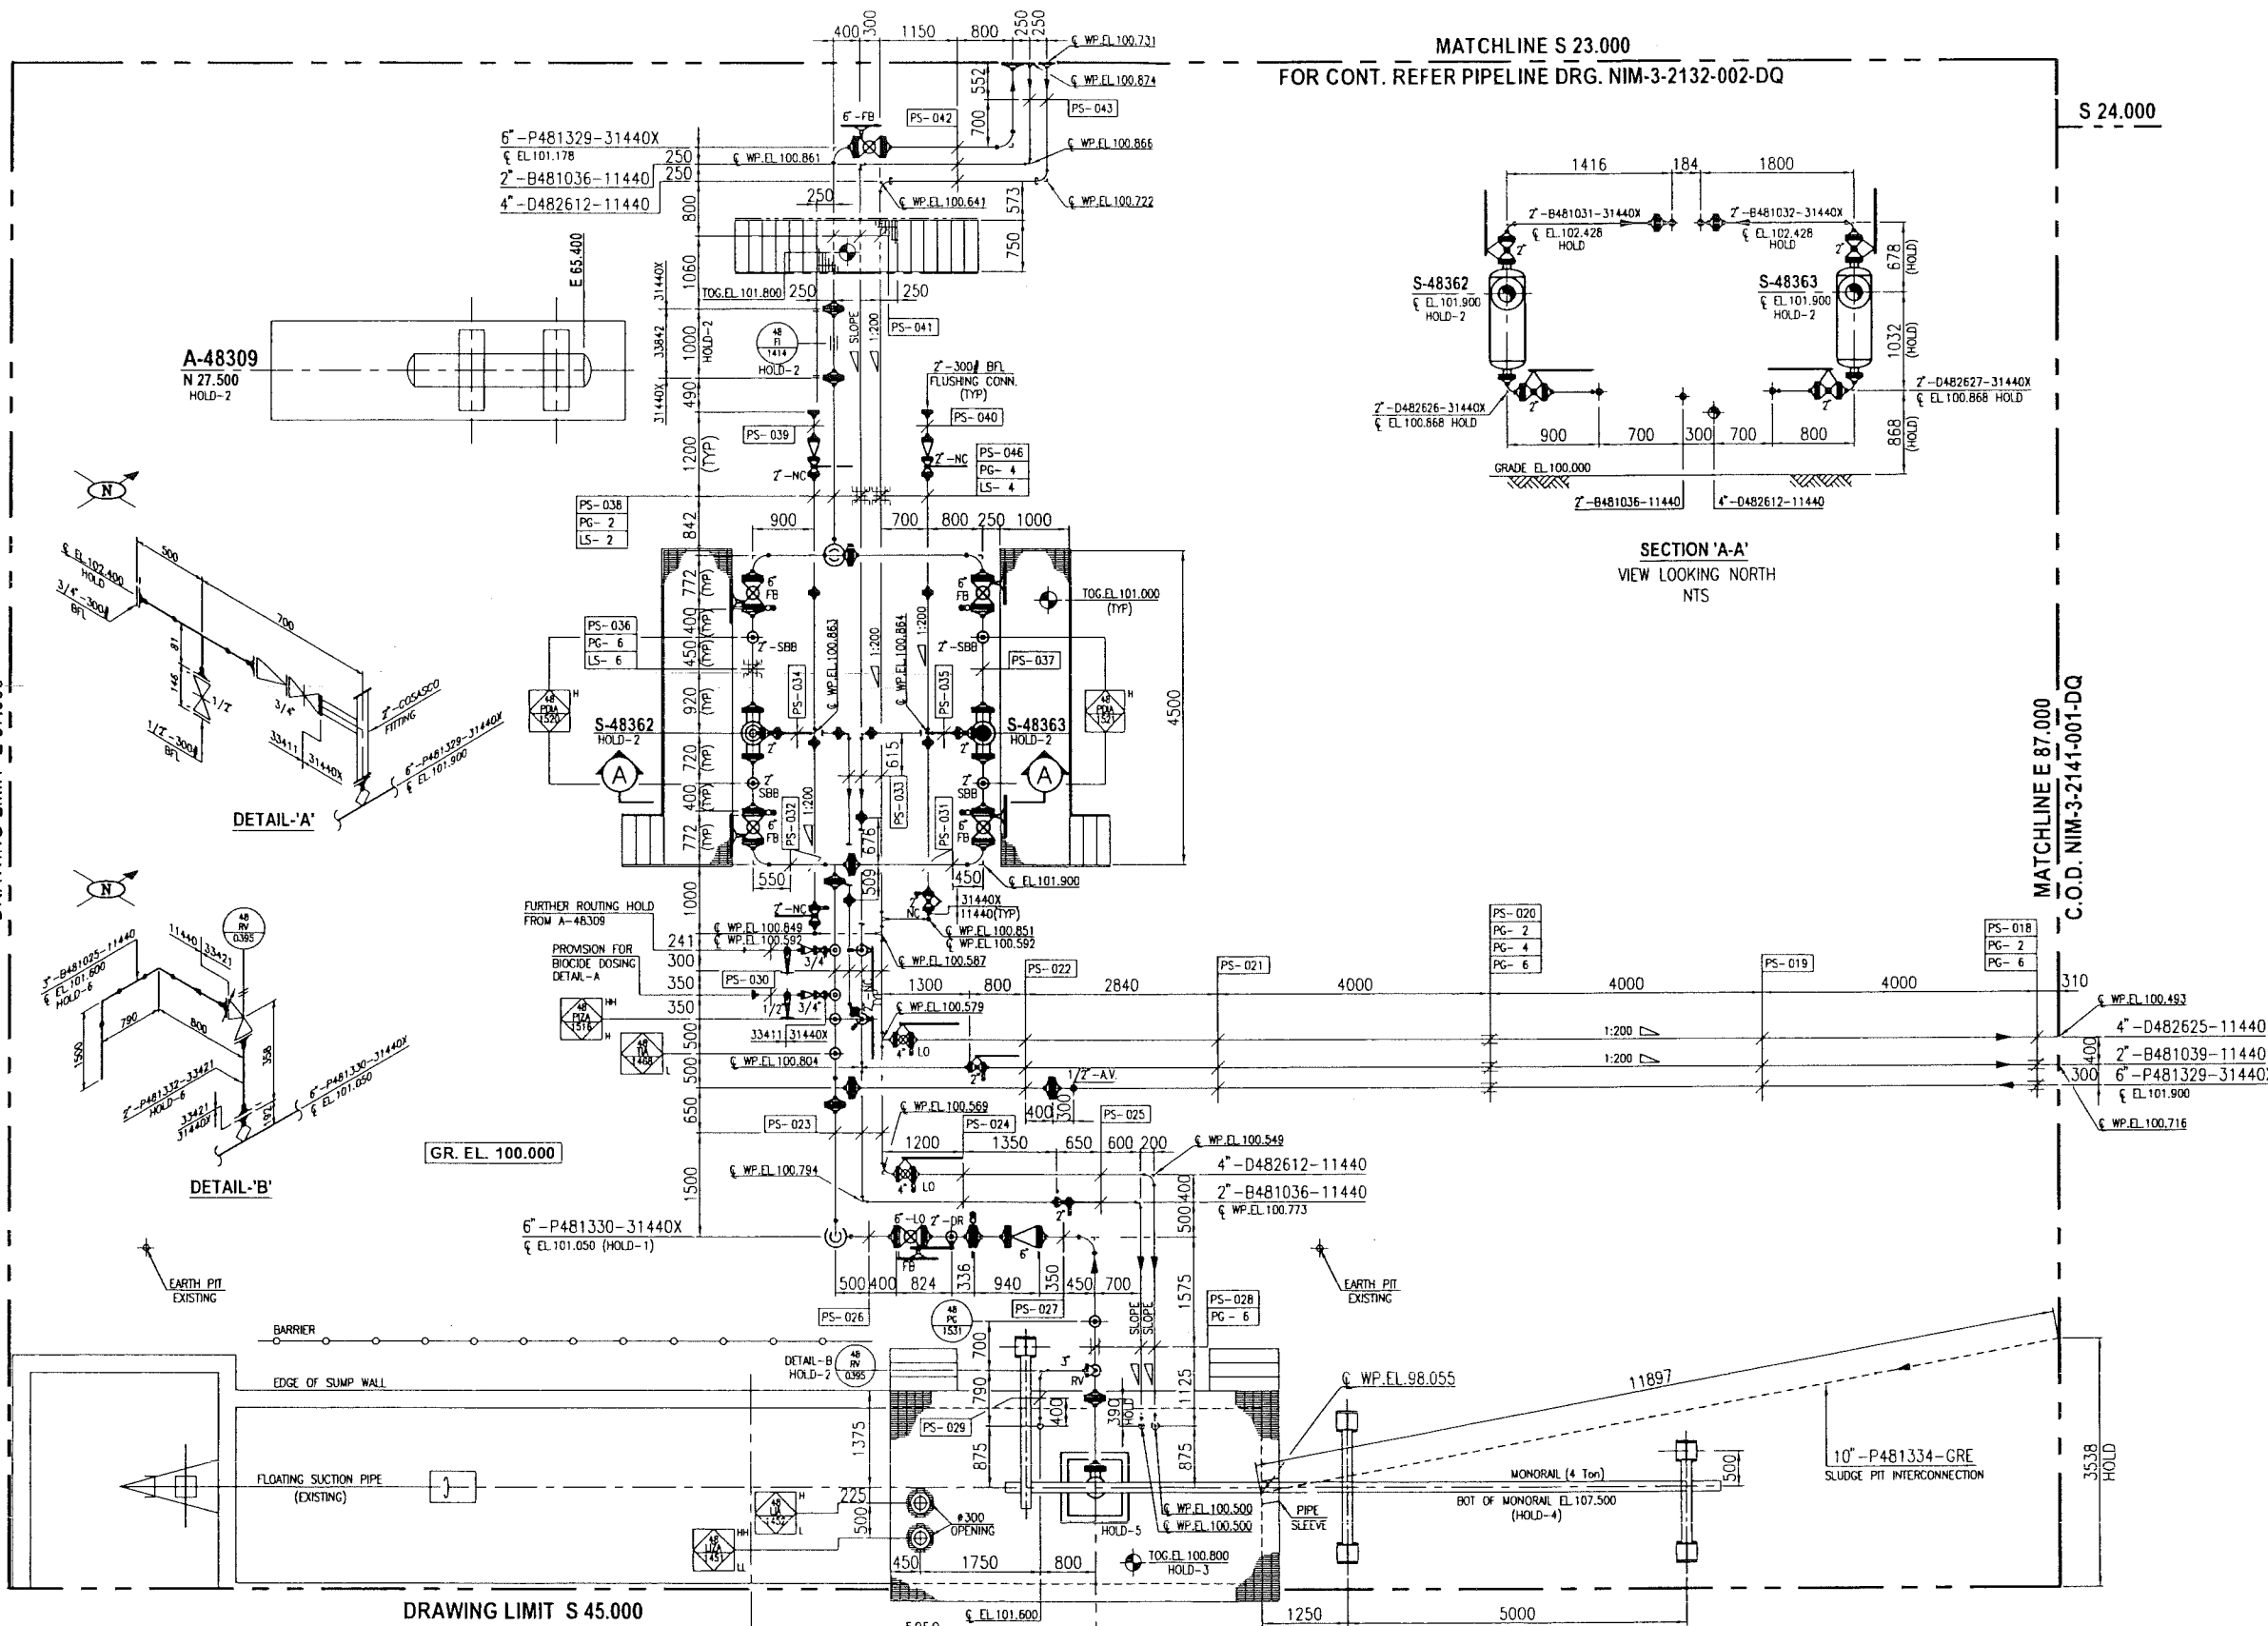

DETAIL 'A'

DETAIL 'B'

SECTION 'A-A'
VIEW LOOKING NORTH
NTS

APPROVED FOR
CONSTRUCTION

THIS COMPLETE DRAWING IS NEW
AND FORMS PART OF SCOPE OF
PROJ. WBS No. NIM.IN.09.011


REV.	DATE	DESCRIPTION	APPROVED FOR CONSTRUCTION	ISSUED FOR COMMENTS	IN.09.011	OSE/28N
0.1	NOV.10	ISSUED FOR I.D.R.				
1	NOV.10	CHKD. BY VMB				
2	NOV.10	APPRO. BY HU				
3	NOV.10	APPRO. BY HU				
4	NOV.10	APPRO. BY HU				
5	NOV.10	APPRO. BY HU				
6	NOV.10	APPRO. BY HU				
7	NOV.10	APPRO. BY HU				
8	NOV.10	APPRO. BY HU				
9	NOV.10	APPRO. BY HU				
10	NOV.10	APPRO. BY HU				

NO.	DESCRIPTION	DATE	APPROVED BY	DESCRIPTION	DATE	APPROVED BY
1	ISSUED FOR I.D.R.	NOV.10	HU	ISSUED FOR CONSTRUCTION	NOV.10	HU
2	CHKD. BY VMB	NOV.10	VMB	ISSUED FOR COMMENTS	NOV.10	VMB
3	APPRO. BY HU	NOV.10	HU			
4	APPRO. BY HU	NOV.10	HU			
5	APPRO. BY HU	NOV.10	HU			
6	APPRO. BY HU	NOV.10	HU			
7	APPRO. BY HU	NOV.10	HU			
8	APPRO. BY HU	NOV.10	HU			
9	APPRO. BY HU	NOV.10	HU			
10	APPRO. BY HU	NOV.10	HU			

W:\3_Piping\WPAI-PDO EMC JOBS (C310606)\PROJECTS\PAIP-PROJECT-JOBS\PAIP00405_DQ\32140001-DQ.dwg 09-APR-2011 11:12:06 AM Mohd.Shahin



DRAWING LIMIT S 24.000

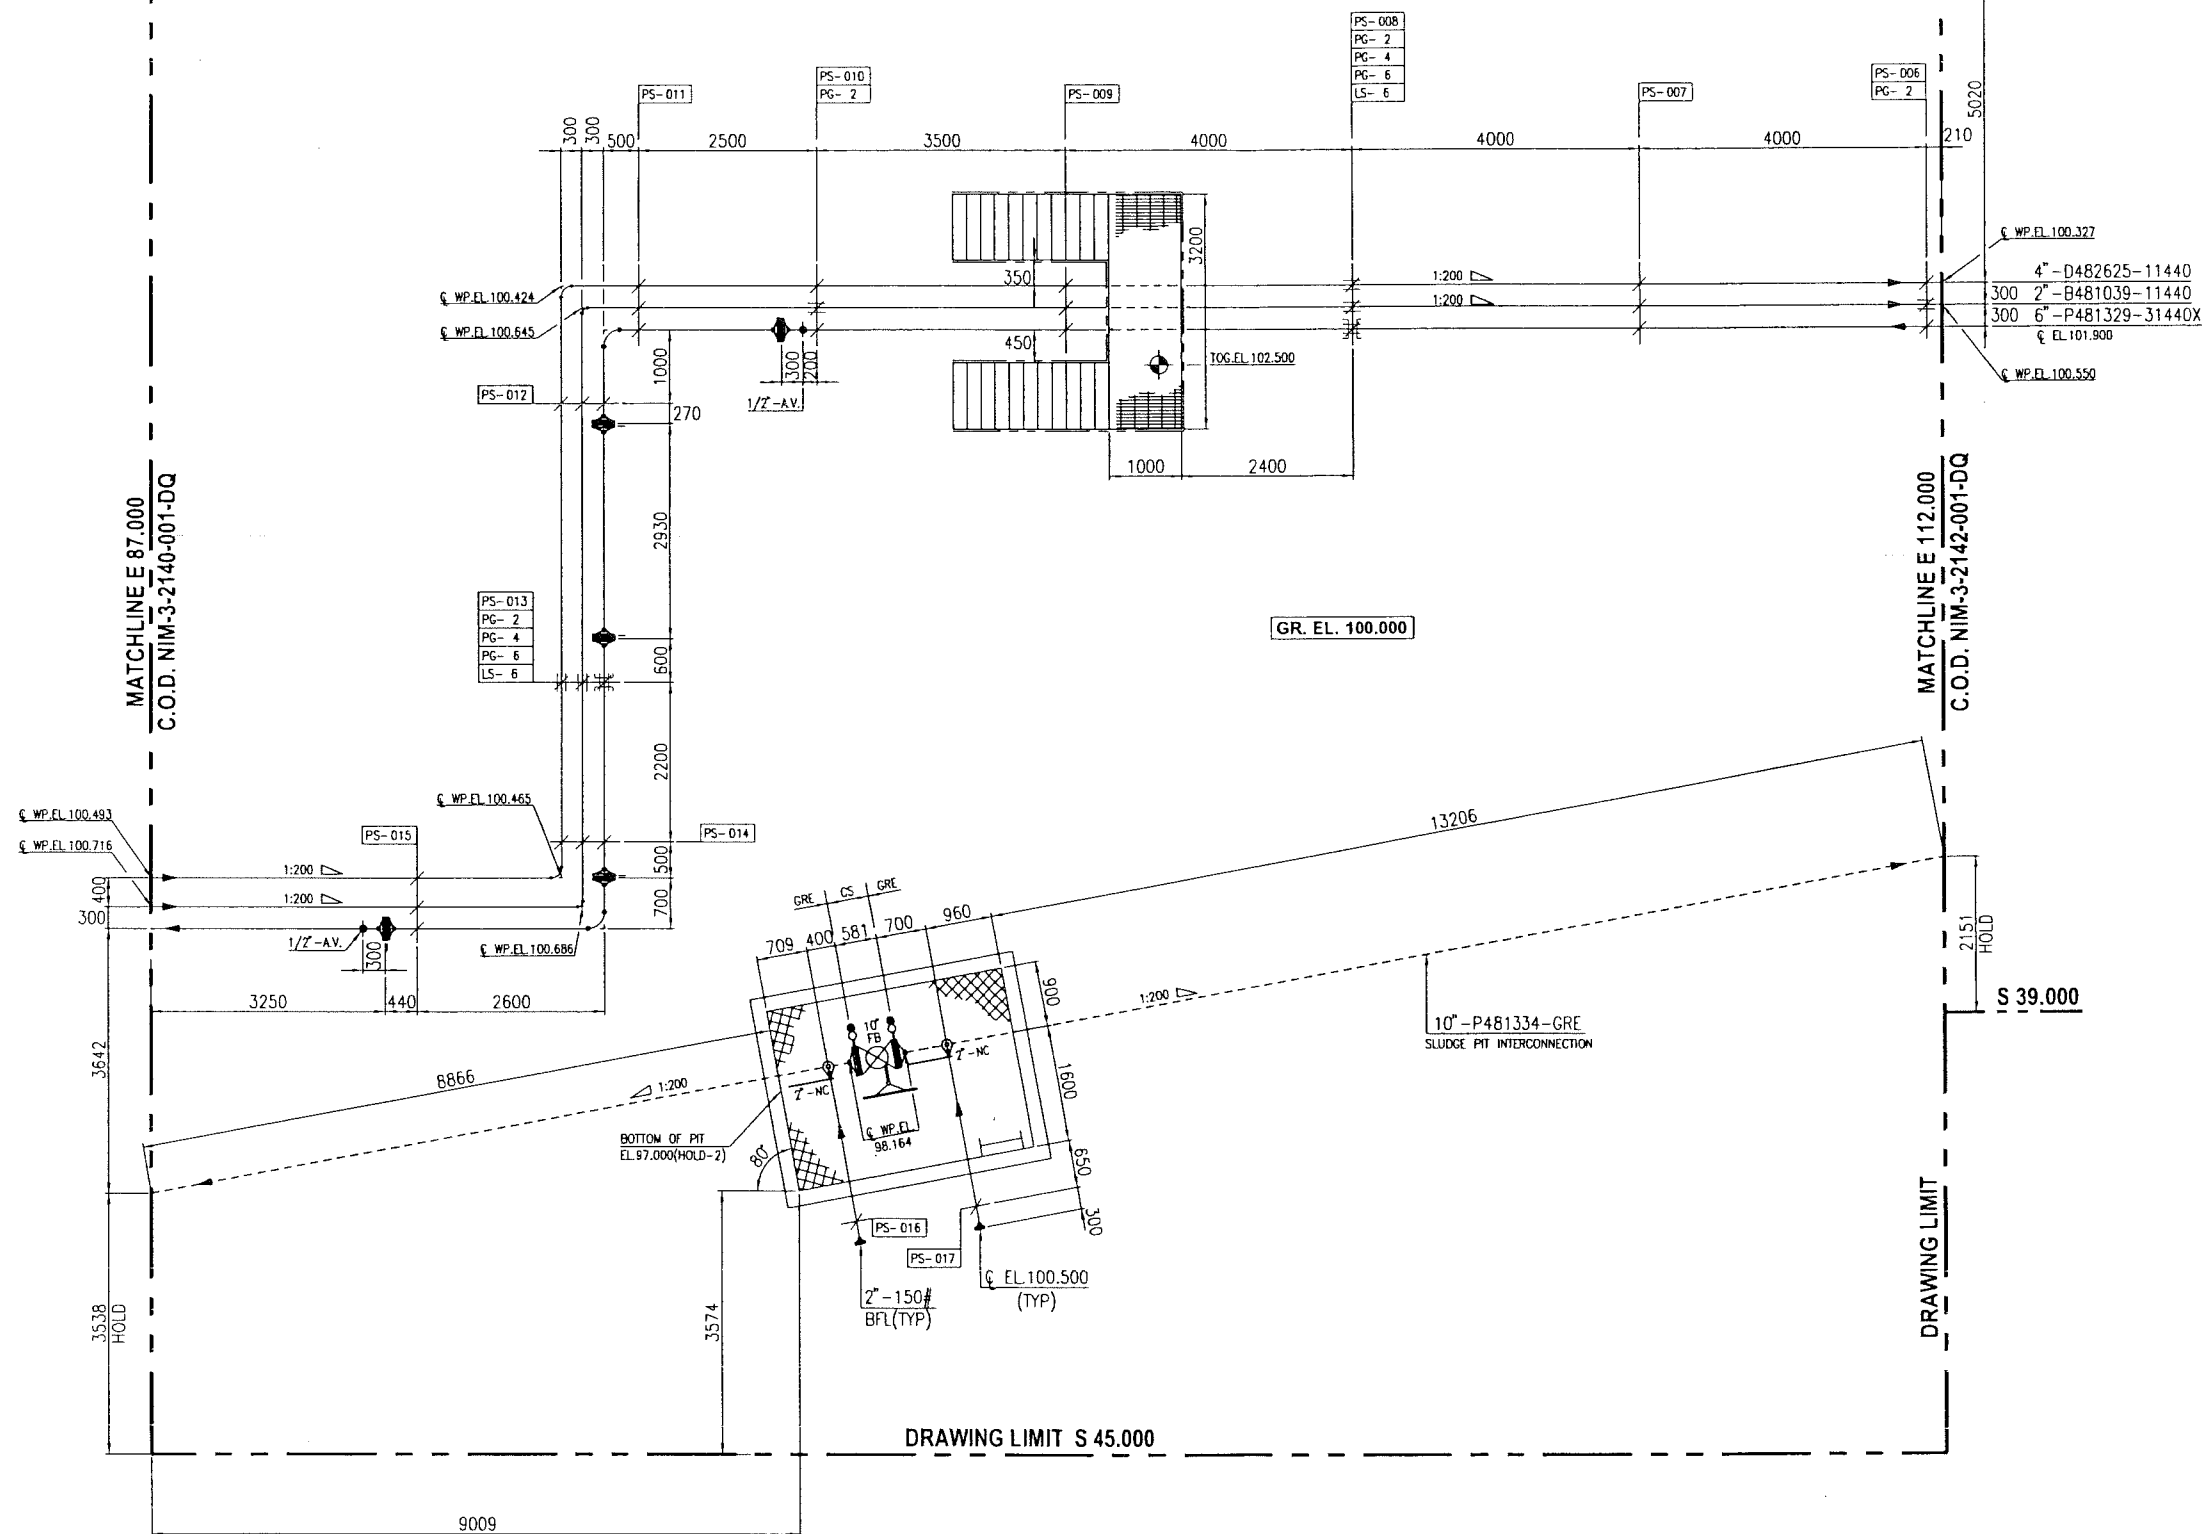

APPROVED FOR
CONSTRUCTION

THIS COMPLETE DRAWING IS NEW
AND FORMS PART OF SCOPE OF
PROJ. WBS No. NIM.IN.09.011

DESCRIPTION : ISSUED FOR I.D.R.							
REV.	0.1	DRN. BY	MIS	DATE	NOV.10	CHKD. BY	VMB
DATE	NOV.10	APPRO. BY	HD	DATE	NOV.10	APPRO. BY	HD
WorleyParsons-Arabian Industries (JV)				PROJECT DRAWING REVISION			
CONTRACT NO. : C31/0606 PROJ. NO. : PAIP00405				IN CASE OF DEVIATIONS A MARKED UP PRINT SHALL BE SENT TO THE PROJECT ENGINEER			
				AREA	NIMR		SCALE : 1:50 CAD DRAWING
				SUB AREA	WASTE MANAGEMENT COMPLEX		NO 05
				DRWG TYPE	PIPING GA		
				DESCRIPTION	SLUDGE PIT INTERCONNECTION		
				NO	NIM	3	2141 001 DQ 1 A

4. MODULAR TYPE (FULL BORE) SBB VALVES FOR ALL INSTRUMENT CONNECTIONS.
3. 31440X "X" INDICATE PIPING PE/ROTO LINED AND SUPER DUPLEX VALVES.
2. GRADE ELEVATION 100.000 m. IS EQUAL TO EL. (HOLD) ABOVE M.S.L.
1. ALL CO-ORDINATES & ELEVATIONS ARE IN MTRS. AND DIMENSIONS ARE IN mm.



2. VALVE PIT LOCATION, ELEVATION & DIMENSION.
1. ELEVATION IS HOLD FOR PUMP VENDOR DETAILS.

PIPING KEY PLAN
DRAWING CONTROL INDEX

DESCRIPTION

AREA	SERIAL	SL	P	S
NIM	3	2137	001	DQ 1
NIM	1	2635	300	DQ 4

MASTER DRAWING REVISION
IN CASE OF DEVIATIONS MARKED UP PRINT SHALL BE SENT TO COASTAL DESIGN OFFICE

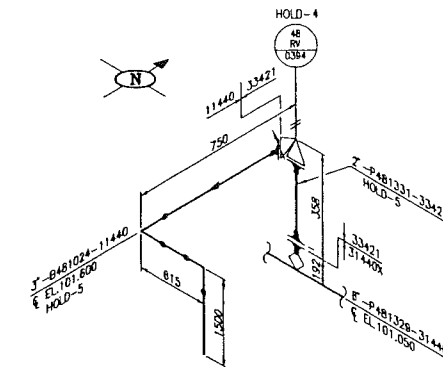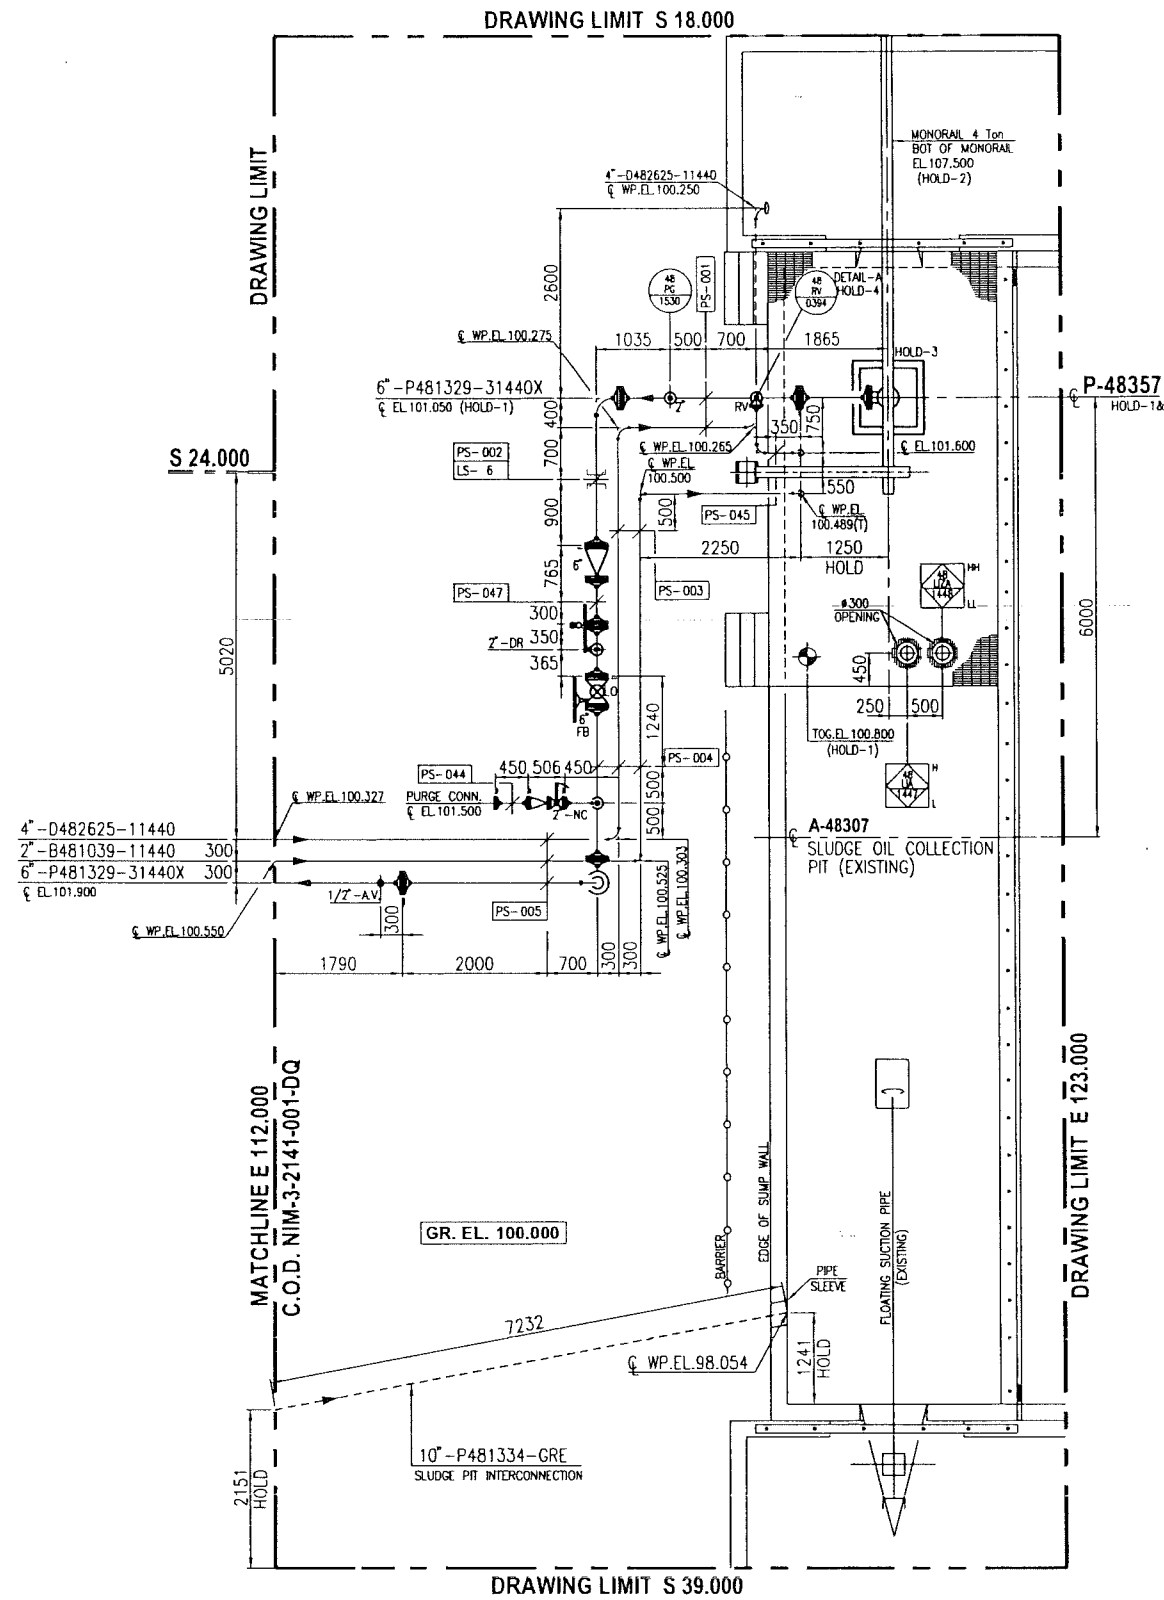

DETAIL-A'

APPROVED FOR CONSTRUCTION

THIS COMPLETE DRAWING IS NEW AND FORMS PART OF SCOPE OF PROJ. WBS No. NIM.IN.09.011

DESCRIPTION : ISSUED FOR I.O.B			
REV.	0.1	CHKD. BY	MIS
DATE	NOV.10	APPRO. BY	WAB

CONTRACT NO. : C31/0606 PROJ. NO. : PAIP00405

REV.	DATE	CHKD. BY	APPRO. BY	DESCRIPTION	WBS. NO.	PROJ. ENG.	SIGNATURE
A	APR.11	MIS	WAB	APPROVED FOR CONSTRUCTION	IN.09.011	OSE/28N	
0	DEC.10	MIS	WAB	ISSUED FOR COMMENTS	IN.09.011	OSE/28N	

PROJECT DRAWING REVISION IN CASE OF DEVIATIONS A MARKED UP PRINT SHALL BE SENT TO THE PROJECT ENGINEER

AREA	NIMR	SCALE	1:50
SUB AREA	NIMR SLUDGE PIT	NO	05
DWG. TYPE	PIPING GA		
DESCRIPTION	SLUDGE PIT A48307 PUMP P48357		

NOTES
4. MODULAR TYPE (FULL BORE) SSB VALVES FOR ALL INSTRUMENT CONNECTIONS.
3. 31440X 'X' INDICATE PIPING PE/ROTO LINED AND SUPER DUPLEX VALVES.
2. GRADE ELEVATION 100,000 m. IS EQUAL TO EL. (HOLD) ABOVE M.S.L.
1. ALL CO-ORDINATES & ELEVATIONS ARE IN MTRS. AND DIMENSIONS ARE IN mm.



5. LINE SIZE.
4. VENDOR DRAWING DETAILS.
3. OPENING FOR PUMP.
2. MONORAIL ELEVATION & CAPACITY.
1. ELEVATION & MOUNTING OF PUMP IS HOLD.

REFERENCE DRAWINGS
PIPING KEY PLAN
DRAWING CONTROL INDEX

DRAWING NUMBER
NIM 3 2137 001 DO 1
NIM 1 2635 300 DO 4

MASTER DRAWING REVISION
IN CASE OF DEVIATIONS MARKED UP PRINT SHALL BE SENT TO COASTAL DESIGN OFFICE

PLANT NORTH

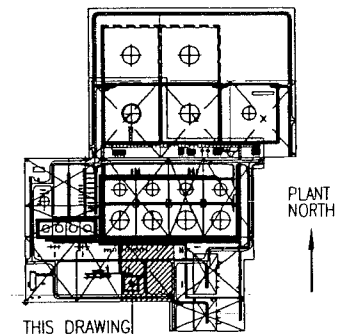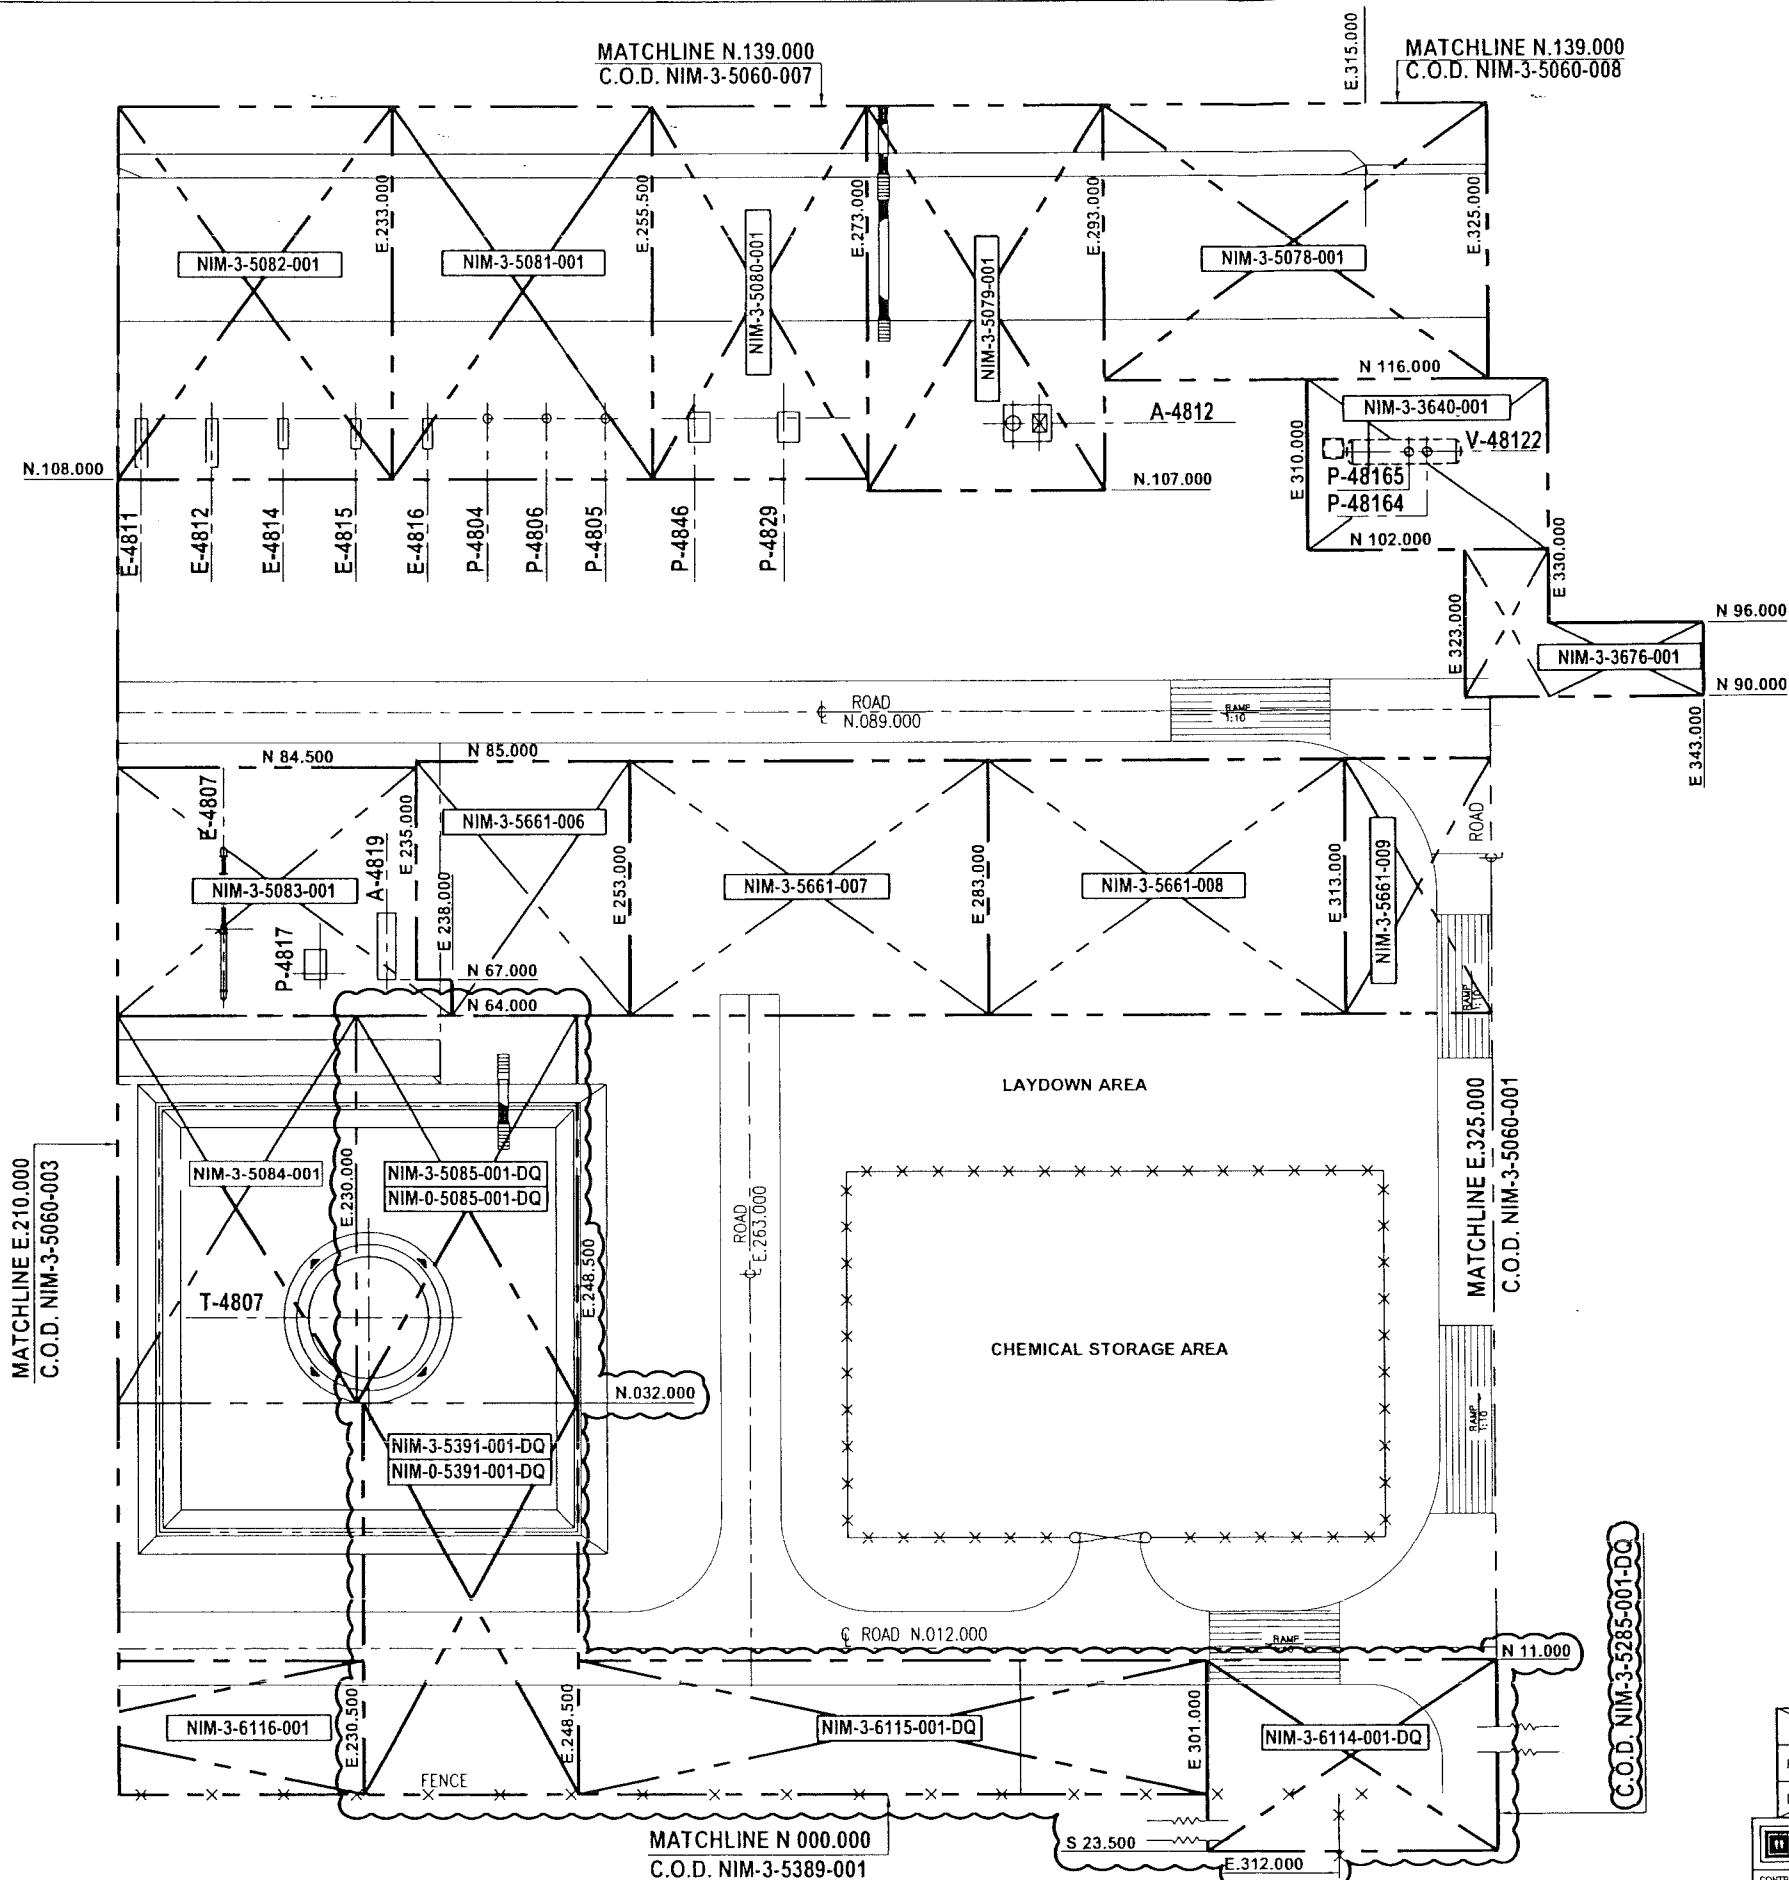

KEY PLAN

SCOPE OF PROJECT
WBS NO.
NIM.IN.09.011

THIS DRAWING IS MADE BASED ON
WBS No. NIM.IN.08.002
PROJ. CODE - CN

THIS DRAWING IS A KEY PLAN ONLY AND IS NOT
TO BE USED FOR EQUIPMENT LOCATIONS

APPROVED FOR
CONSTRUCTION

DESCRIPTION : ISSUED FOR L.D.B.				PROJECT DRAWING REVISION			
REV.	DATE	CHKD. BY	APPRD. BY	REV.	DATE	DESCRIPTION	WBS NO.
0.1	JAN.11	MIS	WMB	A	APR.11	MIS	ISSUED FOR CONSTRUCTION
				0	JAN.11	MIS	ISSUED FOR COMMENTS
CONTRACT NO. : C31/0606 PROJ. NO. : PAIP00405				PROJECT DRAWING REVISION			
DESCRIPTION : ISSUED FOR L.D.B.				IN CASE OF DEVIATIONS A MARKED UP PRINT SHALL BE SENT TO THE PROJECT ENGINEER			
WorleyParsons-Arabian Industries (JV)				CAD DRAWING			
AREA : NIMR				SUB AREA : PRODUCTION STATION			
NO. 05				DESCRIPTION : KEY PLAN FOR PIPING PLAN			
NO. 05				DESCRIPTION : SLUDGE SYSTEM AREA			
NO. 05				NO. NIM 3 5060 002 DQ A1 A			



2. PLANT DATUM EL.100.000 = EL.227.020 ABOVE M.S.L.
1. ALL DIMENSIONS ARE IN MM AND ELEVATION/CO-ORDINATES ARE IN METRES.

DRAWING CONTROL INDEX			
NO.	DESCRIPTION	DATE	BY
1	OVERALL PLOT PLAN	26.03.00	QK
2	OVERALL KEY PLAN	26.03.00	QK
3	OVERALL KEY PLAN	26.03.00	QK
4	OVERALL KEY PLAN	26.03.00	QK

REFERENCE DRAWINGS			
NO.	DESCRIPTION	DATE	BY
1	AS BUILT FOR PROJECT '3Y'	26.03.00	QK
2	AS BUILT FOR PROJECT '9B'	26.03.00	QK
3	AS BUILT FOR PROJ. '1S'	26.03.00	QK
4	AS BUILT FOR PROJ. '1D'	26.03.00	QK
5	AS BUILT FOR PROJECT G6	26.03.00	QK
6	AS BUILT AS PER B.I.89.591	26.03.00	QK

MASTER DRAWING REVISION			
NO.	DESCRIPTION	DATE	BY
1	AS BUILT FOR PROJECT '3Y'	26.03.00	QK
2	AS BUILT FOR PROJECT '9B'	26.03.00	QK
3	AS BUILT FOR PROJ. '1S'	26.03.00	QK
4	AS BUILT FOR PROJ. '1D'	26.03.00	QK
5	AS BUILT FOR PROJECT G6	26.03.00	QK
6	AS BUILT AS PER B.I.89.591	26.03.00	QK

PROJECT DRAWING REVISION			
NO.	DESCRIPTION	DATE	BY
1	AS BUILT FOR PROJECT '3Y'	26.03.00	QK
2	AS BUILT FOR PROJECT '9B'	26.03.00	QK
3	AS BUILT FOR PROJ. '1S'	26.03.00	QK
4	AS BUILT FOR PROJ. '1D'	26.03.00	QK
5	AS BUILT FOR PROJECT G6	26.03.00	QK
6	AS BUILT AS PER B.I.89.591	26.03.00	QK

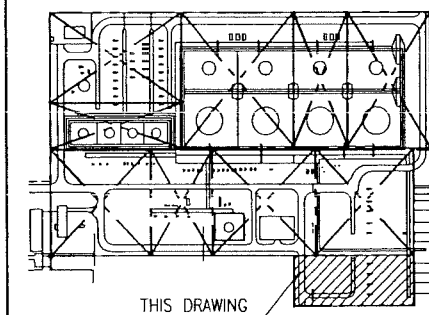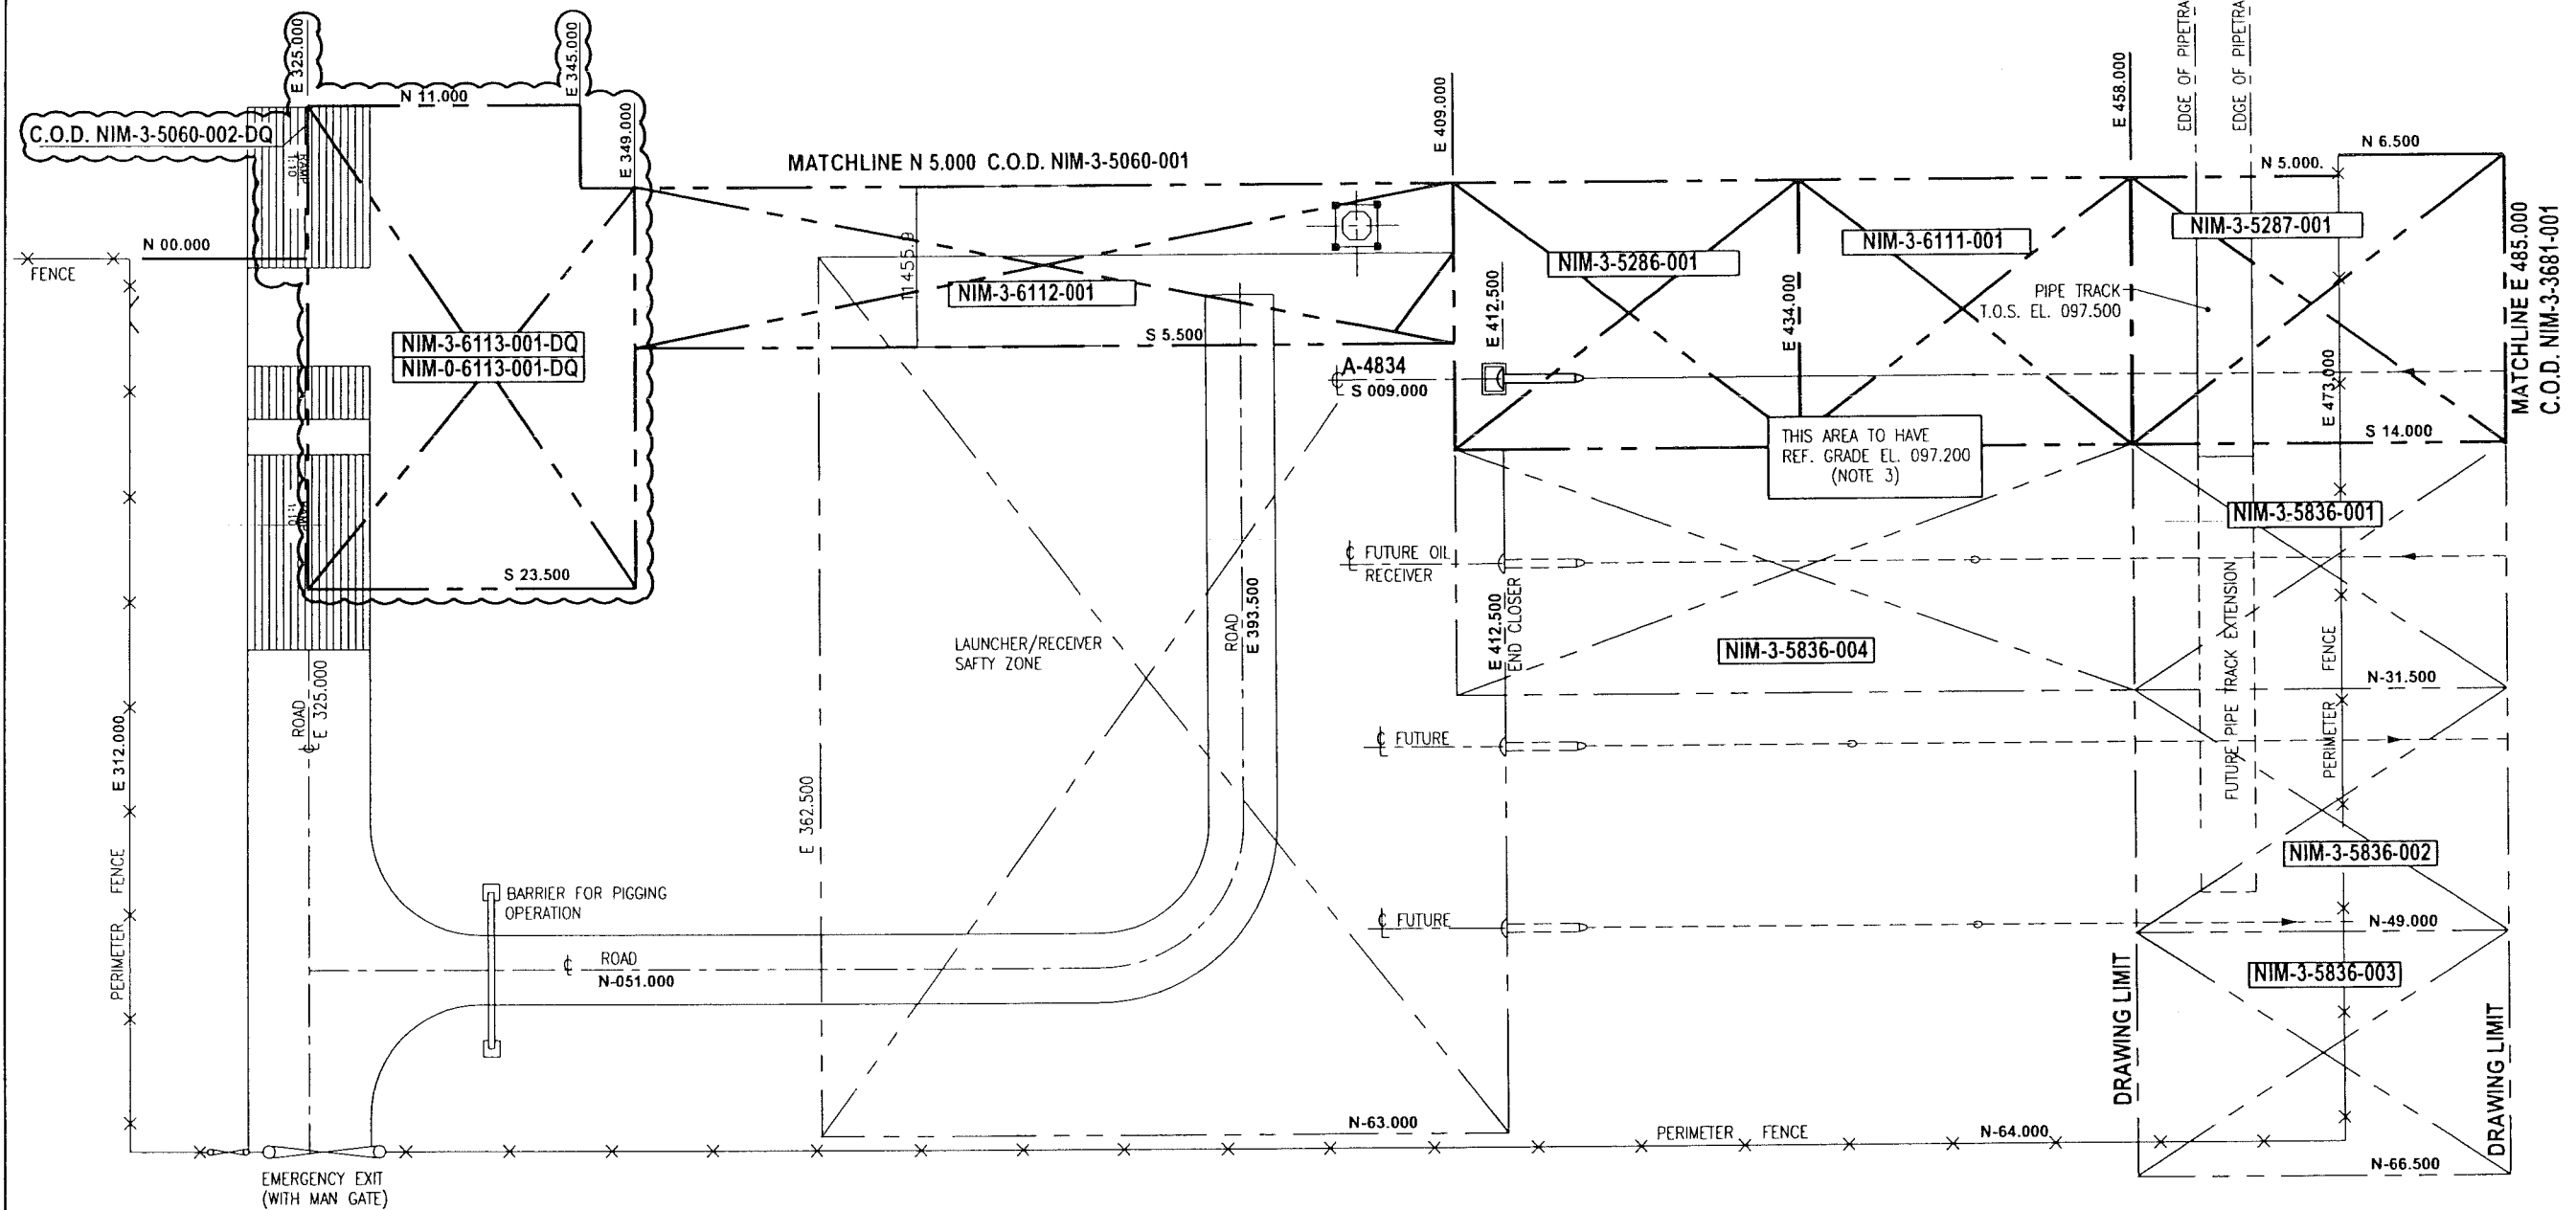

THIS DRAWING IS A KEY PLAN ONLY AND IS NOT TO BE USED FOR EQUIPMENT LOCATIONS

SCOPE OF PROJECT
WBS NO.
NIM.IN.09.011

THIS DRAWING IS MADE BASED ON
WBS No. NIM.IN.08.002
PROJ. CODE - CN

APPROVED FOR
CONSTRUCTION


NOTES
3. REF. GRADE EL. IS LOCAL ELEVATION DEFINED ONLY FOR THE PURPOSE OF FOUNDATION & PIPING DESIGN.
2. PLANT DATUM EL. 100.000 = EL. 227.020 ABOVE M.S.L.
1. ALL CO-ORDINATES ARE IN METRES

DRAWING CONTROL INDEX				
OVERALL PLOT PLAN	NIM 1	2635	300	DO 4
PLOT PLAN	NIM 1	5073	001	1
ENGINEERING PLOT PLANS-KEY PLAN	NIM 1	5087	001	1
OVERALL KEY PLAN	NIM 1	5082	001	1
PIPING G.A. KEY PLAN	NIM 3	5059	001	1
SITE GRADING PLAN	NIM 3	5060	001	1
NIMR PRODUCTION STN. PLOT PLAN	NIM 2	5004	001	1
NIMR PRODUCTION STN. SITE PLAN	NIM 1	5072	001	1
	NIM 1	5071	001	1


DESCRIPTION	AREA	SERIAL	SH	P	REV	DATE	APPROVED BY	DESCRIPTION	WBS NO.	PROJ. APPROVAL

DESCRIPTION	WBS NO.	PROJ. APPROVAL
AS BUILT FOR PROJECT CODE '9X'	06.003	
AS BUILT FOR PROJECT CODE '9B'	04.002	
AS BUILT FOR PROJECT CODE 'Y4'	98.289	
AS BUILT AS PER FP-1238		

DESCRIPTION : ISSUED FOR L.O.R.							
REV. 0.1	CHKD. BY	MIS		DATE	APPR. BY	MIS	
DATE JAN '11	APPR. BY	MIS		DATE	APPR. BY	MIS	
WorleyParsons-Arabian Industries (JV)				PROJECT DRAWING REVISION			
CONTRACT NO. : C3170606 PROJ. NO. : PAIP00405				IN CASE OF DEVIATIONS A MARKED UP PRINT SHALL BE SENT TO THE PROJECT ENGINEER			
AREA : NIMR				SCALE : 1 : 250 CAD DRAWING			
SUB AREA : PRODUCTION STATION				NO. 05			
KEY PLAN FOR PIPING PLAN LAUNCHER/RECEIVER AREA				TRAIN 4 EXTN.			
NO. NIM 3 5285 001 DQ01 A							

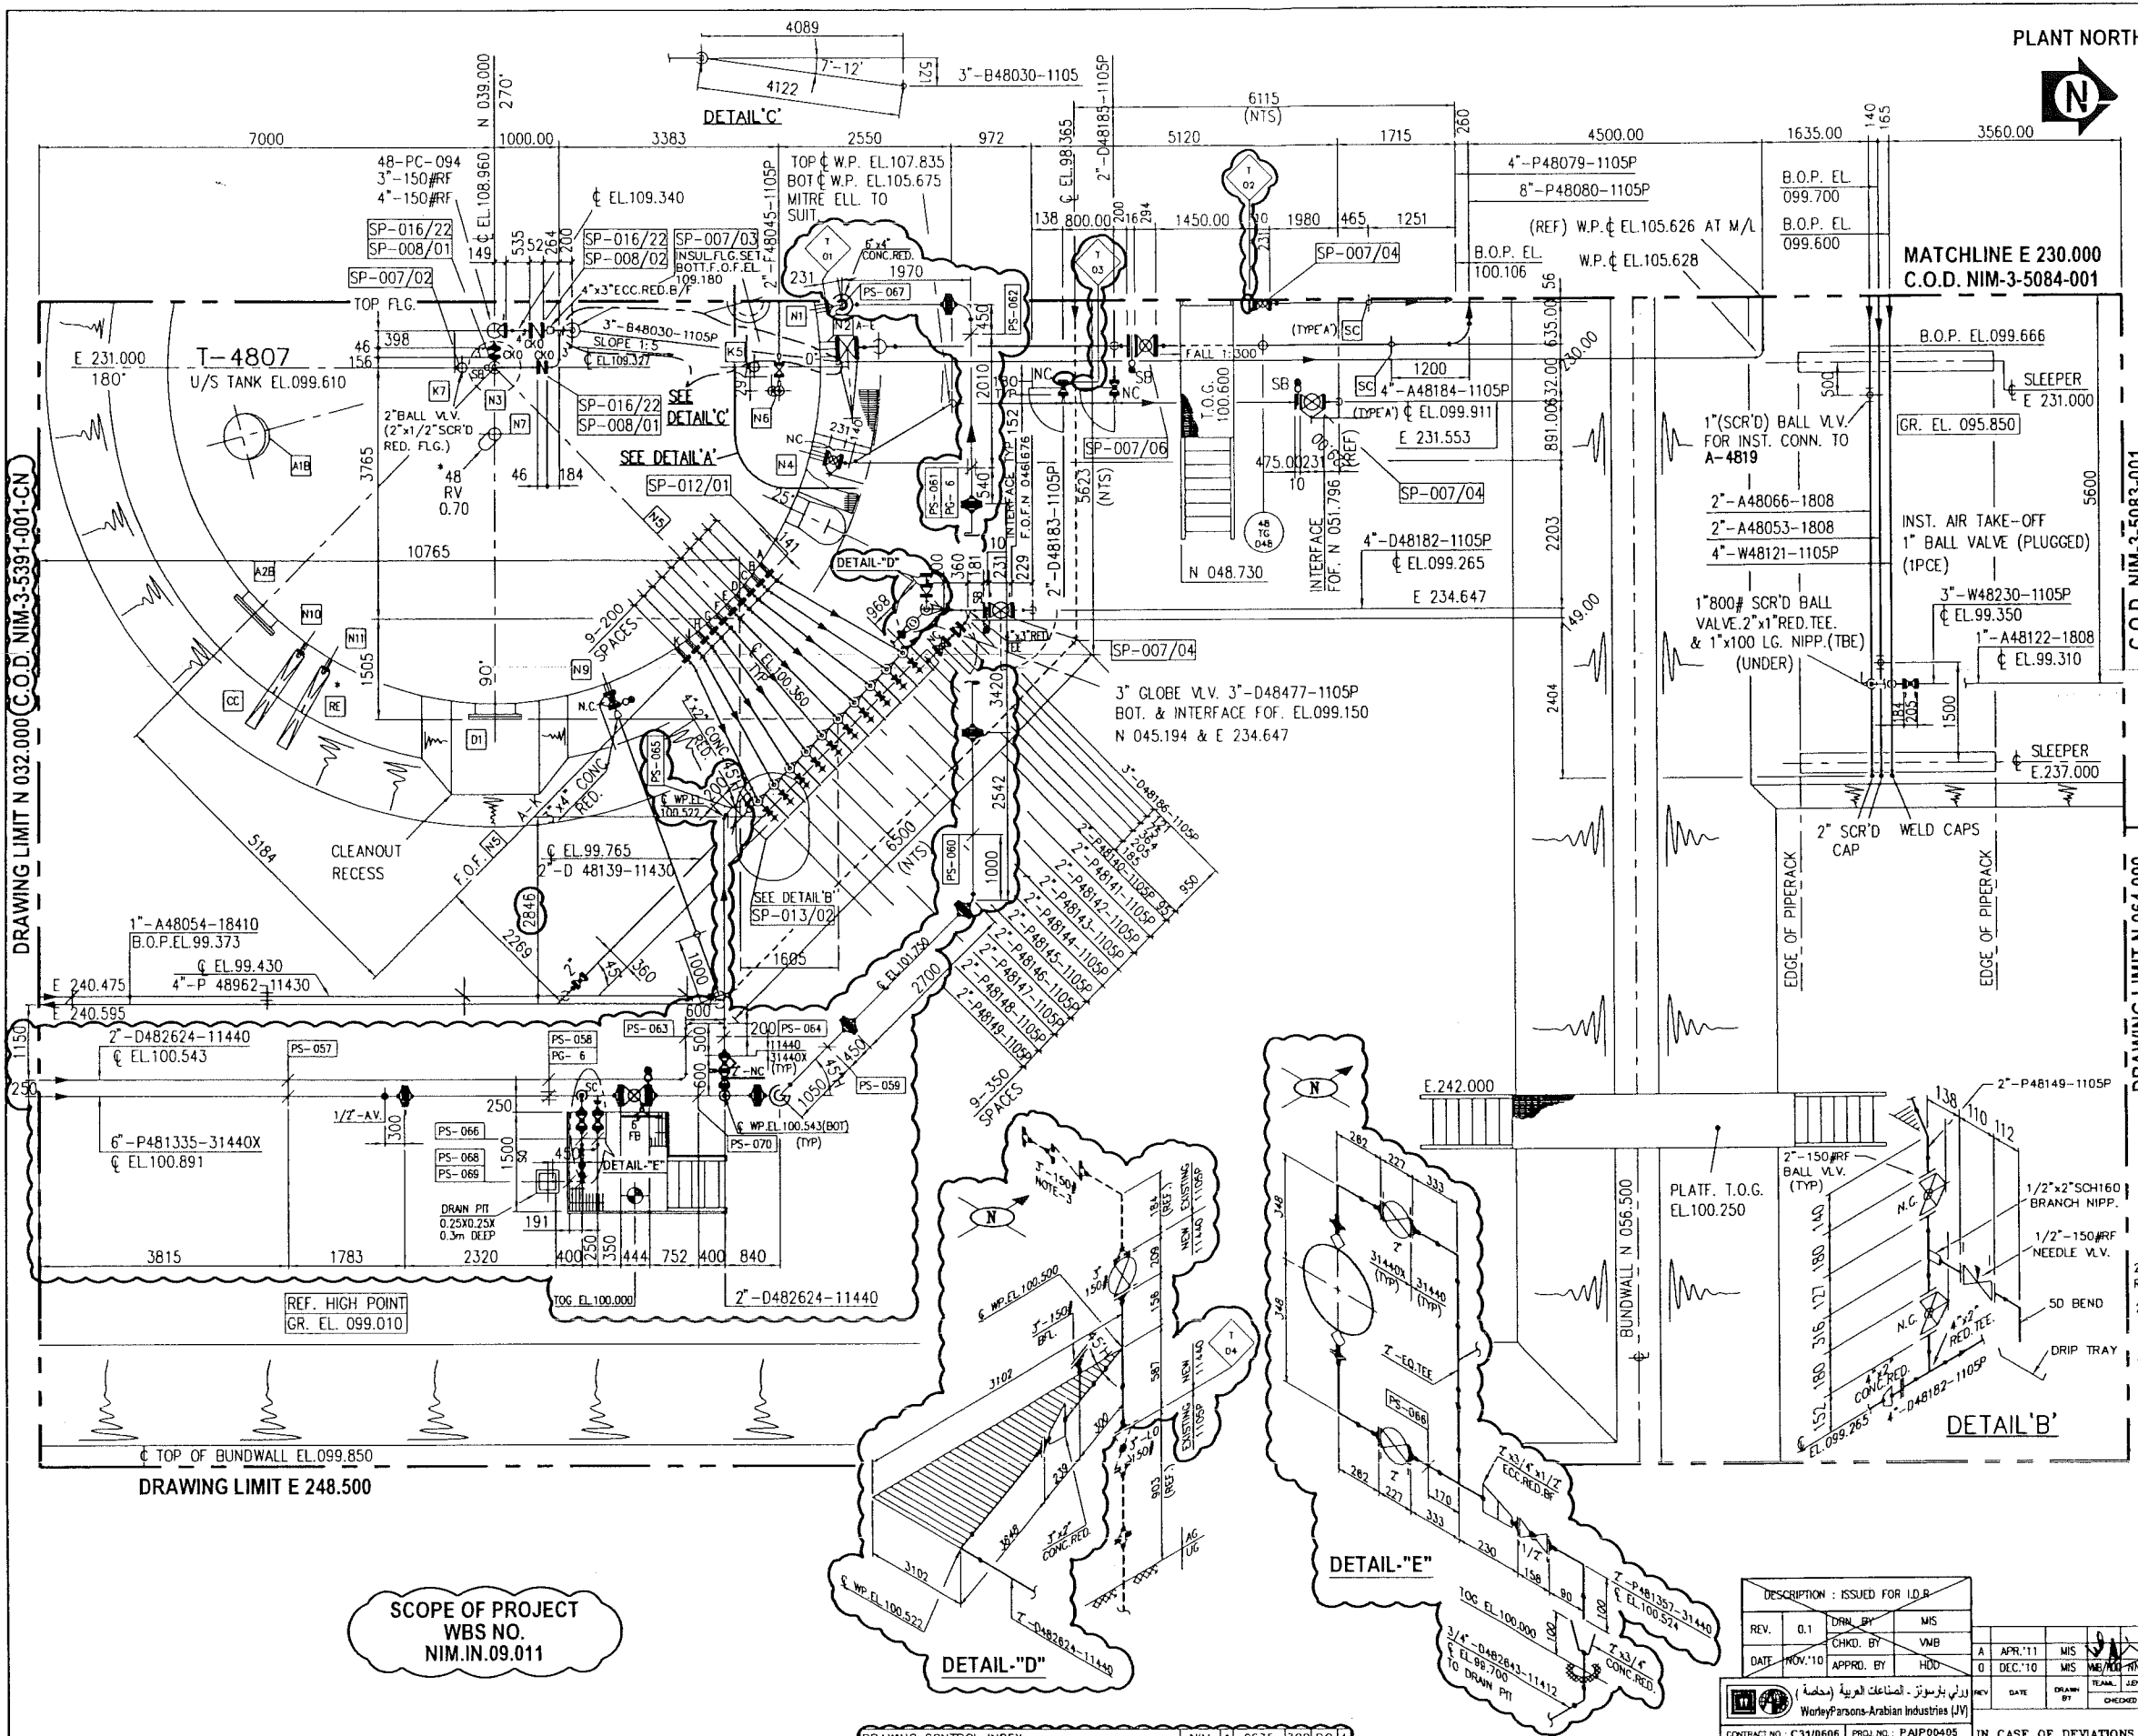

NOZZLE SCHEDULE									
EQUIP NO.	NOZZLE NO.	SIZE	RATING	F.O.F. EL. / F. ELEV	ORIENT	C TO F.O.F. OR NOZZ			
N1	4"	150#RF		107.116	350°	5209			
N2A	8"	150#RF		104.216	357°	5209			
N2B	8"	150#RF		103.216	357°	5209			
N2C	8"	150#RF		102.216	357°	5209			
N2D	8"	150#RF		101.216	357°	5209			
N2E	8"	150#RF		100.216	357°	5209			
N3	3"	150#RF		108.794	0°	0			
N4	4"	150#RF		100.216	15°	5209			
N5A	2"	150#RF		105.856	-	5184			
N5B	2"	150#RF		105.246	-	5184			
N5C	2"	150#RF		104.636	-	5184			
N5D	2"	150#RF		104.026	-	5184			
N5E	2"	150#RF		103.416	45°	5184			
N5F	2"	150#RF		102.806	-	5184			
N5G	2"	150#RF		102.196	-	5184			
N5H	2"	150#RF		101.416	-	5184			
N5J	2"	150#RF		100.976	-	5184			
N5K	2"	150#RF		100.360	-	5184			
N6	2"	150#RF		107.897	5°	4400			
N7	3"	150#RF		108.677	90°	1000			
N9	3"	150#RF		100.116	70°	5184			
N10	2"	150#RF		100.116	125°	5184			
N11	2"	150#RF		100.116	120°	5184			
K5	2"	150#RF		107.995	0°	4000			
K7	2"	150#RF		108.695	180°	500			
A1B	20"	STD		STD	165°	4000			
A2B	24"	STD		STD	135°	STD			
D1	24"x24"	STD		STD	90°	STD			

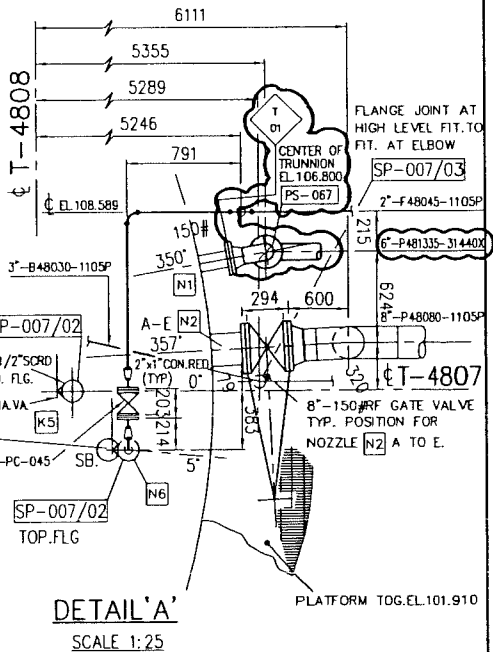

NOTES

- 31440X-X INDICATE PIPING PE/ROTO LINED AND SUPER DUPLEX SS VALVES.
- EXISTING SPOOL WITH CHECK VALVE TO BE RE-USED
- VENDOR SUPPLY
- FOR GENERAL NOTES SEE DRG. NO. NIM-3-5060-002

DRAWING CONTROL INDEX

DESCRIPTION	NO.	DATE	BY	CHKD.	APPD.
PIPING GA KEY PLAN, SLUDGE SYSTEM AREA	NIM 1 2635	300	DO 4		
UNDERGROUND SERVICES SLUDGE TANK AREA	NIM 3 5060	002	DO 1		
ENGINEERING PLOT PLAN, SLUDGE SYSTEM AREA	NIM 1 5089	001			
NIMR PRODUCTION STATION OVERALL PLOT PLAN	NIM 1 5072	001			
NIMR PRODUCTION STATION SITE PLAN	NIM 1 5071	001			

APPROVED FOR CONSTRUCTION

PROJECT DRAWING REVISION

NO.	DATE	DESCRIPTION	BY	CHKD.	APPD.
1	09.09.11	ISSUED FOR CONSTRUCTION			
2	09.09.11	ISSUED FOR COMMENTS			

IN CASE OF DEVIATIONS A MARKED UP PRINT SHALL BE SENT TO THE PROJECT ENGINEER


AREA : NIMR

SUB AREA : PRODUCTION STATION


NO : 05

DRWG TYPE : PIPING PLAN

DESCRIPTION : SLUDGE TANK AREA T-4807

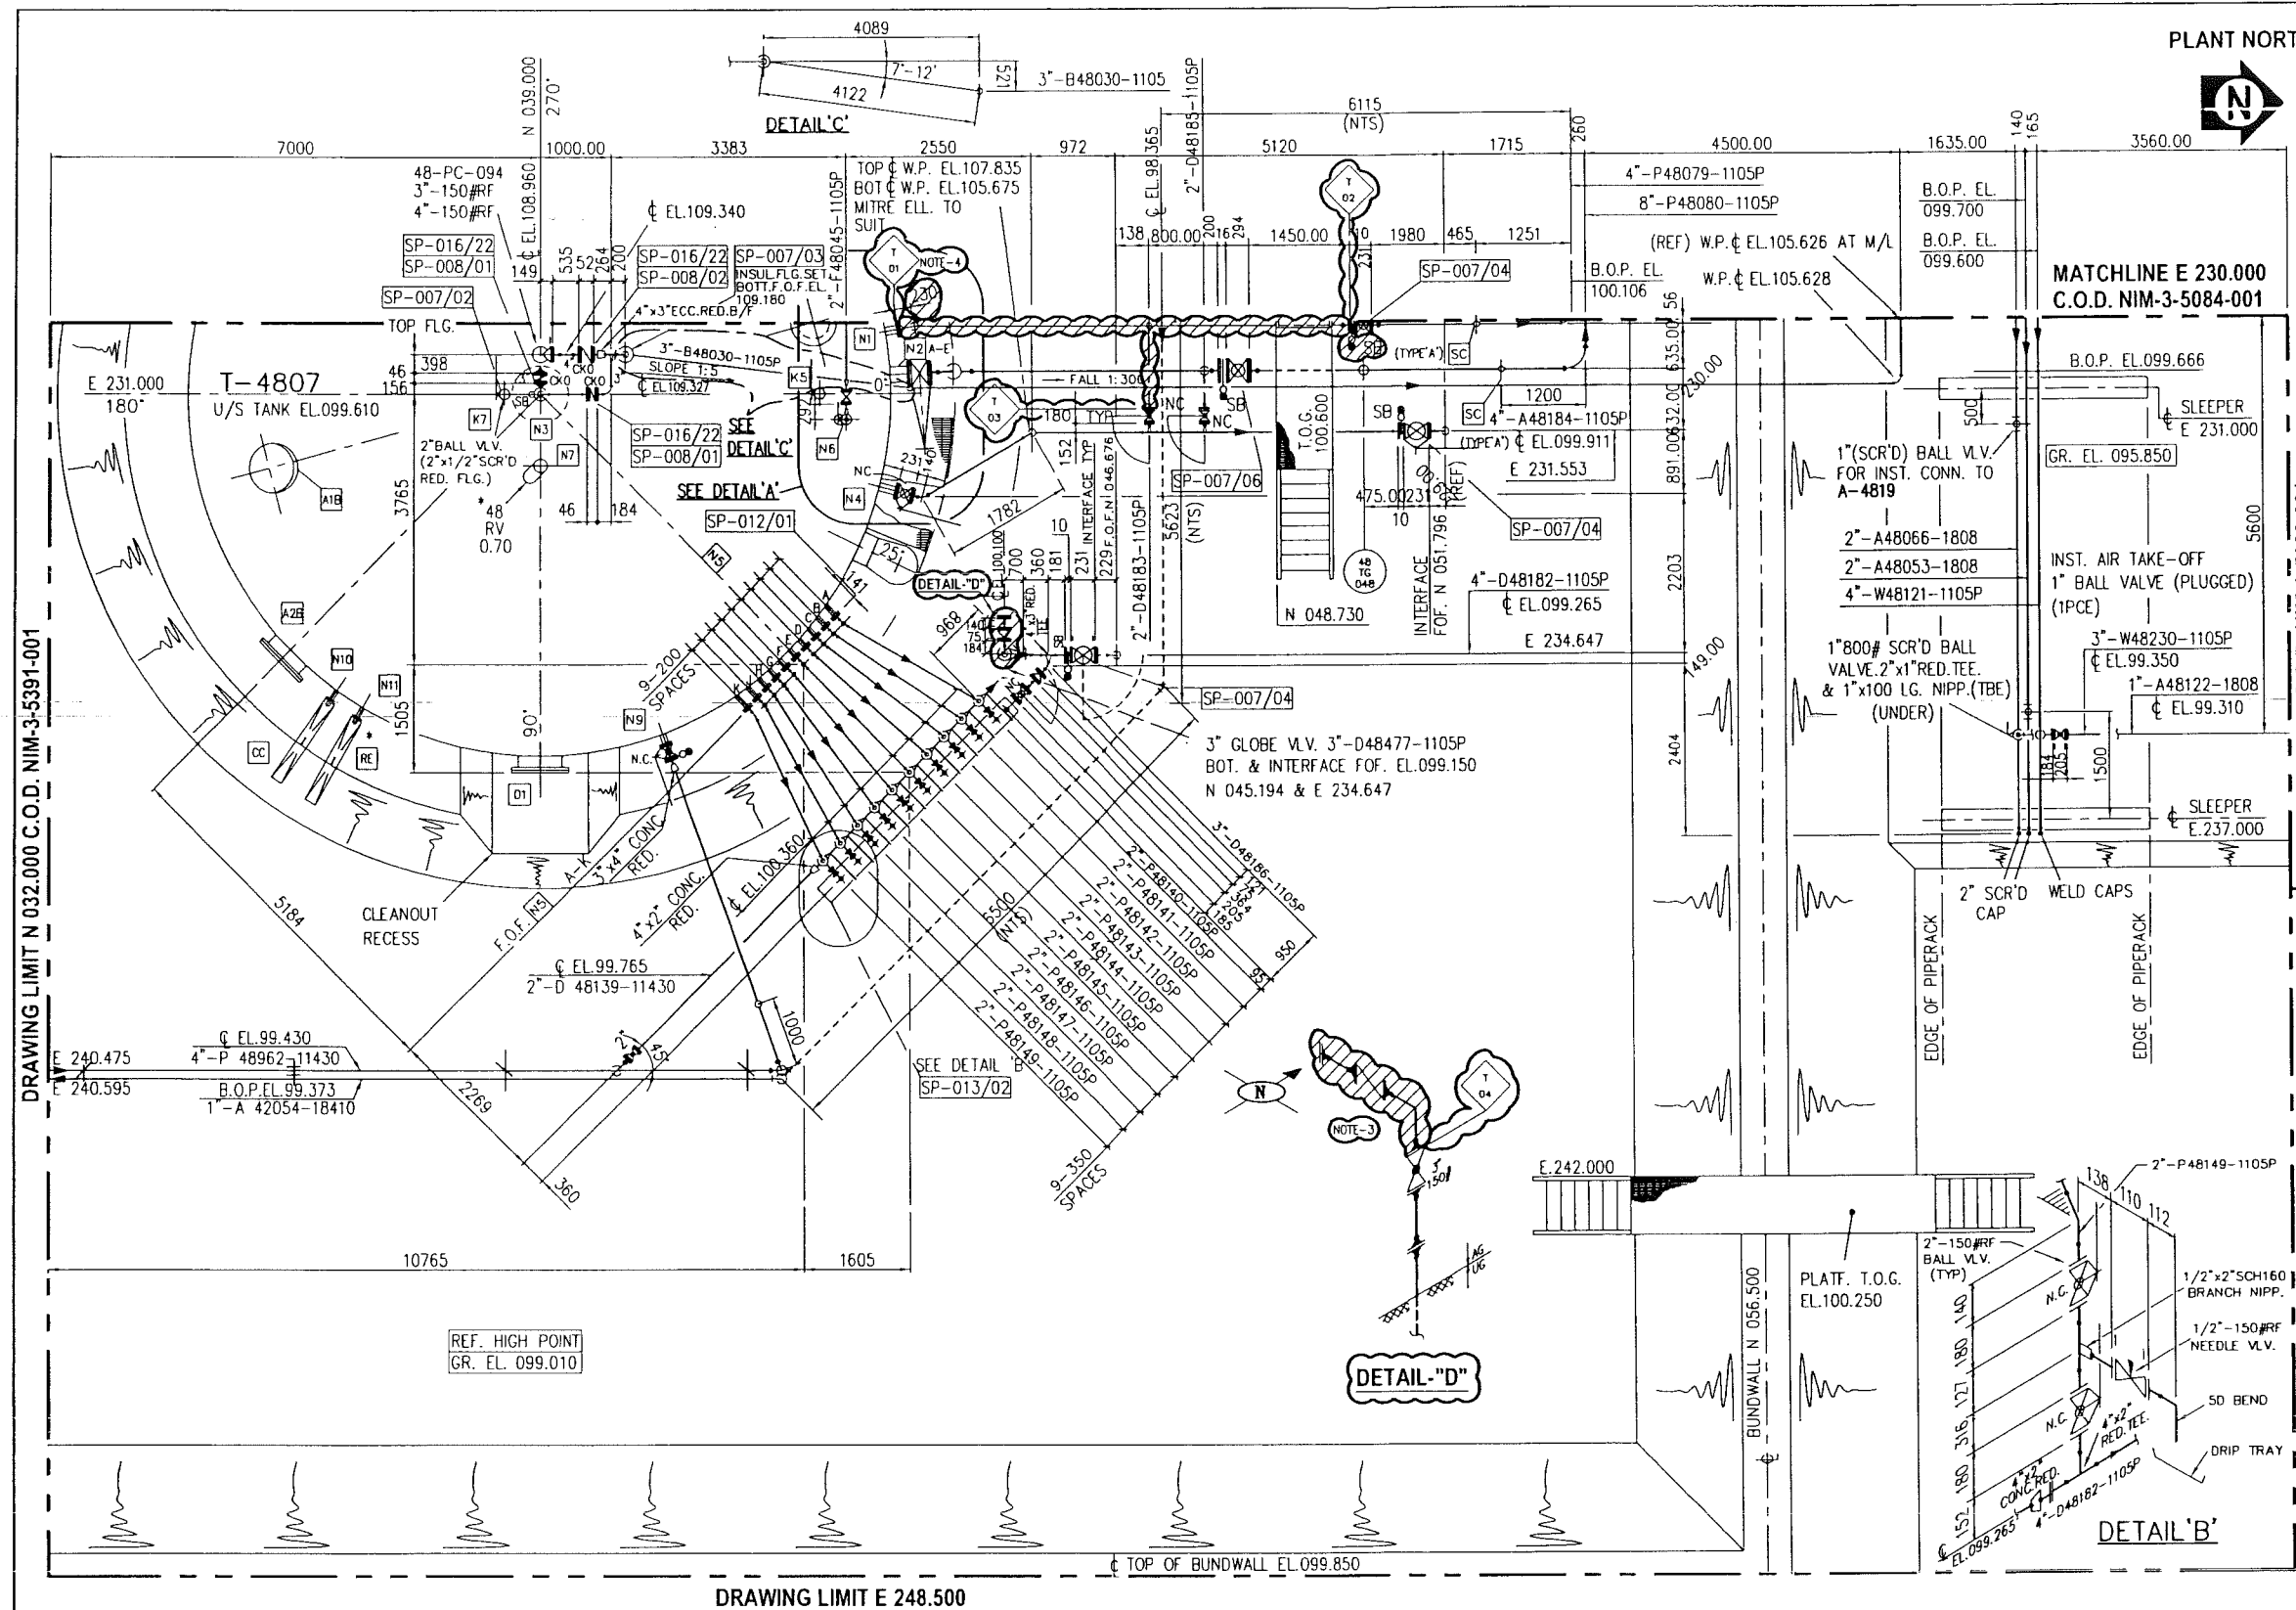

EQUIP No.	NOZZ No.	SIZE	RATING	F.O.F. EL/ ELEV	ORIENT	TO F.O.F. OR NOZZ
T-4807	N1	4"	150#RF	107.116	350°	5209
	N2A	8"	150#RF	104.216	357°	5209
	N2B	8"	150#RF	103.216	357°	5209
	N2C	8"	150#RF	102.216	357°	5209
	N2D	8"	150#RF	101.216	357°	5209
	N2E	8"	150#RF	100.216	357°	5209
	N3	3"	150#RF	108.794	0°	0
	N4	4"	150#RF	100.216	15°	5209
	N5A	2"	150#RF	105.856	-	5184
	N5B	2"	150#RF	105.246	-	5184
	N5C	2"	150#RF	104.636	-	5184
	N5D	2"	150#RF	104.026	-	5184
	N5E	2"	150#RF	103.416	45°	5184
	N5F	2"	150#RF	102.806	-	5184
	N5G	2"	150#RF	102.196	-	5184
	N5H	2"	150#RF	101.416	-	5184
	N5J	2"	150#RF	100.976	-	5184
	N5K	2"	150#RF	100.360	-	5184
	N6	2"	150#RF	107.897	5°	4400
	N7	3"	150#RF	108.677	90°	1000
	N9	3"	150#RF	100.116	70°	5184
	N10	2"	150#RF	100.116	125°	5184
	N11	2"	150#RF	100.116	120°	5184
	K5	2"	150#RF	107.995	0°	4000
	K7	2"	150#RF	108.695	180°	500
	A1B	20"	STD	STD	165°	4000
	A2B	24"	STD	STD	135°	STD
	D1	24"x24"	STD	STD	90°	STD

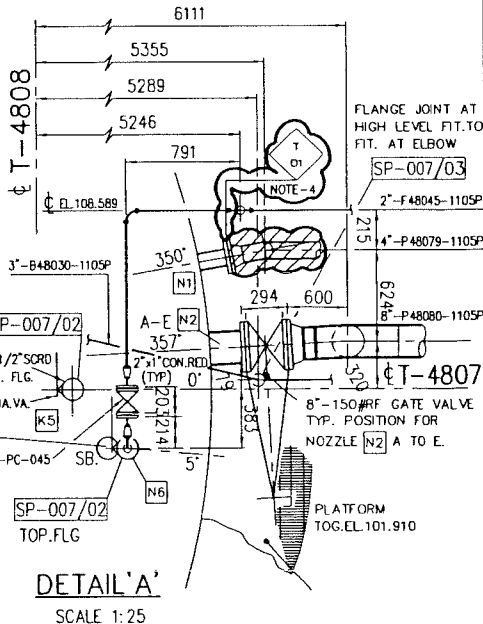

DETAIL 'A'
SCALE 1:25

SCOPE OF DEMOLITION
WBS NO.
NIM.IN.09.011

SCOPE OF PROJECT
WBS NO.
NIM.IN.09.011

- NOTES
4. SUPPORT ARMS AT EL.106.970 NOT TO BE DEMOLISHED AND GUIDE AT EL.102.675 TO BE DEMOLISHED.
 3. EXISTING SPOOL WITH CHECK VALVE TO BE RE-USED.
 2. VENDOR SUPPLY
 1. FOR GENERAL NOTES SEE DRG. NO. NIM-3-5060-002

NO.	DESCRIPTION	DATE	BY	CHKD.	APPD.	REV.
1	PIPING G.A. KEY PLAN, SLUDGE SYSTEM AREA	26.03.00	DO	4		
2	UNDERGROUND SERVICES SLUDGE TANK AREA	30.06.00	DO	1		
3	ENGINEERING PLOT PLAN, SLUDGE SYSTEM AREA	30.06.00	DO	1		
4	NIMR PRODUCTION STATION OVERALL PLOT PLAN	30.06.00	DO	1		
5	NIMR PRODUCTION STATION SITE PLAN	30.06.00	DO	1		

NO.	DESCRIPTION	DATE	BY	CHKD.	APPD.	REV.
1	AS BUILT FOR PROJ. 10	01.01.00	DO	1		
2	AS BUILT FOR B.I. NO. 84.361	01.01.00	DO	1		


APPROVED FOR DEMOLITION		PROJECT DRAWING REVISION	
NO.	DESCRIPTION	NO.	DESCRIPTION
1	ISSUED FOR I.D.R.	1	ISSUED FOR COMMENTS
2	ISSUED FOR DEMOLITION	2	ISSUED FOR DEMOLITION
IN CASE OF DEVIATIONS A MARKED UP PRINT SHALL BE SENT TO THE PROJECT ENGINEER		IN CASE OF DEVIATIONS MARKED UP PRINT SHALL BE SENT TO COASTAL DESIGN OFFICE	
AREA : NIMR		SUB AREA : PRODUCTION STATION	
DRINK TYPE : PIPING PLAN (DEMOLITION)		DESCRIPTION : SLUDGE TANK AREA T-4807	
NO. : NIM 0 5085 001 DO 1 A		NO. : 05	



MATCHLINE E 230.500 C.O.D NIM-3-6116-001

DRAWING LIMIT E 230.500

MATCHLINE N 032.000 C.O.D NIM-3-5085-001-DQ

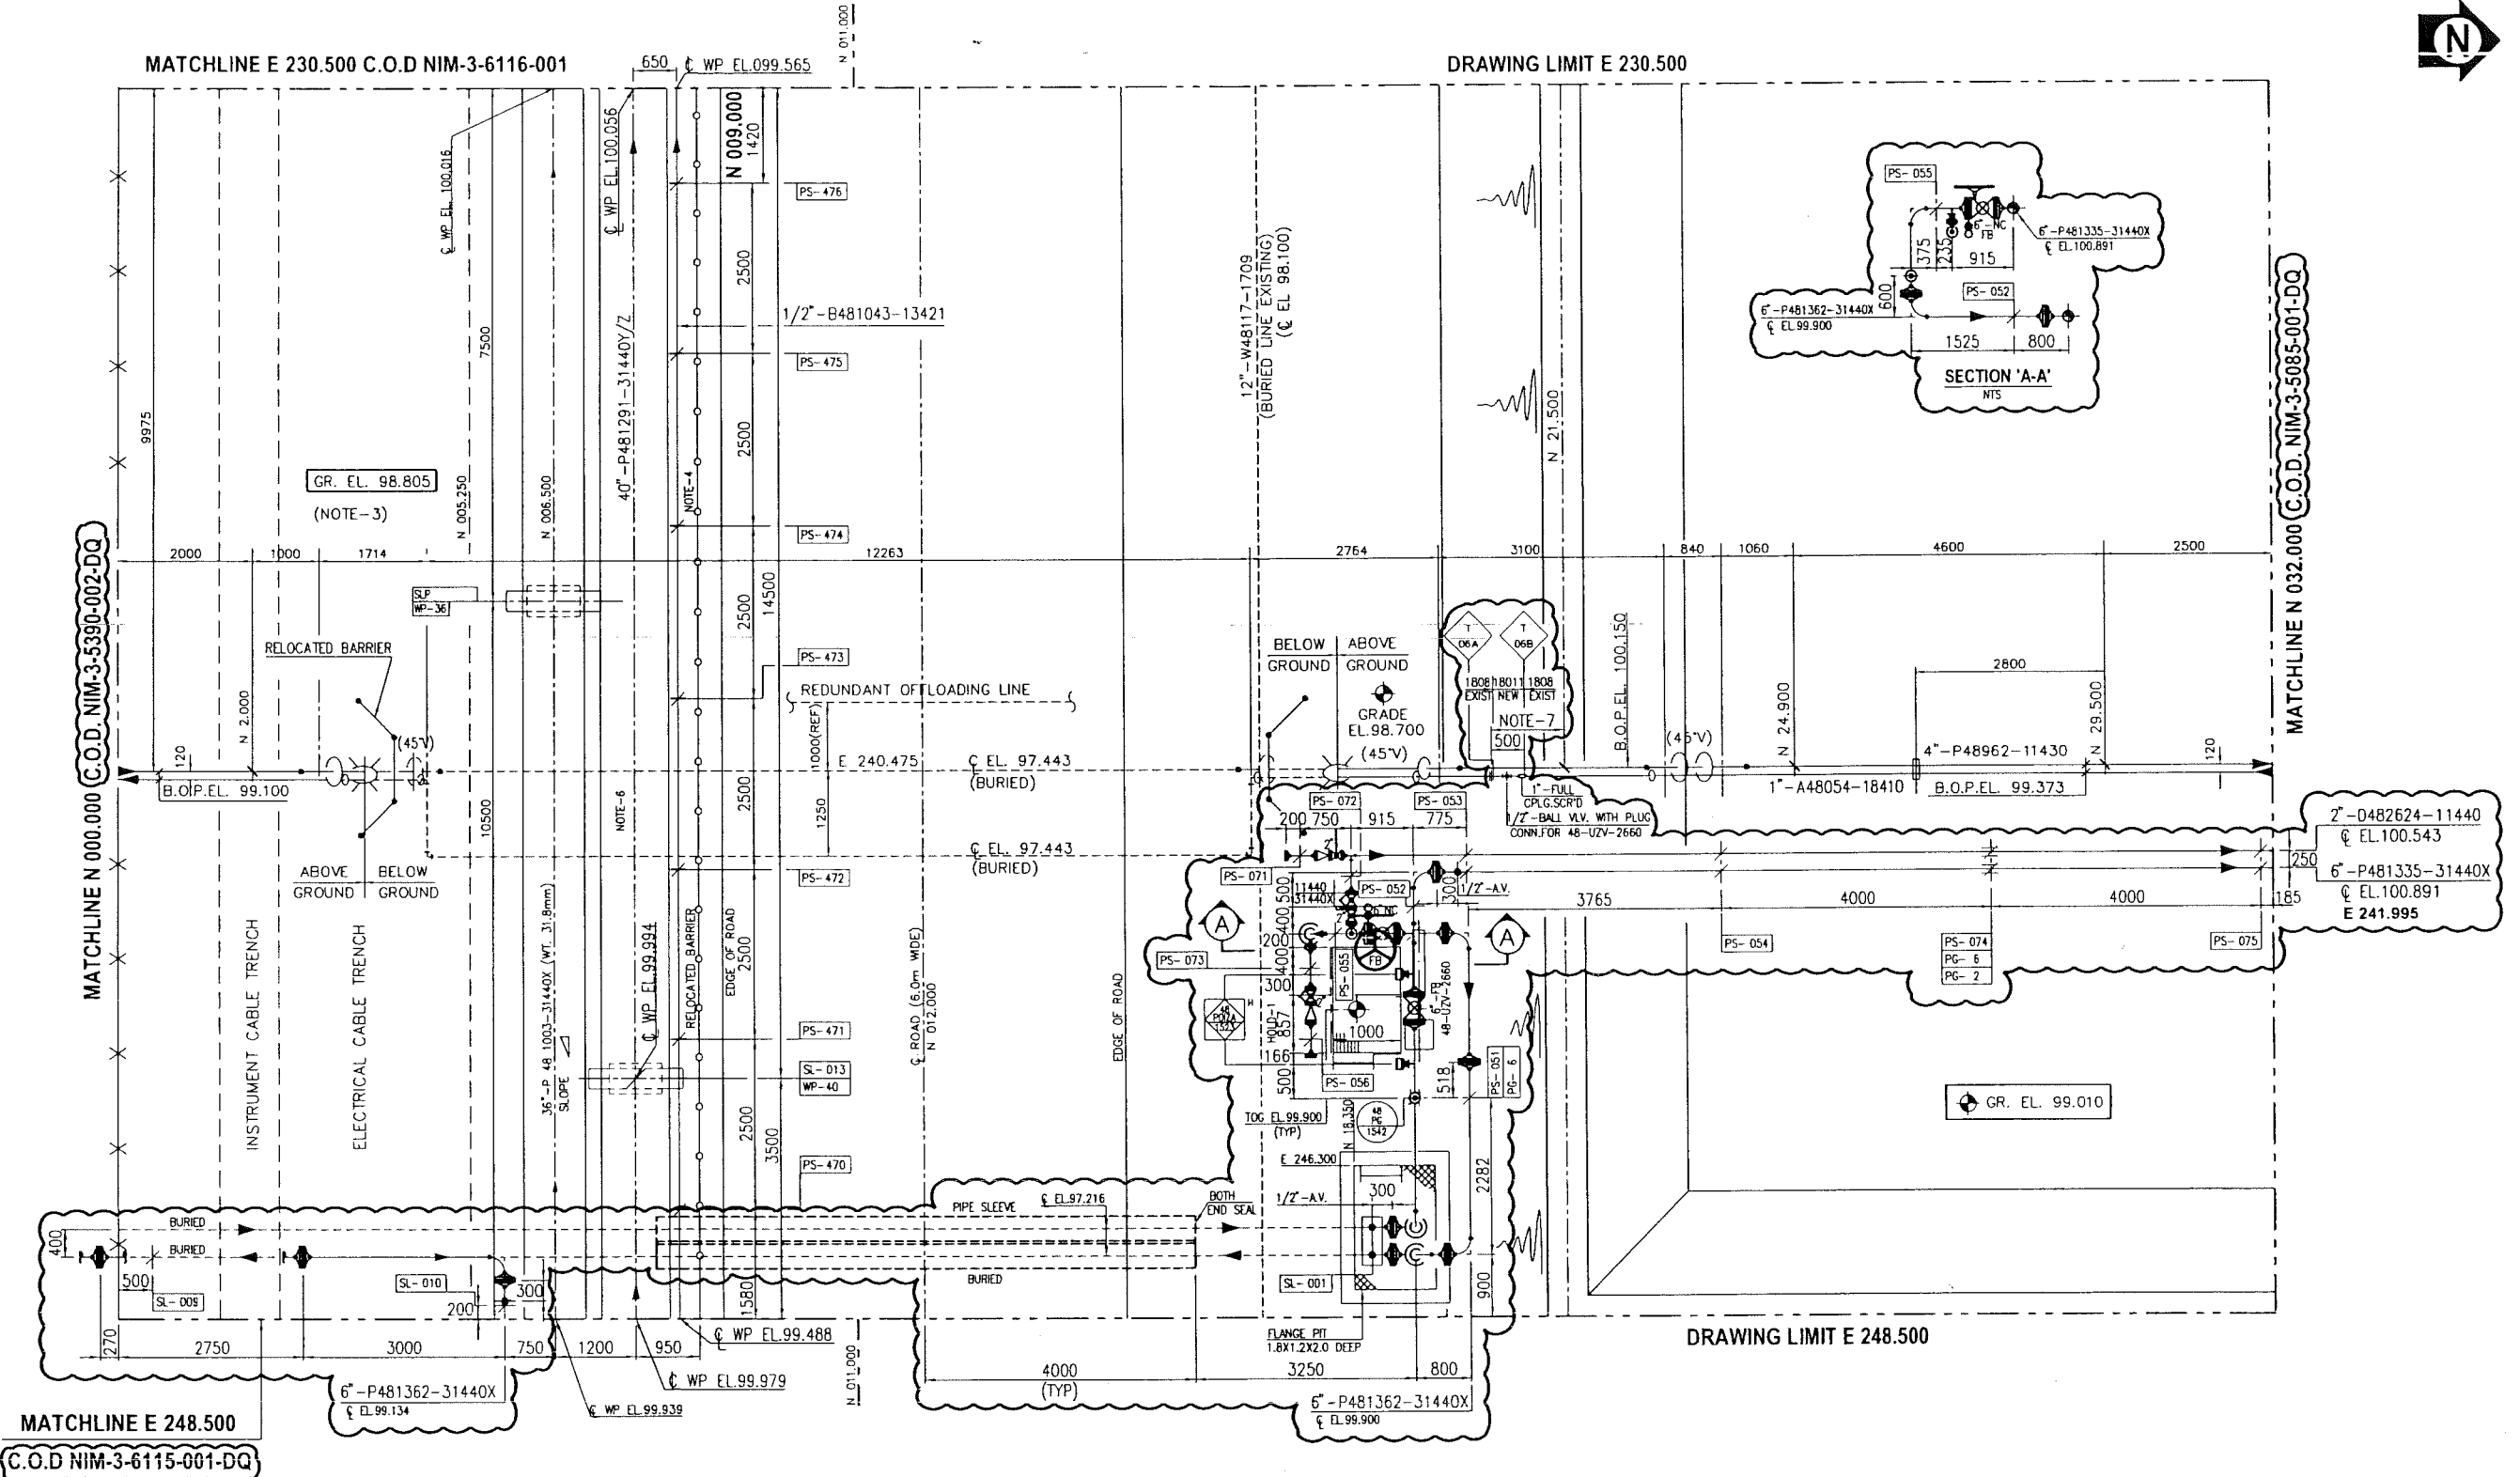

MATCHLINE E 248.500
C.O.D NIM-3-6115-001-DQ

HOLD:-1) UZV-2660 VALVE DIMENSION.

THIS DRAWING IS MADE BASED ON
WBS No. NIM.IN.09.011
PROJ. CODE- CN

SCOPE OF PROJECT
WBS NO.
NIM.IN.09.011

8. 31440X 'X' INDICATE PIPING PE/ROTO LINED AND SUPER DUPLEX VALVES.
7. DIMENSION TO BE CHECKED AT SITE.
6. CLASS 31440Z COVERS PE LINED STRAIGHT PIPE SPOOLS FOR SIZE DN 50 TO DN 1000 AND FBE INTERNALLY COATED STRAIGHT PIPE SPOOLS & FITTINGS FOR SIZE DN 50 TO DN 600.
5. CLASS 31440Z COVERS FBE INTERNALLY COATED STRAIGHT PIPE SPOOLS (OF SMALL LENGTH) & FITTINGS FOR SIZE DN 700 TO DN 1000.
4. EXISTING BARRIER TO BE REUSED.
3. ELEVATION BASED ON SITE SURVEY.
2. PLANT DATUM EL. 100.200 = EL. 222.220 ABOVE M.S.L.
1. ALL DIMENSIONS ARE IN MM AND CO-ORDINATES & ELEVATIONS ARE IN METRES UNLESS NOTED.

DESCRIPTION	AREA	SERIAL	SH.	P.	REV.	DATE	APPROVED BY
DRAWING CONTROL INDEX	NIM	1	2635	300	DO	4	
KEY PLAN FOR PIPING PLAN	NIM	3	5060	002	DQ	1	
PIPING G.A. OVERALL KEY PLAN	NIM	3	5059	001	-	1	
PLOT PLAN	NIM	1	5089	001	-	1	
KEY PLAN - ENGG. PLOT PLAN	NIM	1	5082	001	-	1	


DESCRIPTION	BLDG.	PROJ.	PROJ. NO.	PROJ. NAME	PROJ. CODE	PROJ. SIZE
AS BUILT FOR PROJECT '98'	04.002	CM				
AS BUILT FOR PROJ. '10'	SR.134	ONE/24				
ORIGINAL ISSUE	98.134					

DESCRIPTION	BLDG.	PROJ.	PROJ. NO.	PROJ. NAME	PROJ. CODE	PROJ. SIZE
CRUDE SLUDGE TANK AREA						
PIPING G.A.						
PRODUCTION STATION						
NIMR						

APPROVED FOR
CONSTRUCTION

REV.	DATE	CHKD. BY	APPRD. BY	DESCRIPTION
0.1	NOV.10	DRN. BY	MIS	ISSUED FOR I.D.R.
0	DEC.10	CHKD. BY	VMB	
		APPRD. BY	HDD	

REV.	DATE	CHKD. BY	APPRD. BY	DESCRIPTION
0	NOV.10	DRN. BY	MIS	ISSUED FOR I.D.R.
0	DEC.10	CHKD. BY	VMB	
		APPRD. BY	HDD	

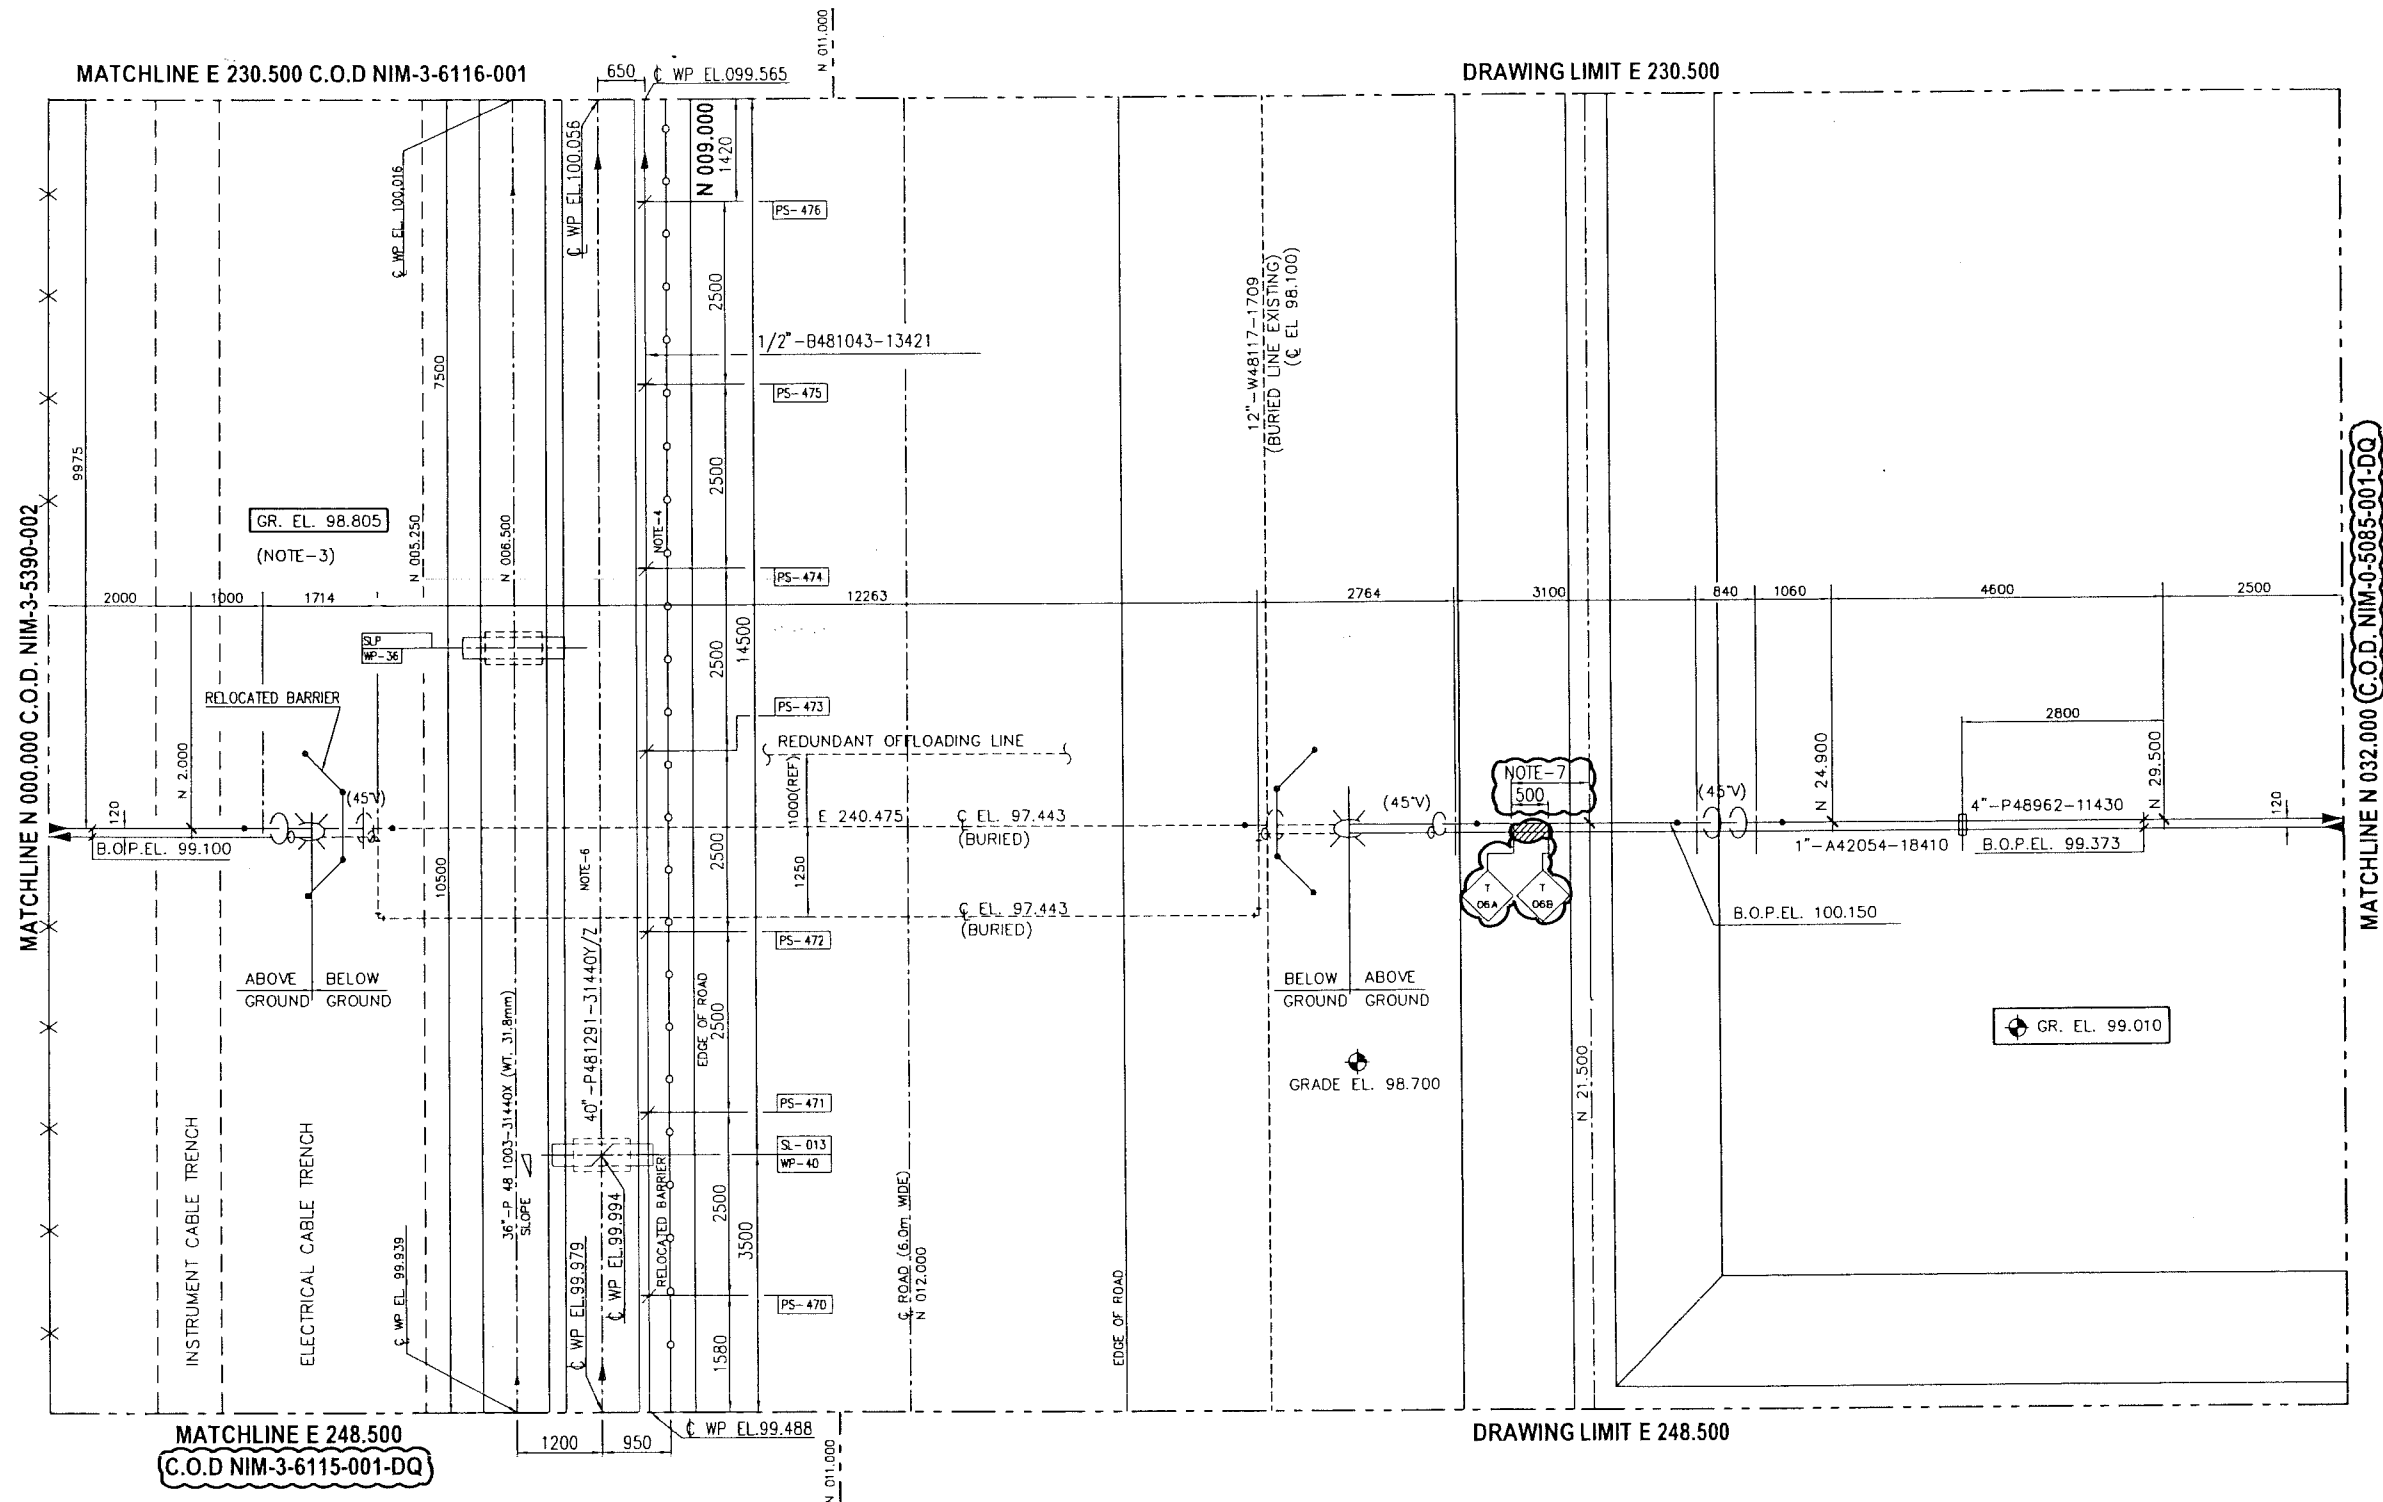

SCOPE OF DEMOLITION
WBS NO.
NIM.IN.09.011

SCOPE OF PROJECT
WBS NO.
NIM.IN.09.011

THIS DRAWING IS MADE BASED ON
WBS No. NIM.IN.08.002
PROJ. CODE - CN

APPROVED FOR
DEMOLITION

7. DIMENSION TO BE CHECKED AT SITE.
6. CLASS 31440Y COVERS PE LINED STRIGHT PIPE SPOOLS FOR SIZE DN 50 TO DN 1000 AND FBE INTERNALLY COATED STRAIGHT PIPE SPOOLS & FITTINGS FOR SIZE DN 50 TO DN 600.
5. CLASS 31440Z COVERS FBE INTERNALLY COATED STRAIGHT PIPE SPOOLS (OF SMALL LENGTH) & FITTINGS FOR SIZE ON 700 TO DN 1000.
4. EXISTING BARRIER TO BE REUSED.
3. ELEVATION BASED ON SITE SURVEY.
2. PLANT DATUM EL. 100.200 = EL. 222.220 ABOVE M.S.L.
1. ALL DIMENSIONS ARE IN MM AND CO-ORDINATES & ELEVATIONS ARE IN METRES UNLESS NOTED.

DESCRIPTION	AREA	SERIAL	SH.	P.	REV.	DATE	APPROVED BY
DRIVING KEY PLAN	NIM	1	2635	300	00	4	
PLOT PLAN	NIM	3	5060	002	00	1	
KEY PLAN - ENGG. PLOT PLAN	NIM	1	5089	001	1	A	JAN'00
	NIM	1	5082	001	1	O	JUN'99

REFERENCE DRAWINGS

IN CASE OF DEVIATIONS MARKED UP PRINT SHALL BE SENT TO COASTAL DESIGN OFFICE

REV.	DATE	DESCRIPTION	ISSUED FOR I.D.R.
0.1	NOV'10	DRN. BY LAILA	
		CHKD. BY VMB	
		APPRD. BY HOD	

CONTRACT NO. : C31/0606 PROJ. NO. : PAIP004005



DESCRIPTION : ISSUED FOR I.D.R.

REV.	DATE	DESCRIPTION	ISSUED FOR I.D.R.
A	APR'11	MIS	
O	DEC'10	LAILA	
		APPRD. BY HOD	

IN CASE OF DEVIATIONS A MARKED UP PRINT SHALL BE SENT TO THE PROJECT ENGINEER

AREA	SUB AREA	DRWG. TYPE	DESCRIPTION
NIMR	PRODUCTION STATION	PIPING G.A.(DEMOLITION)	CRUDE SLUDGE TANK AREA

PLANT NORTH

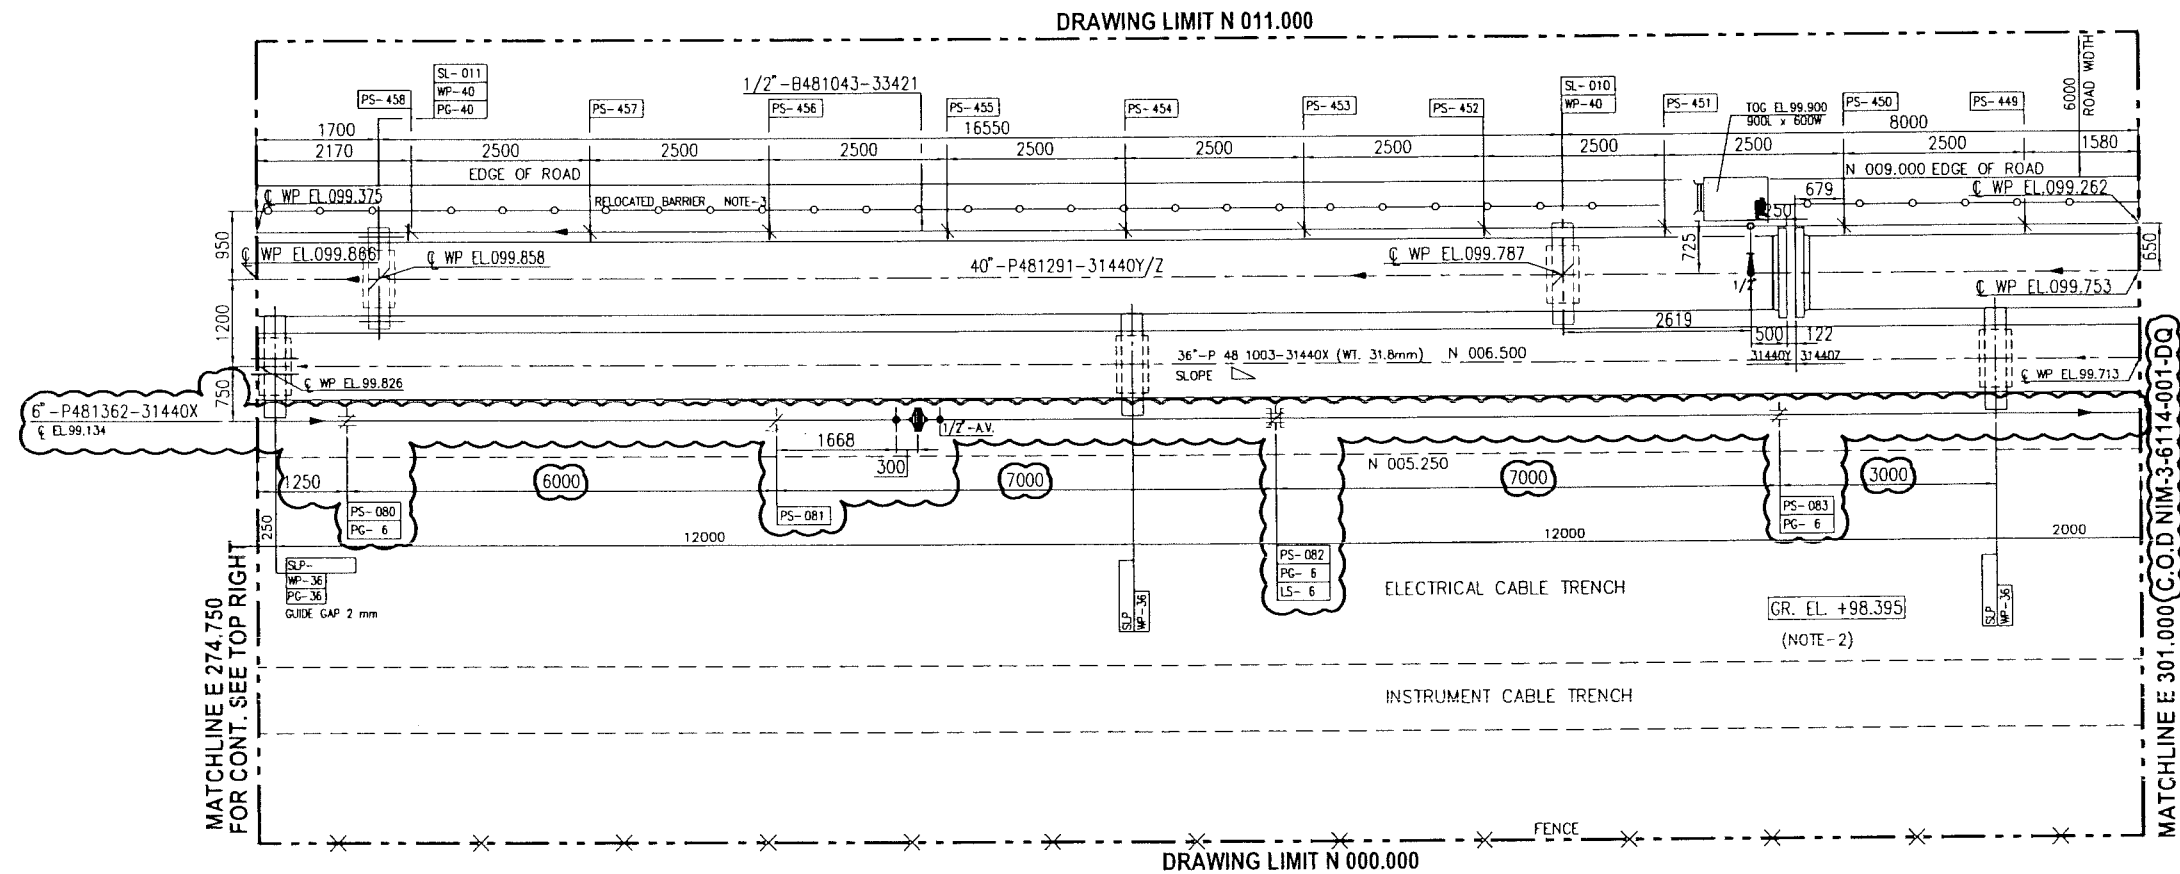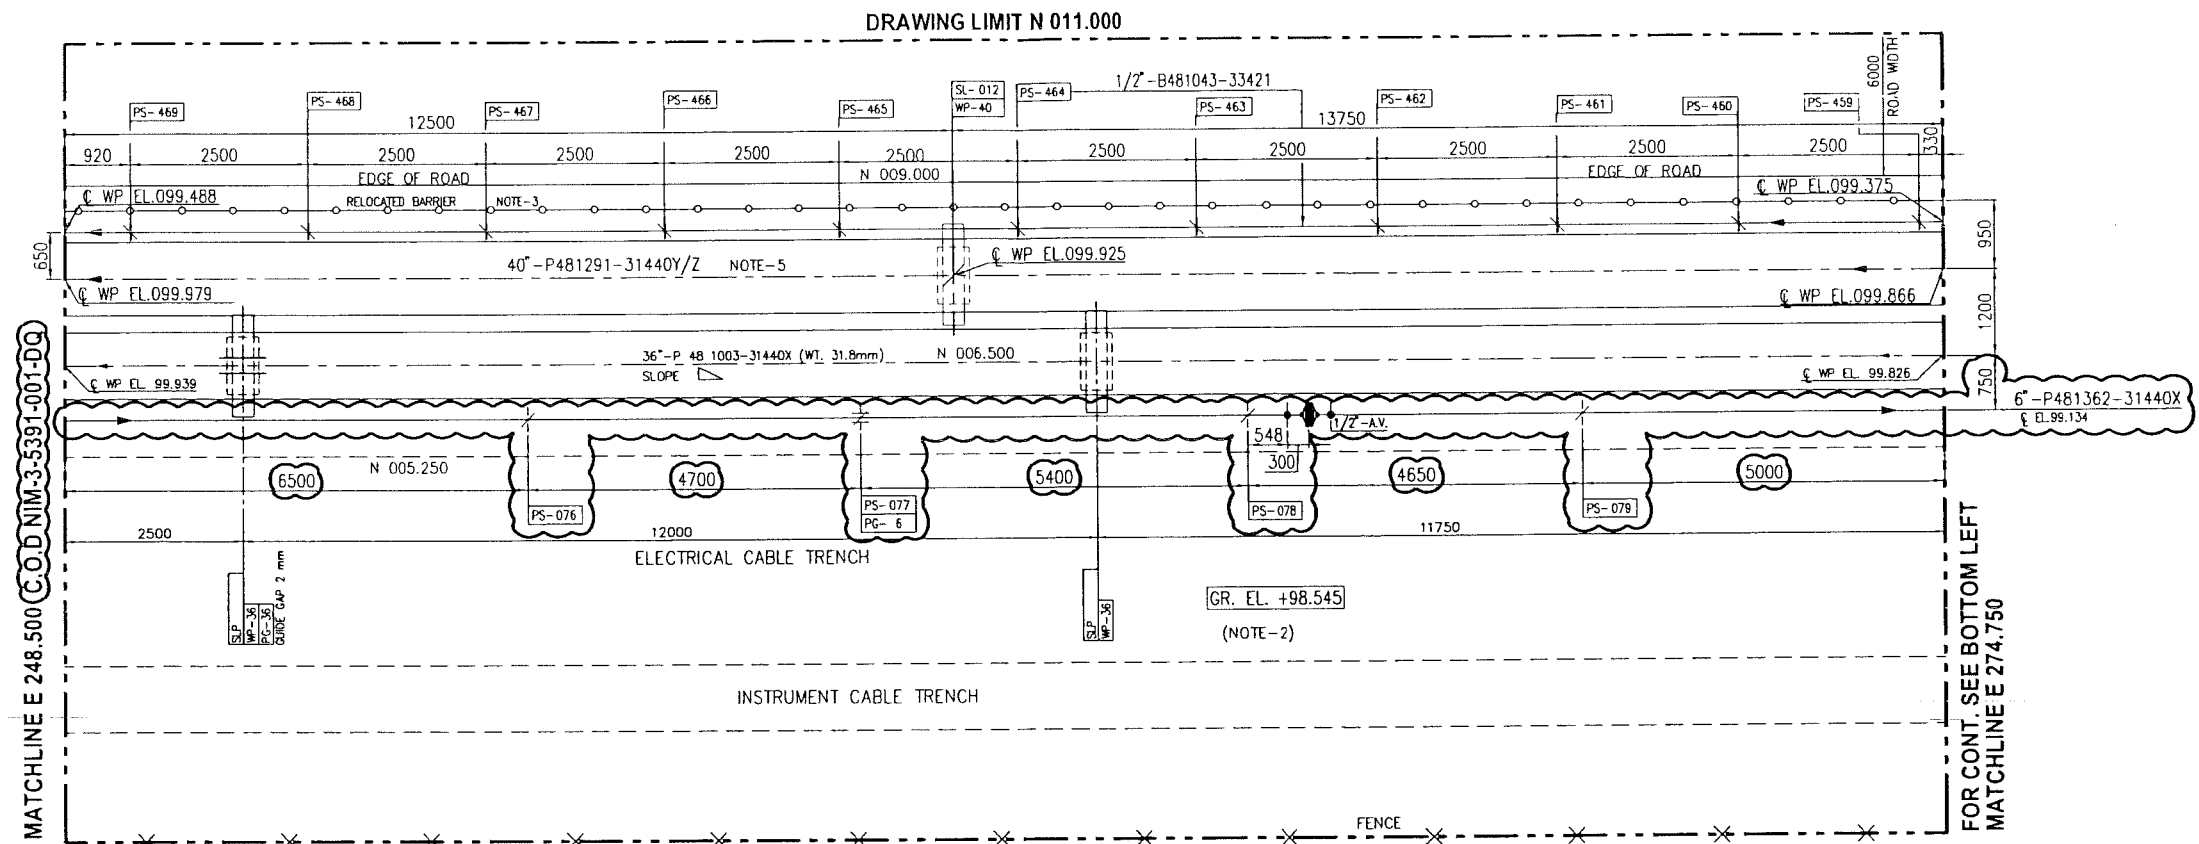

SCOPE OF PROJECT
WBS NO.
NIM.IN.09.011

THIS DRAWING IS MADE BASED ON
WBS No. NIM.IN.08.002
PROJ. CODE - CN

DESCRIPTION : ISSUED FOR I.D.B.			
REV.	0.1	DRN. BY	MIS
CHKD. BY		WMB	
DATE	JAN.11	APPRD. BY	MB

CONTRACT NO. : C310606 PROJ. NO. : PAIP00405
WorleyParsons-Arabian Industries (JV)

PROJECT DRAWING REVISION			
REV.	DATE	DESCRIPTION	BY
A	APR.11	MIS	APPROVED FOR CONSTRUCTION
0	JAN.11	MIS	ISSUED FOR COMMENTS

AREA	NIMR
SUB AREA	PRODUCTION STATION
NO.	05
DESCRIPTION	PIPING GA
SCALE	1:50
DATE	09-APR-2011
TIME	3:07:25 PM
BY	Mohd.Shahid

6. 31440X "X" INDICATE PIPING PE/ROTO LINED AND SUPER DUPLEX VALVES.
5. CLASS 31440Y COVERS PE LINED STRAIGHT PIPE SPOOLS FOR SIZE DN 50 TO DN 1000 AND FBE INTERNALLY COATED STRAIGHT PIPE SPOOLS & FITTINGS FOR SIZE DN 50 TO DN 600.
4. CLASS 31440Z COVERS FBE INTERNALLY COATED STRAIGHT PIPE SPOOLS (OF SMALL LENGTH) & FITTINGS FOR SIZE DN 700 TO DN 1000.
3. EXISTING BARRIER TO BE REUSED.
2. ELEVATION BASED ON SITE SURVEY.
1. ALL DIMENSIONS ARE IN MM AND ELEVATIONS/CO-ORDINATES ARE IN METRES UNLESS OTHERWISE NOTED.

DESCRIPTION	DRAWING NUMBER	AREA	SERIAL	SH.	P.	REV.	DATE	APPROVED BY
KEY PLAN FOR PIPING PLAN	NIM 1 2635 300 DC 4							
PIPING G.A. OVERALL KEY PLAN	NIM 3 5060 002 DC 1							
KEY PLAN - ENGG. PLOT PLAN	NIM 1 5059 001							
PLOT PLAN	NIM 1 5082 001							
	NIM 1 5089 001							

REFERENCE DRAWINGS

MASTER DRAWING REVISION
IN CASE OF DEVIATIONS MARKED UP PRINT SHALL BE SENT TO COASTAL DESIGN OFFICE

DRAWING LIMIT E 301.000


MATCHLINE E 301.000 (C.O.D. NIM-3-6115-001-DQ)

PLANT NORTH



DRAWING LIMIT N 011.000

DRAWING LIMIT S 023.500

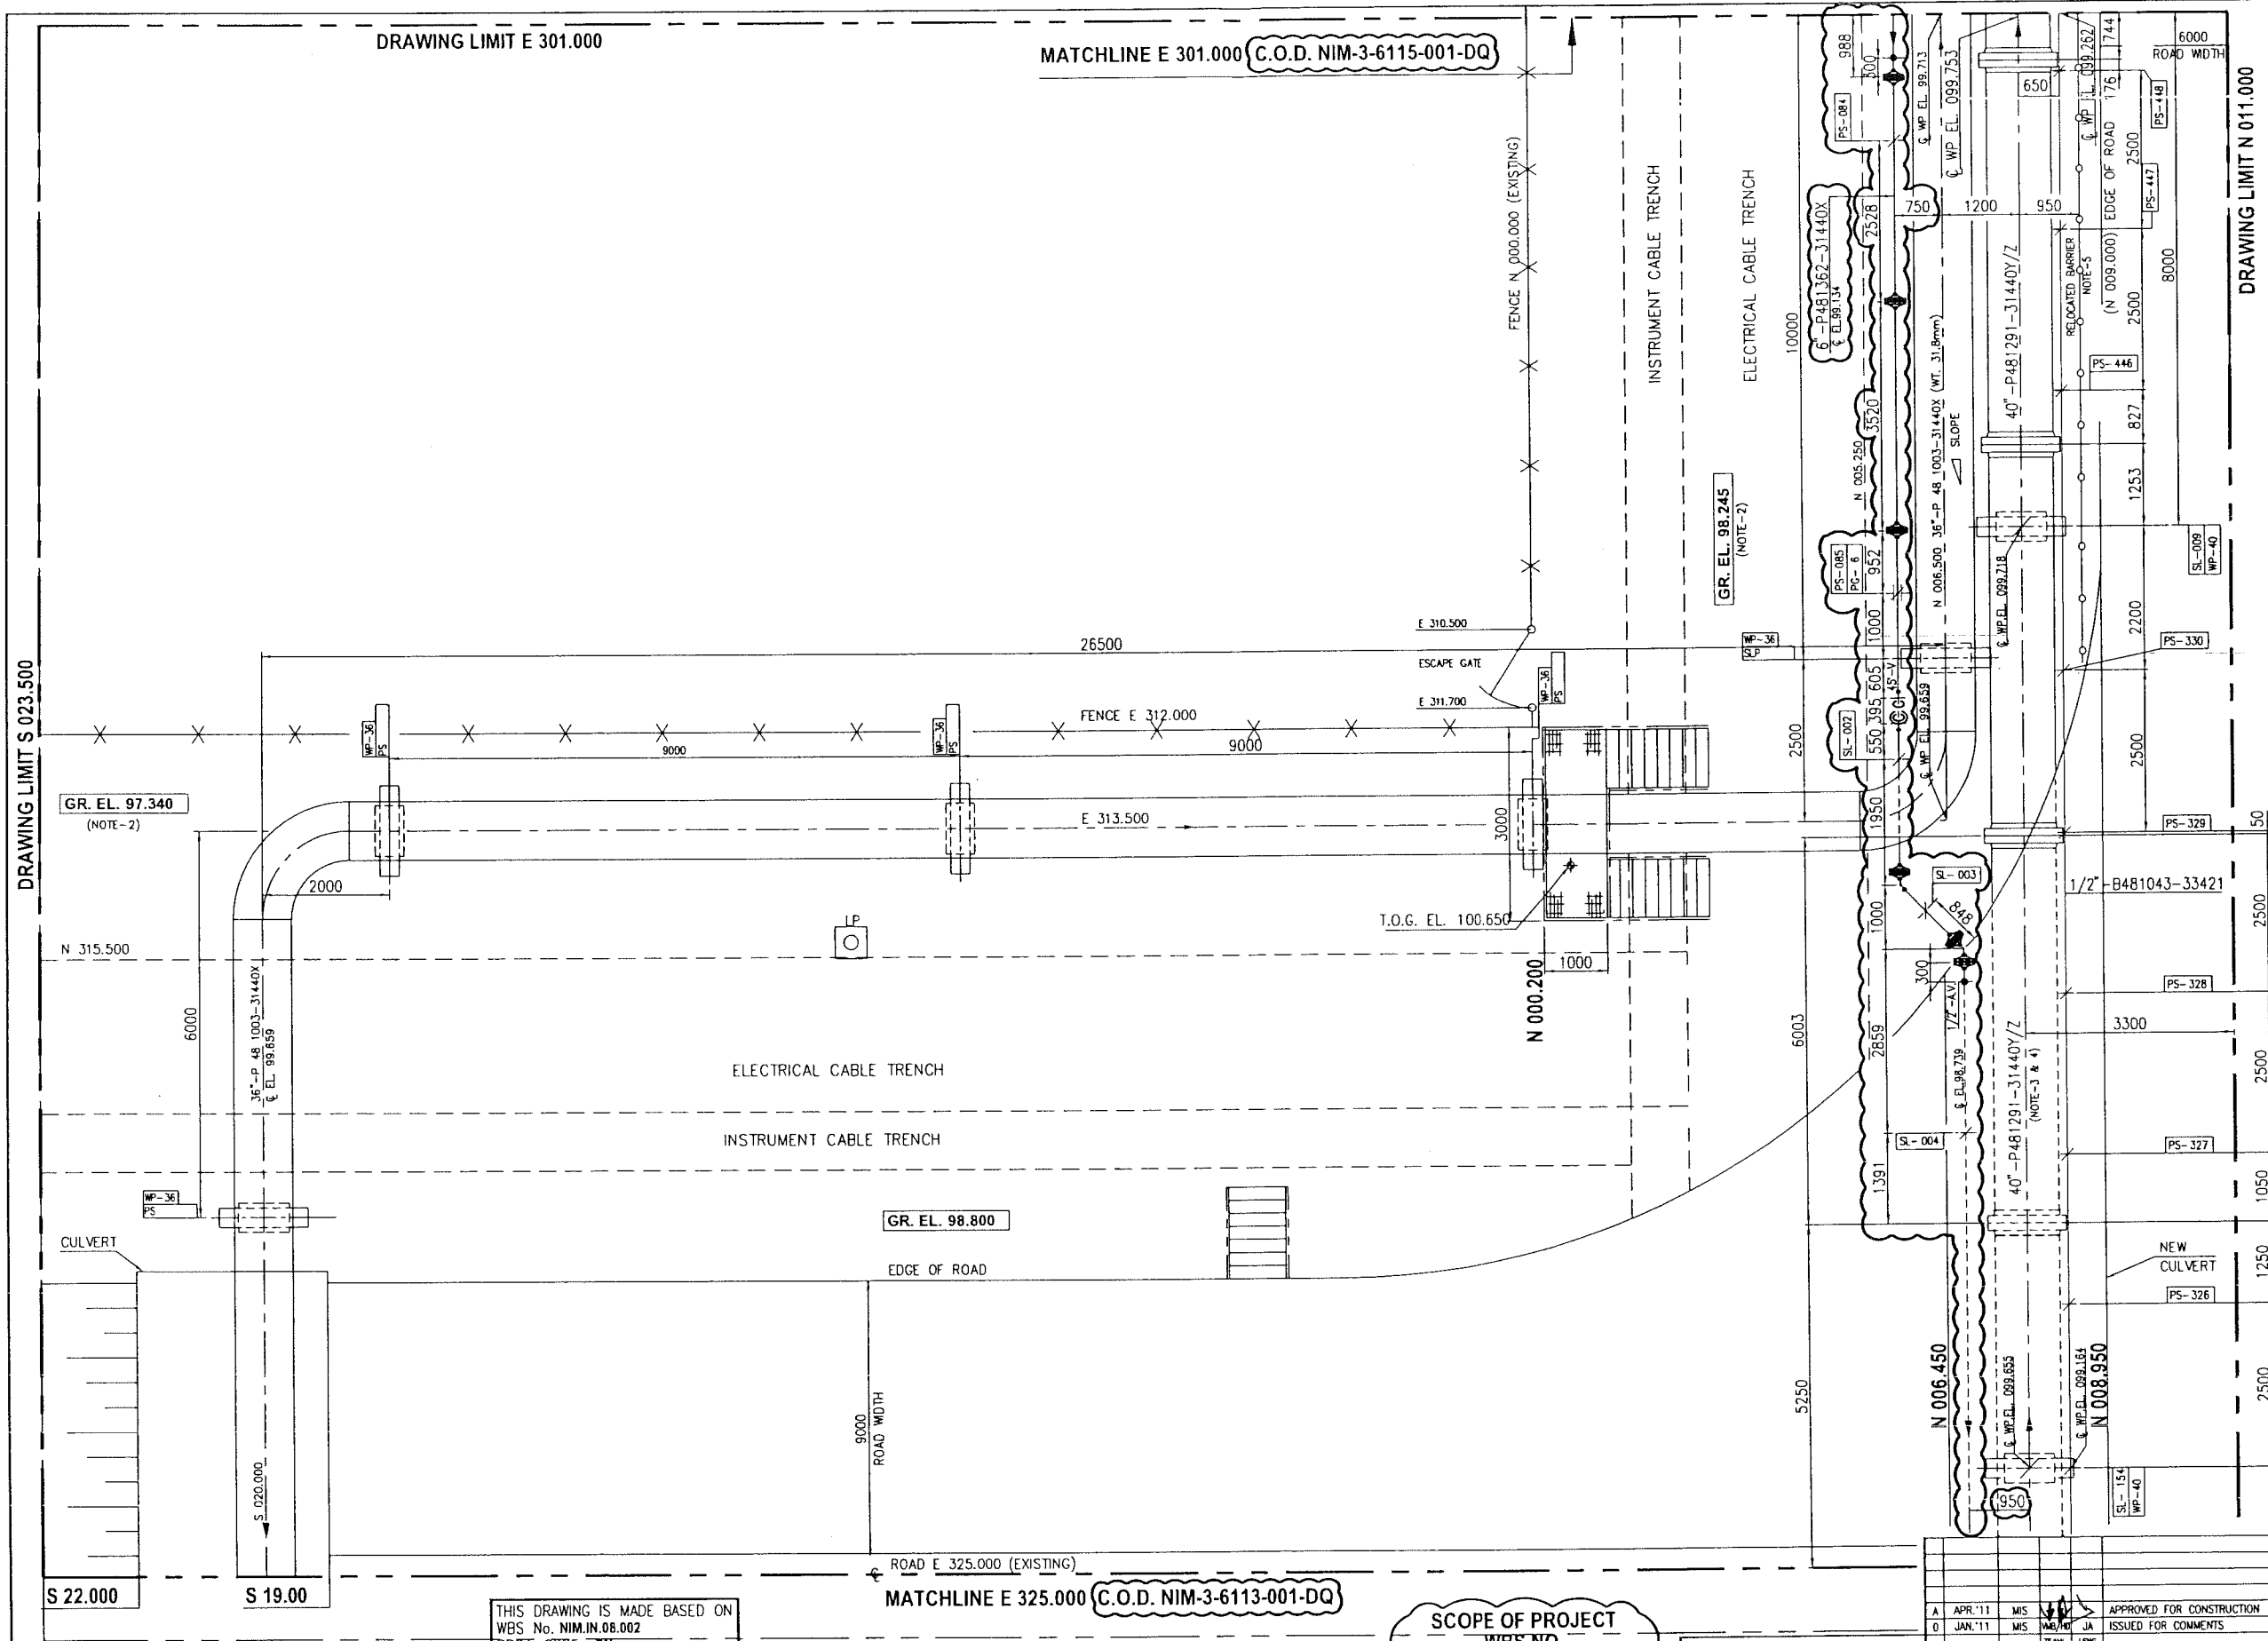

DESCRIPTION : ISSUED FOR I.D.B.			
REV.	0.1	DRAWN BY	MIS
DATE	JAN.11	CHKD. BY	VMB
		APPRO. BY	ME

APPROVED FOR CONSTRUCTION

THIS DRAWING IS MADE BASED ON
WBS No. NIM.IN.08.002
PROJ. CODE - CN

MATCHLINE E 325.000 (C.O.D. NIM-3-6113-001-DQ)

SCOPE OF PROJECT
WBS NO.
NIM.IN.09.011

6. 31440X 'X' INDICATE PIPING PE/ROTO LINED AND SUPER DUPLEX VALVES.
5. EXISTING BARRIER TO BE REUSED.
4. CLASS 31440Y COVERS PE LINED STRAIGHT PIPE SPOOLS FOR SIZE DN 50 TO DN 1000 AND FBE INTERNALLY COATED STRAIGHT PIPE SPOOLS & FITTINGS FOR SIZE DN 50 TO DN 600.
3. CLASS 31440Z COVERS FBE INTERNALLY COATED STRAIGHT PIPE SPOOLS (OF SMALL LENGTH) & FITTINGS FOR SIZE DN 700 TO DN 1000.
2. ELEVATION BASED ON SITE SURVEY.
1. ALL DIMENSIONS ARE IN MM AND ELEVATIONS/CO-ORDINATES ARE IN METRES UNLESS OTHERWISE NOTED.

DESCRIPTION	AREA	SERIAL	SL	P	S
DRAWING CONTROL INDEX	NIM	1	2635	300	DQ 4
KEY PLAN FOR PIPING PLAN	NIM	3	5060	002	DQ 1
PIPING G.A. OVERALL KEY PLAN	NIM	3	5059	001	1
PLOT PLAN	NIM	3	5285	001	1
PLOT PLAN	NIM	3	5089	001	1
KEY PLAN - ENGG. PLOT PLAN	NIM	1	5082	001	1
PLOT PLAN	NIM	1	5097	001	1

REFERENCE DRAWINGS

MASTER DRAWING REVISION
IN CASE OF DEVIATIONS MARKED UP PRINT SHALL BE SENT TO COASTAL DESIGN OFFICE

CONTRACT NO. : C31/0606 PROJ. NO. : PAIP00405
WorleyParsons-Arabian Industries (JV)

PROJECT DRAWING REVISION			
REV.	DATE	DESCRIPTION	BY
A	APR.11	ISSUED FOR CONSTRUCTION	MIS
0	JAN.11	ISSUED FOR COMMENTS	MIS


IN CASE OF DEVIATIONS A MARKED UP PRINT SHALL BE SENT TO THE PROJECT ENGINEER

AREA	NIMR	NO	05
SUB AREA	PRODUCTION STATION		
DRAWING TYPE	PIPING GA		
DESCRIPTION	36" INLET HEADER		

SCALE : 1:50 CAD DRAWING

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Petroleum Development Oman

DRWG	AREA	ENG	SERIAL	SHEET	PROJ	ENG	REV.
NIM	3	6114	001	DQ	1	A	

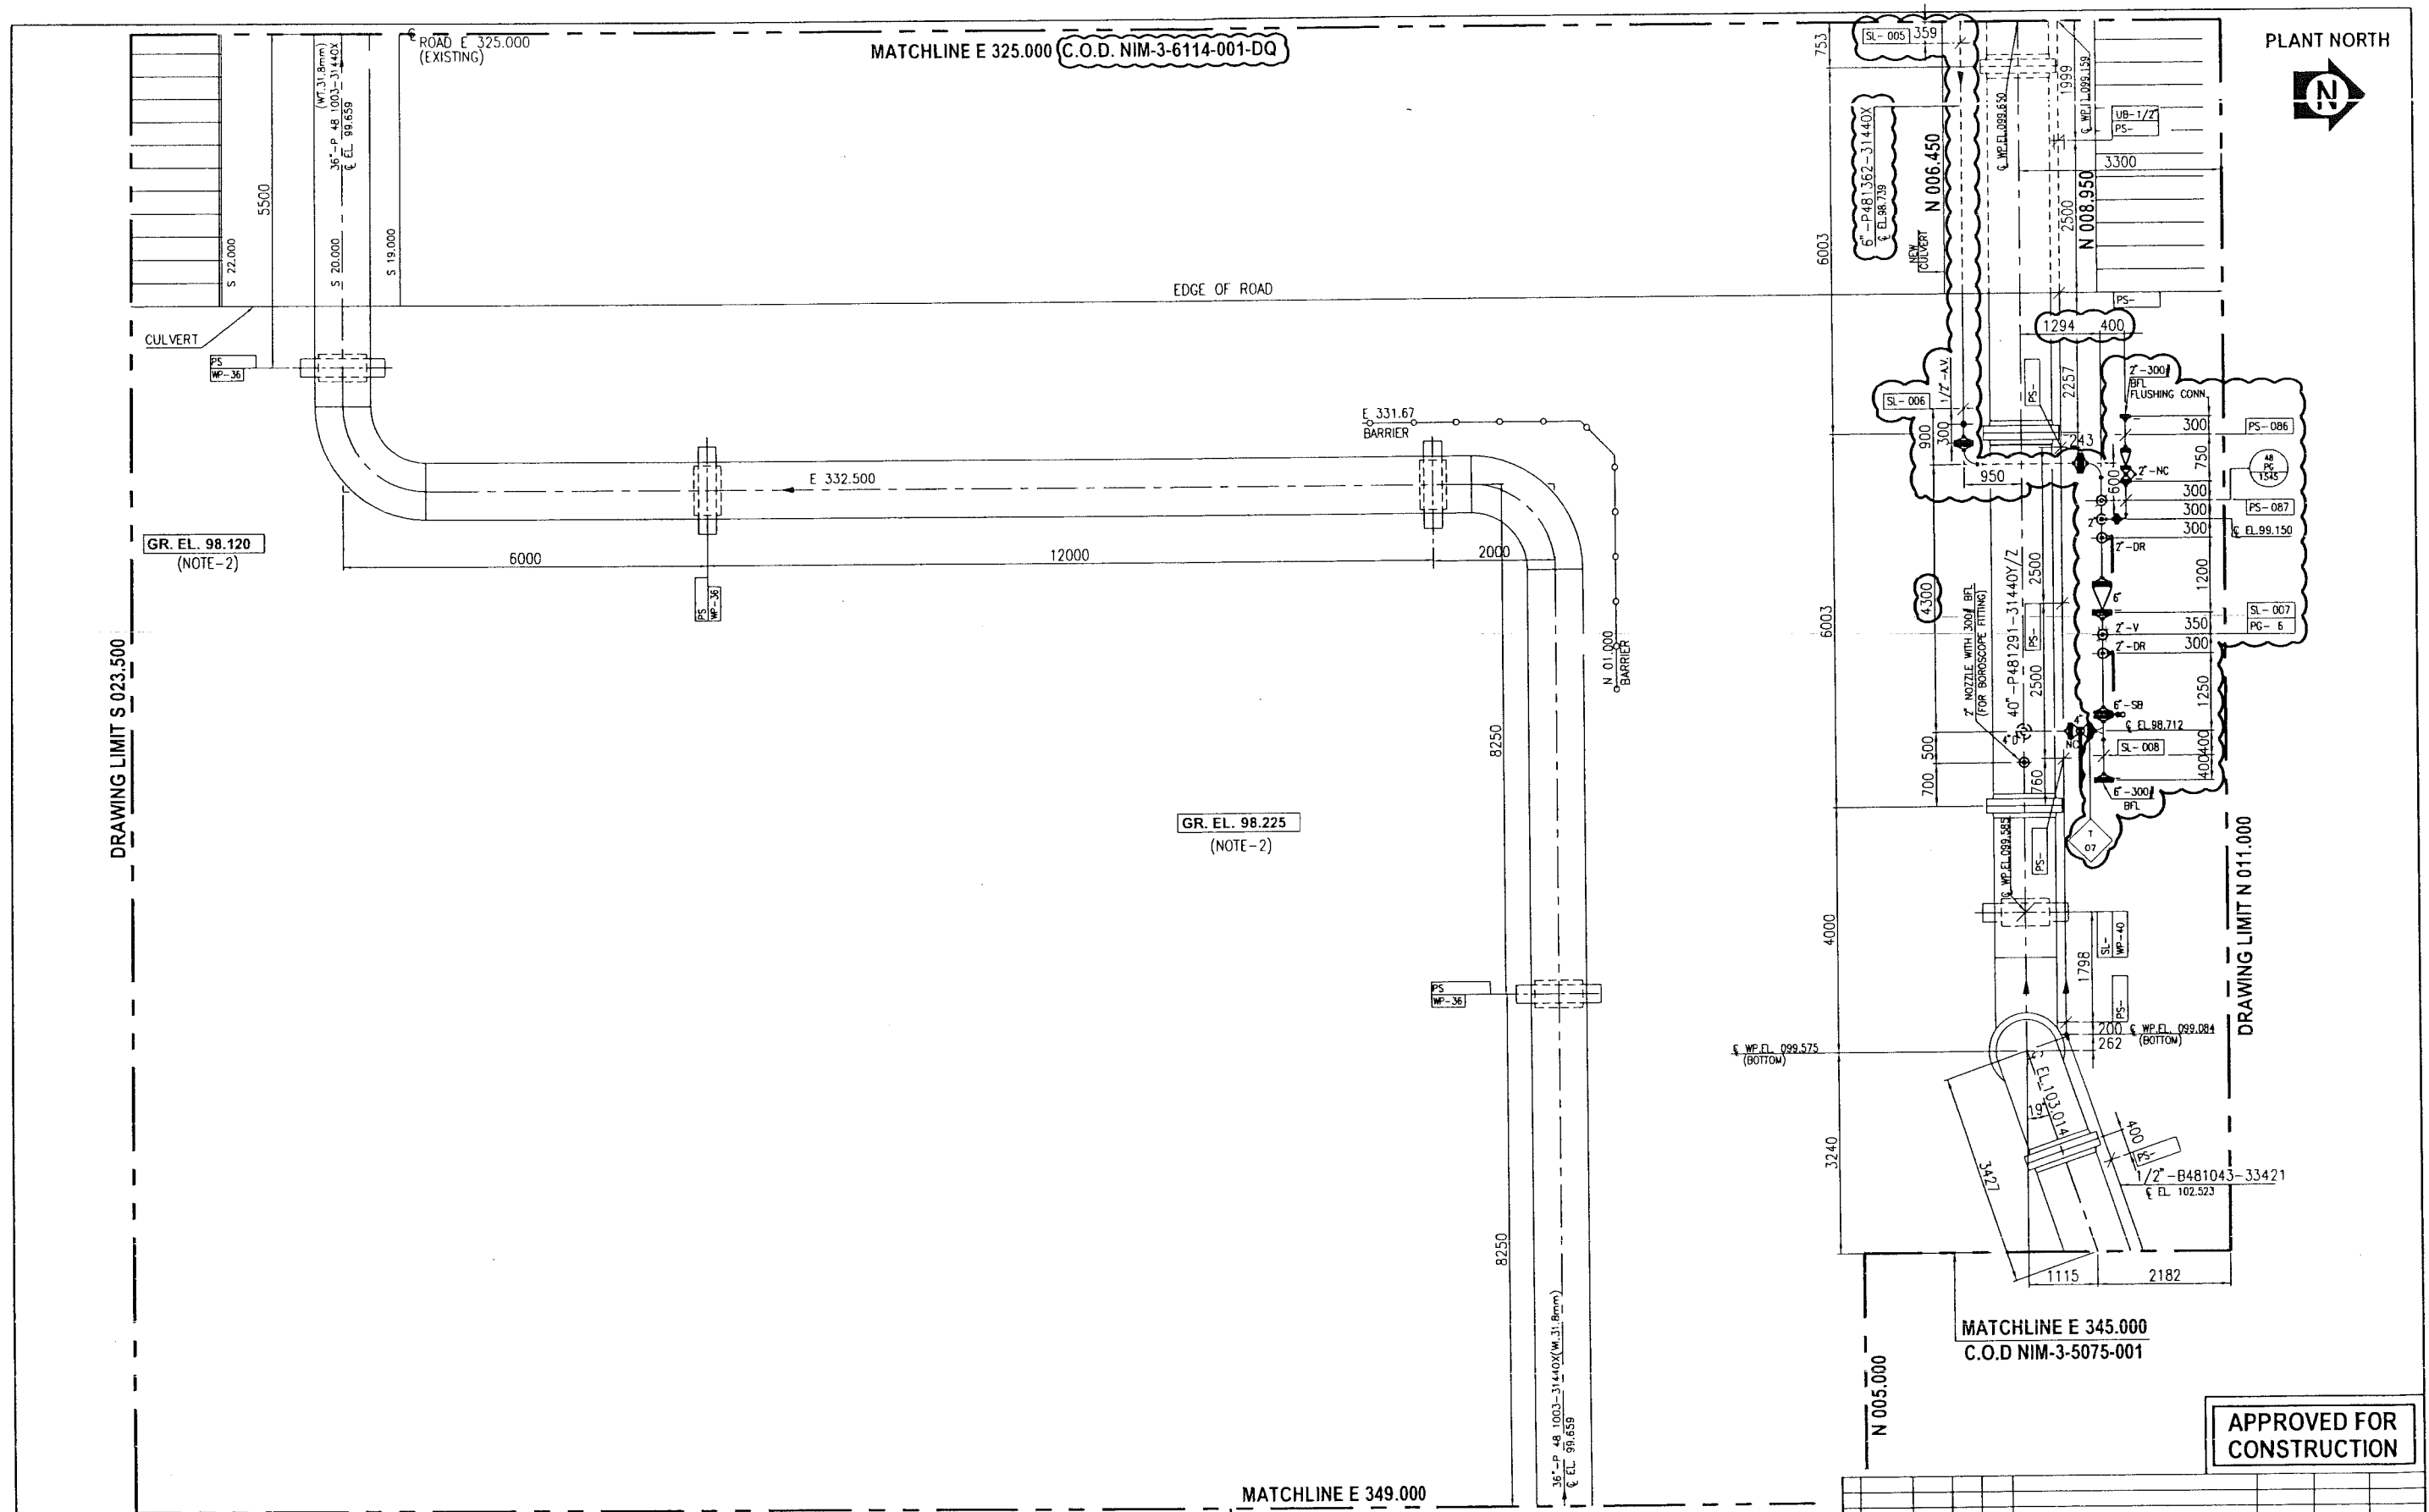

PLANT NORTH



DRAWING LIMIT S 023.500

DRAWING LIMIT N 011.000

GR. EL. 98.120
(NOTE-2)

GR. EL. 98.225
(NOTE-2)

DRAWING LIMIT E 349.000

SCOPE OF DEMOLITION
WBS NO.
NIM.IN.09.011

SCOPE OF PROJECT
WBS NO.
NIM.IN.09.011

THIS DRAWING IS MADE BASED ON
WBS No. NIM.IN.08.002
PROJ. CODE- CN

MATCHLINE E 349.000
C.O.D NIM-3-6112-001

MATCHLINE E 345.000
C.O.D NIM-3-5075-001

APPROVED FOR
DEMOLITION

3. CLASS 314402 COVERS FBE INTERNALLY COATED STRAIGHT PIPE SPOOLS (OF SMALL LENGTH) & FITTINGS FOR SIZE ON 700 TO DN 1000.
2. ELEVATION BASED ON SITE SURVEY.
1. ALL DIMENSIONS ARE IN MM. AND ELEVATIONS / CO-ORDINATES ARE IN METRES UNLESS OTHERWISE NOTED.

DESCRIPTION	AREA	SERIAL	SL	P	S
DRAWING CONTROL INDEX	NIM	1	2635	300	DQ 4
KEY PLAN FOR PIPING PLAN	NIM	3	5285	001	DQ 1
PIPING G.A. OVERALL KEY PLAN	NIM	3	5059	001	
KEY PLAN - ENGG. PLOT PLAN	NIM	1	5082	001	
PLOT PLAN	NIM	0	5090	001	
PLOT PLAN	NIM	1	5097	001	

REFERENCE DRAWINGS

REV.	DATE	BY	CHKD. BY	APPRD. BY
0.1	JAN '11	MIS	VMB	MB



WorleyParsons-Arabian Industries (WPAI)

CONTRACT NO.: C31/0606 PROJ. NO.: PAIP00405

DESCRIPTION	WBS NO.	PROLOG	SPECLNG	POD APPROVAL
AS BUILT FOR PROJECT 'SB'	04.002			
ORIGINAL ISSUE	04.002			

IN CASE OF DEVIATIONS MARKED UP PRINT SHALL BE SENT TO COASTAL DESIGN OFFICE

REV.	DATE	BY	CHKD. BY	APPRD. BY
0	JAN '11	MIS	VMB	MB

DESCRIPTION	WBS NO.	PROLOG	SPECLNG	POD APPROVAL
IN CASE OF DEVIATIONS A MARKED UP PRINT SHALL BE SENT TO THE PROJECT ENGINEER				

AREA	SUB AREA	DRWG TYPE	DESCRIPTION
NIMR	PRODUCTION STATION	PIPING GA (DEMOLITION)	36" INLET HEADER


NO.	AREA	ENG	SERIAL	SHEET	PROJ	DATE	REV.
NIM	0	6113	001	DQ	1	A	

COVER SHEET

TIE-IN SCHEDULE

NIMR SLUDGE PITS SYSTEM UPGRADE

APPROVED FOR
CONSTRUCTION

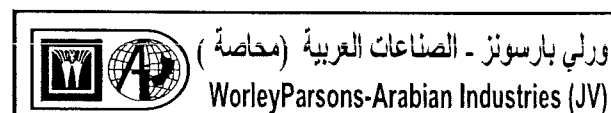

CONTRACT NO. : C31/0606 PROJ. NO. : PAIP00405

B	APR.'11	MIS		APPROVED FOR CONSTRUCTION	IN.09.011	OSE/28N	
A	JAN.'11	MIS	VMB/HD	JA	RE-ISSUED FOR COMMENTS	IN.09.011	OSE/28N
0	DEC.'10	MIS	VMB/HD	NNP	ISSUED FOR COMMENTS	IN.09.011	OSE/28N
REV	DATE	DRAWN BY	TEAML.	J.ENG.	DESCRIPTION	W.B.S. NO.	PROJ. ENG. SIGNATURE
			CHECKED				P D O APPROVAL

PROJECT DRAWING REVISION

IN CASE OF DEVIATIONS A MARKED UP PRINT SHALL BE SENT TO THE PROJECT ENGINEER

AREA : NIMR

SUB AREA : NIMR SLUDGE PIT

NO. 05

DRWG. TYPE : TIE-IN SCHEDULE

DESCRIPTION : COVER SHEET

SCALE : NTS
0 1 2 3 4 5 6 7



شركة تنمية نفط عُمان
Petroleum Development Oman

DRWG	AREA CODE	ENG SECT	SERIAL NUMBER	SHEET	PROJ CODE	DWG SIZE	REV.
NO	NIM	3	2143	001	DQ	3	B

DRAWING CONTROL INDEX REFER

NIM -2635-300-DQ

REV	DATE	APPROVED BY	DESCRIPTION	W.B.S. NO.	PROJ.ENG.	SPEC.ENG.

PDO APPROVAL

NOTES/REFERENCE DRAWINGS
IN CASE OF DEVIATIONS MARKED UP PRINT SHALL BE SENT TO COASTAL DESIGN OFFICE

MASTER DRAWING REVISION

TIE-IN NO.	DESCRIPTION	TIE-IN TYPE	P.E.F.S.	PIPING PLAN	LINE NO.	ISOMETRIC	REMARKS
T 01	DISMANTLE THE EXISTING PIPE SPOOL AND CONNECT NEW 4" - 150# FLANGED PIPE SPOOL.	F2	NIM-1-5030-001-DQ	NIM-3-5085-001-DQ	P48079	NIM-3-2144-016-DQ	
T 02	DISMANTLE THE EXISTING PIPE SPOOL AND ADD NEW 4" - 150# BLIND FLANGE.	F3	NIM-1-5030-001-DQ	NIM-3-5085-001-DQ	P48079	NIM-3-2144-021-DQ	
T 03	DISMANTLE THE EXISTING PIPE SPOOL AND ADD NEW 2" - 150# BLIND FLANGE.	F3	NIM-1-5030-001-DQ	NIM-3-5085-001-DQ	D48183	NIM-3-2144-040-DQ	
T 04	DISMANTLE THE EXISTING PIPE SPOOL AND CONNECT NEW 3" - 150# FLANGED PIPE SPOOL.	F2	NIM-1-5040-002-DQ	NIM-3-5085-001-DQ	D48477	NIM-3-2144-037-DQ	
T 06A	DISMANTLE THE EXISTING SCREWED PIPE AND CONNECT THE NEW PIPE SPOOL WITH UNION JOINTS.	T4	NIM-1-5054-001-DQ	NIM-3-5391-001-DQ	A48054	NIM-3-2144-032-DQ	
T 06B	CUT THE EXISTING PIPE AND CONNECT THE NEW PIPE SPOOL WITH SCREWED COUPLING.	T5	NIM-1-5054-001-DQ	NIM-3-5391-001-DQ	A48054	NIM-3-2144-032-DQ	
T 07	DISMANTLE THE EXISTING BLIND FLANGE AND CONNECT NEW 4" - 300# FLANGED PIPE SPOOL.	F2	NIM-1-3637-001-DQ	NIM-3-6113-001-DQ	P481291	NIM-3-2144-017-DQ	

BUTT WELD	B1		B2		B3		B4		B5		B6		B7	
FLANGED	F1		F2		F3		F4		F5		F6		F7	
THREADED	T1		T2		T3		T4		T5		T6		T7	
HOT TAP	H1		H2		GRE PIPING									
					G1	G2	G3	G4						


LEGEND :		APPROVED FOR CONSTRUCTION
	- EXISTING	
	- NEW	
SCALE : NTS		CAD DRAWING
0 1 2 3 4 5 6 7		
شركة تنمية نفط عُمان Petroleum Development Oman		
DRWG	AREA CODE	REV.
NO	NIM 3 2143 003 DQ	3 B

COVER SHEET

ISOMETRIC AND MTO.

NIMR SLUDGE PITS SYSTEM UPGRADE

APPROVED FOR
CONSTRUCTION

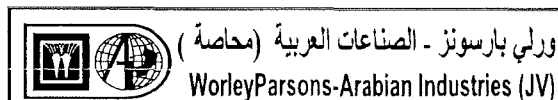

CONTRACT NO.: C31/0606 PROJ. NO.: PAIP00405

0	APR.'11	MD	TEAM	J.ENG.	APPROVED FOR CONSTRUCTION	NIM.IN.09.001	OSE/28N
REV	DATE	DRAWN BY	CHECKED		DESCRIPTION	W.B.S. NO.	PROJ. ENG. SIGNATURE
				P D O APPROVAL			

PROJECT DRAWING REVISION

IN CASE OF DEVIATIONS A MARKED UP PRINT SHALL BE SENT TO THE PROJECT ENGINEER

AREA	: NIMR	SCALE : NTS	CAD DRAWING
SUB AREA	: NIMR SLUDGE PIT	NO. 05	
DWG. TYPE	: ISOMETRICS AND MTO		
DESCRIPTION	: COVER SHEET		
DWG	AREA CODE	ENG SECT	SERIAL NUMBER
NO	NIM	3	2144 001 DQ
		SHEET	PROJ CODE
		DWG SIZE	REV.
		3	0



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Petroleum Development Oman

DRAWING CONTROL INDEX REFER	REV	DATE	APPROVED BY	DESCRIPTION	W.B.S. NO.	PROJ.ENG.	SPEC.ENG.
NIM-1-2635-300-DQ							

NOTES/REFERENCE DRAWINGS MASTER DRAWING REVISION
IN CASE OF DEVIATIONS MARKED UP PRINT SHALL BE SENT TO COASTAL DESIGN OFFICE

		REVISION & DATE OF ISSUE OF DOCUMENT																	
SHEET NO.	DESCRIPTION	O	APR.'11	A	B	C	D	E	F	G	H	I	J	K	L	M	N	P	Q
		REVISION OF SHEETS																	
001	COVER SHEET	0																	
002	INDEX & ISSUE SHEET	0																	
003	ISSUE SHEET	0																	
004	ISSUE SHEET	N/A																	
005	ISSUE SHEET	N/A																	
006	ISSUE SHEET	N/A																	
007	ISSUE SHEET	N/A																	
008	PE LINING DETAILS	0																	
009	GENERAL NOTES	0																	
010	ISO SYMBOL SHEET	0																	

SHEET NO.	CONTENTS/LINE No.	REVISION & DATE OF ISSUE OF DOCUMENT											SHEET NO.	REVISION & DATE OF ISSUE OF DOCUMENT										
		O	A	B	C	D	E	F	G	H	I	REMARKS		O	A	B	C	D	E	F	G	H	I	REMARKS
		APR.'11													APR.'11									
REVISION OF ISOMETRIC SHEETS												REVISION OF ISOWISE MTO SHEETS												
011	P481329	0											511	0										
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013	P481330	0											513	0										
014	P481331	0											514	0										
015	P481332	0											515	0										
016	SPARE												516											
017	P481335	0											517	0										
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021	SPARE												521											
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024	P481357	0											524	0										
025	P48079/D48183	0											525	0										
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028	B481024	0											528	0										
029	B481025	0											529	0										
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031	B481032	0											531	0										
032	B481036	0											532	0										
033	B481039	0											533	0										
034	SPARE												534											
035	SPARE												535											

APPROVED FOR
CONSTRUCTION



ورلي بارسونز - الصناعات العربية (مخاصة)
WorleyParsons-Arabian Industries (JV)

CONTRACT NO.: C31/0606 PROJ. NO.: PAIP00405

NOTES

AREA : NIMR

SUB AREA : NIMR SLUDGE PIT

NO. 05

DWG. TYPE : ISOMETRICS AND MTO

DESCRIPTION : INDEX AND ISSUE SHEET

SCALE : NTS

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CAD DRAWING



شركة تنمية نفط عُمان


Petroleum Development Oman

DWG.	AREA CODE	ENG SECT	SERIAL NUMBER	SHEET	PROJ CODE	DWG SIZE	REV.
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NO	NIM	3	2144	002	DQ	3	0
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
SHEET NO.	CONTENTS/LINE No.	REVISION & DATE OF ISSUE OF DOCUMENT											SHEET NO.	REVISION & DATE OF ISSUE OF DOCUMENT											
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		APR.'11												APR.'11											
REVISION OF ISOMETRIC SHEETS													REVISION OF ISOWISE MTO SHEETS												
036	A48911	0											536	0											
037	D482612	0											537	0											
038	D482625	0											538	0											
039	D482626	0											539	0											
040	D482627	0											540	0											
041	D482624	0											541	0											
042	SPARE												542												
043	D482643	0											543	0											
044													544												
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APPROVED FOR
CONSTRUCTION


 ورلي بارسونز - الصناعات العربية (محاصة)
WorleyParsons-Arabian Industries (JV)

CONTRACT NO.: C31/0606 PROJ. NO.: PAIP00405


NOTES

AREA : NIMR	SCALE : NTS 0 1 2 3 4 5 6 7	CAD DRAWING
SUB AREA : NIMR SLUDGE PIT	NO. 05	 شركة تنمية نفط عُمان Petroleum Development Oman
DWG. TYPE : ISOMETRICS AND MTO	DWG. AREA ENG SERIAL SHEET PROJ DWG REV. CODE CODE SECT NUMBER CODE SIZE	
DESCRIPTION : ISSUE SHEET	NO NIM 3 2144 003 DQ 3 0	


PIPE SPOOL INTERNAL PE LINING

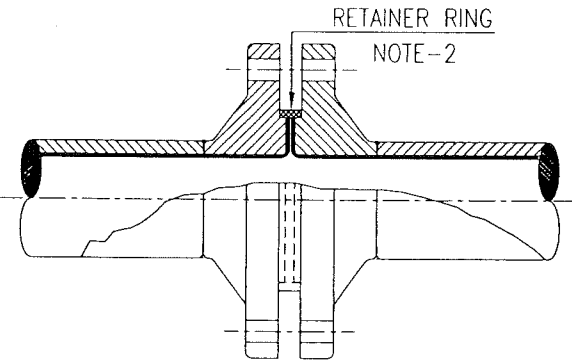

TYPICAL ROTO LINED FLANGE JOINT DETAIL

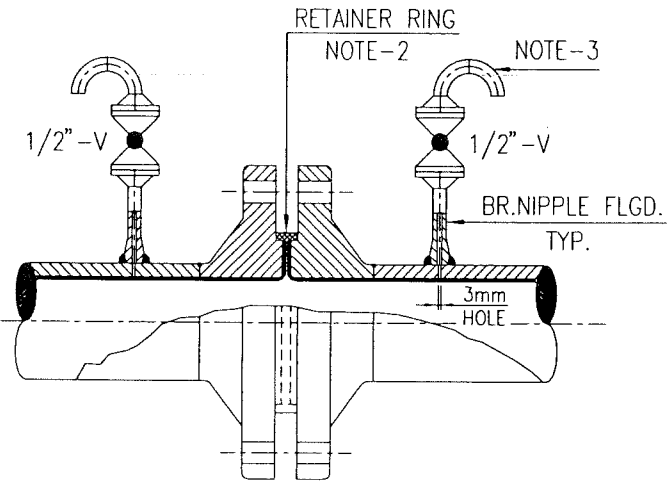

TYPICAL PE LOOSE LINED FLANGE JOINT DETAIL
OIL & GAS SERVICE

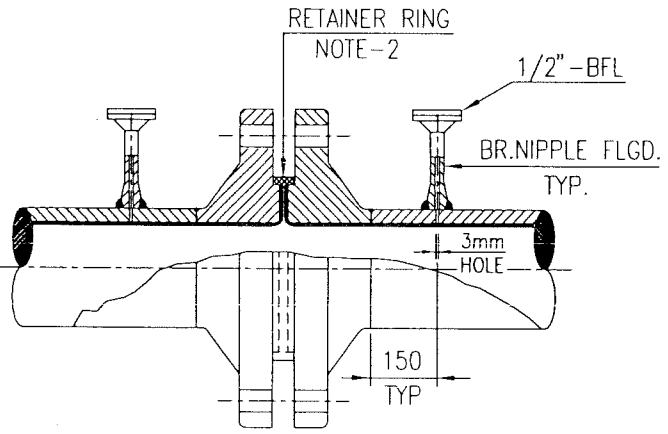

TYPICAL PE LOOSE LINED FLANGE JOINT DETAIL
WATER SERVICE

NOTES:

1. REFER ERD-43-15 FOR SPECIFICATION OF POLYETHYLENE LINER.
2. RETAINING RING SHALL BE SUPPLIED BY THE PE LINING VENDOR.
3. ANNULUS VENT ORIENTATION TO BE DECIDED AT SITE.
4. PIPE SPOOLS SHALL BE PE LINED-LOOSE OR ROTO LINED DEPENDING ON THE SPOOL LENGTH GEOMETRY.
5. TABLE-A ALL DIMENSIONS SHALL BE CONSIDERED AS DIAGONAL LENGTH.
6. GUIDELINE FOR ROTO-LINING OF SPOOL IS SHOWN IN THE TABLE-A BELOW.

TABLE-A (NOTE-6) ROTO LINING-DIMENSIONAL CAPABILITIES			
NOMINAL SIZE	STRAIGHT LENGTH SPOOLS (Max.)	BENDS (Max.)	TEE (Max.)
3"	2500mm	2500mm	2500mm
4" TO 12"	3500mm	3500mm	3500mm
14" TO 20"	3500mm	3350mm	3350mm
24"	3150mm	3300mm	3000mm
26"	3000mm	3300mm	3000mm
30"	3000mm	3300mm	3000mm
34"	3000mm	3300mm	2500mm
36"	3000mm	3300mm	2100mm
40"	2800mm	3300mm	
42"	2800mm		

NOTE: PIPE SPOOL DIMENSION IS NOT APPLICABLE IF SPOOL WEIGHT IS MORE THAN 2250 Kgs.

7. ENSURE THAT ALL ROTO LINED PIPE SPOOL DIMENSIONS ARE VERIFIED AND APPROVED BY PE LINING CONTRACTOR PRIOR TO FABRICATION.
8. PIPE SPOOL DIMENSIONS ARE GIVEN FROM THE FACE OF CS FLANGE (EXCLUDING LINING THICKNESS)
9. FOR ROTO LINING MIN. BRANCH OFF SIZE SHALL BE 2".
10. FOR PE LOOSE LINING MIN. PIPE SIZE SHALL BE 4".
11. FOR ON PLOT PIPING, PE LOOSE LINER STRAIGHT PIPE SPOOL LENTGTH OF 19.0 M.(Max.) SHALL BE CONSIDERED.
12. THE PE LINED PIPE SPOOL TO BE FABRICATED WITH THE INSIDE EDGES OF THE RAISED FACE FLANGES GROUND TO RADIUS OF 6mm.
13. FOR PE LINED PIPE SPOOLS, INTERNAL WELDING PENETRATION & BURNS SHALL BE CONTROLLED & GROUND FLUSH WITH THE WALL WHEREVER POSSIBLE TO GRIND FROM INSIDE.

APPROVED FOR
CONSTRUCTION

AREA : NIMR

SUB AREA : NIMR SLUDGE PIT

NO. 05

DWG.TYPE : ISOMETRICS & MTO

DESCRIPTION : PE LINING DETAILS

SCALE : NTS
0 1 2 3 4 5 6 7



شركة تنمية نفط عُمان
Petroleum Development Oman

DWG	AREA CODE	ENG SECT	SERIAL NUMBER	SHEET	PROJ CODE	DWG SIZE	REV.
NO	NIM	3	2144	008	DQ	3	0



ورلي بارسونز - الصناعات العربية (محاصة)
WorleyParsons-Arabian Industries (JV)

CONTRACT NO.: C31/0606 PROJ. NO.: PAIP00405


GENERAL NOTES

1. ALL DIMENSIONS ON ISOMETRICS ARE IN MILLIMETRES. ELEVATIONS AND CO-ORDINATES ARE IN METRES, UNLESS OTHERWISE NOTED.
2. ROUTING INDICATED FOR LINES 1 1/2" & BELOW IS FOR GUIDANCE ONLY. EXACT ROUTING TO BE DECIDED AT SITE.
3. FIELD WELDS TO BE DECIDED AT SITE BY PIPING CONTRACTOR.
4. PIPES, PIPE FITTINGS AND VALVES ON ISOMETRIC DRAWINGS ARE SHOWN IN ACCORDANCE WITH SHEET NO. 010
5. BUILT-IN DIMENSIONS FOR VALVES ON ISOMETRIC DRAWINGS ARE GENERALLY INCLUDING THE THICKNESS OF GASKETS.
6. NO ALLOWANCE FOR WELD GAP IS GIVEN ON ISOMETRIC DRAWINGS. OVERALL DIMENSIONS OF CLOSED ASSEMBLIES OF FITTINGS, OR FITTINGS AND FLANGES ARE SHOWN ON THE BASIS OF THE NET SUM OF THE NOMINAL DIMENSIONS OF THE PIPE COMPONENTS.
7. THE BENDING RADIUS OF PULLED BENDS SHALL NOT BE LESS THAN 5 x D (D=NOMINAL PIPE SIZE).
8. UNLESS NOTED ON ISOMETRIC, ORIENTATION OF SPECTACLE BLINDS SHALL BE AS FOLLOWS:

(a) SPECTACLE BLINDS IN HORIZONTAL LINES : UP

(b) SPECTACLE BLINDS IN VERTICAL LINES : AS SHOWN IN PIPING GENERAL ARRANGEMENT DWG.
9. IN GENERAL THE MATERIAL FOR WELDED FLOOR STANDS AND WELDED DUMMY SUPPORTS IS INCLUDED IN THE 'LIST OF MATERIAL' OF THE PIPELINE CONCERNED.
10. LOCATION OF PIPE SUPPORTS ARE SHOWN WITH PIPE SUPPORT NOS. ON PIPING ARRANGEMENT DRAWINGS. AND FOR PIPE ATTACHMENTS SUCH AS SHOES, TRUNNIONS AND DUMMIES ETC. REFER LIST OF DRAWING NO. **NIM - 2 - 1842 - 001- DQ, NIM - 2 - 1842 - 001- DQ**
11. FOR PE LINING DETAILS REFER SHEET NO. 008
12. DRAWING NO. FOR BILL OF MATERIAL SHEET IS NOTED ON ISOMETRIC. ALSO REFER ISO-INDEX WHICH GIVES LINE WISE ISO SHEET NO. & MTO SHEET NO. REFER LINE LIST FOR PEFS NO. AND DESCRIPTION OF "FROM" & "TO"
13. FOR INSULATED LINES REFER SPEC. DEP.30.46.00.31.GEN.
14. PIPE MATERIAL CONNECTED TO EQUIPMENT (LOOSE MATERIAL LIKE VENTS, DRAINS, PRESSURE CONNECTIONS AND STAND PIPE ETC.) ARE SHOWN ON ISOMETRIC DRAWINGS AS VESSEL TRIM.
15. ITEMS HAVING RATINGS NOT IN LINE WITH PIPE CLASS ARE CALLED OUT.
16. HANDWHEEL / WRENCH ORIENTATION FOR THE 2" AND ABOVE VALVES REFER PIPING PLAN,

17. CHAMFER OF 15° AS SHOWN BELOW SHALL BE APPLIED IN CASE OF PIPE CLASS CHANGE. ALL OTHER WELD-END PREPARATIONS SHALL BE IN ACCORDANCE WITH APPLICABLE ASME AND/OR ANSI STANDARD.

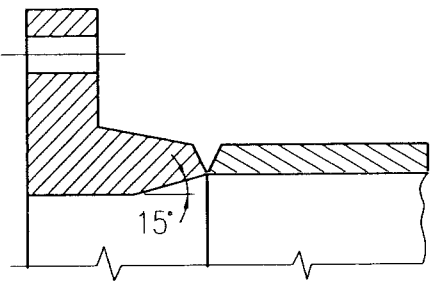

18. PIPE SUPPORTS AND DIMENSIONS MARKED WITH CLOUD ARE UNDER HOLD AWAITING VENDOR INFORMATION.
19. FOR STANDARD SYMBOLS REFER SHEET NO.010
20. PIPE FABRICATION AND TESTING SHALL BE AS PER THE FOLLOWNG SP & DEP'S.

SP-1173 SPECIFICATION FOR WELDING OF ON-PLOT PIPE WORK (AMMENDMENTS/SUPPLEMENTS TO ASME B31.3).

SP-1176 NON-DESTRUCTIVE EXAMINATION(AMMENDMENTS/SUPPLEMENTS TO ASME BPV CODE SECTION V).


SP-2051 SPECIFICATION FOR FLUSHING, PRESSURE TESTING, PICKLING AND SENSITIVE LEAK TESTING OF MECHANICAL EQUIPMENT AND PIPING.

SP-2020 FLANGE CONNECTIONS-BOLTING TORQUING AND TENSIONING.

SP-1246 SPECIFICATION FOR PAINTING & COATING OF OIL AND GAS PRODUCTION FACILITIES.

DEP 31.38.01.31 SHOP AND FIELD FABRICATION OF PIPING.

APPROVED FOR
CONSTRUCTION

AREA : NIMR		SCALE : NTS		CAD DRAWING			
SUB AREA : NIMR SLUDGE PIT		NO. 05		 شركة تنمية نفط عُمان Petroleum Development Oman			
DWG. TYPE : ISOMETRICS AND MTO		DWG.	AREA CODE	ENG SECT	SERIAL NUMBER	SHEET	PROJ CODE
DESCRIPTION : GENERAL NOTES		NO	NIM	3	2144	009 DQ	3 0







ورلي بارسونز - الصناعات العربية (محصاة)
WorleyParsons-Arabian Industries (JV)


CONTRACT NO.: C31/0606

PROJ. NO.: PAIP00405


1.0 PIPING SYMBOLS

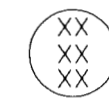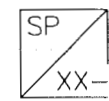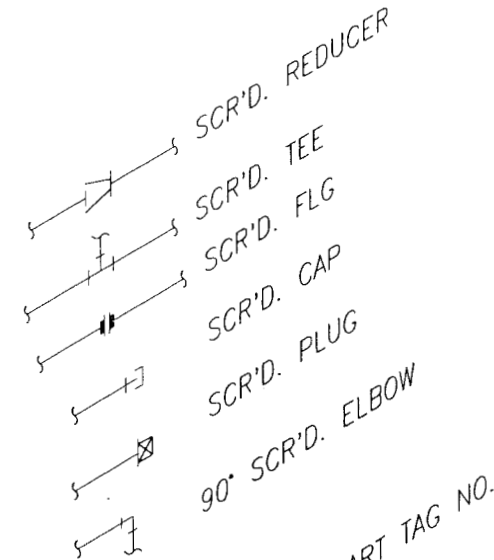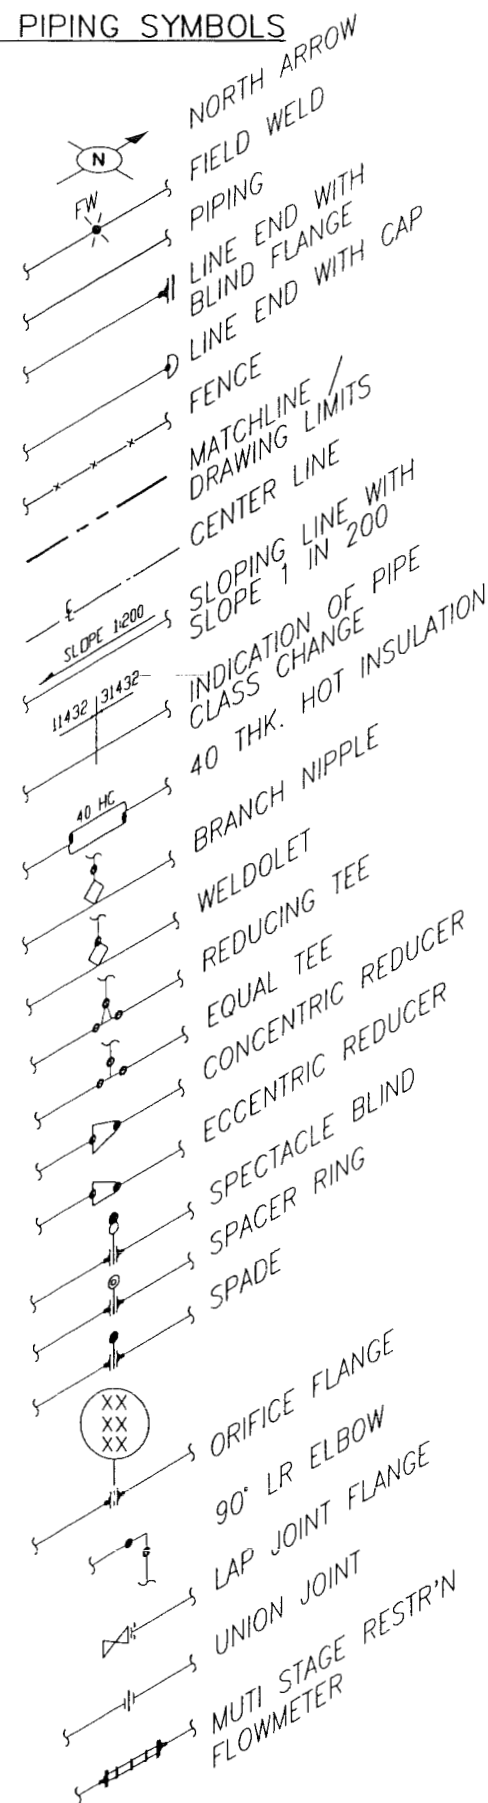


4.0 PIPE SUPPORTS

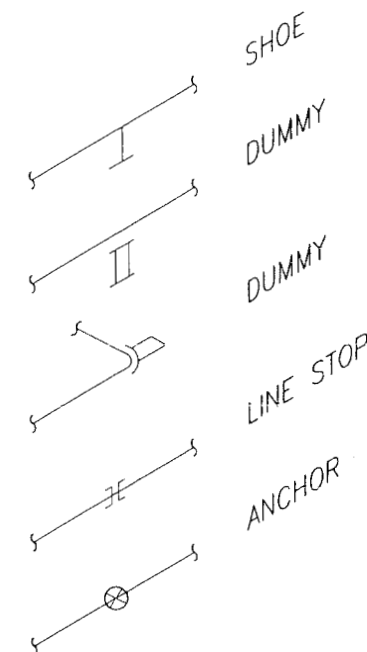

2.0 VALVE SYMBOLS

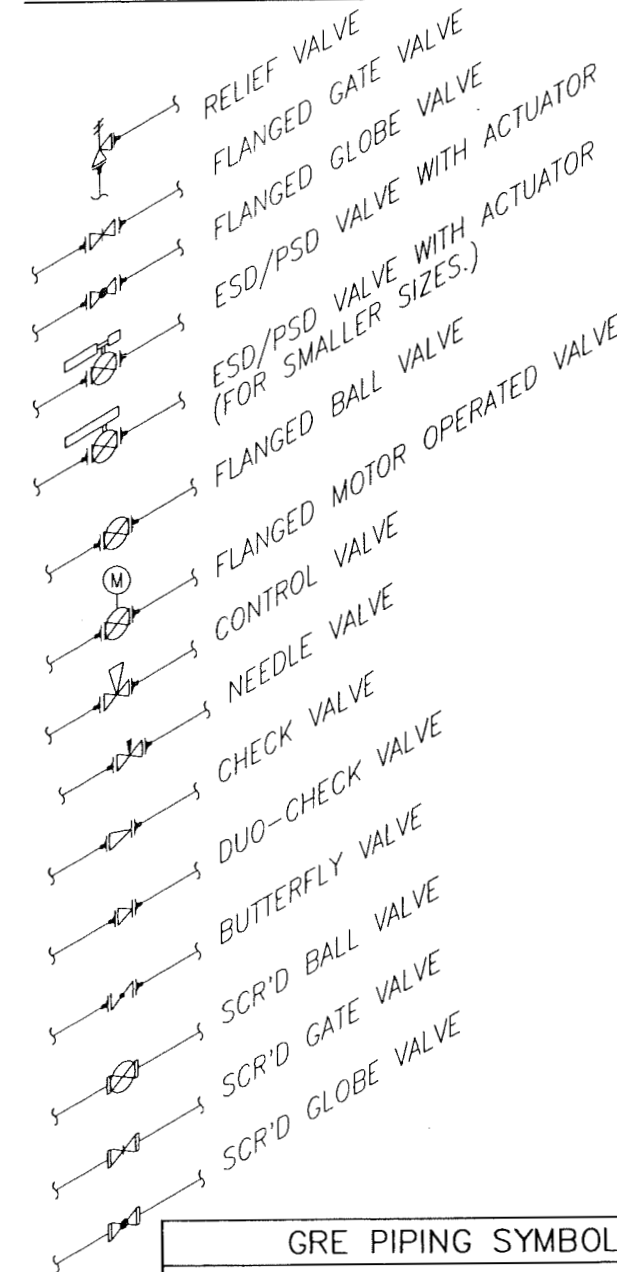

GRE PIPING SYMBOLS

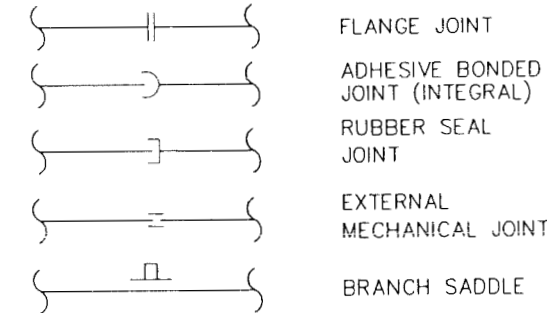

3.0 PIPING ABBREVIATIONS

BF	BOTTOM FLAT
BFL	BLIND FLANGE
BOC	BOTTOM OF CONCRETE
BOP	BOTTOM OF PIPE
BTL	BOTTOM TANGENT LINE
CL	CENTER LINE
CONT.	CONTINUED
C.O.D.	CONTINUED ON DRAWING
D	DRAIN POINT (PROCESS)
DWG	DRAWING
DBB	DOUBLE BLOCK BLEED MONOBLOCK VALVE
ECC.	ECCENTRIC
ESD	EMERGENCY SHUTDOWN
EL.	ELEVATION
FB	FULL BORE
FFL	FINISHED FLOOR LEVEL
FLG.	FLANGE
FOF	FACE OF FLANGE
F.P.	FIXED SADDLE
HD	HYDRO TEST DRAIN
HV	HYDRO TEST VENT
LC	LOCKED CLOSED
LO	LOCKED OPEN
RED.	REDUCER
REF	REFERENCE
RV	RELIEF VALVE
SBB	SINGLE BLOCK BLEED MONOBLOCK VALVE
SC	SAMPLE CONNECTION
SHT.	SHEET
S.P.	SLIDING SADDLE
TF	TOP FLAT
TL	TANGENT LINE
TOC	TOP OF CONCRETE
TOG	TOP OF GRATING
TOS	TOP OF STEEL
TYP.	TYPICAL
MTO	MATERIAL TAKE-OFF
MOV	MOTOR OPERATED VALVE
NC	NORMALLY CLOSED
PSD	PROCESS SHUTDOWN
UC	UTILITY CONNECTION
V	VENT POINT (PROCESS)
WP EL.	WORKING POINT ELEVATION
PE	POLYETHYLENE

APPROVED FOR CONSTRUCTION

AREA : NIMR

SUB AREA : NIMR SLUDGE PIT

NO. 05

DWG. TYPE : ISOMETRICS AND MTO

DESCRIPTION : ISO SYMBOL SHEET


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شركة تنمية نفط عُمان
Petrochem Development Oman

DWG	AREA CODE	ENG SECT	SERIAL NUMBER	SHEET	PROJ CODE	DWG SIZE	REV.
NO	NIM	3	2144	010	DQ	3	0

ورلي بارسونز - الصناعات العربية (مخاصة)
WorleyParsons-Arabian Industries (JV)

CONTRACT NO.: C31/0606 PROJ. NO.: PAIP00405

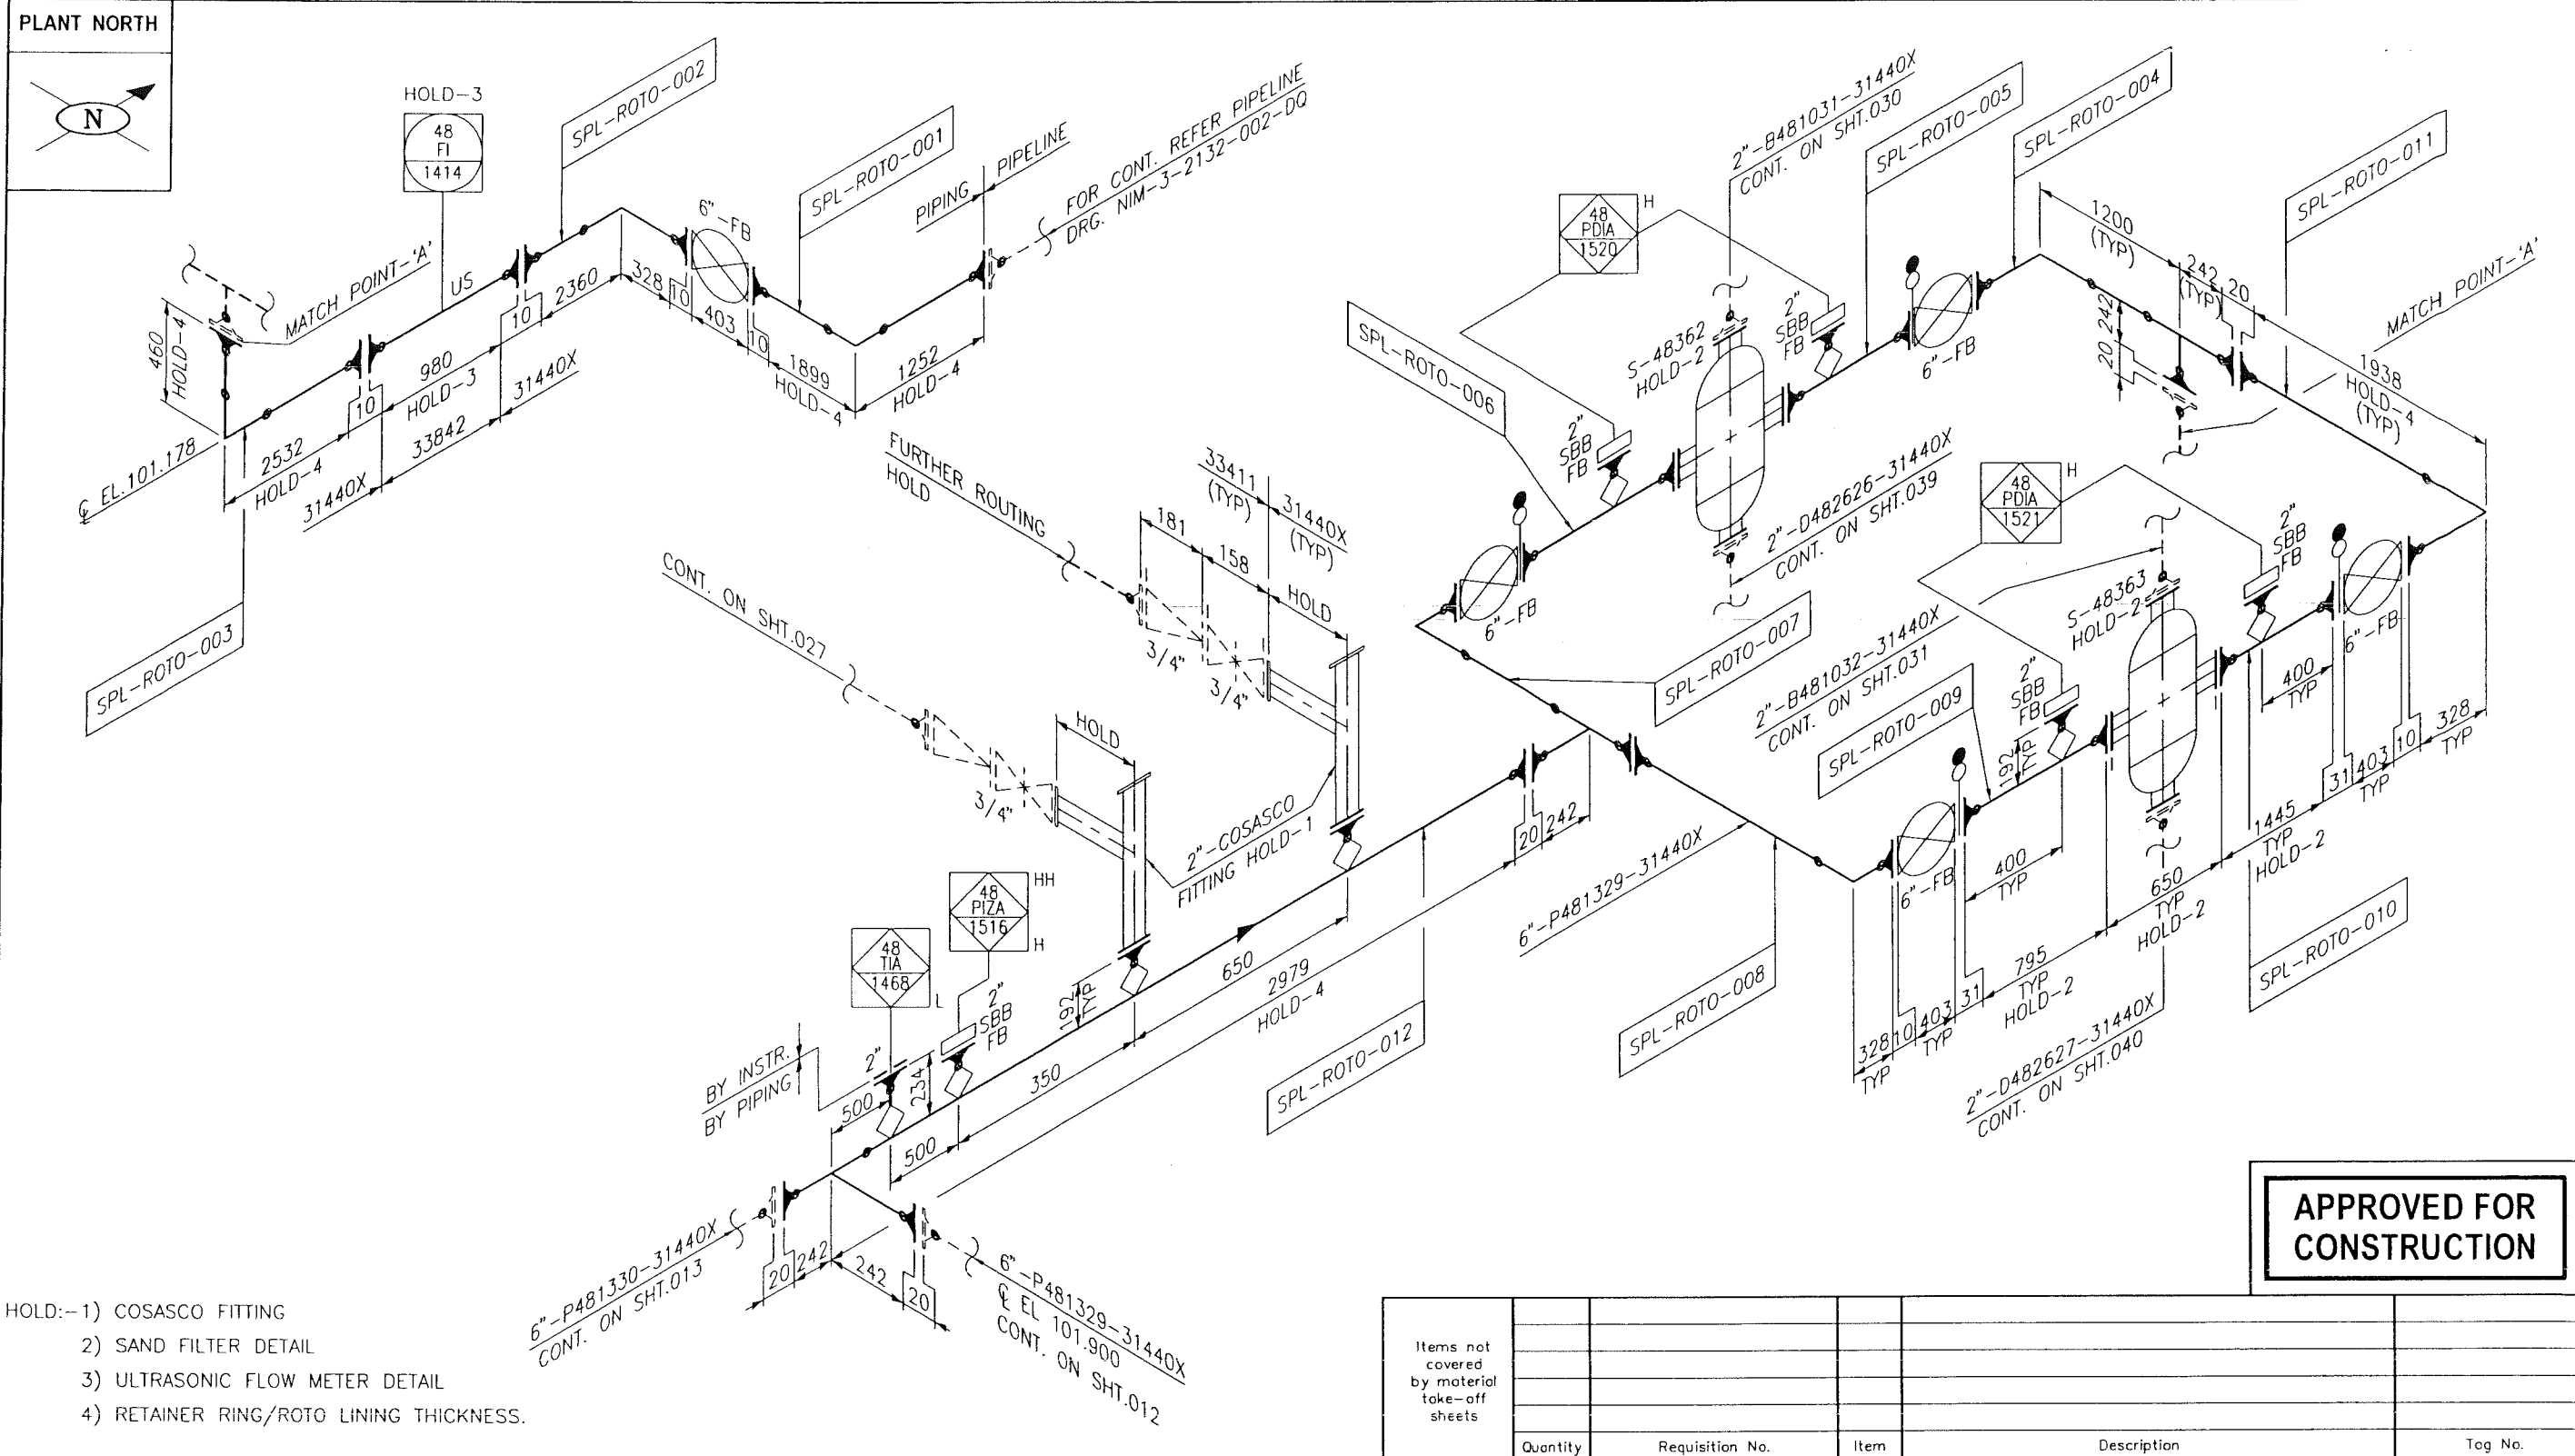

- HOLD:-1) COSASCO FITTING
 2) SAND FILTER DETAIL
 3) ULTRASONIC FLOW METER DETAIL
 4) RETAINER RING/ROTO LINING THICKNESS.

- 4) 31440X INDICATE PE/ROTO PIPING LINED AND VALVES WITH BODY & TRIM OF 25%CR SDSS
 3) DIMENSION TO BE CHECKED & CONFIRMED AT SITE PRIOR TO FABRICATION.
 2) FOR PE/ROTO LINING DETAILS REFER SHEET NO.008
 1) FOR GENERAL NOTES REFER SHEET No. 009
 NOTES:

ورلي بارسونز - الصناعات العربية (محاصة)
 WorleyParsons-Arabian Industries (JV)

CONTRACT NO.: C31/0606 PROJ. NO.: PAIP00405

MTO DWG. No. :

DO NOT MAKE ANY MODIFICATION WITHOUT
 CONFIRMATION FROM DESIGN DEPT.
 AS THIS IS STRESS CRITICAL LINE.


STRESS RELIEVED	NO
NDT REQUIREMENT	RT10 % RANDOM
INSULATION	NIL THK.
PAINTING	PCS 1 OF SP1246
W.B.S. No.	IN.09.011
PIPING ARRGT. DRWG.	MIN-3-2140-001-DQ MIN-3-2141-001-DQ

MADE BY :	DATE :	CHKD BY :	APPRD BY :	TITLE :
MD	APR.'11			PIPING ISOMETRIC NIMR SLUDGE PITS SYSTEM UPGRADE-FED AND DD
DESIGN PRESSURE	4782 kPag	PIPING CLASS	LINE No.	
DESIGN TEMP.	5 TO 82 °C	31440X	P481329	
HYDRO TEST PRESS.	7173 kPag			
REV.	0			
DATE	APR.'11			
SIGN.				

شركة تنمية نفط عمان
 Petroleum Development Oman

DWG.	AREA CODE	ENG SECT	SERIAL NUMBER	SHEET	PROJ CODE	DWG SIZE	REV
NO	NIM	3	2144	011	DQ	3	0

PLANT NORTH

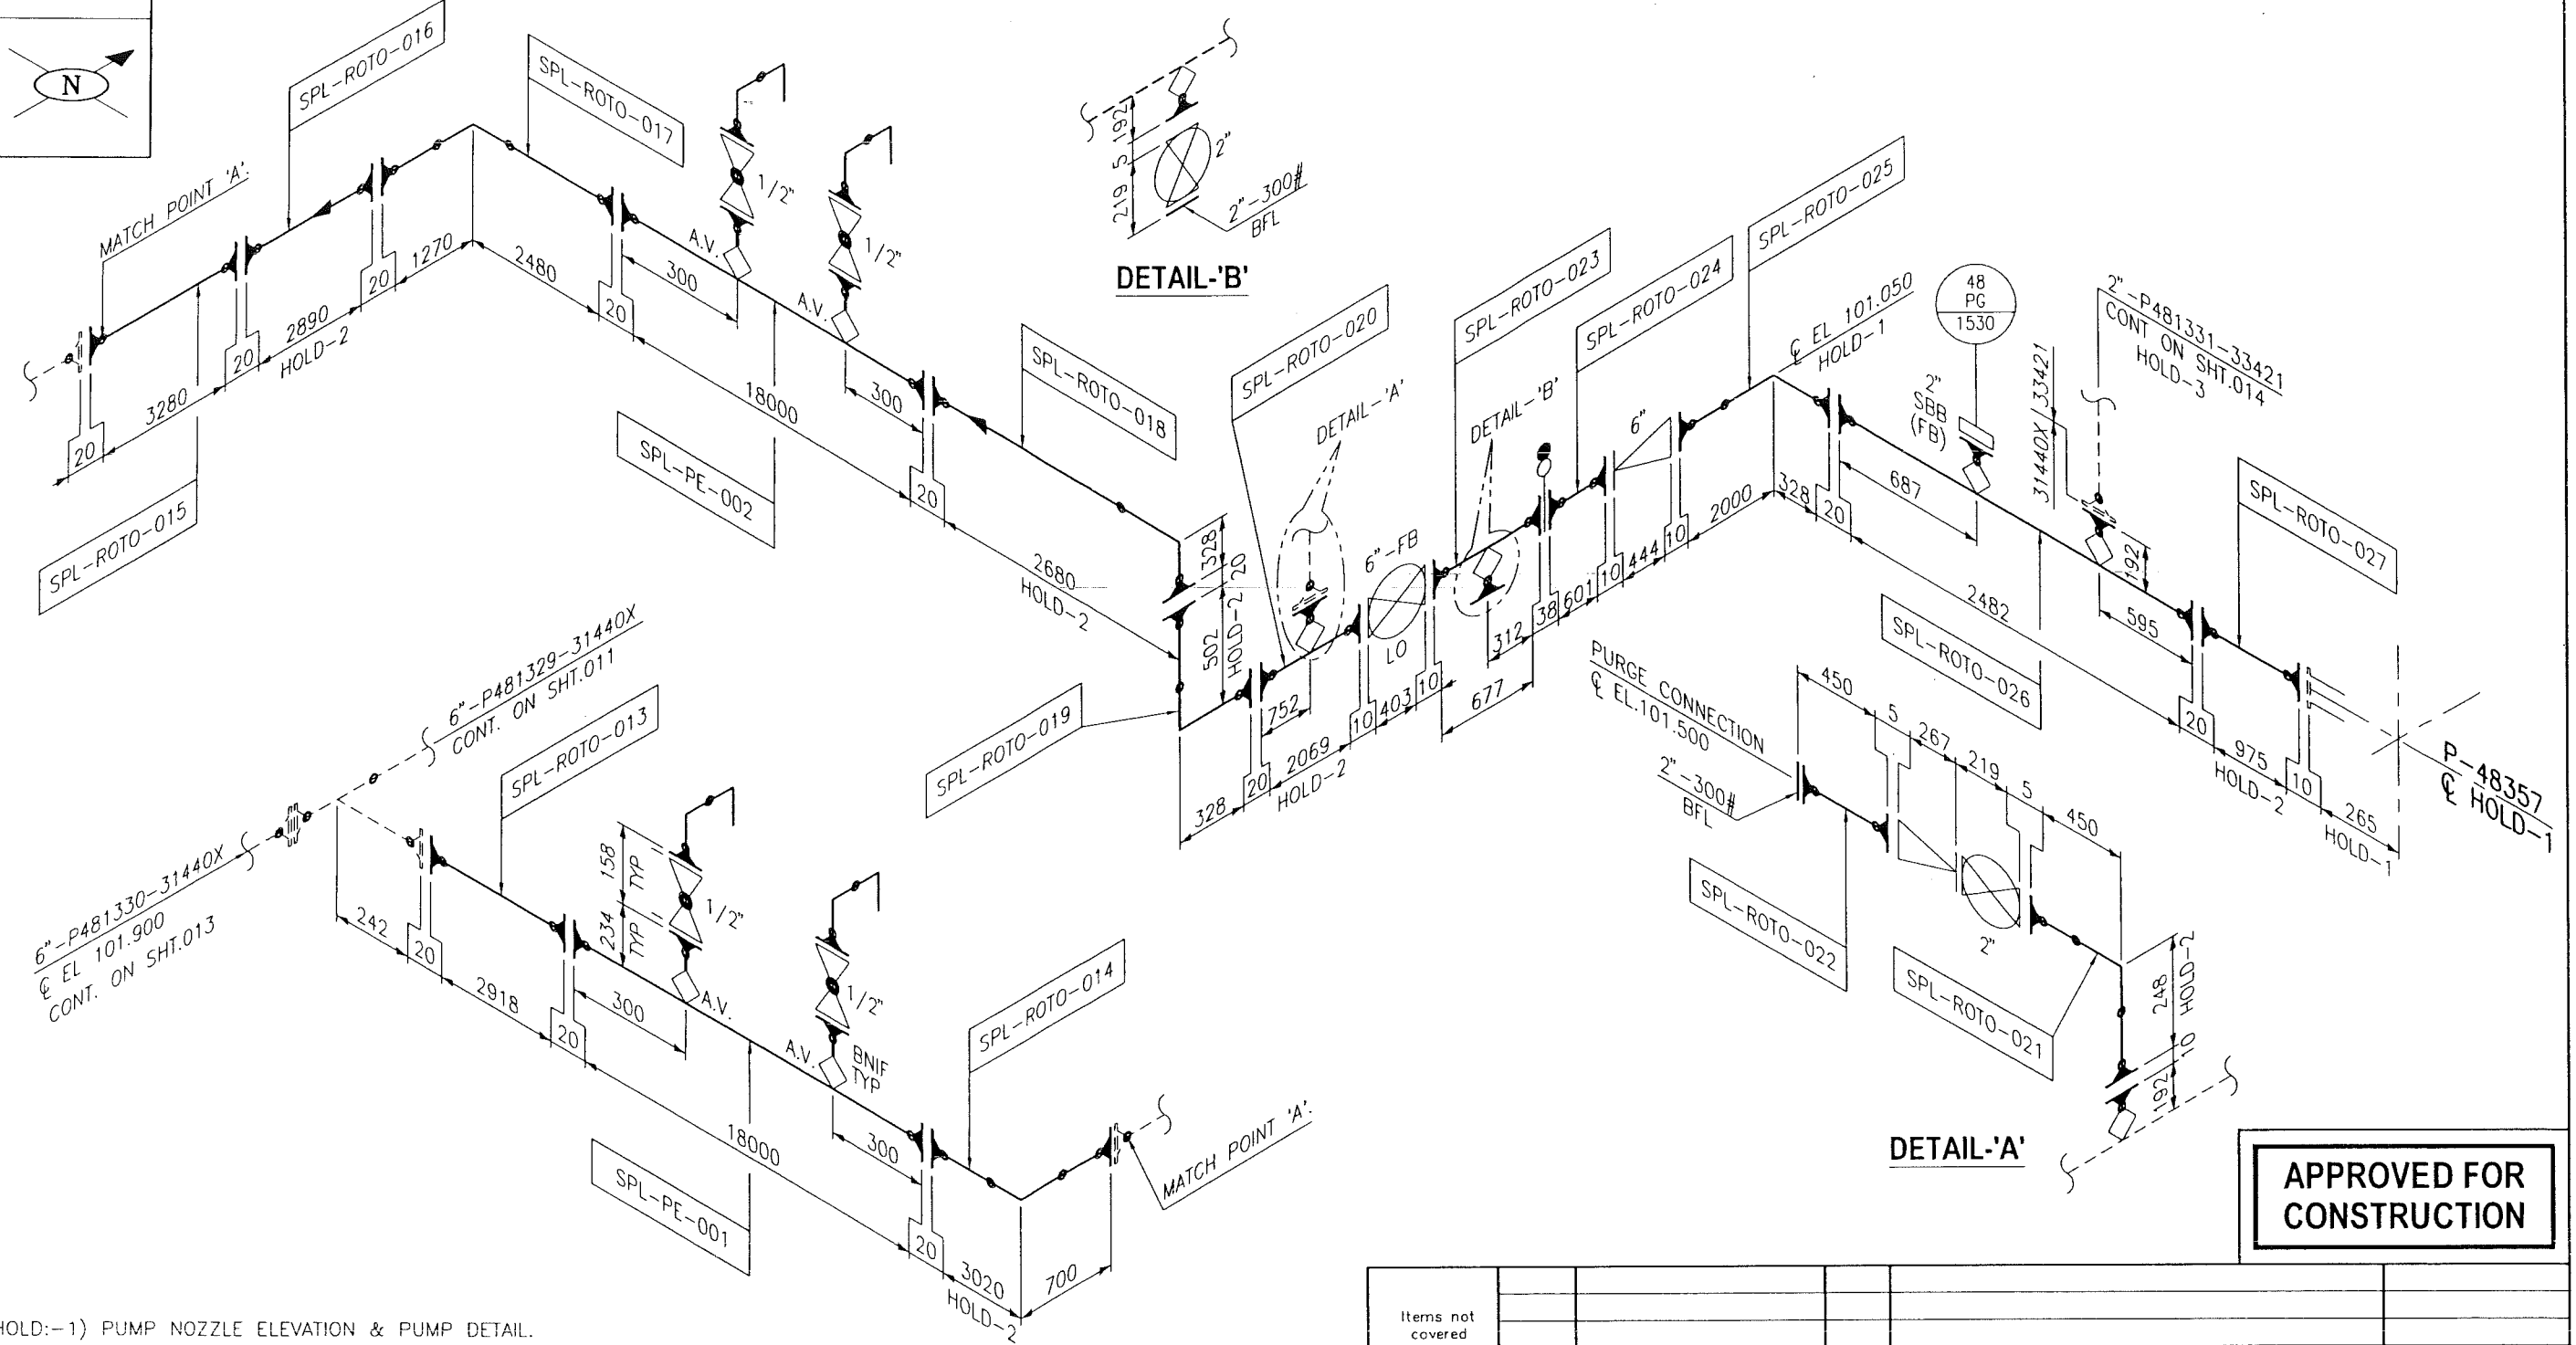

HOLD:-1) PUMP NOZZLE ELEVATION & PUMP DETAIL.
2) RETAINER RING/ROTO LINING THICKNESS.
3) LINE SIZE.

- 4) 31440X INDICATE PE/ROTO PIPING LINED AND SUPER DUPLEX VALVES
3) DIMENSION TO BE CHECKED & CONFIRMED AT SITE PRIOR TO FABRICATION.
2) FOR PE/ROTO LINING DETAILS REFER SHEET NO.008
1) FOR GENERAL NOTES REFER SHEET No. 009
- NOTES:

WorleyParsons-Arabian Industries (JV)

CONTRACT NO.: C31/0606 PROJ. NO.: PAIP00405

MTO DWG. No. :

DO NOT MAKE ANY MODIFICATION WITHOUT
CONFIRMATION FROM DESIGN DEPT.
AS THIS IS STRESS CRITICAL LINE.



STRESS RELIEVED NO
NDT REQUIREMENT RT10 % RANDOM
INSULATION NIL THK.
PAINTING PCS 1 OF SP1246

NIM 3 2144 512 DQ 4

MADE BY : MD	DATE : APR.'11	CHKD BY :	APPRD BY :	TITLE : PIPING ISOMETRIC NIMR SLUDGE PITS SYSTEM UPGRADE-FED AND DD
DESIGN PRESSURE 4782 kPag	DESIGN TEMP. 5 TO 82 °C	HYDRO TEST PRESS. 7173 kPag	W.B.S. No. IN.09.011	REV. 0
PIPING CLASS 31440X	LINE No. P481329	DATE APR.'11	SIGN.	DWG. NO NIM 3 2144 012 DQ 3 0

APPROVED FOR
CONSTRUCTION

PLANT NORTH

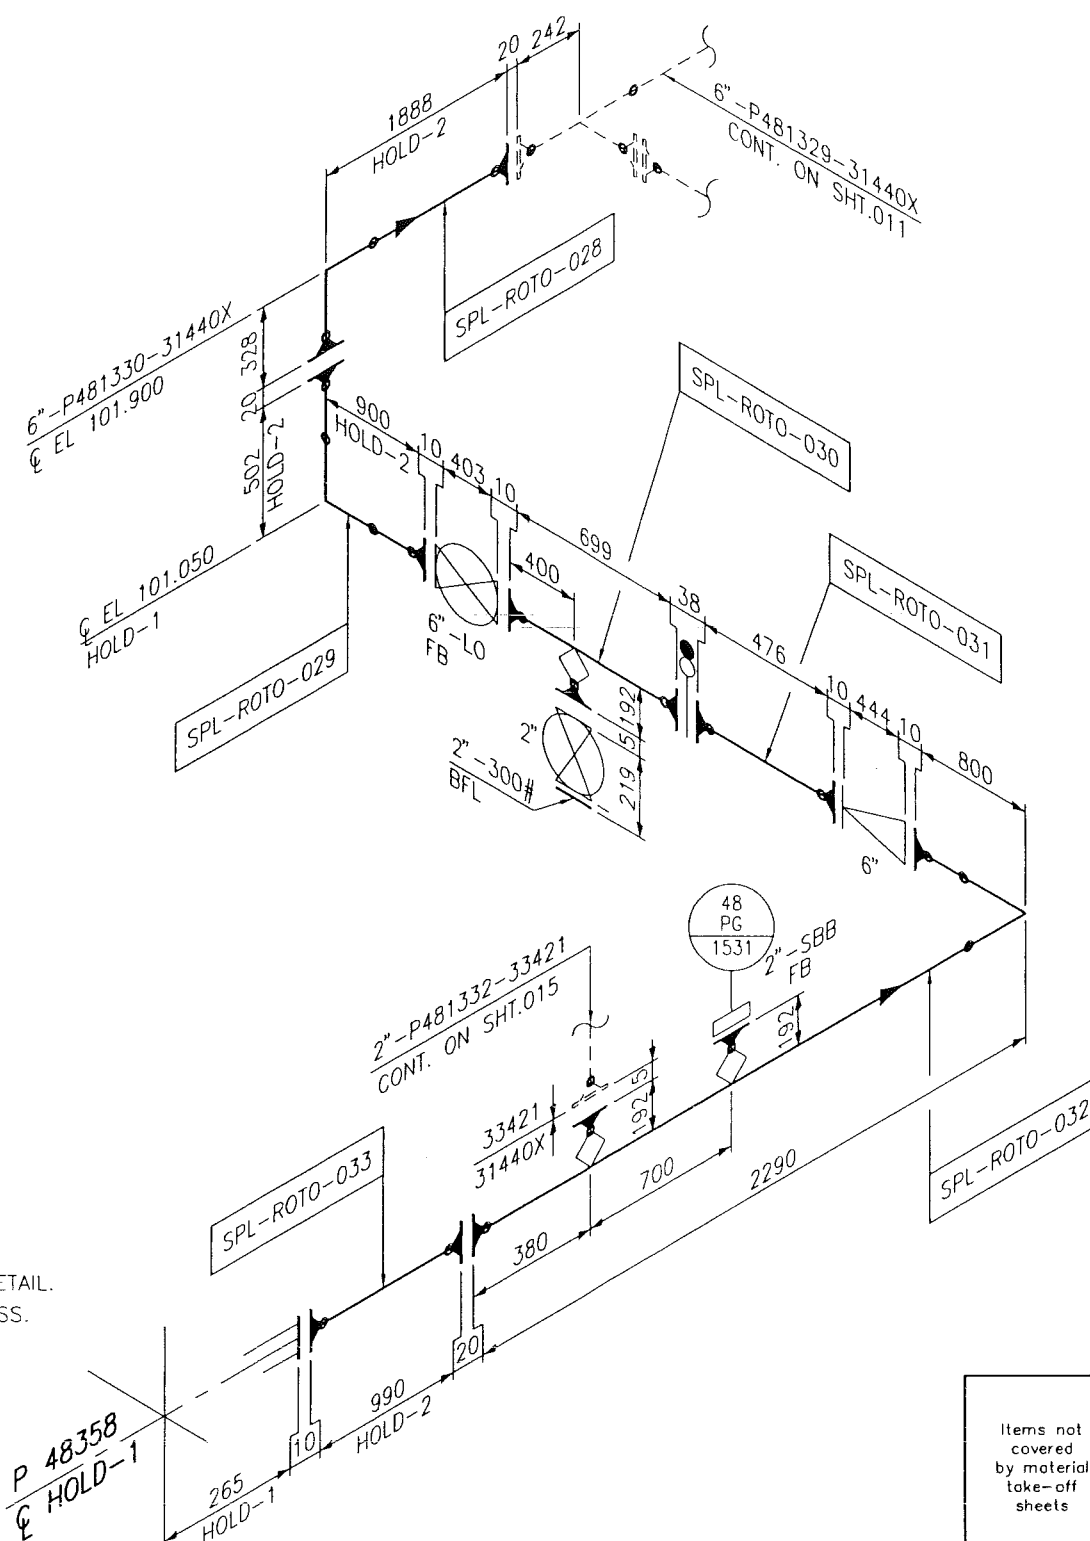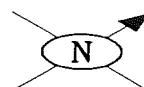

HOLD:-1) PUMP NOZZLE ELEVATION & PUMP DETAIL.
2) RETAINER RING/ROTO LINING THICKNESS.

**APPROVED FOR
CONSTRUCTION**

Items not covered by material take-off sheets	Quantity	Requisition No.	Item	Description	Tog No.
MADE BY : MD		DATE : APR.'11	CHKD BY :	APPRD BY :	TITLE : PIPING ISOMETRIC NIMR SLUDGE PITS SYSTEM UPGRADE-FED AND DD
STRESS RELIEVED NO		DESIGN PRESSURE 4782 kPag	PIPING CLASS 31440X		LINE No. P481330
NDT REQUIREMENT RT10 % RANDOM		DESIGN TEMP. 5 TO 82 °C	HYDRO TEST PRESS. 7173 kPag		
INSULATION NIL THK.		PAINTING PCS 1 OF SP1246	W.B.S. No. IN.09.011		
DO NOT MAKE ANY MODIFICATION WITHOUT CONFIRMATION FROM DESIGN DEPT. AS THIS IS STRESS CRITICAL LINE.		REV. 0			
PIPING ARRGT. DRWG. NIM-3-2140-001-DQ		DATE APR.'11		SIGN.	
NIM 3 2144 513 DQ 4		NO NIM 3 2144 013 DQ 3 0		DWG. AREA CODE ENG SECT SERIAL NUMBER SHEET PROJ CODE DWG SIZE REV	



- 4) 31440X INDICATE PE/ROTO PIPING LINED AND VALVES WITH BODY & TRIM OF 25%CR SDSS
3) DIMENSION TO BE CHECKED & CONFIRMED AT SITE PRIOR TO FABRICATION.
2) FOR PE/ROTO LINING DETAILS REFER SHEET NO.008
1) FOR GENERAL NOTES REFER SHEET No. 009
- NOTES:



ورلي بارسونز - الصناعات العربية (محصاة)
WorleyParsons-Arabian Industries (JV)

CONTRACT NO.: C31/0606 PROJ. NO.: PAIP00405


MTO DWG. No. :

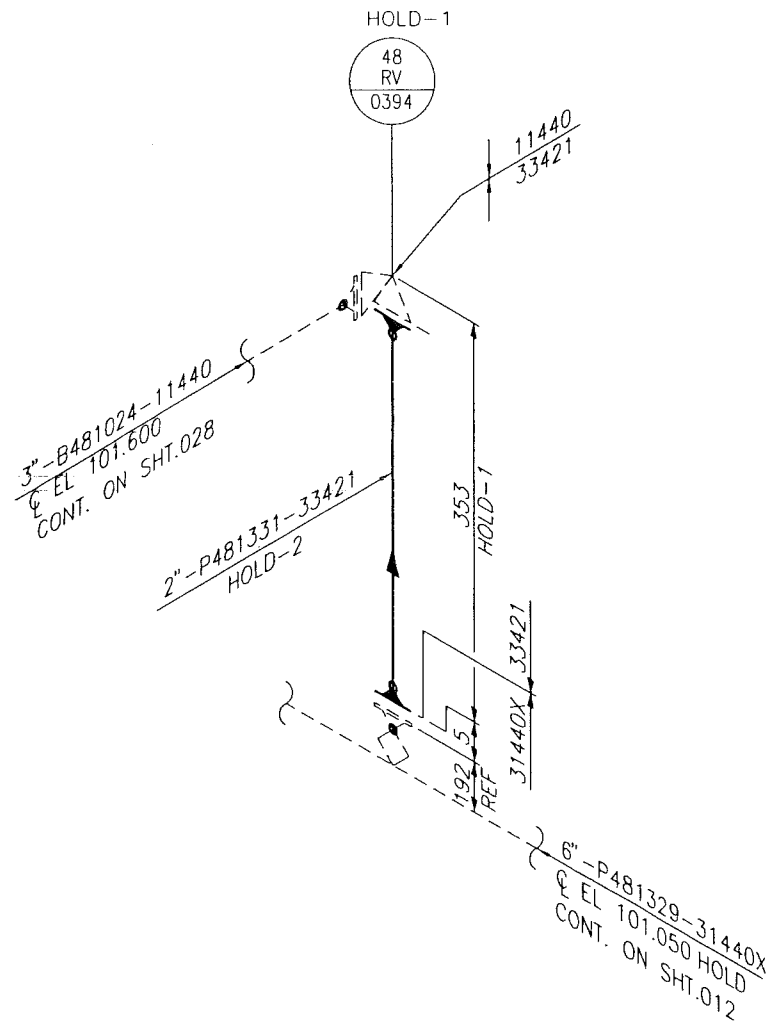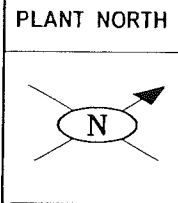

APPROVED FOR
CONSTRUCTION

HOLD:-1) 48 RV 0394 VLV SIZE.
2) LINE SIZE.

- 3) DIMENSION TO BE CHECKED & CONFIRMED AT SITE PRIOR TO FABRICATION.
2) FOR PE/ROTO LINING DETAILS REFER SHEET NO.008
1) FOR GENERAL NOTES REFER SHEET No. 009
NOTES:

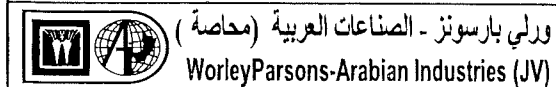

CONTRACT NO.: C31/0606 PROJ. NO.: PAIP00405



MTO DWG. No. :

DO NOT MAKE ANY MODIFICATION WITHOUT
CONFIRMATION FROM DESIGN DEPT.
AS THIS IS STRESS CRITICAL LINE

STRESS RELIEVED	NO
NDT REQUIREMENT	RT10 % RANDOM
INSULATION	NIL THK.
PAINTING	PCS 1 OF SP1246
NIM 3 2144 514 DQ 4	

Items not covered by material take-off sheets	Quantity	Requisition No.	Item	Description	Tag No.
MADE BY :	DATE :	CHKD BY :	APPRD BY :	TITLE :	
MD	APR.'11			PIPING ISOMETRIC NIMR SLUDGE PITS SYSTEM UPGRADE-FED AND DD	
DESIGN PRESSURE	4429	kPag	PIPING CLASS	LINE No.	
DESIGN TEMP.	5 TO 82	°C	33421	P481331	
HYDRO TEST PRESS.	6643	kPag			
W.B.S. No.	IN.09.011	REV.	0	DWG.	AREA CODE
PIPING ARRGT. DRWG.	DATE	APR.'11		NO	NIM 3 2144 014 DQ 3 0
MIN-3-2142-001-DQ	SIGN.				

PLANT NORTH

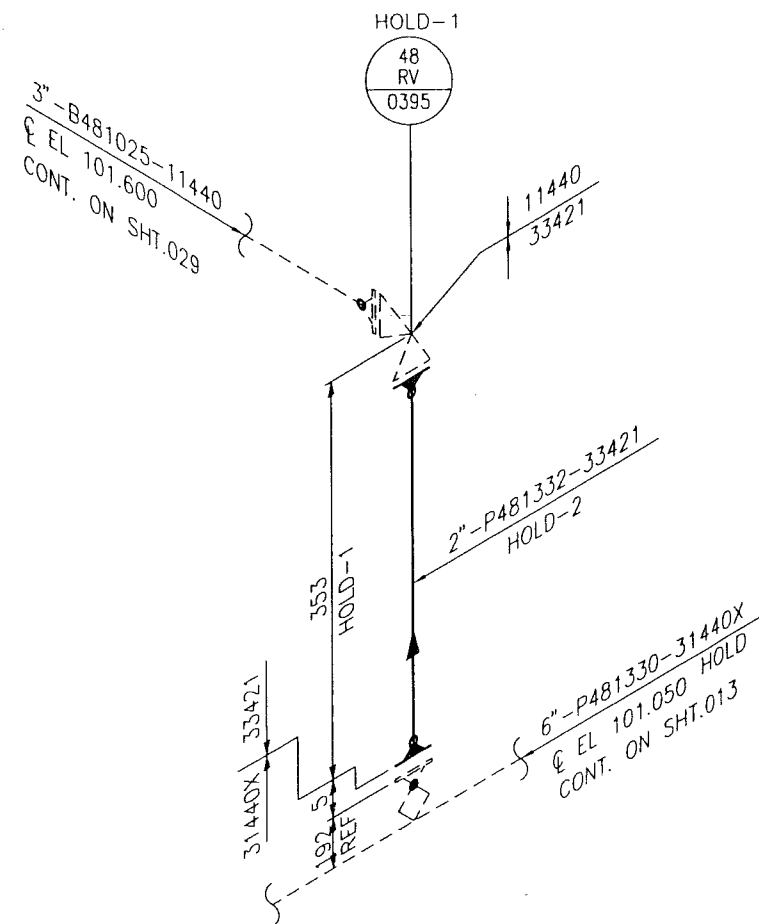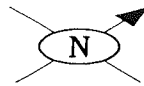APPROVED FOR
CONSTRUCTION

HOLD:-1) 48 RV 0395 VLV SIZE.

2) LINE SIZE.

3) DIMENSION TO BE CHECKED & CONFIRMED AT SITE PRIOR TO FABRICATION.

2) FOR PE/ROTO LINING DETAILS REFER SHEET NO.008.

1) FOR GENERAL NOTES REFER SHEET No. 009

NOTES:

ورلي بارسونز - الصناعات العربية (محصاة)
WorleyParsons-Arabian Industries (JV)

CONTRACT NO.: C31/0606

PROJ. NO.: PAIP00405

MTO DWG. No. :

DO NOT MAKE ANY MODIFICATION WITHOUT
CONFIRMATION FROM DESIGN DEPT.
AS THIS IS STRESS CRITICAL LINE

STRESS RELIEVED	NO
NDT REQUIREMENT	RT10 % RANDOM
INSULATION	NIL THK.
PAINTING	PCS 1 OF SP1246

NIM 3 2144 515 DQ 4

MADE BY :	DATE :	CHKD BY :	APPRD BY :
MD	APR.'11		

DESIGN PRESSURE	4429	kPag
DESIGN TEMP.	5 TO 82	°C
HYDRO TEST PRESS.	6643	kPag
W.B.S. No.	IN.09.011	

PIPING ARRGT. DRWG.
MIN-3-2140-001-DQTITLE : PIPING ISOMETRIC
NIMR SLUDGE PITS SYSTEM UPGRADE-FED AND DD

PIPING CLASS	LINE No.
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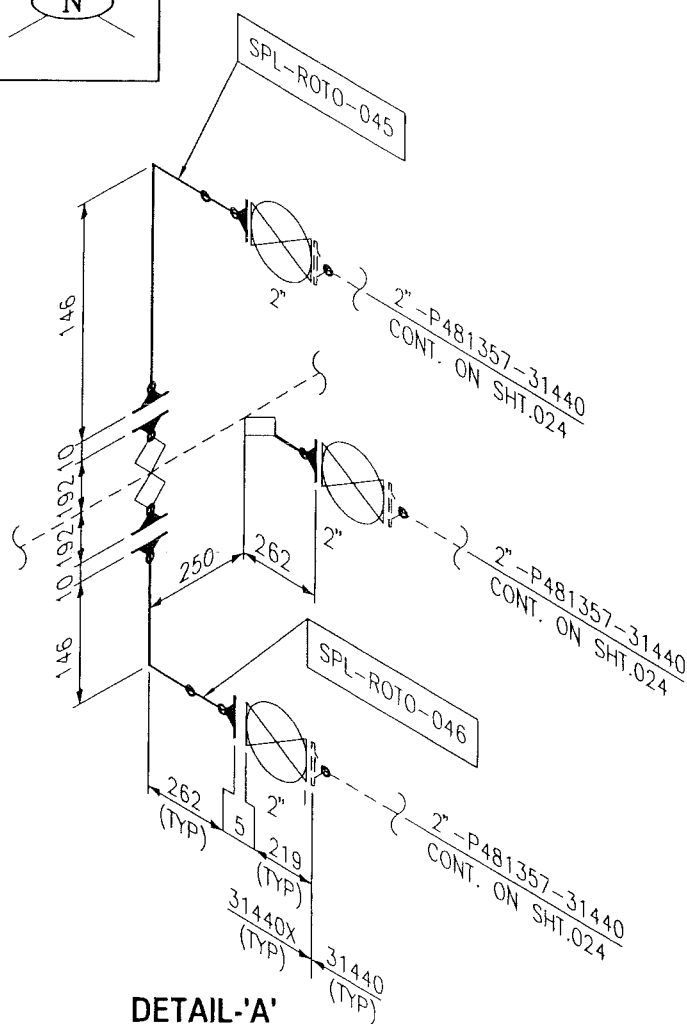
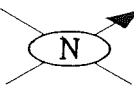
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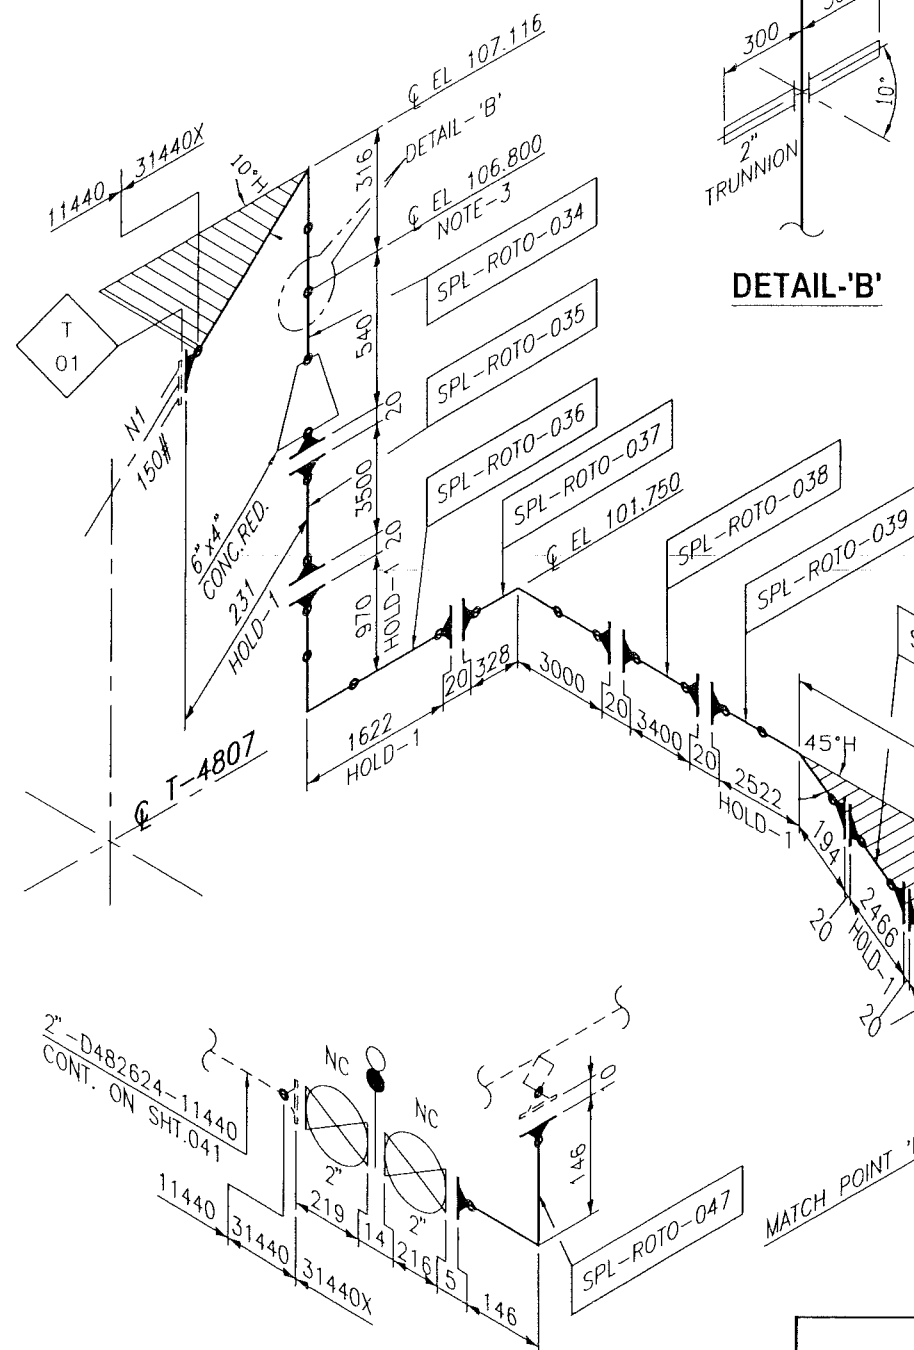
شركة تنمية نفط عُمان
Petroleum Development Oman

DWG.	AREA CODE	ENG SECT	SERIAL NUMBER	SHEET	PROJ CODE	DWG SIZE	REV
NIM	3	2144	015	DQ	3	0	


PLANT NORTH




DETAIL 'A'



DETAIL 'B'

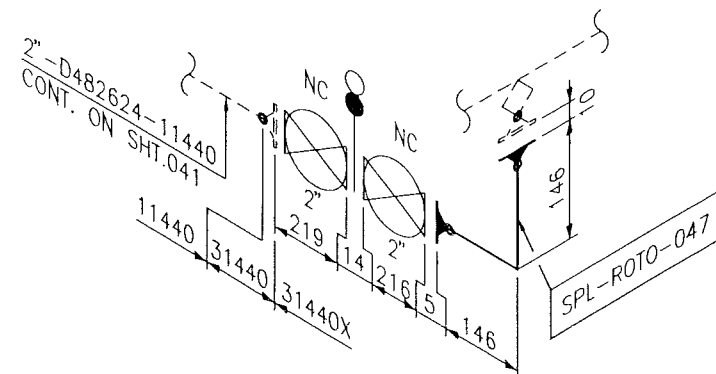

DETAIL 'C'

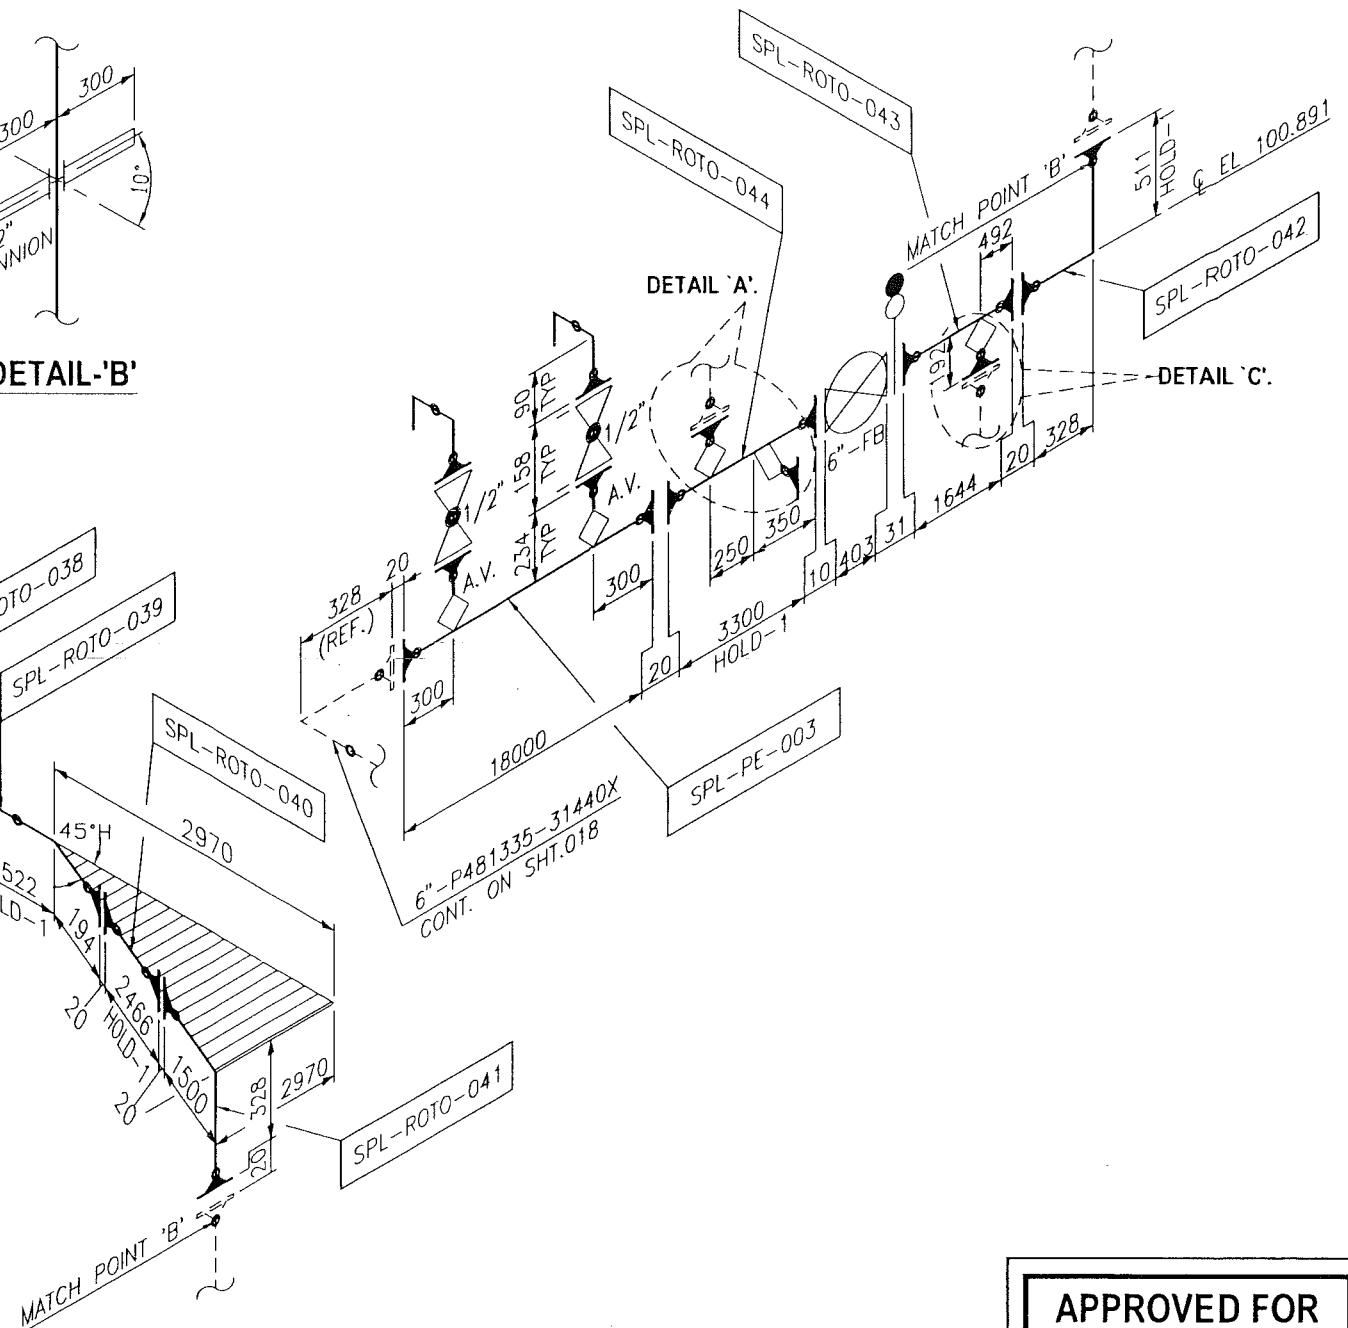

APPROVED FOR
CONSTRUCTION

HOLD:-1) RETAINER RING/ROTO LINING THICKNESS.

- 4) 31440X INDICATE PE/ROTO PIPING LINED AND SUPER DUPLEX VALVES.
3) DIMENSION TO BE CHECKED & CONFIRMED AT SITE PRIOR TO FABRICATION.
2) FOR PE LINING DETAILS REFER SHEET NO.008
1) FOR GENERAL NOTES REFER SHEET No. 009



ورلي بارسونز - الصناعات العربية (محصاة)
WorleyParsons-Arabian Industries (JV)

CONTRACT NO.: C31/0606 PROJ. NO.: PAIP00405

MTD DWG. No. :

DO NOT MAKE ANY MODIFICATION WITHOUT
CONFIRMATION FROM DESIGN DEPT.
AS THIS IS STRESS CRITICAL LINE.



STRESS RELIEVED	NO
NDT REQUIREMENT	RT10 % RANDOM
INSULATION	NIL THK.
PAINTING	PCS 1 OF SP1246
W.B.S. No.	IN.09.011
PIPING ARRGT. DRWG.	NIM-3-5085-001-DQ NIM-3-5391-001-DQ

MADE BY :	DATE :	CHKD BY :	APPRD BY :	TITLE :
MD	APR.'11			PIPING ISOMETRIC NIMR SLUDGE PITS SYSTEM UPGRADE-FED AND DD
DESIGN PRESSURE	4782	kPag	PIPING CLASS	LINE No.
DESIGN TEMP.	5 TO 82	°C	31440X	P481335
HYDRO TEST PRESS.	7173	kPag		
REV.	0			
DATE	APR.'11			
SIGN.				
DWG.	AREA CODE	ENG SECT	SERIAL NUMBER	SHEET
NO	NIM	3	2144	017 DQ
				3
				0



شركة تنمية نفط عُمان
Petroleum Development Oman

PLANT NORTH

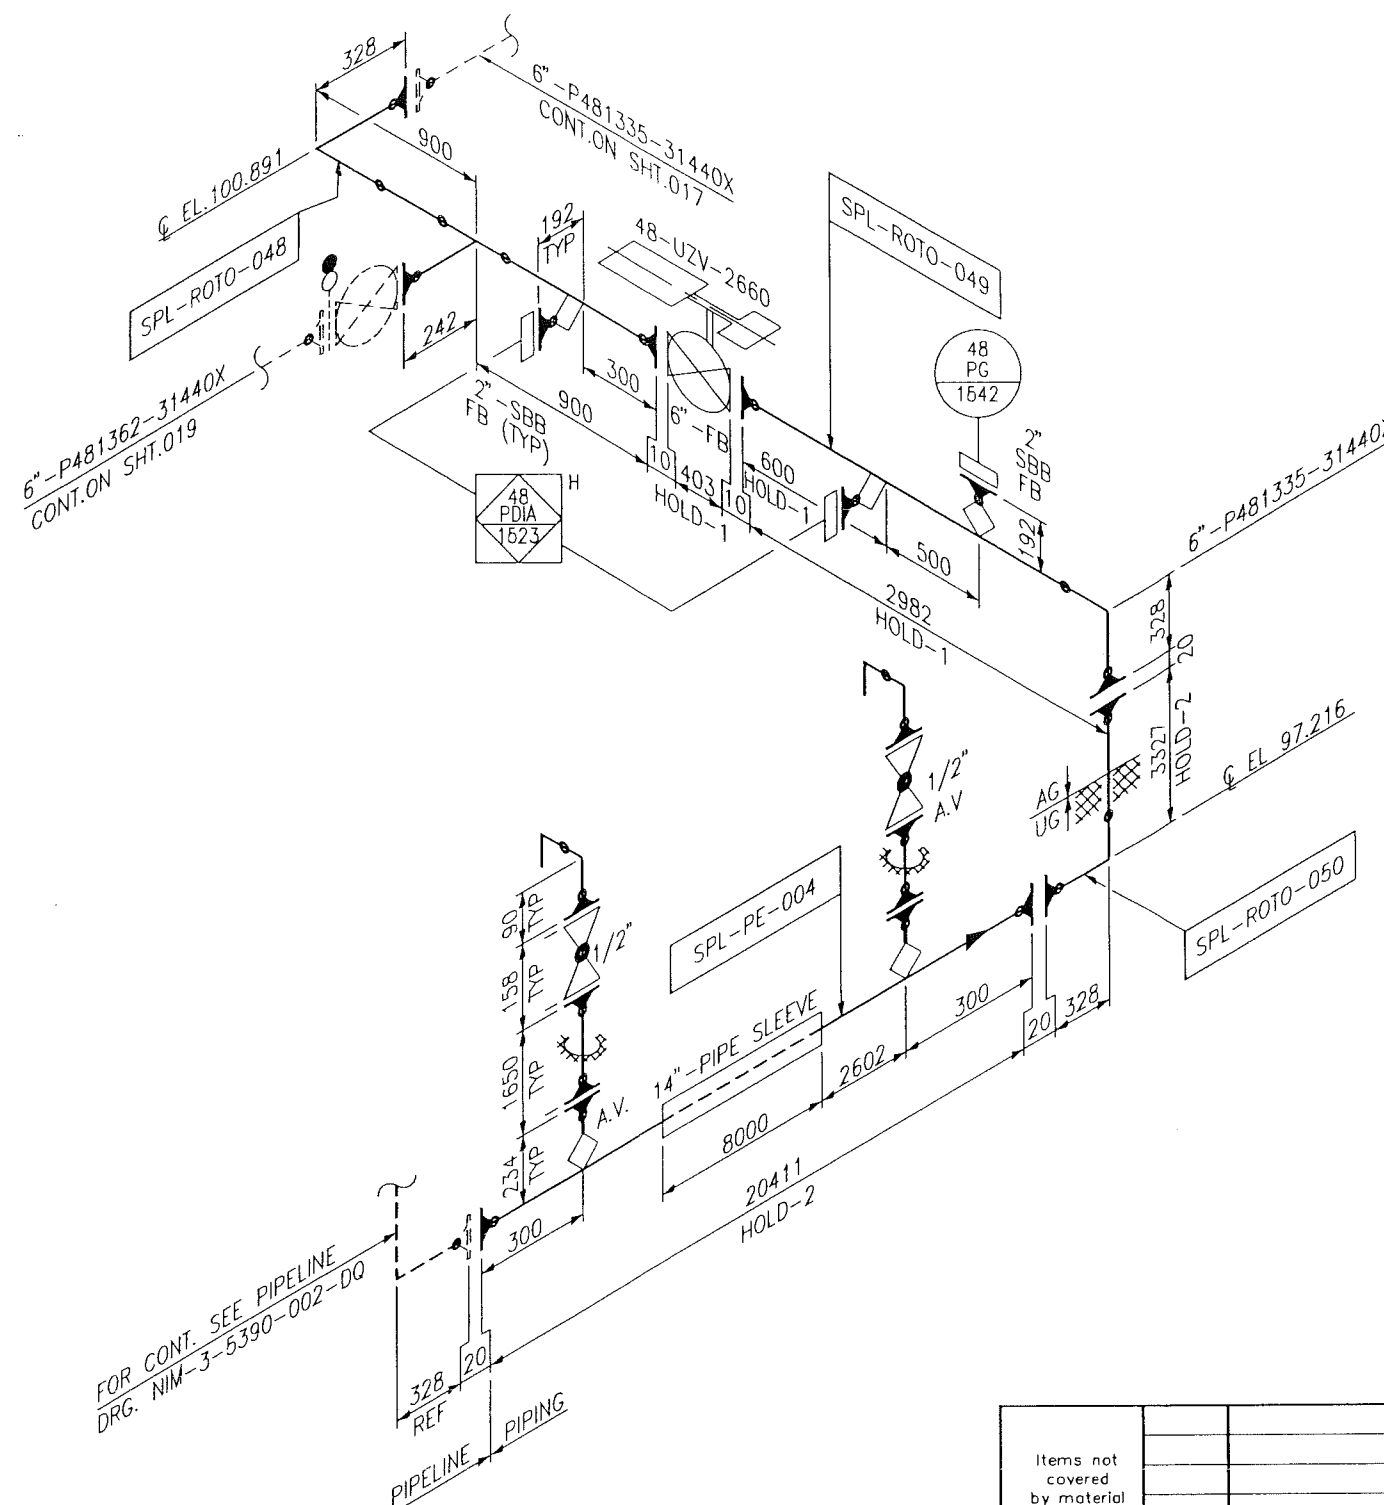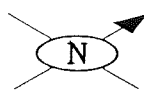

HOLD:-1) UZV-2660.VLV DIM
2) RETAINER RING/ROTO LINING THICKNESS.

- 4) 31440X INDICATE PE/ROTO PIPING LINED AND SUPER SUPLEX VALVES.
3) DIMENSION TO BE CHECKED & CONFIRMED AT SITE PRIOR TO FABRICATION.
2) FOR PE LINING DETAILS REFER SHEET NO.008
1) FOR GENERAL NOTES REFER SHEET No. 009
NOTES:



ورلي بارسونز - الصناعات العربية (محصاة)
WorleyParsons-Arabian Industries (JV)

CONTRACT NO. : C31/0606 PROJ. NO. : PAIP00405

MTO DWG. No. :

**DO NOT MAKE ANY MODIFICATION WITHOUT
CONFIRMATION FROM DESIGN DEPT.
AS THIS IS STRESS CRITICAL LINE**

STRESS RELIEVED NO
NOT REQUIREMENT RT10 % RANDOM
INSULATION NIL THK.

PAINTING PCS 1,2 OF SP1246

NIM 3 2144 518 DQ 4

MADE BY : MD	DATE : APR.'11	CHKD BY :	APPRD BY :	TITLE : PIPING ISOMETRIC NIMR SLUDGE PITS SYSTEM UPGRADE-FED AND DD
DESIGN PRESSURE 4782 kPag	DESIGN TEMP. 5 TO 82 °C	HYDRO TEST PRESS. 7173 kPag	W.B.S. No. IN.09.011	PIPING CLASS 31440X
LINE No. P481335	REV. 0	DATE APR.'11	SIGN.	NO NIM 3 2144 018 DQ 3 0



**APPROVED FOR
CONSTRUCTION**



شركة تنمية نفط عُمان
Petroleum Development Oman

DWG.	AREA CODE	ENG SECT	SERIAL NUMBER	SHEET	PROJ CODE	DWG SIZE	REV
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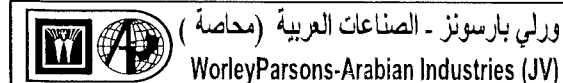
PLANT NORTH

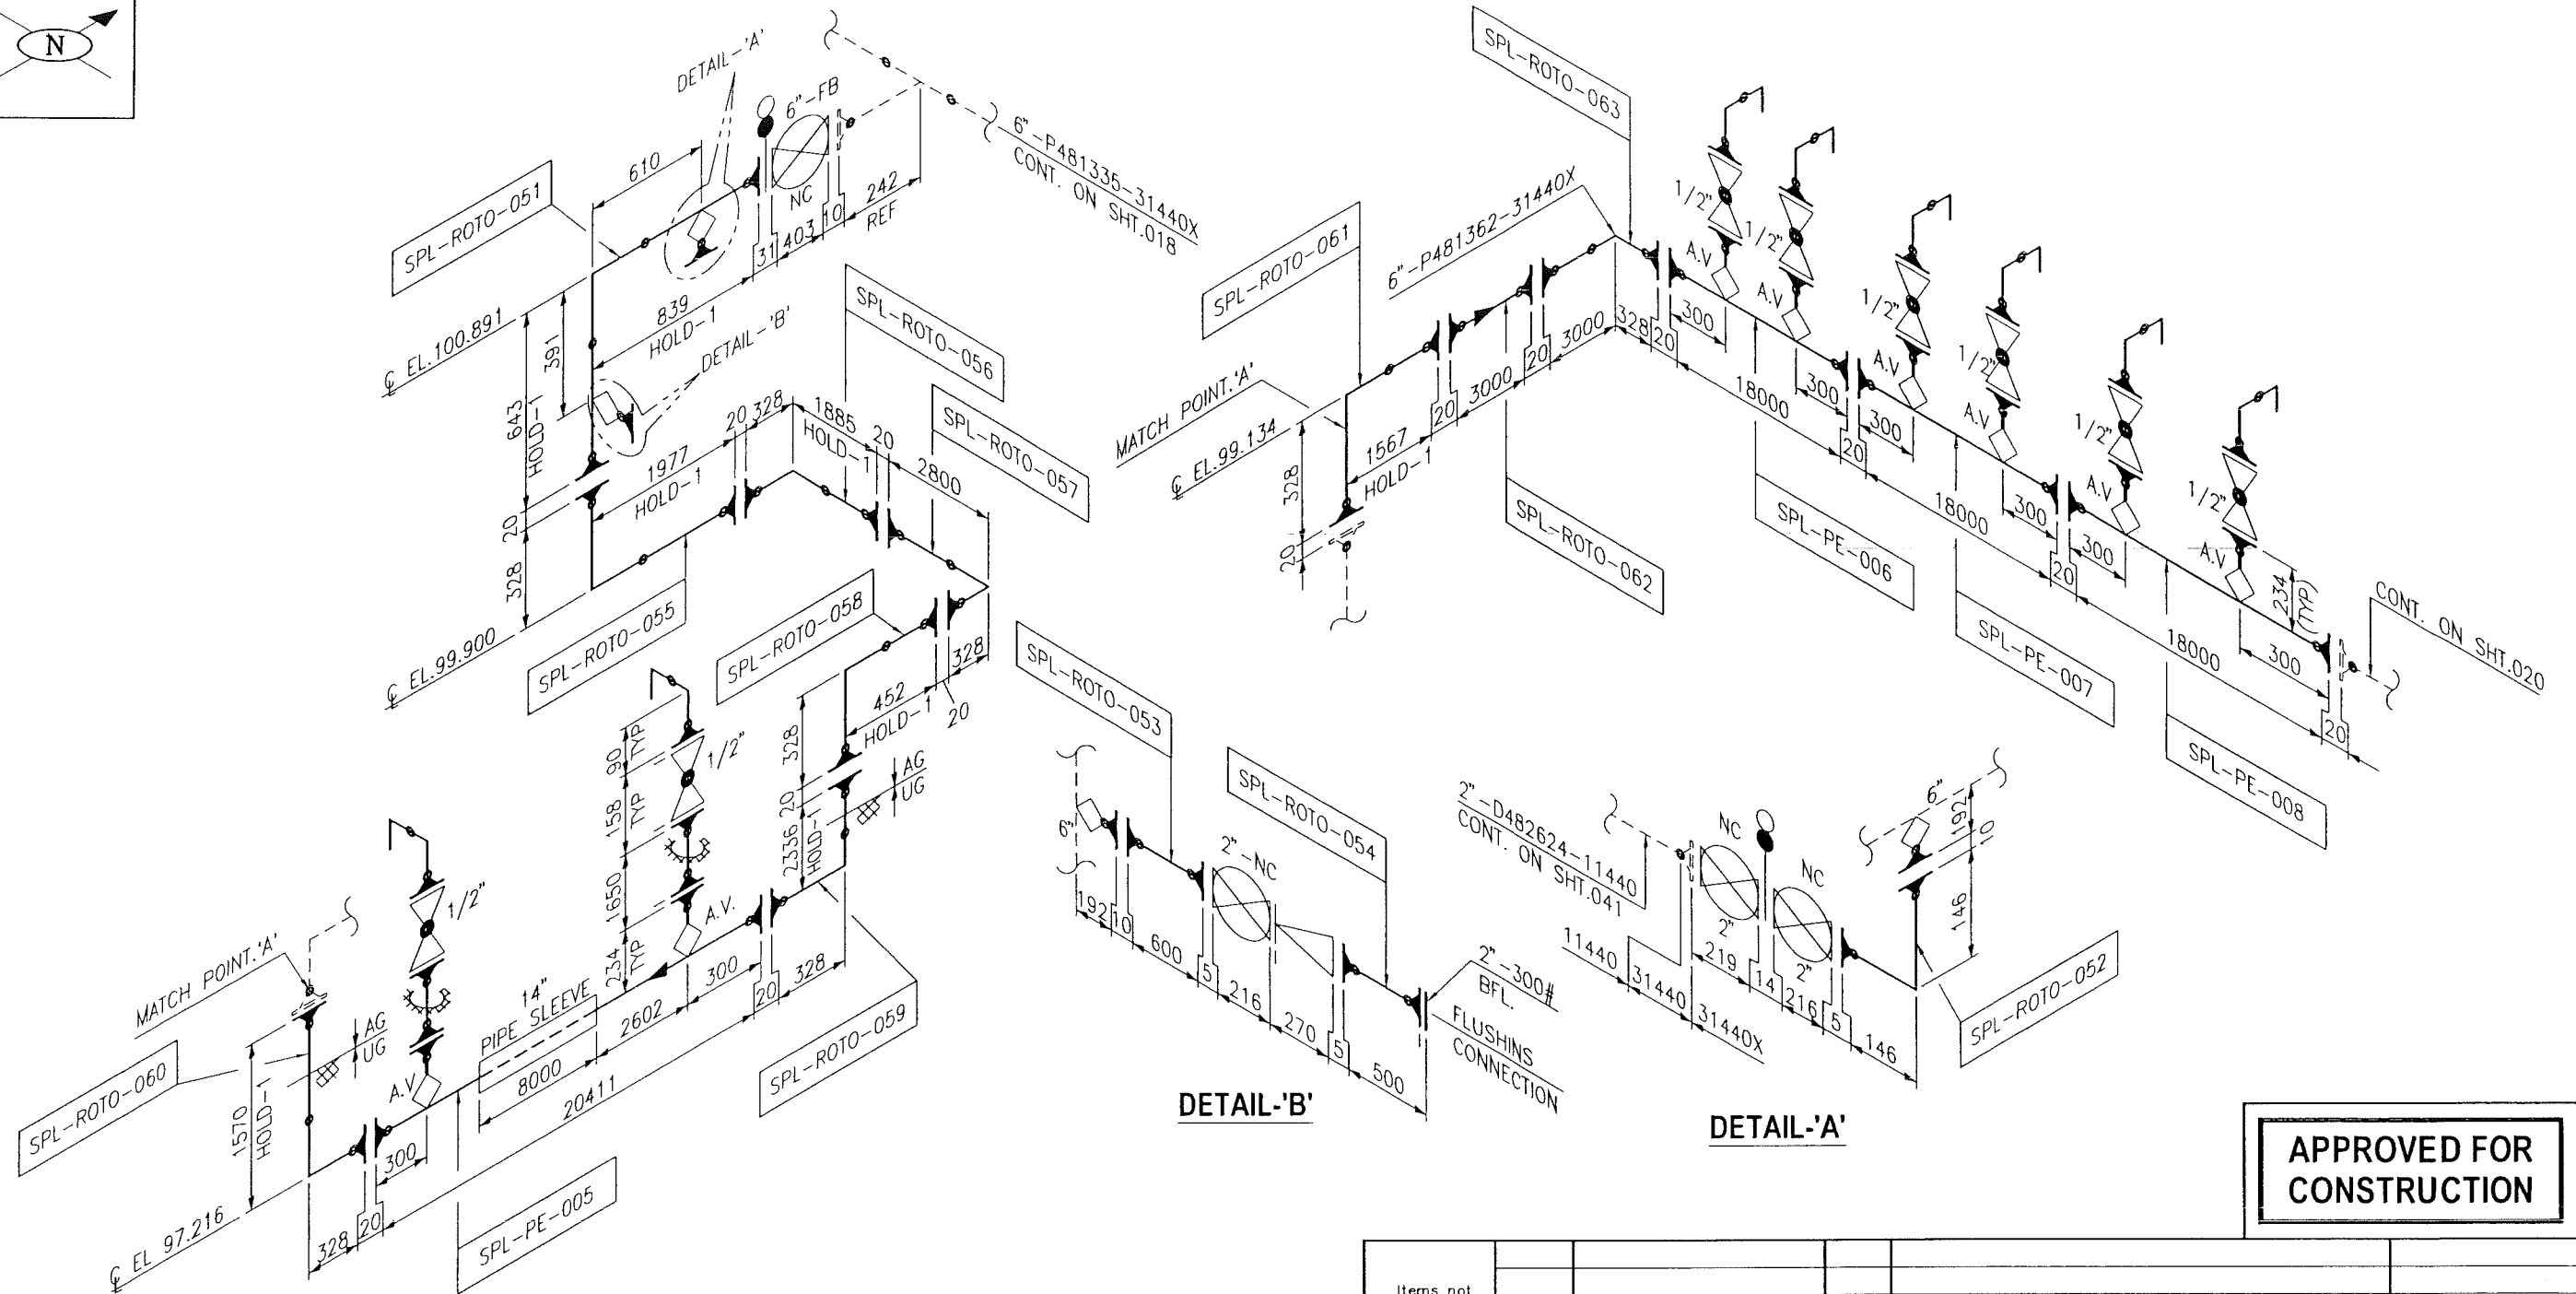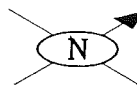

**APPROVED FOR
CONSTRUCTION**

HOLD:-1) RETAINER RING/ROTO LINING THICKNESS.

- 4) 31440X INDICATE PE/ROTO PIPING LINED. VALVES WITH BODY & TRIM OF 25% Cr SDSS
- 3) DIMENSION TO BE CHECKED & CONFIRMED AT SITE PRIOR TO FABRICATION.
- 2) FOR PE/ROTO LINING DETAILS REFER SHEET NO.008
- 1) FOR GENERAL NOTES REFER SHEET No. 009
- NOTES:




CONTRACT NO.: C31/0606 PROJ. NO.: PAIP00405

MTO DWG. No. :

**DO NOT MAKE ANY MODIFICATION WITHOUT
CONFIRMATION FROM DESIGN DEPT.
AS THIS IS STRESS CRITICAL LINE.**

STRESS RELIEVED	NO
NDT REQUIREMENT	RT10 % RANDOM
INSULATION	NIL THK.
PAINTING	PCS 1,2 OF SP1246
NIM 3 2144 519 DQ 4	

Items not covered by material take-off sheets	Quantity	Requisition No.	Item	Description	Tag No.
MADE BY :	DATE :	CHKD BY :	APPRD BY :	TITLE :	
MD	APR.'11			PIPING ISOMETRIC NIMR SLUDGE PITS SYSTEM UPGRADE--FED AND DD	
DESIGN PRESSURE	4782	kPag	PIPING CLASS	LINE No.	
DESIGN TEMP.	5 TO 82	°C	31440X	P481362	
HYDRO TEST PRESS.	7173	kPag			
W.B.S. No.	IN.09.011		REV.	0	
PIPING ARRGT. DRWG.					
NIM-3-6114/6115-001-DQ					
NIM-3-5391-001-DQ					
NIM-3-5390-002-DQ					
DATE	APR.'11				
SIGN.					
DWG.	AREA CODE	ENG SECT	SERIAL NUMBER	SHEET	PROJ CODE
NO					
NIM 3 2144 019 DQ 3 0					

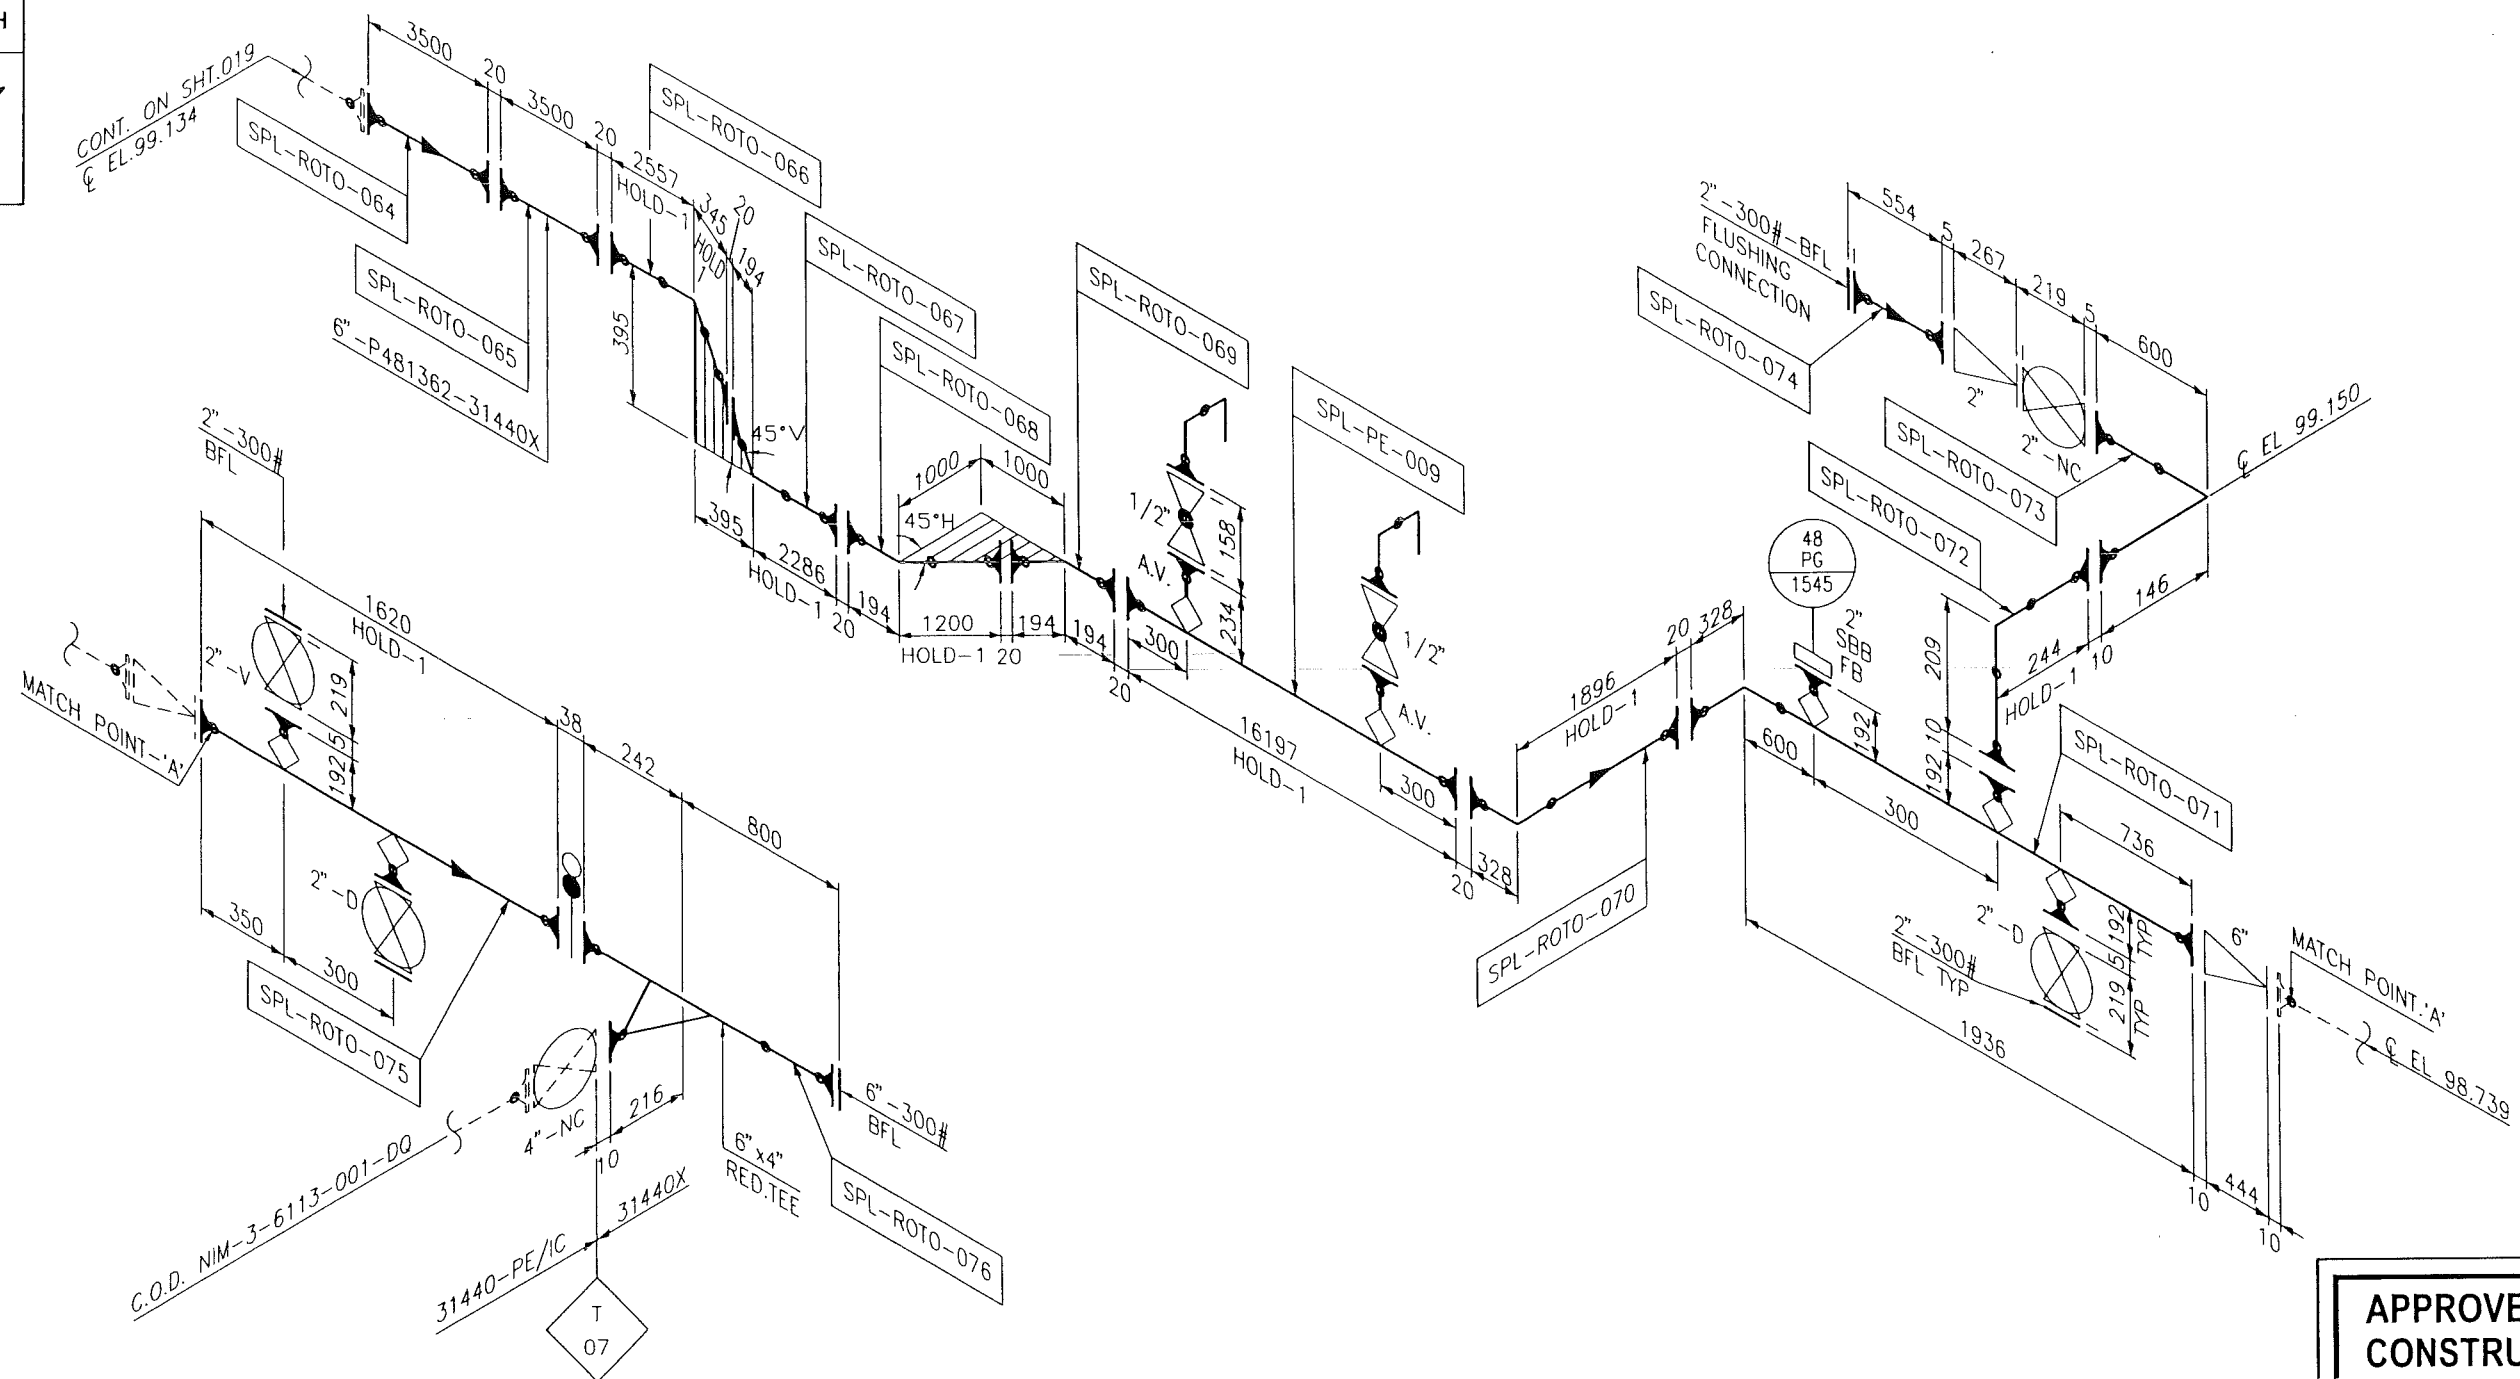

**APPROVED FOR
CONSTRUCTION**

4) 31440X INDICATE PE/ROTO PIPING LINED. VALVES
WITH BODY & TRIM OF 25% Cr SDSS

~~3) DIMENSION TO BE CHECKED & CONFIRMED AT SITE PRIOR TO FABRICATION.~~

2) FOR PE/ROTO LINING DETAILS REFER SHEET NO.008

1) FOR GENERAL NOTES REFER SHEET No. 009

NOTES:



CONTRACT NO.: C31/0606	PROJ. NO.: PAIP00405
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MTO DWG. No. :

~~DO NOT MAKE ANY MODIFICATION WITHOUT
CONFIRMATION FROM DESIGN DEPT.
AS THIS IS STRESS CRITICAL LINE~~

STRESS RELIEVED	NO		
NDT REQUIREMENT	RT10	%	RANDOM
INSULATION	NIL	THK.	
PAINTING	PCS 1 OF SP1246		

NIM 3 2144 520 DQ 4

MADE BY :	DATE :	CHKD BY :	APPRD BY :	TITLE :
MD	APR.'11			


DESIGN PRESSURE	4782	kPag
DESIGN TEMP.	5 TO 82	°C
HYDRO TEST PRESS.	7173	kPag
W.B.S. No.	IN.09.011	


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NIM-3-6113-001-DQ	
NIM-3-6114-001-DQ	

TITLE : PIPING ISOMETRIC
NIMR SLUDGE PITS SYSTEM UPGRADE-FED AND DD

PIPING CLASS	LINE No.
31440X	P481362

REV.	0					



DATE	APR.'11
SIGN.	



شركة تنمية نفط عُمان
Petroleum Development Oman

DWG.	AREA CODE	ENG SECT	SERIAL NUMBER	SHEET	PROJ CODE	DWG SIZE	REV
NO	NIM	3	2144	020	DQ	3	0

PLANT NORTH

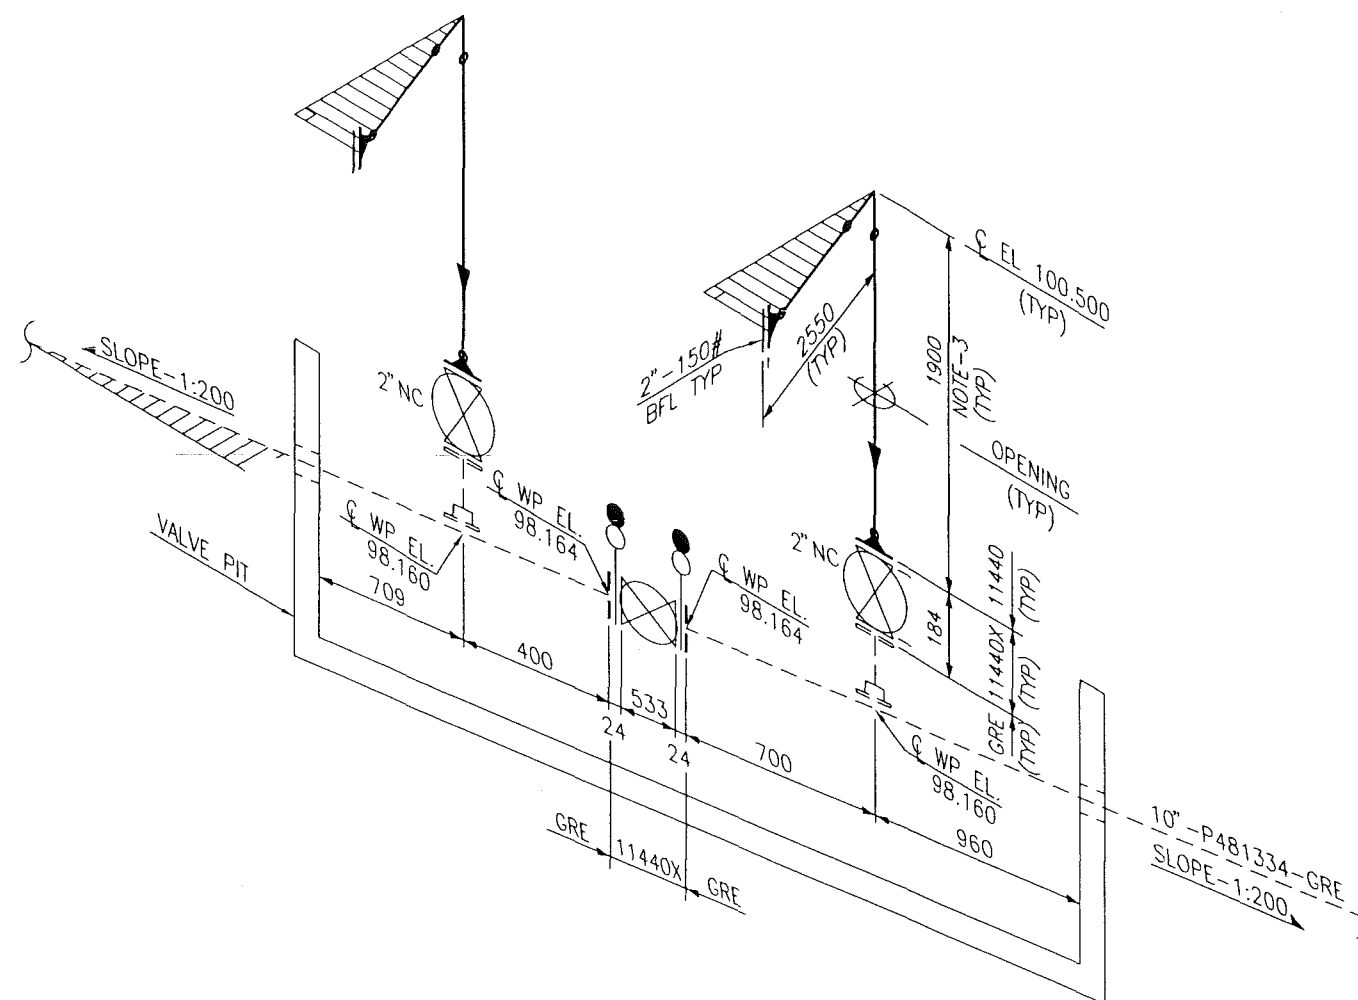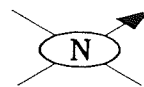

**APPROVED FOR
CONSTRUCTION**

Quantity	Requisition No.	Item	Description	Tag No.

- 3) DIMENSION TO BE CHECKED & CONFIRMED AT SITE PRIOR TO FABRICATION.
 2) FOR PE LINING DETAILS REFER SHEET NO.008-
 1) FOR GENERAL NOTES REFER SHEET No. 009

NOTES:
 ورلي بارسونز - الصناعات العربية (محاصة)
 WorleyParsons-Arabian Industries (JV)

CONTRACT NO.: C31/0606 PROJ. NO.: PAIP00405

MTO DWG. No. :

**DO NOT MAKE ANY MODIFICATION WITHOUT
CONFIRMATION FROM DESIGN DEPT.
AS THIS IS STRESS CRITICAL LINE**



STRESS RELIEVED	NO
NDT REQUIREMENT	RT10 % RANDOM
INSULATION	N/A THK.
PAINTING	PCS 1 OF SP1246

MADE BY : MIS	DATE : APR.'11	CHKD BY :	APPRD BY :	TITLE : PIPING ISOMETRIC NIMR SLUDGE PITS SYSTEM UPGRADE-FED AND DD
DESIGN PRESSURE	1820	kPag	PIPING CLASS	LINE No.
DESIGN TEMP.	5 TO 82	°C	11440	P481334
HYDRO TEST PRESS.	2730	kPag	11440X	
W.B.S. No.	NIM.IN.09.011	REV.	0	
PIPING ARRGT. DRWG.	NIM-3-2141-001-DQ	DATE	APR.'11	
		SIGN.		

شركة تنمية نفط عُمان
 Petroleum Development Oman

DWG.	AREA CODE	ENG SECT	SERIAL NUMBER	SHEET	PROJ CODE	DWG SIZE	REV
NO	NIM	3	2144	023	DQ	3	0

PLANT NORTH

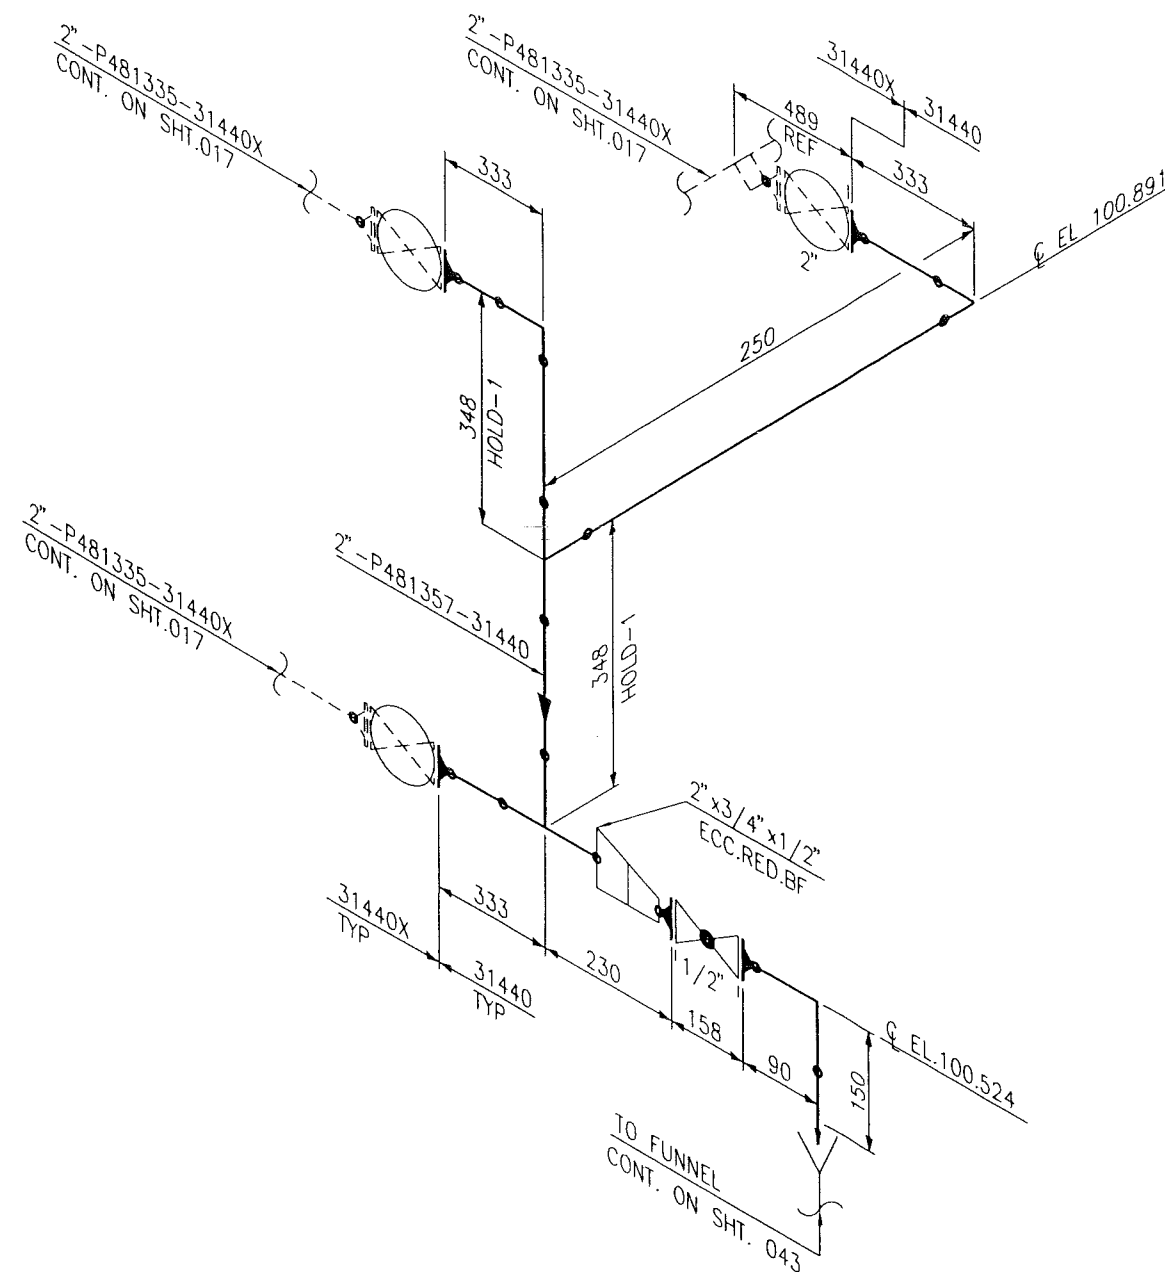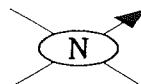

**APPROVED FOR
CONSTRUCTION**

HOLD-1) ROTO LINING THICKNESS.

Items not covered by material take-off sheets	Quantity	Requisition No.	Item	Description	Tag No.																		
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MADE BY :	DATE :	CHKD BY :	APPRD BY :	TITLE :																			
MD	APR.'11			PIPING ISOMETRIC NIMR SLUDGE PITS SYSTEM UPGRADE-FED AND DD																			
STRESS RELIEVED NO NDT REQUIREMENT RT10 % RANDOM INSULATION NIL THK. PAINTING PCS 1 OF SP1246		DESIGN PRESSURE 4782 kPag DESIGN TEMP. 5 TO 82 °C HYDRO TEST PRESS. 7173 kPag W.B.S. No. IN.09.011		PIPING CLASS 31440 LINE No. P481357																			
DO NOT MAKE ANY MODIFICATION WITHOUT CONFIRMATION FROM DESIGN DEPT. AS THIS IS STRESS CRITICAL LINE		PIPING ARRGT. DRWG. MIN-3-5085-001-DQ		<table border="1"> <tr> <td>REV.</td> <td>0</td> <td> </td> <td> </td> <td> </td> <td> </td> </tr> <tr> <td>DATE</td> <td>APR.'11</td> <td> </td> <td> </td> <td> </td> <td> </td> </tr> <tr> <td>SIGN.</td> <td></td> <td> </td> <td> </td> <td> </td> <td> </td> </tr> </table>		REV.	0					DATE	APR.'11					SIGN.					
REV.	0																						
DATE	APR.'11																						
SIGN.																							

- 3) DIMENSION TO BE CHECKED & CONFIRMED AT SITE PRIOR TO FABRICATION.
 2) FOR PE LINING DETAILS REFER SHEET NO.008
 1) FOR GENERAL NOTES REFER SHEET No. 009
 NOTES:



ورلي بارسونز - الصناعات العربية (محصاة)
 WorleyParsons-Arabian Industries (JV)

CONTRACT NO.: C31/0606 PROJ. NO.: PAIP00405




MTO DWG. No. :

NIM 3 2144 524 DQ 4

شركة تنمية نفط عُمان
 Petroleum Development Oman

DWG.	AREA CODE	ENG SECT	SERIAL NUMBER	SHEET	PROJ CODE	DWG SIZE	REV
NO	NIM	3	2144	024	DQ	3	0

PLANT NORTH

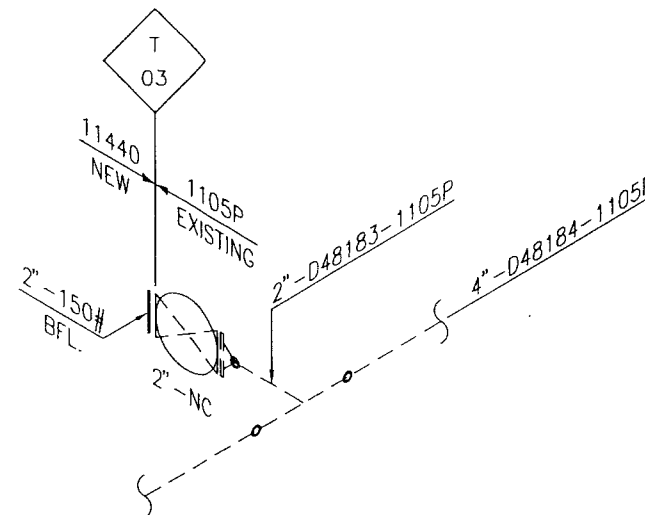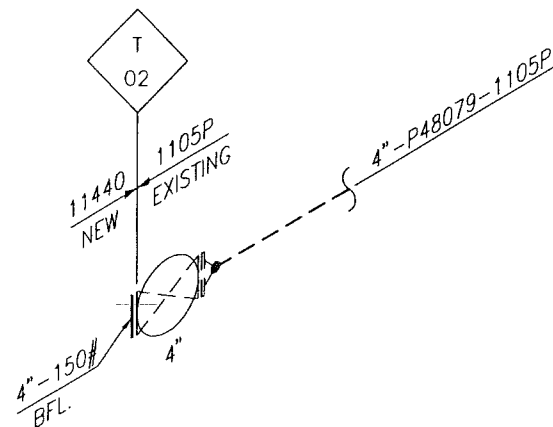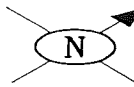
**APPROVED FOR
CONSTRUCTION**

- 3) DIMENSION TO BE CHECKED & CONFIRMED AT SITE PRIOR TO FABRICATION.
2) FOR PE LINING DETAILS REFER SHEET NO.008-
1) FOR GENERAL NOTES REFER SHEET No. 009

NOTES:



ورلي بارسونز - الصناعات العربية (محصاة)
WorleyParsons-Arabian Industries (JV)

CONTRACT NO.: C31/0606 PROJ. NO.: PAIP00405

MTO DWG. No. :

**DO NOT MAKE ANY MODIFICATION WITHOUT
CONFIRMATION FROM DESIGN DEPT.
AS THIS IS STRESS CRITICAL LINE**

STRESS RELIEVED NO
NDT REQUIREMENT N/A %
INSULATION N/A THK.
PAINTING PCS 1 OF SP1246



NIM 3 2144 525 DQ 4

Items not covered by material take-off sheets	Quantity	Requisition No.	Item	Description	Tag No.
MADE BY : MIS	DATE : APR.'11	CHKD BY :	APPRD BY :	TITLE : PIPING ISOMETRIC NIMR SLUDGE PITS SYSTEM UPGRADE-FED AND DD	
DESIGN PRESSURE 1820	kPag	PIPING CLASS	LINE No.		
DESIGN TEMP. 5 TO 82	°C	11440	P48079		
HYDRO TEST PRESS. N/A	kPag	11440	D48183		
W.B.S. No. NIM.IN.09.011	REV. 0	DATE APR.'11	SIGN.	DWG. AREA CODE ENG SECT SERIAL NUMBER SHEET PROJ CODE DWG SIZE REV	
PIPING ARRGT. DRWG. NIM-3-5085-001-DQ				NO NIM 3 2144 025 DQ 3 0	



شركة تنمية نفط عُمان
Petroleum Development Oman

PLANT NORTH

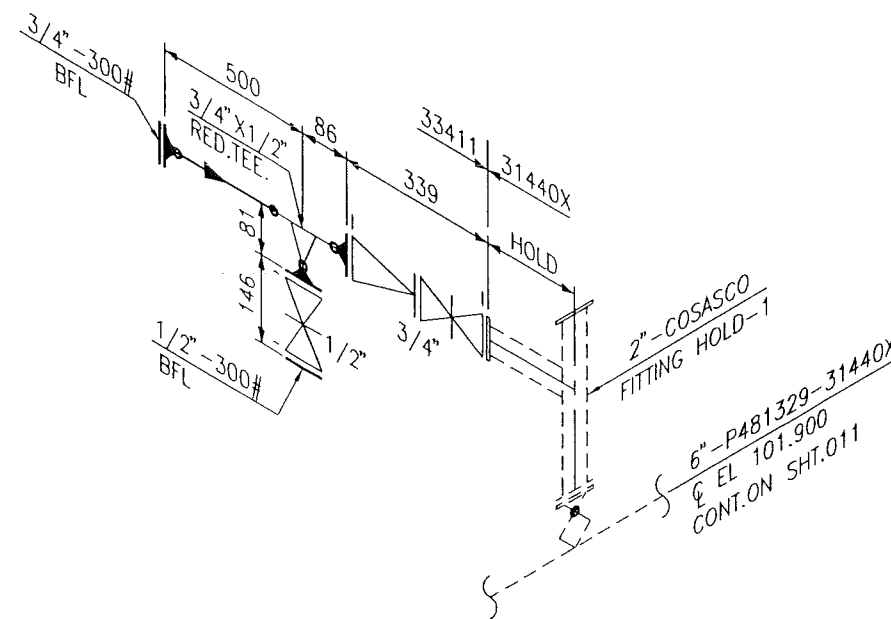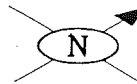


**APPROVED FOR
CONSTRUCTION**

HOLD:-1) COSASCO FITTING

Items not covered by material take-off sheets	Quantity	Requisition No.	Item	Description	Tag No.																																										
<table border="1"> <tr> <td>MADE BY :</td> <td>DATE :</td> <td>CHKD BY :</td> <td>APPRD BY :</td> <td colspan="2">TITLE :</td> </tr> <tr> <td>MIS</td> <td>APR.'11</td> <td></td> <td></td> <td colspan="2">PIPING ISOMETRIC NIMR SLUDGE PITS SYSTEM UPGRADE-FED AND DD</td> </tr> </table>						MADE BY :	DATE :	CHKD BY :	APPRD BY :	TITLE :		MIS	APR.'11			PIPING ISOMETRIC NIMR SLUDGE PITS SYSTEM UPGRADE-FED AND DD																															
MADE BY :	DATE :	CHKD BY :	APPRD BY :	TITLE :																																											
MIS	APR.'11			PIPING ISOMETRIC NIMR SLUDGE PITS SYSTEM UPGRADE-FED AND DD																																											
3) DIMENSION TO BE CHECKED & CONFIRMED AT SITE PRIOR TO FABRICATION. 2) FOR PE/ROTO LINING DETAILS REFER SHEET NO.008 1) FOR GENERAL NOTES REFER SHEET No. 009 NOTES:		<table border="1"> <tr> <td>STRESS RELIEVED</td> <td>NO</td> <td>DESIGN PRESSURE</td> <td>4429</td> <td>kPag</td> <td>PIPING CLASS</td> <td>LINE No.</td> </tr> <tr> <td>NDT REQUIREMENT</td> <td>RT10 % RANDOM</td> <td>DESIGN TEMP.</td> <td>5 TO 82</td> <td>°C</td> <td>33411</td> <td>P481329</td> </tr> <tr> <td>INSULATION</td> <td>NIL THK.</td> <td>HYDRO TEST PRESS.</td> <td>6643</td> <td>kPag</td> <td> </td> <td> </td> </tr> <tr> <td>PAINTING</td> <td>PCS -</td> <td>W.B.S. No.</td> <td>IN.09.011</td> <td> </td> <td>REV.</td> <td>0</td> </tr> <tr> <td colspan="2">DO NOT MAKE ANY MODIFICATION WITHOUT CONFIRMATION FROM DESIGN DEPT. AS THIS IS STRESS CRITICAL LINE</td> <td colspan="2">PIPING ARRGT. DRWG.</td> <td colspan="3">DATE APR.'11</td> </tr> <tr> <td colspan="2">NIM 3 2144 527 DQ 4</td> <td colspan="2">NIM-3-2140-001-DQ</td> <td colspan="3">SIGN. </td> </tr> </table>				STRESS RELIEVED	NO	DESIGN PRESSURE	4429	kPag	PIPING CLASS	LINE No.	NDT REQUIREMENT	RT10 % RANDOM	DESIGN TEMP.	5 TO 82	°C	33411	P481329	INSULATION	NIL THK.	HYDRO TEST PRESS.	6643	kPag			PAINTING	PCS -	W.B.S. No.	IN.09.011		REV.	0	DO NOT MAKE ANY MODIFICATION WITHOUT CONFIRMATION FROM DESIGN DEPT. AS THIS IS STRESS CRITICAL LINE		PIPING ARRGT. DRWG.		DATE APR.'11			NIM 3 2144 527 DQ 4		NIM-3-2140-001-DQ		SIGN.		
STRESS RELIEVED	NO	DESIGN PRESSURE	4429	kPag	PIPING CLASS	LINE No.																																									
NDT REQUIREMENT	RT10 % RANDOM	DESIGN TEMP.	5 TO 82	°C	33411	P481329																																									
INSULATION	NIL THK.	HYDRO TEST PRESS.	6643	kPag																																											
PAINTING	PCS -	W.B.S. No.	IN.09.011		REV.	0																																									
DO NOT MAKE ANY MODIFICATION WITHOUT CONFIRMATION FROM DESIGN DEPT. AS THIS IS STRESS CRITICAL LINE		PIPING ARRGT. DRWG.		DATE APR.'11																																											
NIM 3 2144 527 DQ 4		NIM-3-2140-001-DQ		SIGN.																																											
 CONTRACT NO.: C31/0606 PROJ. NO.: PAIP00405		 DWG. AREA CODE ENG SECT SERIAL NUMBER SHEET PROJ CODE DWG SIZE REV NO NIM 3 2144 027 DQ 3 0																																													

MTO DWG. No. :

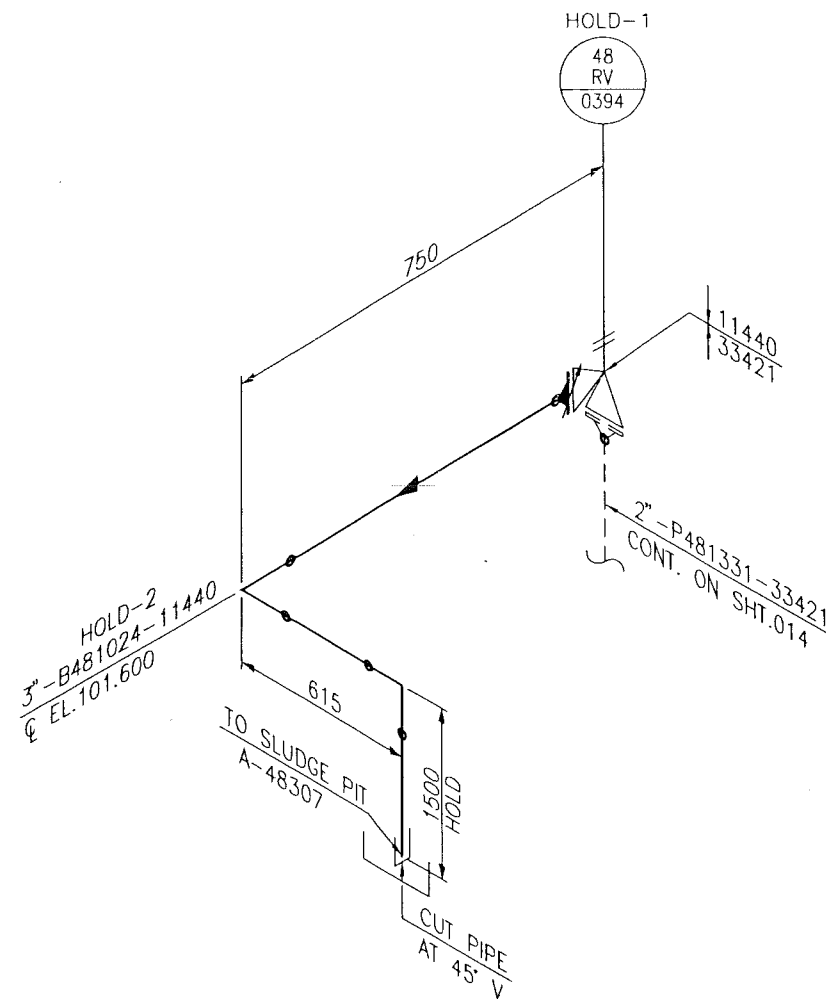


**APPROVED FOR
CONSTRUCTION**

HOLD:-1) 48 RV 394 VLV SIZE.
2) LINE SIZE.

[illegible]

3) DIMENSION TO BE CHECKED & CONFIRMED AT SITE PRIOR TO FABRICATION.
2) FOR PE LINING DETAILS REFER SHEET NO.008
1) FOR GENERAL NOTES REFER SHEET No. 009
NOTES:


 ورلي بارسونز - الصناعات العربية (محصاة)
 WorleyParsons-Arabian Industries (JV)

CONTRACT NO.: C31/0606	PROJ. NO.: PAIP00405
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MTO DWG. No. :


~~DO NOT MAKE ANY MODIFICATION WITHOUT
CONFIRMATION FROM DESIGN DEPT.
AS THIS IS STRESS CRITICAL LINE.~~

STRESS RELIEVED	NO				
NDT REQUIREMENT	RT10	%	RANDOM		
INSULATION	N/A THK.				
PAINTING	PCS 01	OF	SP1246		
NIM	3	2144	528	DQ	4

MADE BY :	DATE :	CHKD BY :	APPRD BY :	TITLE :
MIS	APR '11			PIPING ISOMETRIC NIMR SLUDGE PITS SYSTEM UPGRADE-FED AND DD

[illegible]

W:\3_Piping\WPAI-PDO EMC JOBS (C310606)\PROJECTS\PAIP-PROJECT-JOBS\PAIP00405_DQ\ISO\32144028_DQ.dwg 13-APR-2011 9:42:60 AM Mohd.Sheikh

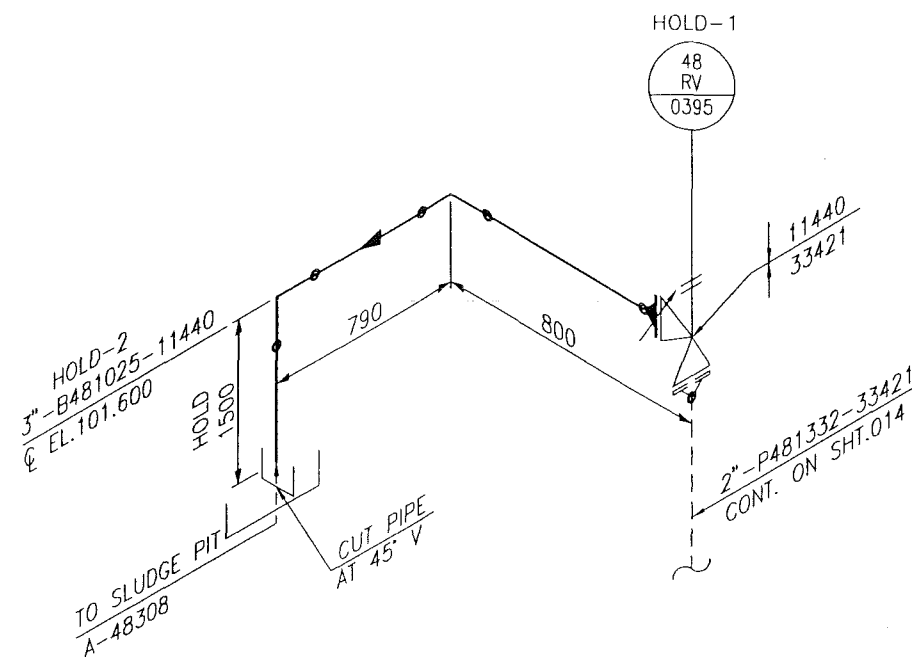

**APPROVED FOR
CONSTRUCTION**

HOLD:-1) 48 RV 395 VLV SIZ.
2) LINE SIZE.

3) ~~DIMENSION TO BE CHECKED & CONFIRMED AT SITE PRIOR TO FABRICATION.~~
2) ~~FOR PE LINING DETAILS REFER SHEET NO.008-~~
1) FOR GENERAL NOTES REFER SHEET No. 009

NOTES:



ورلي بارسونز - الصناعات العربية (محاصة)
WorleyParsons-Arabian Industries (JV)

CONTRACT NO. : C31/0606	PROJ. NO. : PAIP00405
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MTO DWG. No. :

~~DO NOT MAKE ANY MODIFICATION WITHOUT
CONFIRMATION FROM DESIGN DEPT.
AS THIS IS STRESS CRITICAL LINE.~~


STRESS RELIEVED	NO
NDT REQUIREMENT	RT10 % RANDOM
INSULATION	N/A THK.
PAINTING	PCS 01 OF SP1246

NIM 3 2144 529 DQ 4

MADE BY :	
MIS	

DATE :
APR.'11

CHKD BY :
WA

APPRD BY


7	TITLE :
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PIPING ISOMETRIC
NIMR SLUDGE PITS SYSTEM UPGRADE-FED AND DD

DESIGN PRESSURE	1820	kPag
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DESIGN TEMP.	5 TO 82	°C
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HYDRO TEST PRESS.	2730	kPag
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W.B.S. No. NIM.N.09.011

PIPING ARRGT. DRWG.
NIM-3-2140-001-DQ

	PIPING CLASS
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11440

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REV.	0	
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DATE	APR.'11
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LINE No.

B481025



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شركة تنمية نفط عُمان
Petroleum Development Oman

DWG.	AREA CODE	ENG SECT	SERIAL NUMBER	SHEET	PROJ CODE	DWG SIZE	RE
NO	NIM	3	2144	029	DQ	3	

PLANT NORTH


**APPROVED FOR
CONSTRUCTION**

HOLD-1) S-48362 VENDOR INFORMATION
2) ROTO LINING THICKNESS

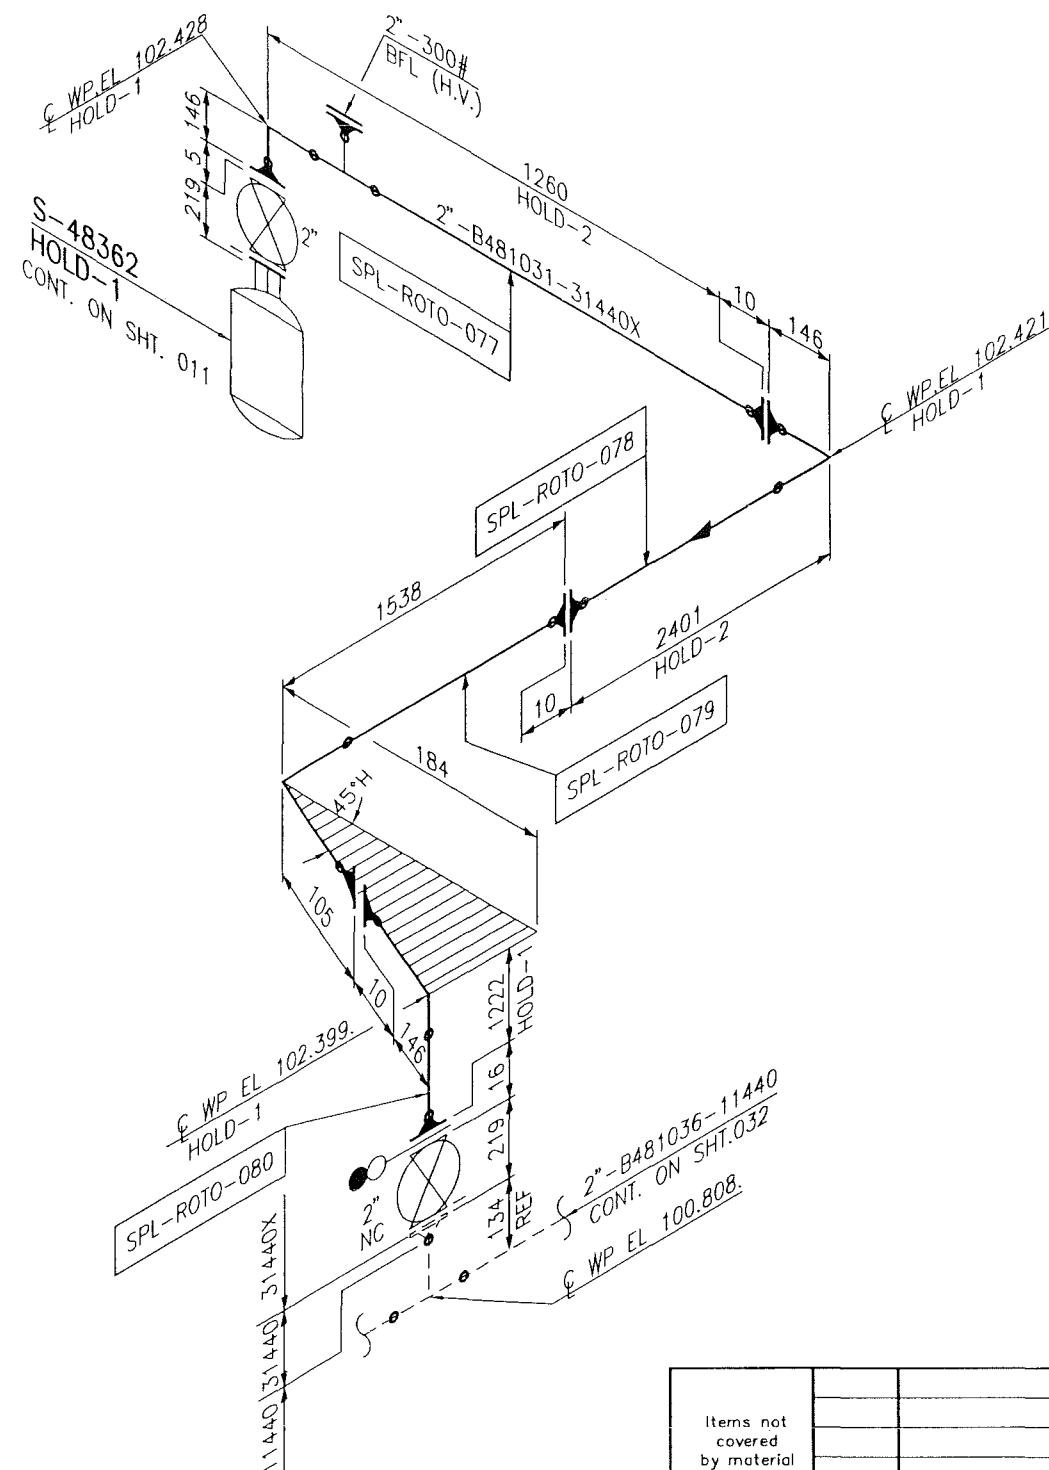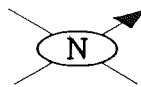
4) 31440X INDICATE PE/ROTO PIPING LINED AND VALVES
WITH BODY & TRIM OF 25% Cr.SDSS

3) DIMENSION TO BE CHECKED & CONFIRMED AT SITE PRIOR TO FABRICATION.

2) FOR PE/ROTO LINING DETAILS REFER SHEET NO.008

1) FOR GENERAL NOTES REFER SHEET No. 009

NOTES:


 ورلي بارسونز - الصناعات العربية (محصاة)
 WorleyParsons-Arabian Industries (JV)


CONTRACT NO.: C31/0606 PROJ. NO.: PAIP00405

MTO DWG. No. :



**DO NOT MAKE ANY MODIFICATION WITHOUT
CONFIRMATION FROM DESIGN DEPT.
AS THIS IS STRESS CRITICAL LINE**

STRESS RELIEVED	NO
NDT REQUIREMENT	RT10 % RANDOM
INSULATION	NIL THK.
PAINTING	PCS 1 OF SP1246

NIM 3 2144 530 DQ 4

Items not covered by material take-off sheets	Quantity	Requisition No.	Item	Description	Tag No.
MADE BY :	DATE :	CHKD BY :	APPRD BY :	TITLE :	
MD	APR.'11			PIPING ISOMETRIC NIMR SLUDGE PITS SYSTEM UPGRADE-FED AND DD	
DESIGN PRESSURE	4782	kPag	PIPING CLASS	LINE No.	
DESIGN TEMP.	5 TO 82	°C	31440X	B480131	
HYDRO TEST PRESS.	7173	kPag			
W.B.S. No.	IN.09.011		REV.	0	
PIPING ARRGT. DRWG.	NIM-3-2140-001-DQ		DATE	APR.'11	
			SIGN.		
 شركة تنمية نفط عمان Petroleum Development Oman			DWG.	AREA CODE	ENG SECT
			SERIAL NUMBER	SHEET	PROJ CODE
			DWG SIZE	REV	
			NO	NIM 3 2144 030 DQ	3 0

PLANT NORTH

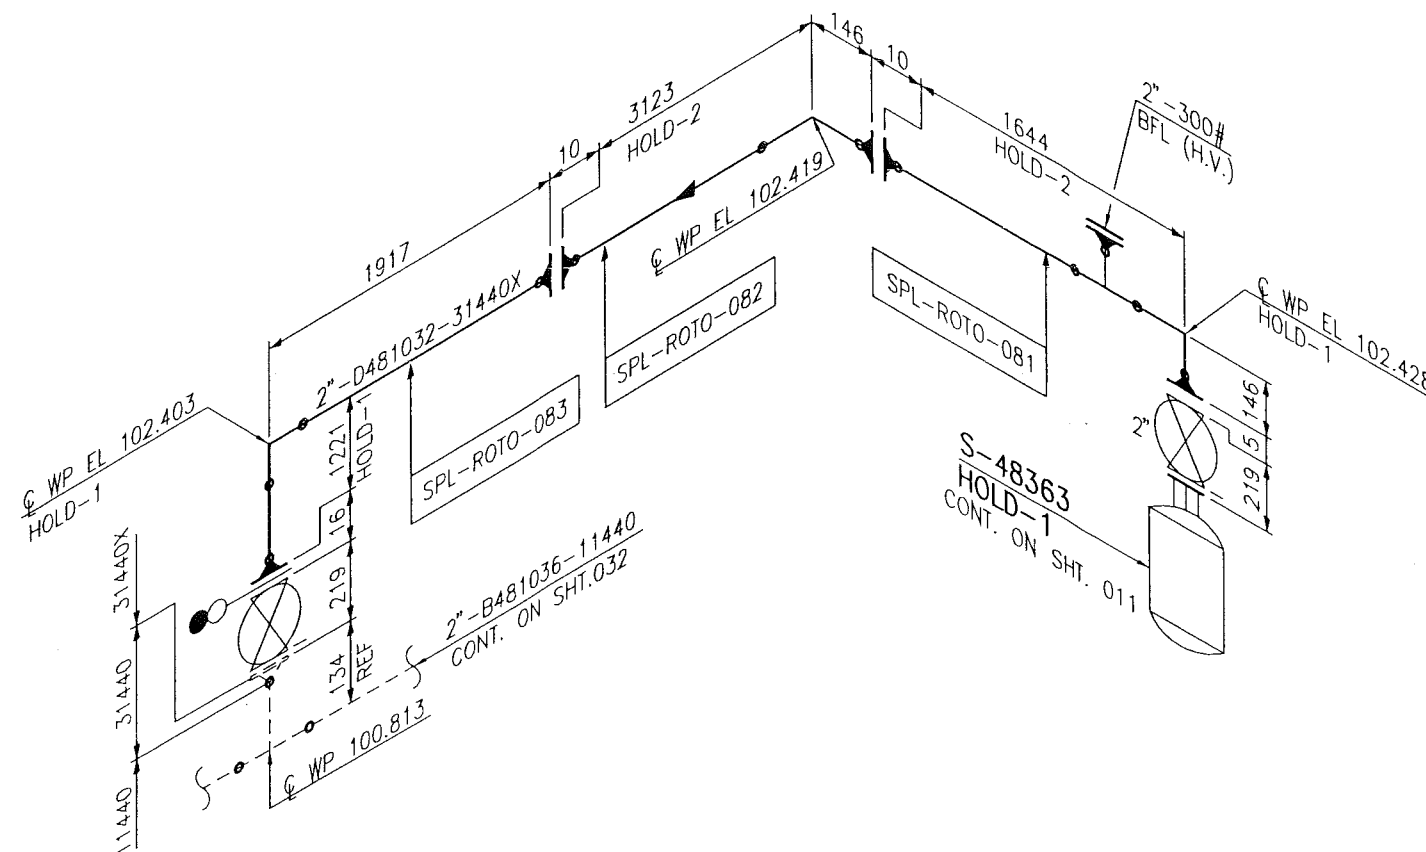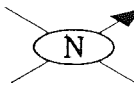

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CONSTRUCTION**

HOLD-1) S-48363 VENDOR INFORMATION
2) ROTO LINING THICKNESS

- 4) 31440X INDICATE PIPING CLASS WITH PE/ROTO LINED. VALVE WITH BODY & TRIM 25% SDSS
- 3) DIMENSION TO BE CHECKED & CONFIRMED AT SITE PRIOR TO FABRICATION:-
- 2) FOR PE/ROTO LINING DETAILS REFER SHEET NO.008
- 1) FOR GENERAL NOTES REFER SHEET No. 009
- NOTES:



ورلي بارسونز - الصناعات العربية (محصاة)
WorleyParsons-Arabian Industries (JV)

CONTRACT NO.: C31/0606 PROJ. NO.: PAIP00405

MTO DWG. No. :

**DO NOT MAKE ANY MODIFICATION WITHOUT
CONFIRMATION FROM DESIGN DEPT.
AS THIS IS STRESS CRITICAL LINE**

STRESS RELIEVED NO
NOT REQUIREMENT RT10 % RANDOM
INSULATION NIL THK.

PAINTING PCS 1 OF SP1246


NIM 3 2144 531 DQ 4

MADE BY : MD DATE : APR.'11 CHKD BY : APPRD BY : TITLE : PIPING ISOMETRIC
NIMR SLUDGE PITS SYSTEM UPGRADE-FED AND DD

DESIGN PRESSURE 4782 kPag PIPING CLASS 31440X LINE No. B480132
DESIGN TEMP. 5 TO 82 °C
HYDRO TEST PRESS. 7173 kPag



W.B.S. No. IN.09.011 REV. 0

PIPING ARRGT. DRWG. NIM-3-2140-001-DQ DATE APR.'11 SIGN.

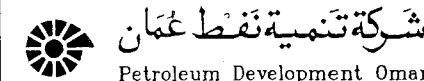

DWG. AREA CODE ENG SECT SERIAL NUMBER SHEET PROJ CODE DWG SIZE REV
No NIM 3 2144 031 DQ 3 0

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CONSTRUCTION**

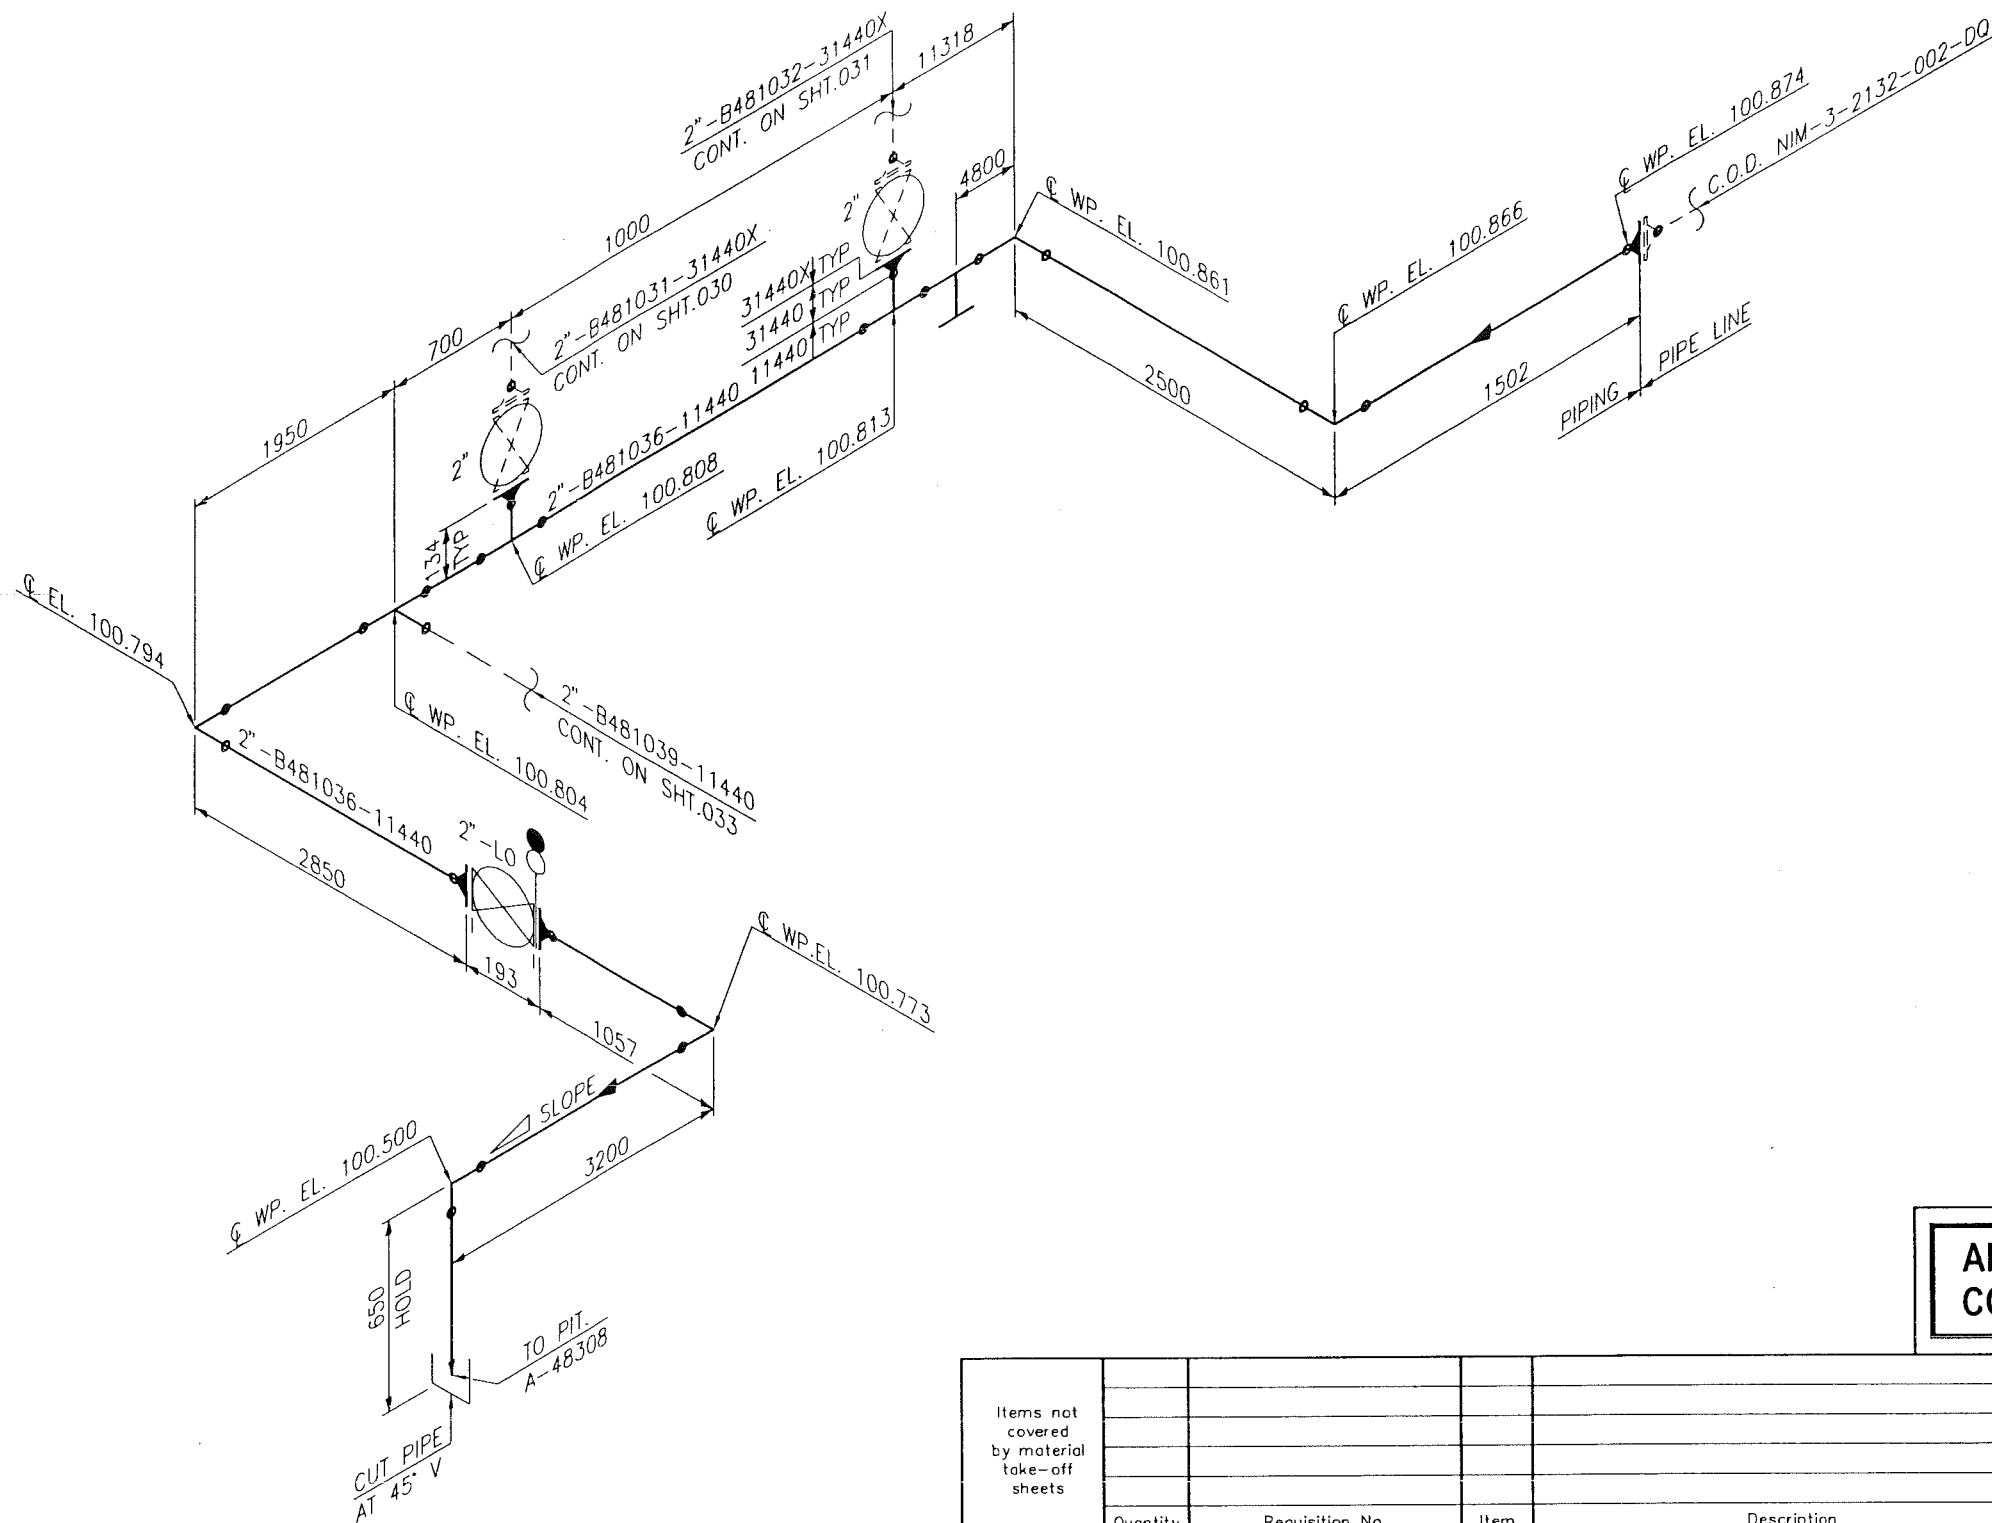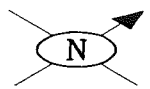Items not covered by material take-off sheets	Quantity	Requisition No.	Item	Description	Tag No.

- 3) DIMENSION TO BE CHECKED & CONFIRMED AT SITE PRIOR TO FABRICATION.
 2) FOR PE LINING DETAILS REFER SHEET NO.008-
 1) FOR GENERAL NOTES REFER SHEET No. 009
 NOTES:

**DO NOT MAKE ANY MODIFICATION WITHOUT
CONFIRMATION FROM DESIGN DEPT.
AS THIS IS STRESS CRITICAL LINE**

MADE BY : LAILA DATE : APR.'11 CHKD BY : APPRD BY : TITLE : PIPING ISOMETRIC
NIMR SLUDGE PITS SYSTEM UPGRADE-FED AND DD

STRESS RELIEVED NO
 NDT REQUIREMENT RT10 % RANDOM
 INSULATION NIL THK.
 PAINTING PCS 1 OF SP 1246

DESIGN PRESSURE 1820 kPag
 DESIGN TEMP. 5 TO 82 °C
 HYDRO TEST PRESS. 2730 kPag
 W.B.S. No. IN.09.011

PIPING CLASS 11440
 LINE No. B481036

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 WorleyParsons-Arabian Industries (JV)

MTO DWG. No. :

NIM 3 2144 532 DQ 4



PIPING ARRGT. DRWG.
 NIM-3-2140-001-DQ

REV. 0
 DATE APR.'11
 SIGN.

DWG.	AREA CODE	ENG SECT	SERIAL NUMBER	SHEET	PROJ CODE	DWG SIZE	REV
NO	NIM	3	2144	032	DQ	3	0

CONTRACT NO. : C31/0606 PROJ. NO. : PAIP00405


PLANT NORTH

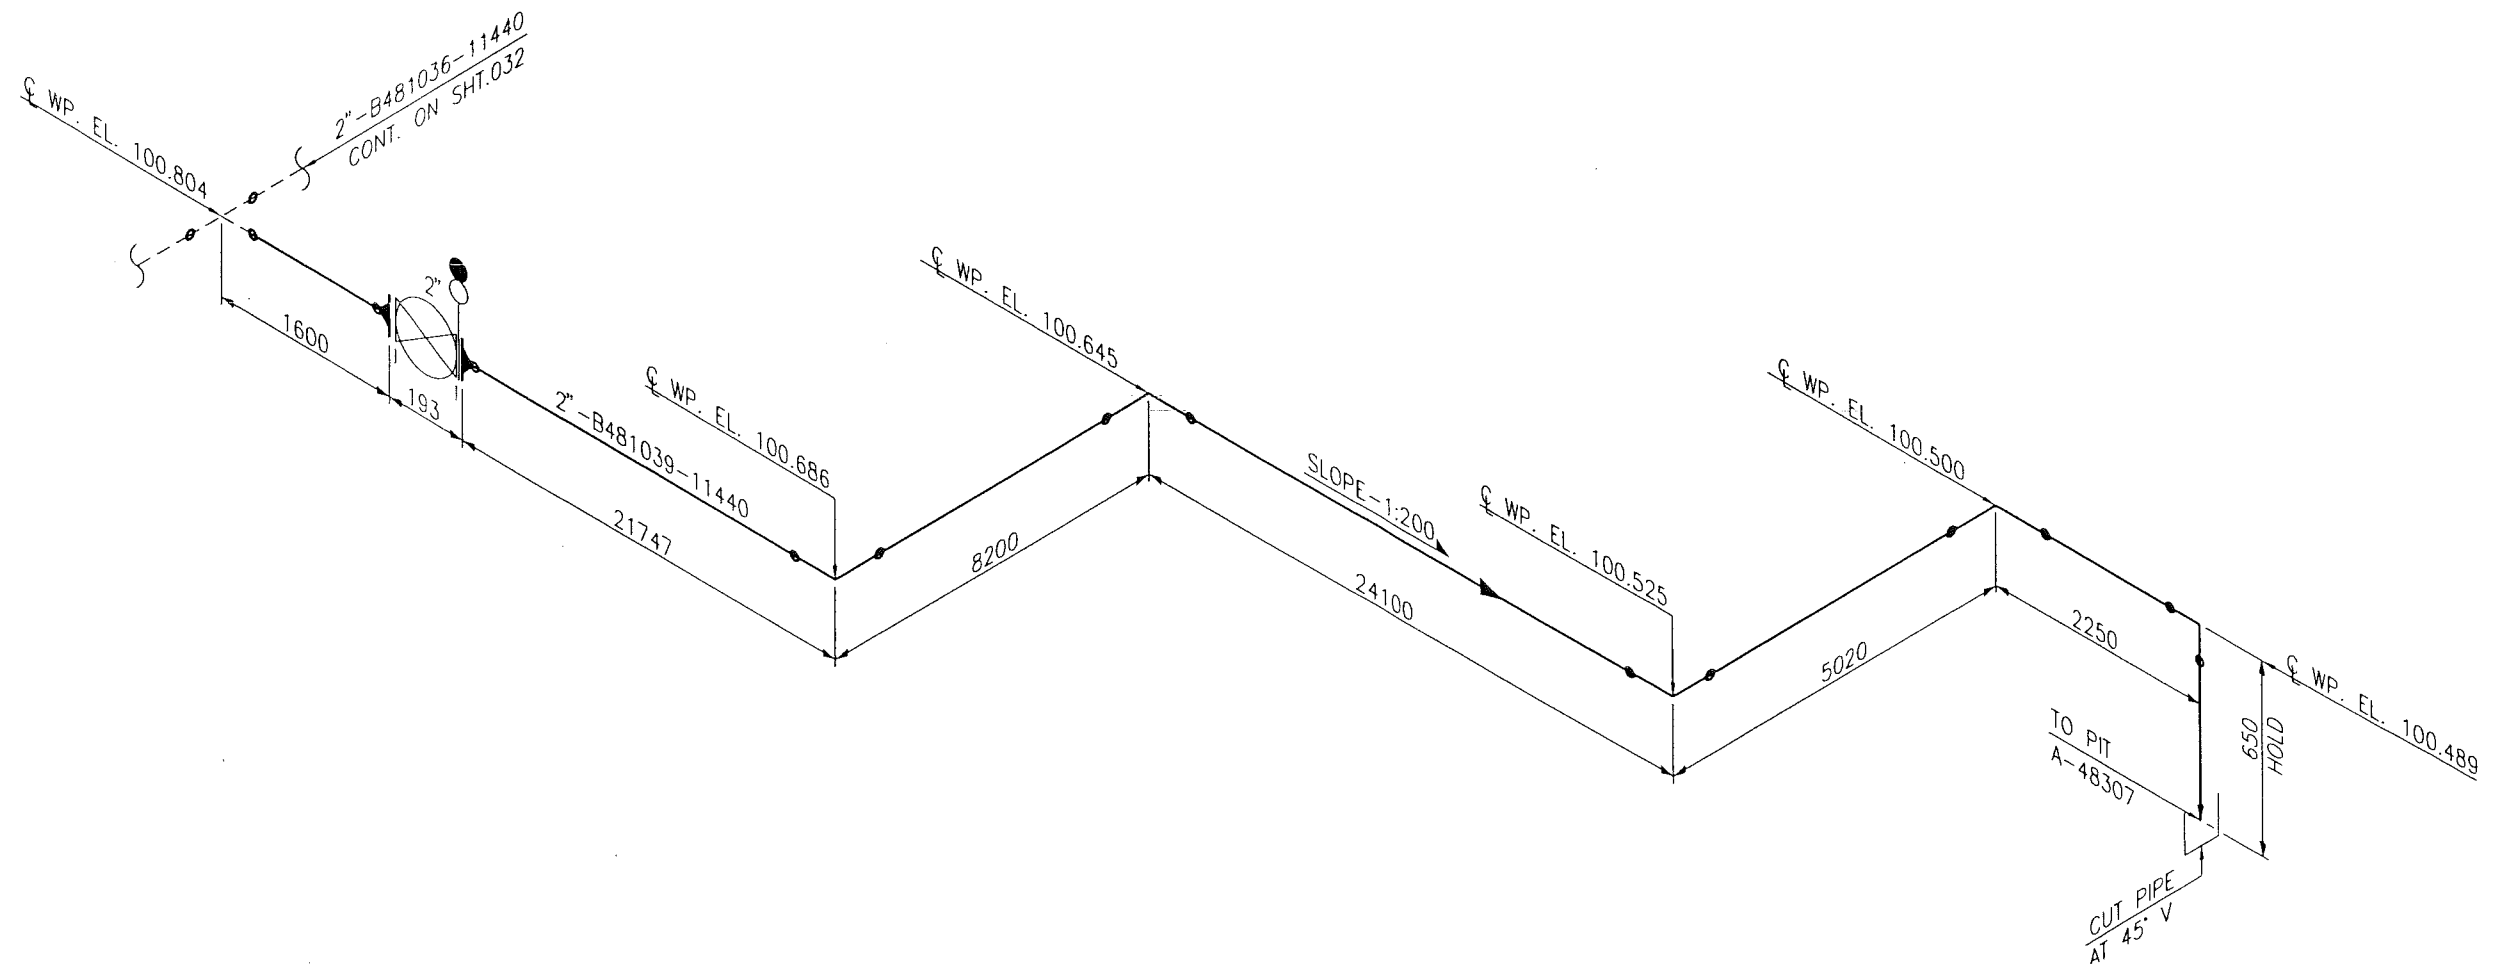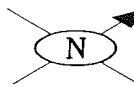

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CONSTRUCTION**

Items not covered by material take-off sheets	Quantity	Requisition No.	Item	Description	Tag No.

- 3) DIMENSION TO BE CHECKED & CONFIRMED AT SITE PRIOR TO FABRICATION.
 2) FOR PE LINING DETAILS REFER SHEET NO.008-
 1) FOR GENERAL NOTES REFER SHEET No. 009
 NOTES:

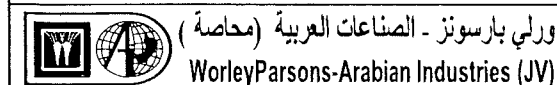


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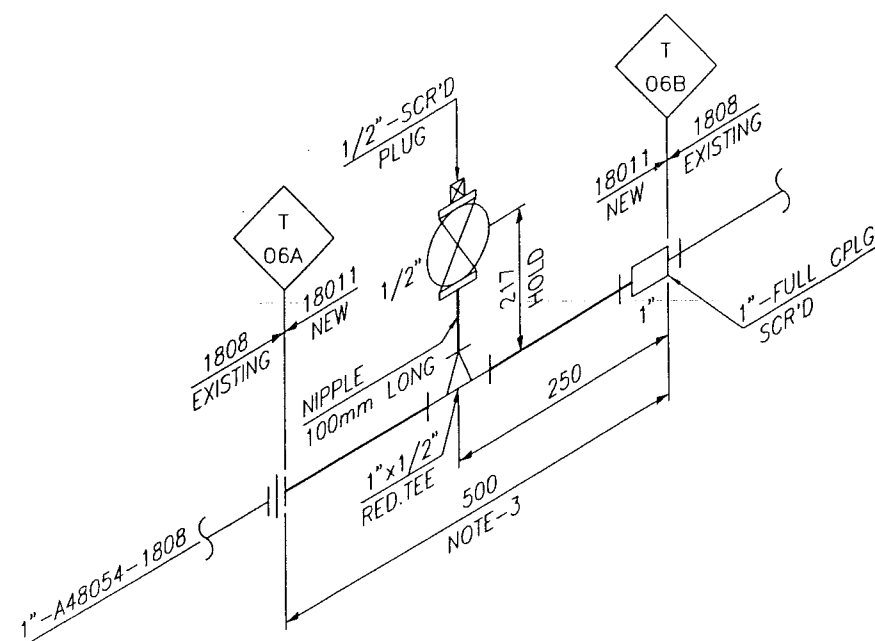
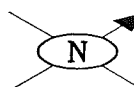
**DO NOT MAKE ANY MODIFICATION WITHOUT
CONFIRMATION FROM DESIGN DEPT.
AS THIS IS STRESS CRITICAL LINE.**

STRESS RELIEVED	NO
NDT REQUIREMENT	RT10 % RANDOM
INSULATION	NIL THK.
PAINTING	PCS 1 OF SP1246
NIM 3 2144 533 DQ 4	

MADE BY : MD	DATE : APR.'11	CHKD BY : [Signature]	APPRD BY : [Signature]	TITLE : PIPING ISOMETRIC NIMR SLUDGE PITS SYSTEM UPGRADE-FED AND DD	
DESIGN PRESSURE	1820	kPag	PIPING CLASS	LINE No.	
DESIGN TEMP.	5 TO 82	°C	11440	B481039	
HYDRO TEST PRESS.	2730	kPag			
W.B.S. No.	IN.09.011	REV.	0		
PIPING ARRGT. DRWG.	NIM-3-2140-001-DQ NIM-3-2141-001-DQ NIM-3-2142-001-DQ	DATE	APR'11		
		SIGN.	[Signature]		
DWG.	AREA CODE	ENG SECT	SERIAL NUMBER	SHEET	PROJ CODE
NO	NIM	3	2144	033	DQ
				3	0



PLANT NORTH

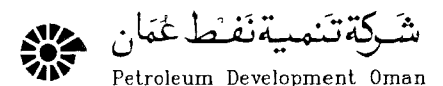

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CONSTRUCTION**

- 4) LINE SHALL BE PNEUMATIC TESTED AT 700Kpag
 3) DIMENSION TO BE CHECKED & CONFIRMED AT SITE PRIOR TO FABRICATION.
 2) FOR PE LINING DETAILS REFER SHEET NO.008
 1) FOR GENERAL NOTES REFER SHEET No. 009
 NOTES:



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 WorleyParsons-Arabian Industries (JV)

CONTRACT NO.: C31/0606 PROJ. NO.: PAIP00405


MTO DWG. No. :

**DO NOT MAKE ANY MODIFICATION WITHOUT
CONFIRMATION FROM DESIGN DEPT.
AS THIS IS STRESS CRITICAL LINE**

STRESS RELIEVED NO
 NDT REQUIREMENT N/A %
 INSULATION N/A THK.
 PAINTING PCS N/A

NIM 3 2144 536 DQ 4

Items not covered by material take-off sheets	Quantity	Requisition No.	Item	Description	Tag No.
MADE BY : MIS DATE : APR.'11 CHKD BY : APPRD BY : TITLE : PIPING ISOMETRIC NIMR SLUDGE PITS SYSTEM UPGRADE-FED AND DD					
DESIGN PRESSURE 1600 kPag		PIPING CLASS 18011		LINE No. A48054	
DESIGN TEMP. 5 TO 60 °C		HYDRO TEST PRESS. N/A kPag		W.B.S. No. NIM.IN.09.011	
REV. 0		DATE APR.'11		SIGN.	
DWG. AREA CODE		ENG SECT		SERIAL NUMBER	
SHEET		PROJ CODE		DWG SIZE	
NO NIM 3 2144 036 DQ 3		REV 0			

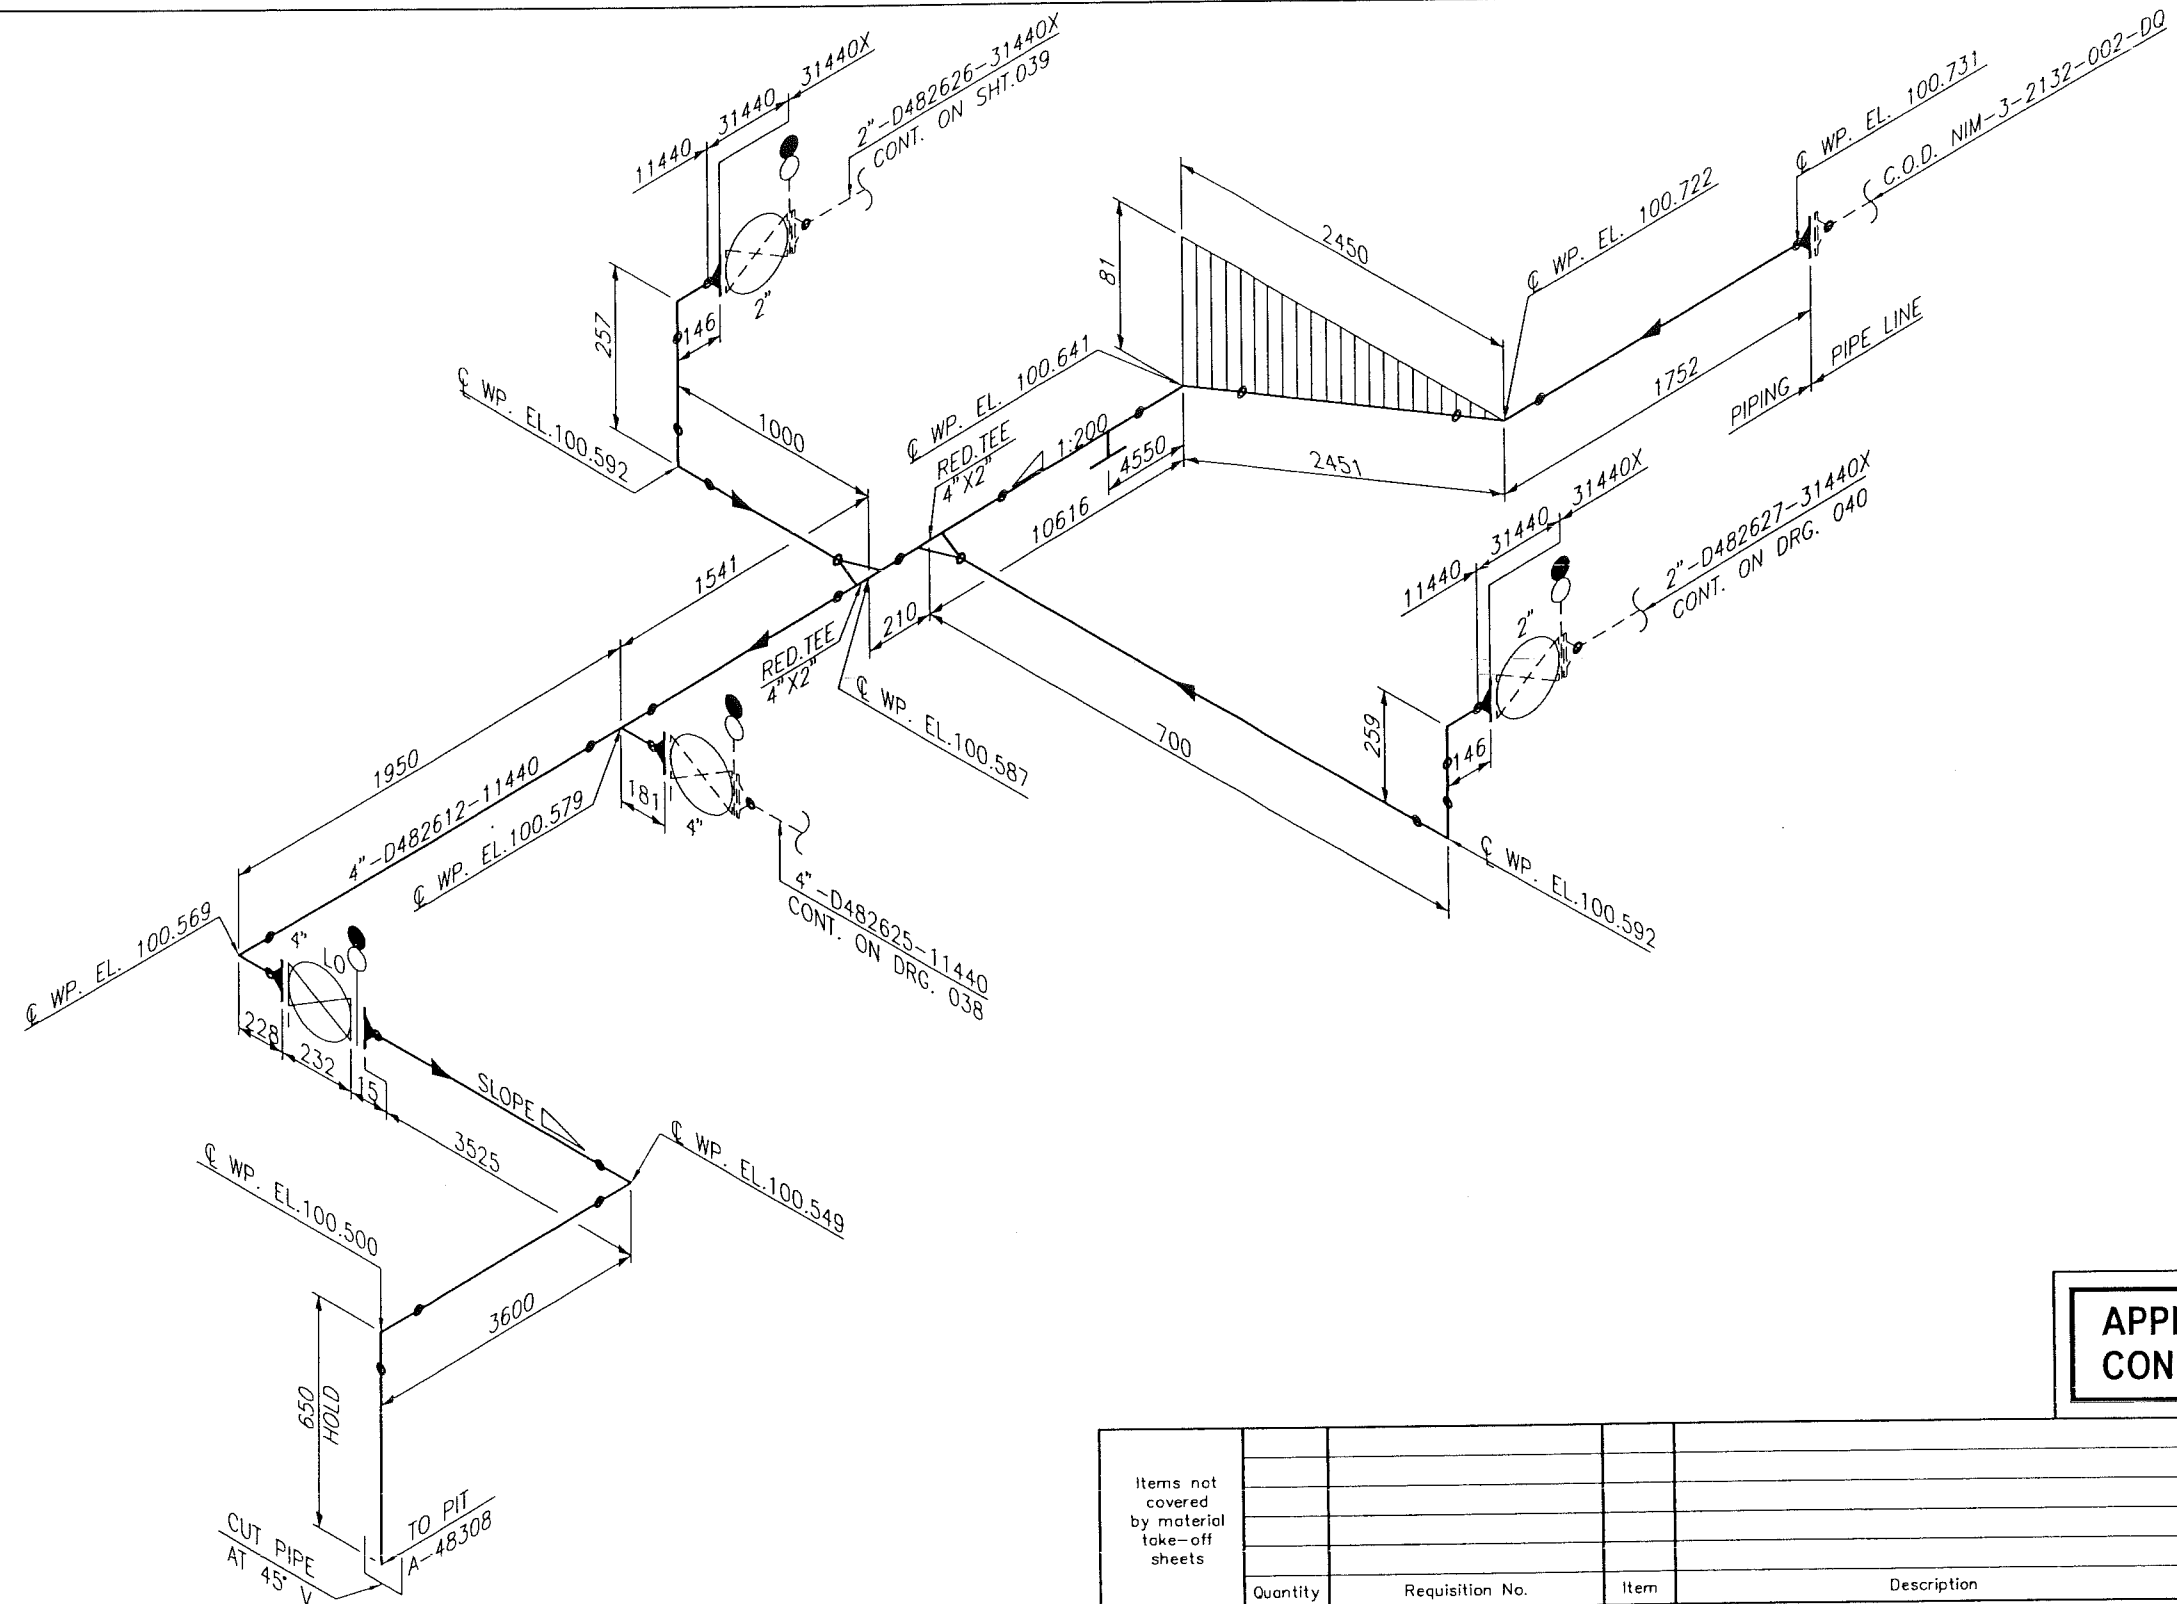

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CONSTRUCTION**

[illegible]

NOTES:





ورلي بارسونز - الصناعات العربية (محصاة)
WorleyParsons-Arabian Industries (JV)

MTO DWG. No. :

PROJ. NO.: PAIP00405

PLANT NORTH

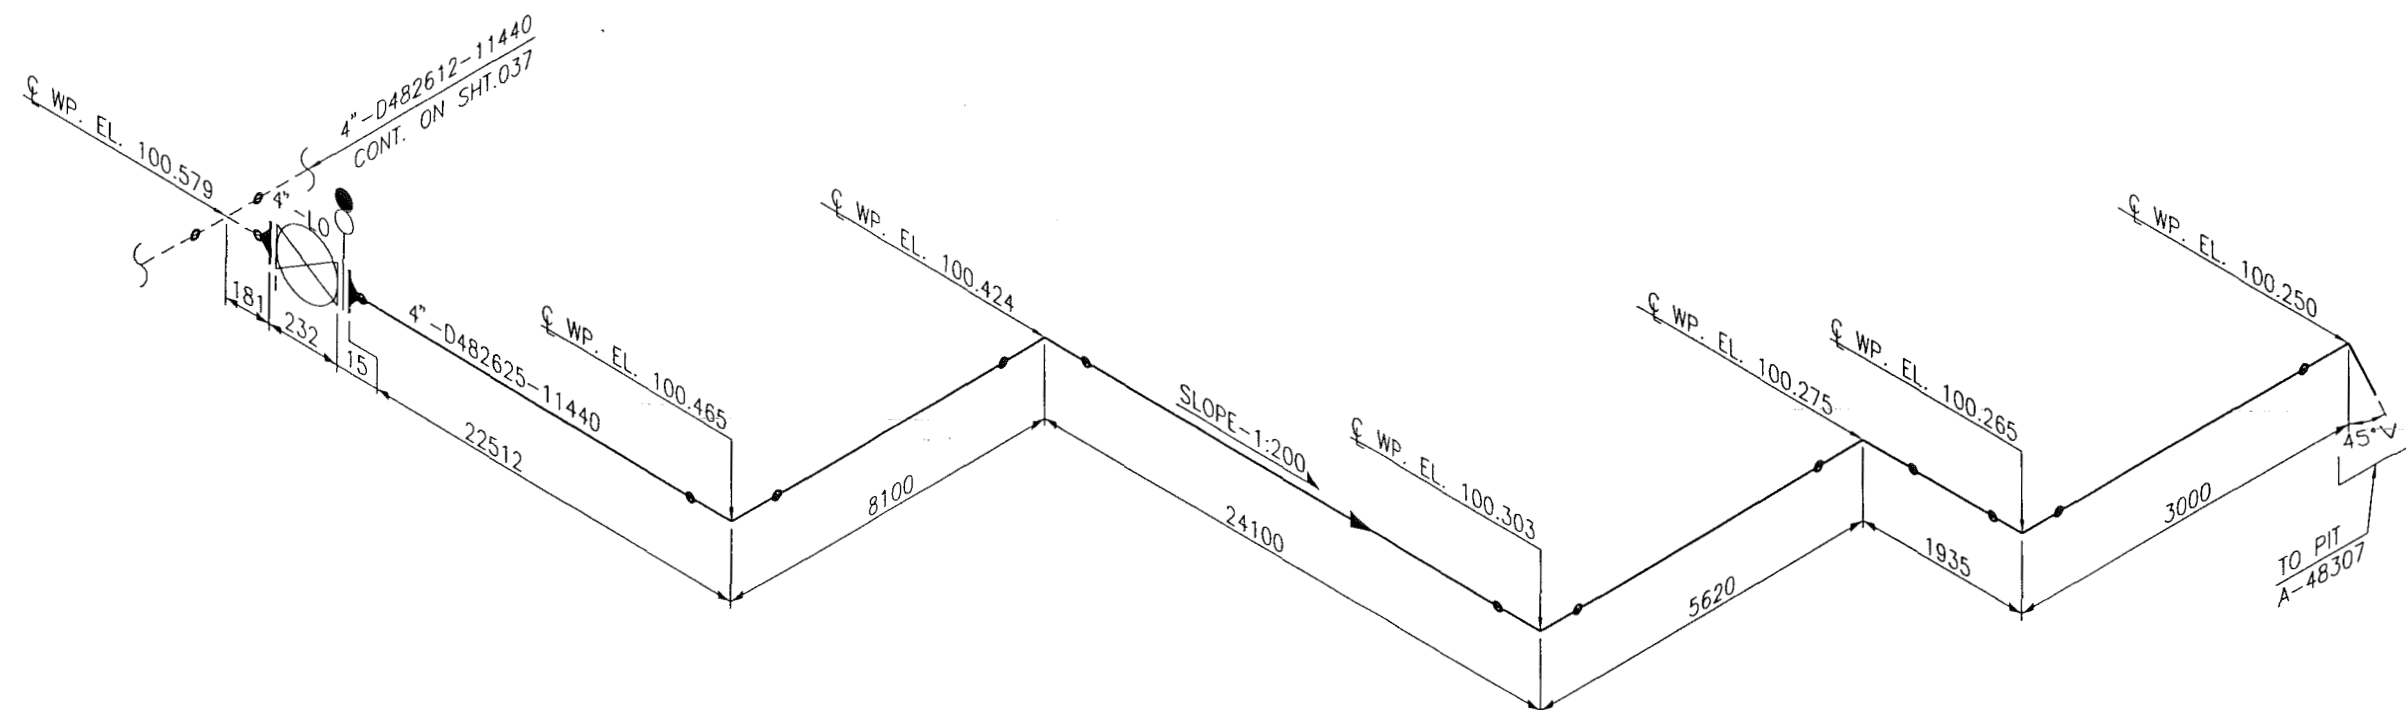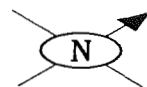

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CONSTRUCTION**

Items not covered by material take-off sheets	Quantity	Requisition No.	Item	Description	Tag No.

- 3) DIMENSION TO BE CHECKED & CONFIRMED AT SITE PRIOR TO FABRICATION.
 2) FOR PE LINING DETAILS REFER SHEET NO.008
 1) FOR GENERAL NOTES REFER SHEET No. 009
 NOTES:



ورلي بارسونز - الصناعات العربية (محصاة)
 WorleyParsons-Arabian Industries (JV)

CONTRACT NO.: C31/0606 PROJ. NO.: PAIP00405

MTO DWG. No. :

**DO NOT MAKE ANY MODIFICATION WITHOUT
CONFIRMATION FROM DESIGN DEPT.
AS THIS IS STRESS CRITICAL LINE**

STRESS RELIEVED NO
 NDT REQUIREMENT RT10 % RANDOM
 INSULATION NIL THK.
 PAINTING PCS 1 OF SP1246

NIM 3 2144 538 DQ 4

MADE BY : MD DATE : APR.'11 CHKD BY : APPRD BY : TITLE : PIPING ISOMETRIC
 NIMR SLUDGE PITS SYSTEM UPGRADE-FED AND DD

DESIGN PRESSURE 1820 kPag PIPING CLASS 11440 LINE No. D482625
 DESIGN TEMP. 5 TO 82 °C
 HYDRO TEST PRESS. 2730 kPag
 W.B.S. No. IN.09.011



REV. 0 DATE APR'11 SIGN.
 PIPING ARRGT. DRWG.
 NIM-3-2140-001-DQ
 NIM-3-2141-001-DQ
 NIM-3-2142-001-DQ



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DWG.	AREA CODE	ENG SECT	SERIAL NUMBER	SHEET	PROJ CODE	DWG SIZE	REV
NO	NIM	3	2144	038	DQ	3	0

PLANT NORTH

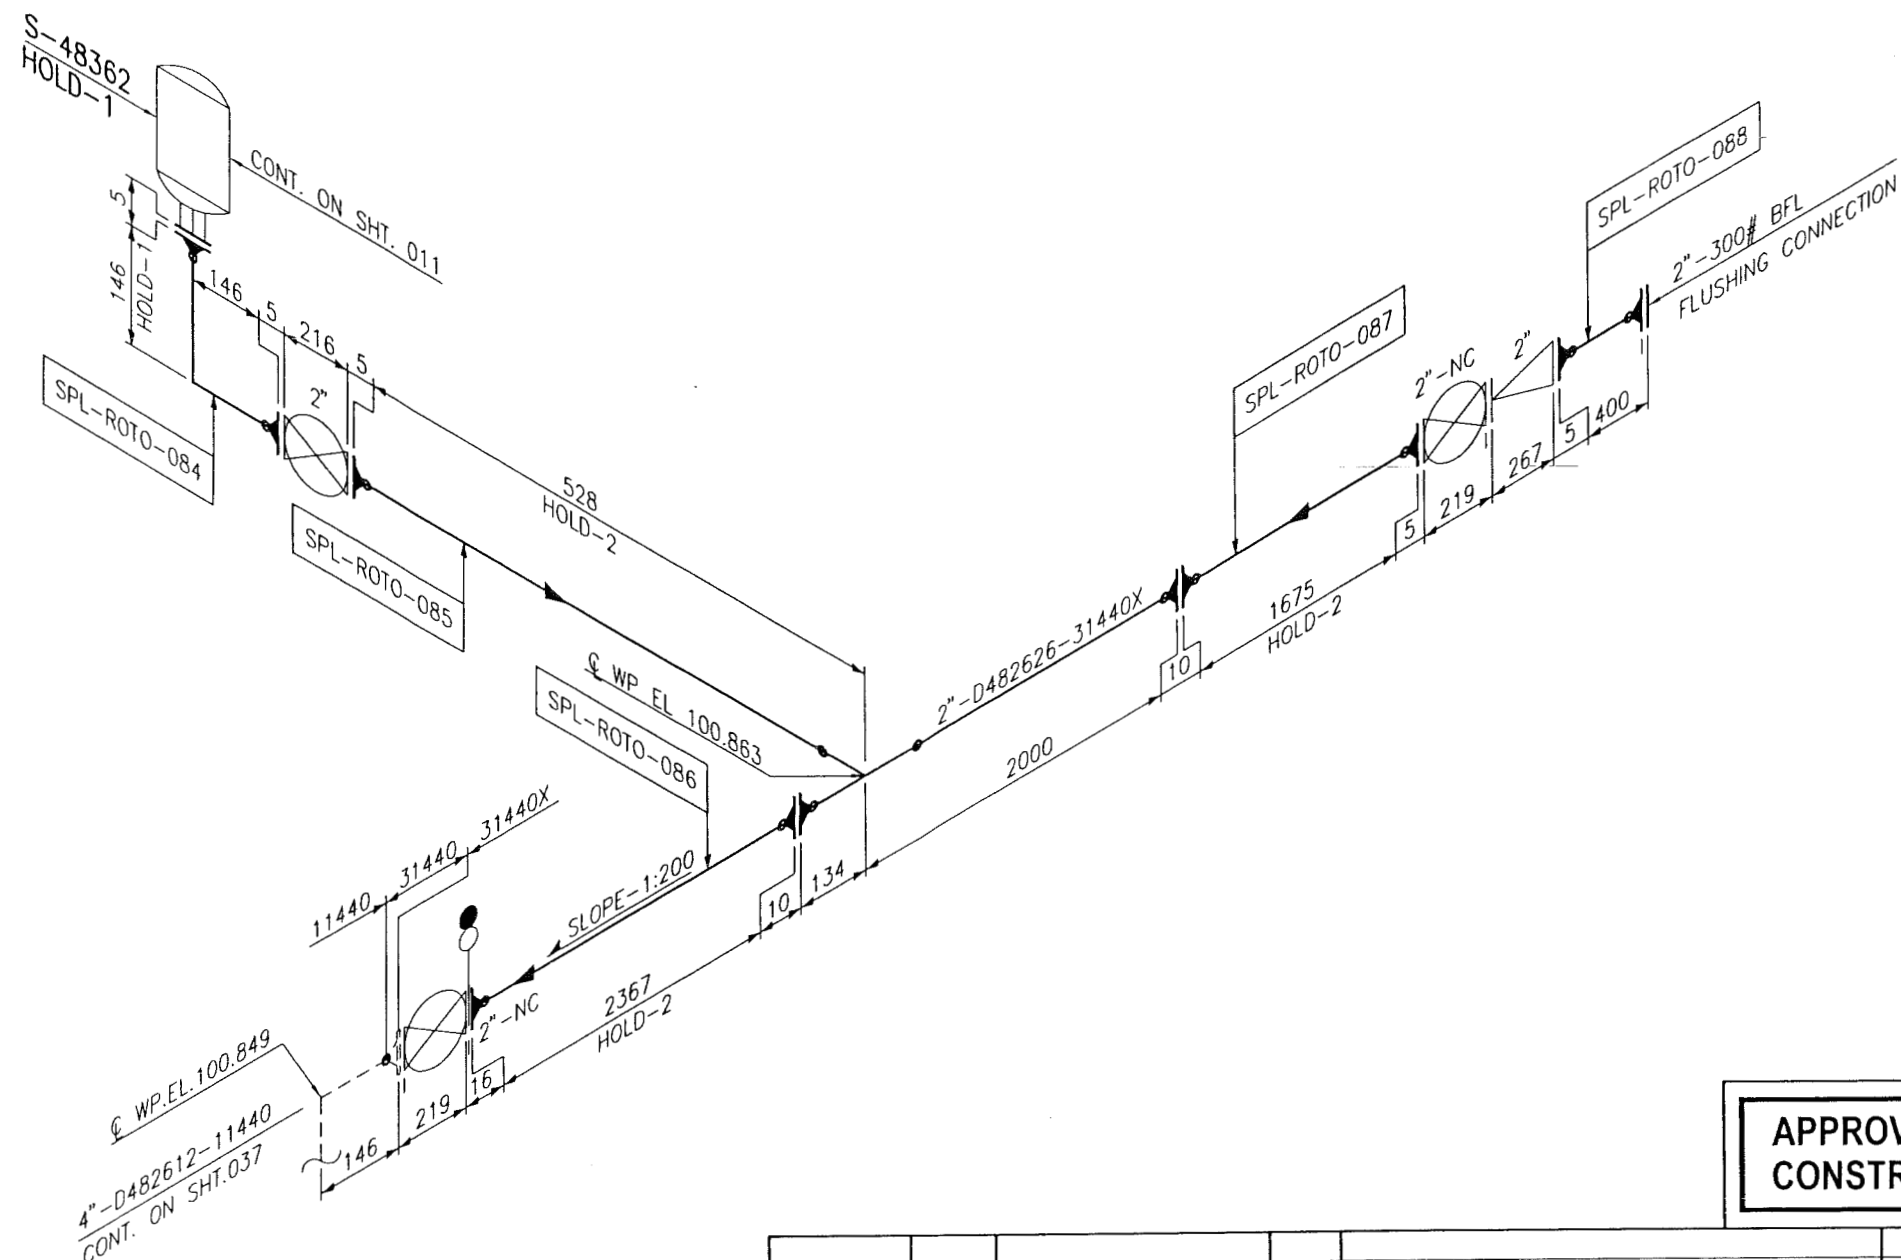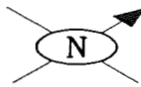

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CONSTRUCTION**

HOLD-1) S-48362 VENDOR INFORMATION
2) RETAINER RING/ROTO LINING THICKNES.

- 4) 31440X INDICATE PE/ROTO PIPING LINED AND VALVES
WITH BODY & TRIM OF 25%CR SDSS
3) DIMENSION TO BE CHECKED & CONFIRMED AT SITE PRIOR TO FABRICATION.
2) FOR PE/ROTO LINING DETAILS REFER SHEET NO.008
1) FOR GENERAL NOTES REFER SHEET No. 009
NOTES:

**DO NOT MAKE ANY MODIFICATION WITHOUT
CONFIRMATION FROM DESIGN DEPT.
AS THIS IS STRESS CRITICAL LINE**

STRESS RELIEVED NO
NDT REQUIREMENT RT10 % RANDOM
INSULATION NIL THK.
PAINTING PCS 1 OF SP1246

MADE BY : MD DATE : APR.'11 CHKD BY : APPRD BY : TITLE : PIPING ISOMETRIC
NIMR SLUDGE PITS SYSTEM UPGRADE-FED AND DD

DESIGN PRESSURE 4782 kPag PIPING CLASS 31440X LINE No. D482626
DESIGN TEMP. 5 TO 82 °C
HYDRO TEST PRESS. 7173 kPag

W.B.S. No. IN.09.011 REV. 0
PIPING ARRGT. DRWG. NIM-3-2140-001-DQ DATE APR.'11
SIGN. NO

شركة تنمية نفط عُمان
Petroleum Development Oman



ورلي بارسونز - الصناعات العربية (محاصة)
WorleyParsons-Arabian Industries (JV)

CONTRACT NO.: C31/0606 PROJ. NO.: PAIP00405

MTO DWG. No. :

NIM 3 2144 539 DQ 4

PLANT NORTH

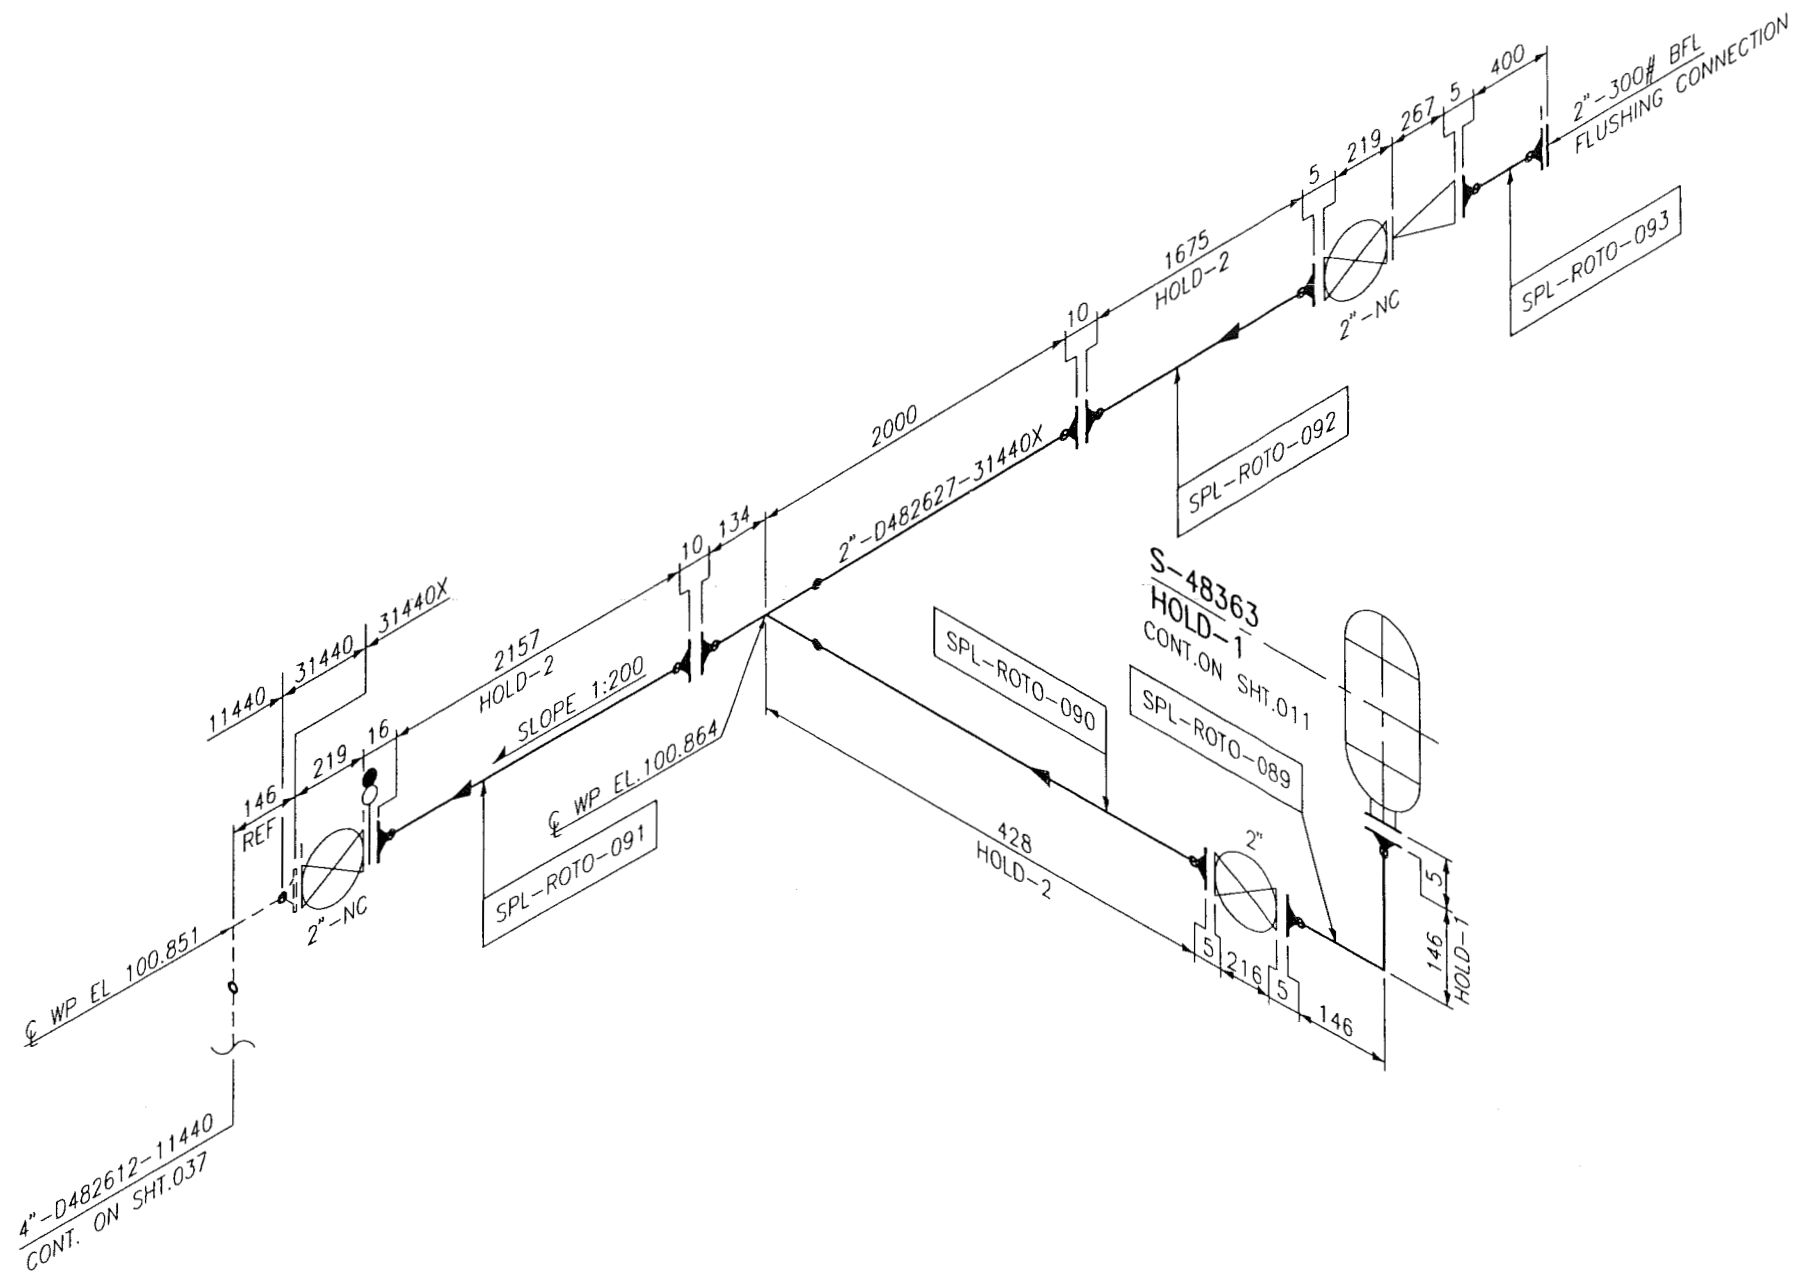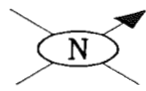

**APPROVED FOR
CONSTRUCTION**

HOLD-1) S-48363 VENDOR INFORMATION
2) RETAINER RING/ROTO LINING THICKNESS.

- 4) 31440X INDICATE PE/ROTO PIPING LINED AND VALVES
WITH BODY & TRIM OF 25%CR SDSS
- 3) DIMENSION TO BE CHECKED & CONFIRMED AT SITE PRIOR TO FABRICATION.
- 2) FOR PE/ROTO LINING DETAILS REFER SHEET NO.008
- 1) FOR GENERAL NOTES REFER SHEET No. 009
- NOTES:



ورلي بارسونز - الصناعات العربية (محصاة)
WorleyParsons-Arabian Industries (JV)

CONTRACT NO.: C31/0606 PROJ. NO.: PAIP00405

MTO DWG. No.:

**DO NOT MAKE ANY MODIFICATION WITHOUT
CONFIRMATION FROM DESIGN DEPT.
AS THIS IS STRESS CRITICAL LINE**

STRESS RELIEVED NO
NDT REQUIREMENT RT10 % RANDOM
INSULATION NIL THK.
PAINTING PCS 1 OF SP1245

NIM 3 2144 540 DQ 4




Items not covered by material take-off sheets	Quantity	Requisition No.	Item	Description	Tag No.
MADE BY : MD	DATE : APR.'11	CHKD BY : [Signature]	APPRD BY : [Signature]	TITLE : PIPING ISOMETRIC NIMR SLUDGE PITS SYSTEM UPGRADE-FED AND DD	
DESIGN PRESSURE 4782 kPag	DESIGN TEMP. 5 TO 82 °C	HYDRO TEST PRESS. 7173 kPag	W.B.S. No. IN.09.011	PIPING CLASS 31440X	LINE No. D482627
PIPING ARRGT. DRWG. NIM-3-2140-001-DQ				REV. 0	DATE APR.'11
SIGN. [Signature]				NO NIM 3 2144 040 DQ 3 0	



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Petroleum Development Oman

DWG.	AREA CODE	ENG SECT	SERIAL NUMBER	SHEET	PROJ CODE	DWG SIZE	REV
NIM	3	2144	040	DQ	3	0	


PLANT NORTH

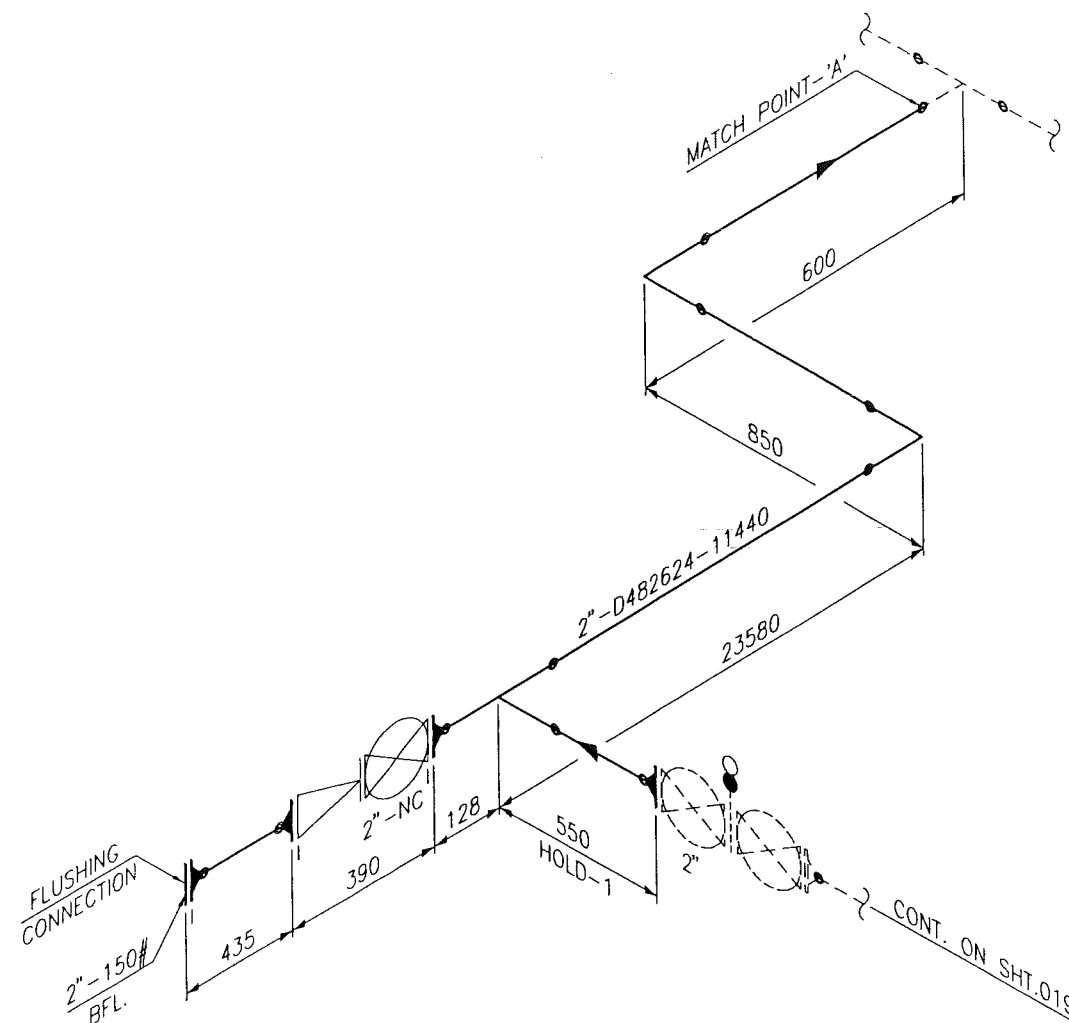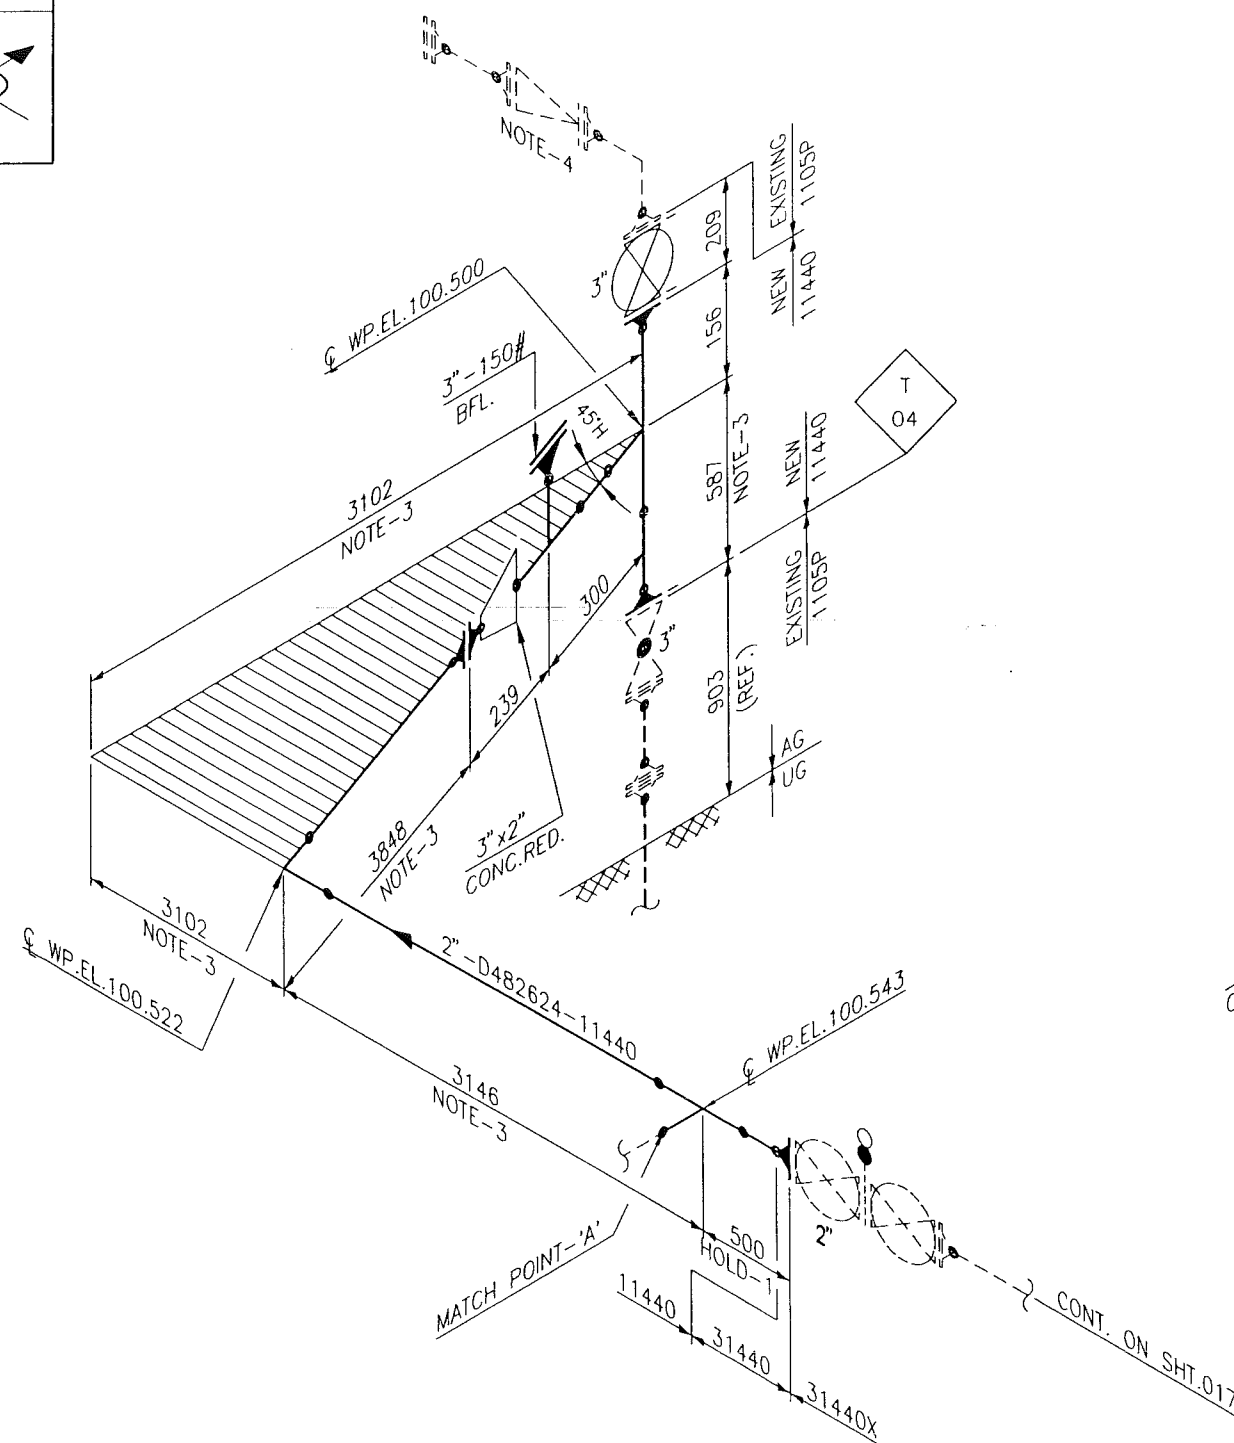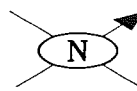

**APPROVED FOR
CONSTRUCTION**

HOLD:-1) RETAINER RING/ROTO LINING THICKNESS.

- 4) EXISTING SPOOL WITH CHECK VALVE TO BE RE-USED.
 3) DIMENSION TO BE CHECKED & CONFIRMED AT SITE PRIOR TO FABRICATION.
 2) FOR PE LINING DETAILS REFER SHEET NO.008
 1) FOR GENERAL NOTES REFER SHEET No. 009

NOTES:
 ورلي بارسونز - الصناعات العربية (محصاة)
 WorleyParsons-Arabian Industries (JV)


CONTRACT NO.: C31/0606 PROJ. NO.: PAIP00405

MTO DWG. No. :



**DO NOT MAKE ANY MODIFICATION WITHOUT
CONFIRMATION FROM DESIGN DEPT.
AS THIS IS STRESS CRITICAL LINE**

STRESS RELIEVED	NO
NDT REQUIREMENT	R10 % RANDOM
INSULATION	NIL THK.
PAINTING	PCS 1 OF SP1246
NIM 3 2144 541 DQ 4	

MADE BY : MD	DATE : APR.'11	CHKD BY : 	APPRD BY : 	TITLE : PIPING ISOMETRIC NIMR SLUDGE PITS SYSTEM UPGRADE-FED AND DD			
DESIGN PRESSURE	1820	kPag	PIPING CLASS	11440	LINE No.	D482624	
DESIGN TEMP.	5 TO 82	°C	HYDRO TEST PRESS.	2730	kPag		
W.B.S. No.	IN.09.011		REV.	0			
PIPING ARRGT. DRWG. NIM-3-5085-001-DQ NIM-3-5391-001-DQ				DATE	APR'11		
				SIGN.			
DWG.	AREA CODE	ENG SECT	SERIAL NUMBER	SHEET	PROJ CODE	DWG SIZE	REV
NO	NIM	3	2144	041	DQ	3	0

 **شركة تنمية نفط عُمان**
 Petroleum Development Oman

PLANT NORTH
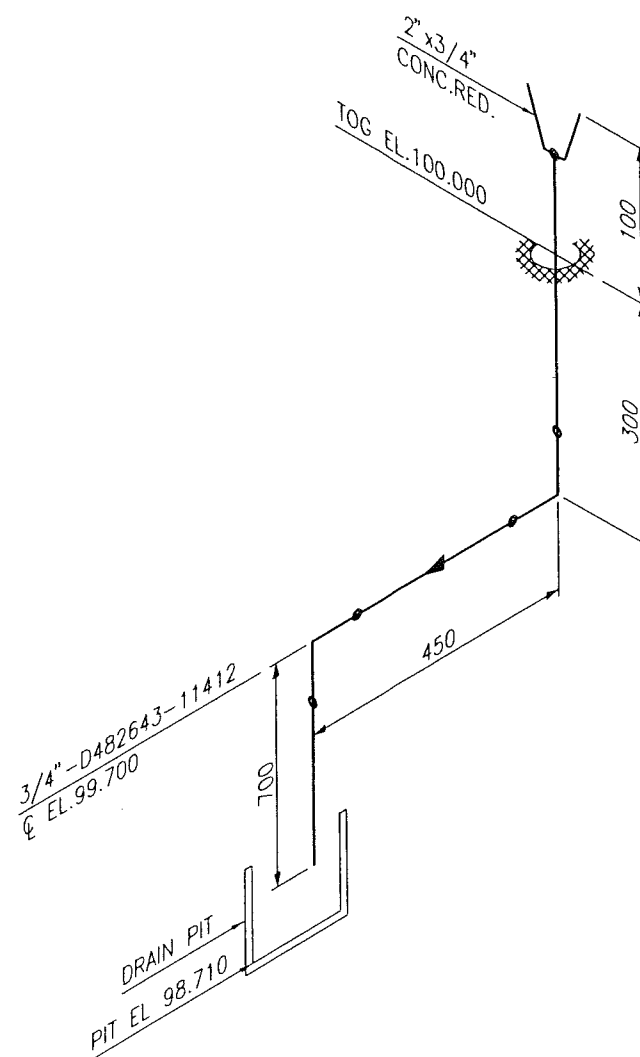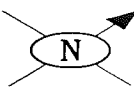
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3) DIMENSION TO BE CHECKED & CONFIRMED AT SITE PRIOR TO FABRICATION.

2) FOR PE LINING DETAILS REFER SHEET NO.008

1) FOR GENERAL NOTES REFER SHEET No. 009

NOTES:

ورلي بارسونز - الصناعات العربية (محصاة)
WorleyParsons-Arabian Industries (JV)

CONTRACT NO.: C31/0606

PROJ. NO.: PAIP00405

MTO DWG. No.:

DO NOT MAKE ANY MODIFICATION WITHOUT
CONFIRMATION FROM DESIGN DEPT.
AS THIS IS STRESS CRITICAL LINE

STRESS RELIEVED	NO
NDT REQUIREMENT	RT10 % RANDOM
INSULATION	N/A THK.
PAINTING	PCS SP 01 OF 1246
NIM 3 2144 543 DQ 4	

Items not covered by material take-off sheets	Quantity	Requisition No.	Item	Description	Tag No.
MADE BY :	DATE :	CHKD BY :	APPRD BY :	TITLE :	
MIS	APR.'11			PIPING ISOMETRIC NIMR SLUDGE PITS SYSTEM UPGRADE-FED AND DD	
DESIGN PRESSURE	1820	kPag	PIPING CLASS	LINE No.	
DESIGN TEMP.	5 TO 82	°C	11412	D482643	
HYDRO TEST PRESS.	2730	kPag			
W.B.S. No.	NIM.IN.09.011			REV.	0
PIPING ARRGT. DRWG.	NIM-3-5085-001-DQ			DATE	APR.'11
				SIGN.	
DWG.	AREA CODE	ENG SECT	SERIAL NUMBER	SHEET	PROJ CODE
NO	NIM	3	2144	043	DQ
				3	0



Isowise Material Take Off

Job Title : Nmr Sludge Pits System upgrade - FED & DD

Discipline : Mechanical & Piping

Area : NIMR

Line Number : P481329

Job No. : PAIP00405

Station :

Isometric Dwg No. : NIM-3-2144-011-DQ-3

Proj. Code : DQ

Isowise MTO No. : NIM-3-2144-511-DQ-4

WBS No : NIM.IN.09.011

MTO Rev. No. : O

MATERIAL FOR FABRICATION

Sr. No.	Quantity	MESC Number	Class	Size 1	Size 2	Description	Material	Sch./WT	Rating	Tag No.
1	23.5	74.30.03.211.1	31440X	150		Pipe	ASTM A106-B	S 40		
2	7	76.30.42.665.1	31440X	150		Elbow 90 Deg Bw	ASTM A234-WPB	S 40		
3	3	76.30.81.665.1	31440X	150		Equal Tee Bw	ASTM A234-WPB	S 40		
4	8	76.79.01.064.1	31440X	150	50	Branch Outlet Bw	ASTM A105	S 40 x S 80		
5	29	76.62.78.566.1	31440X	150		Weld Neck Rf Flange	ASTM A105	S 40	300#	
6	8	76.62.78.610.1	31440X	50		Weld Neck Rf Flange	ASTM A105	S 80	300#	

MATERIAL FOR ERECTION

Sr. No.	Quantity	MESC Number	Class	Size 1	Size 2	Description	Material	Sch./WT	Rating	Tag No.
7	1	76.62.20.320.1	31440X	50		Lap Joint Flange	ASTM A105		300#	
8	4	76.88.37.056.1	31440X	150		Spectacle Blind	ASTM A516-60/65/70		300#	
9	1	76.83.38.562.1	31440X	50	255	Thermowell	ASTM B564 UNS N04400		150# / 2500#	
10	4	85.41.36.374.1	31440X	150		Gasket Spiral Wound	AISI 316, graphite filled CS centring-/SS inner ring		300#	
11	8	85.41.36.414.1	31440X	50		Gasket Spiral Wound	AISI 316, graphite filled CS centring-/SS inner ring		300#	
12	5	NON MESC	31440X	150		Ball Valve 14313 FB Flgd	Body: ASTM A182 F55 UNS N32760/A995 Grade 6A Trim: SDSS, PTFE		300#	
13	1	BY INST	300#	150		Flow Meter			300#	
14	2	NON MESC	31440X	50		Chemical Injection Quill	Body: ASTM A182 F55 UNS N32760/A995 Grade 6A Trim: SDSS, PTFE		300#	CHEMICAL INJ.
15	2	NON MESC	31440X	150		Basket Strainer	Body: ASTM A105/A216-WCB/WCC Internal glass flake coating Trim: 25% Cr Duplex		300#	
16	16	81.38.66.273.1	31440X	.625	100	Stud Bolt With Nuts - Flange	ASTM A193-B7M/A194-2HM			
17	216	81.38.66.337.1	31440X	.75	150	Stud Bolt With Nuts - Flange	ASTM A193-B7M/A194-2HM			
18	48	81.38.66.340.1	31440X	.75	170	Stud Bolt With Nuts - SP/SB	ASTM A193-B7M/A194-2HM			
19	48	81.38.66.278.1	31440X	.625	130	Stud Bolt With Nuts - Temp Inst	ASTM A193-B7M/A194-2HM			
20	5	NON MESC	31440X	50	50	Modular Constr. SBBV	Body: ASTM A182 F55 UNS N32760/A995 Grade 6A Trim: SDSS, PTFE		300#	

Prepared by

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Notes :

1. UOM of Sizes are in mm except Stud Bolts (Size 1 in inch & Size 2 in mm).
2. PIPE Quantities are in meters & all other Items are in Numbers.

APPROVED FOR CONSTRUCTION



Isowise Material Take Off

Job Title : Nimir Sludge Pits System upgrade - FED & DD

Discipline : Mechanical & Piping

Area : NIMR

Line Number : P481329

Job No. : PAIP00405

Station :

Isometric Dwg No. : NIM-3-2144-012-DQ-3

Proj. Code : DQ

Isowise MTO No. : NIM-3-2144-512-DQ-4

WBS No : NIM.IN.09.011

MTO Rev. No. : 0

MATERIAL FOR FABRICATION

Sr. No.	Quantity	MESC Number	Class	Size 1	Size 2	Description	Material	Sch./WT	Rating	Tag No.
1	1.5	74.30.03.071.1	31440X	50		Pipe	ASTM A106-B	S 80		
2	64.5	74.30.03.211.1	31440X	150		Pipe	ASTM A106-B	S 40		
3	8	76.30.42.572.1	31440X	15		Elbow 90 Deg Bw	ASTM A234-WPB	S 160		
4	1	76.30.42.608.1	31440X	50		Elbow 90 Deg Bw	ASTM A234-WPB	S 80		
5	5	76.30.42.665.1	31440X	150		Elbow 90 Deg Bw	ASTM A234-WPB	S 40		
6	4	76.79.01.064.1	31440X	150	50	Branch Outlet Bw	ASTM A105	S 40 x S 80		
7	4	76.80.37.121.1	31440X	600	15	Branch Fitting Flgd	ASTM A105	S 160	300#	
8	30	76.62.78.566.1	31440X	150		Weld Neck Rf Flange	ASTM A105	S 40	300#	
9	8	76.62.78.610.1	31440X	50		Weld Neck Rf Flange	ASTM A105	S 80	300#	
10	4	76.62.78.652.1	31440X	15		Weld Neck Rf Flange	ASTM A105	S 160	300#	

MATERIAL FOR ERECTION

Sr. No.	Quantity	MESC Number	Class	Size 1	Size 2	Description	Material	Sch./WT	Rating	Tag No.
11	2	76.62.11.120.1	31440X	50		Blind Flange	ASTM A105		300#	
12	8	85.41.36.404.1	31440X	15		Gasket Spiral Wound	AISI 316, graphite filled CS centring-/SS inner ring		300#	
13	3	85.41.36.414.1	31440X	50		Gasket Spiral Wound	AISI 316, graphite filled CS centring-/SS inner ring		300#	
14	2	NON MESC	31440X	50		Ball Valve 14313 RB Flgd	Body: ASTM A182 F55 UNS N32760/A995 Grade 6A Trim: SDSS, PTFE		300#	
15	1	NON MESC	31440X	150		Ball Valve 14313 RB Flgd	Body: ASTM A182 F55 UNS N32760/A995 Grade 6A Trim: SDSS, PTFE		300#	
16	4	77.30.05.353.1	31440X	15		Globe Valve Flgd	Body: ASTM A182 F55 UNS N32760/A995 Grade 6A Trim: SDSS, PTFE		300#	
17	1	NON MESC	31440X	50		Check Valve Flgd	Body: ASTM A182 F55 UNS N32760/A995 Grade 6A Trim: SDSS, PTFE		300#	
18	1	NON MESC	31440X	150		Check Valve Flgd	Body: ASTM A182 F55 UNS N32760/A995 Grade 6A Trim: SDSS, PTFE		300#	
19	32	81.38.66.155.1	31440X	.5	70	Stud Bolt With Nuts - Flange	ASTM A193-B7M/A194-2HM			
20	204	81.38.66.337.1	31440X	.75	150	Stud Bolt With Nuts - Flange	ASTM A193-B7M/A194-2HM			
21	72	81.38.66.274.1	31440X	.625	110	Stud Bolt With Nuts - SP/SB	ASTM A193-B7M/A194-2HM			
22	12	81.38.66.340.1	31440X	.75	170	Stud Bolt With Nuts - SP/SB	ASTM A193-B7M/A194-2HM			
23	1	NON MESC	31440X	50	50	Modular Constr. SBBV	Body: ASTM A182 F55 UNS N32760/A995 Grade 6A Trim: SDSS, PTFE		300#	

Prepared by #

Checked by

Approved by

Notes :

1. UOM of Sizes are in mm except Stud Bolts (Size 1 in inch & Size 2 in mm).
2. PIPE Quantities are in meters & all other Items are in Numbers.

APPROVED FOR CONSTRUCTION



Isowise Material Take Off

Job Title : Nimr Sludge Pits System upgrade - FED & DD

Discipline : Mechanical & Piping

Area : NIMR

Line Number : P481330

Job No. : PAIP00405

Station :

Isometric Dwg No. : NIM-3-2144-013-DQ-3

Proj. Code : DQ

Isowise MTO No. : NIM-3-2144-513-DQ-4

WBS No : NIM.IN.09.011

MTO Rev. No. : 0

MATERIAL FOR FABRICATION

Sr. No.	Quantity	MESC Number	Class	Size 1	Size 2	Description	Material	Sch./WT	Rating	Tag No.
1	8.5	74.30.03.211.1	31440X	150		Pipe	ASTM A106-B	S 40		
2	3	76.30.42.665.1	31440X	150		Elbow 90 Deg Bw	ASTM A234-WPB	S 40		
3	3	76.79.01.064.1	31440X	150	50	Branch Outlet Bw	ASTM A105	S 40 x S 80		
4	12	76.62.78.566.1	31440X	150		Weld Neck Rf Flange	ASTM A105	S 40	300#	
5	3	76.62.78.610.1	31440X	50		Weld Neck Rf Flange	ASTM A105	S 80	300#	

MATERIAL FOR ERECTION

Sr. No.	Quantity	MESC Number	Class	Size 1	Size 2	Description	Material	Sch./WT	Rating	Tag No.
6	1	76.62.11.120.1	31440X	50		Blind Flange	ASTM A105		300#	
7	1	76.88.37.056.1	31440X	150		Spectacle Blind	ASTM A516-60/65/70		300#	
8	2	85.41.36.414.1	31440X	50		Gasket Spiral Wound	AISI 316, graphite filled CS centring-/SS inner ring		300#	
9	1	NON MESC	31440X	50		Ball Valve 14313 RB Flgd	Body: ASTM A182 F55 UNS N32760/A995 Grade 6A Trim: SDSS, PTFE		300#	
10	1	NON MESC	31440X	150		Ball Valve 14313 FB Flgd	Body: ASTM A182 F55 UNS N32760/A995 Grade 6A Trim: SDSS, PTFE		300#	
11	1	NON MESC	31440X	150		Check Valve Flgd	Body: ASTM A182 F55 UNS N32760/A995 Grade 6A Trim: SDSS, PTFE		300#	
12	32	81.38.66.273.1	31440X	.625	100	Stud Bolt With Nuts - Flange	ASTM A193-B7M/A194-2HM			
13	96	81.38.66.337.1	31440X	.75	150	Stud Bolt With Nuts - Flange	ASTM A193-B7M/A194-2HM			
14	12	81.38.66.340.1	31440X	.75	170	Stud Bolt With Nuts - SP/SB	ASTM A193-B7M/A194-2HM			
15	1	NON MESC	31440X	50	50	Modular Constr. SBBV	Body: ASTM A182 F55 UNS N32760/A995 Grade 6A Trim: SDSS, PTFE		300#	

Prepared by

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Notes :

1. UOM of Sizes are in mm except Stud Bolts (Size 1 in inch & Size 2 in mm).
2. PIPE Quantities are in meters & all other Items are in Numbers.

APPROVED FOR CONSTRUCTION



Isowise Material Take Off

Job Title : Nimir Sludge Pits System upgrade - FED & DD

Discipline : Mechanical & Piping

Area : NIMR

Line Number : P481331

Job No. : PAIP00405

Station :

Isometric Dwg No. : NIM-3-2144-014-DQ-3

Proj. Code : DQ

Isowise MTO No. : NIM-3-2144-514-DQ-4

WBS No : NIM.IN.09.011


MTO Rev. No. : O


MATERIAL FOR FABRICATION

Sr. No.	Quantity	MESC Number	Class	Size 1	Size 2	Description	Material	Sch./WT	Rating	Tag No.
1	.5	74.36.33.057.1	33421	50		Pipe	ASTM A312-TP316L	S10S		
2	2	76.65.79.410.1	33421	50		Weld Neck Rf Flange	ASTM A182-F316	S10S	300#	

MATERIAL FOR ERECTION

Sr. No.	Quantity	MESC Number	Class	Size 1	Size 2	Description	Material	Sch./WT	Rating	Tag No.
3	1	85.41.36.414.1	33421	50		Gasket Spiral Wound	AISI 316, graphite filled CS centring-/SS inner ring		300#	
4	8	81.38.66.278.1	33421	.625	130	Stud Bolt With Nuts - Meter Run	ASTM A193-B7M/A194-2HM			

Prepared by 

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Notes :

1. UOM of Sizes are in mm except Stud Bolts (Size 1 in inch & Size 2 in mm).
2. PIPE Quantities are in meters & all other Items are in Numbers.

APPROVED FOR CONSTRUCTION



Isowise Material Take Off

Job Title : Nimir Sludge Pits System upgrade - FED & DD

Discipline : Mechanical & Piping

Area : NIMR

Line Number : P481331

Job No. : PAIP00405

Station :

Isometric Dwg No. : NIM-3-2144-015-DQ-3

Proj. Code : DQ

Isowise MTO No. : NIM-3-2144-515-DQ-4

WBS No : NIM.IN.09.011

MTO Rev. No. : 0

MATERIAL FOR FABRICATION

Sr. No.	Quantity	MESC Number	Class	Size 1	Size 2	Description	Material	Sch./WT	Rating	Tag No.
1	.5	74.36.33.057.1	33421	50		Pipe	ASTM A312-TP316L	S10S		
2	2	76.65.79.410.1	33421	50		Weld Neck Rf Flange	ASTM A182-F316	S10S	300#	

MATERIAL FOR ERECTION

Sr. No.	Quantity	MESC Number	Class	Size 1	Size 2	Description	Material	Sch./WT	Rating	Tag No.
3	1	85.41.36.414.1	33421	50		Gasket Spiral Wound	AISI 316, graphite filled CS centring-/SS inner ring		300#	
4	8	81.38.66.278.1	33421	.625	130	Stud Bolt With Nuts - Meter Run	ASTM A193-B7M/A194-2HM			

Prepared by

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Approved by

Notes :

1. UOM of Sizes are in mm except Stud Bolts (Size 1 in inch & Size 2 in mm).
2. PIPE Quantities are in meters & all other Items are in Numbers.

APPROVED FOR CONSTRUCTION



Isowise Material Take Off

Job Title : Nimir Sludge Pits System upgrade - FED & DD

Discipline : Mechanical & Piping

Area : NIMR

Line Number : P481335

Job No. : PAIP00405

Station :

Isometric Dwg No. : NIM-3-2144-017-DQ-3

Proj. Code : DQ

Isowise MTO No. : NIM-3-2144-517-DQ-4

WBS No : NIM.IN.09.011

MTO Rev. No. : O

MATERIAL FOR FABRICATION

Sr. No.	Quantity	MESC Number	Class	Size 1	Size 2	Description	Material	Sch./WT	Rating	Tag No.
1	.5	74.30.03.071.1	31440X	50		Pipe	ASTM A106-B	S 80		
2	1	74.30.03.149.1	31440X	100		Pipe	ASTM A106-B	S 40		
3	42.5	74.30.03.211.1	31440X	150		Pipe	ASTM A106-B	S 40		
4	1	76.30.34.665.1	31440X	150		Elbow 45 Deg Bw	ASTM A234-WPB	S 40		
5	4	76.30.42.572.1	31440X	15		Elbow 90 Deg Bw	ASTM A234-WPB	S 160		
6	3	76.30.42.608.1	31440X	50		Elbow 90 Deg Bw	ASTM A234-WPB	S 80		
7	1	76.30.42.645.1	31440X	100		Elbow 90 Deg Bw	ASTM A234-WPB	S 40		
8	4	76.30.42.665.1	31440X	150		Elbow 90 Deg Bw	ASTM A234-WPB	S 40		
9	1	76.30.66.305.1	31440X	150	100	Reducer Conc.Bw	ASTM A234-WPB	S 40 x S 40		
10	4	76.79.01.064.1	31440X	150	50	Branch Outlet Bw	ASTM A105	S 40 x S 80		
11	2	76.80.37.121.1	31440X	600	15	Branch Fitting Flgd	ASTM A105	S 160	300#	
12	1	76.62.78.314.1	11440	100		Weld Neck Rf Flange	ASTM A105	S40	150#	
13	23	76.62.78.566.1	31440X	150		Weld Neck Rf Flange	ASTM A105	S 40	300#	
14	9	76.62.78.610.1	31440X	50		Weld Neck Rf Flange	ASTM A105	S 80	300#	
15	2	76.62.78.652.1	31440X	15		Weld Neck Rf Flange	ASTM A105	S 160	300#	

MATERIAL FOR ERECTION

Sr. No.	Quantity	MESC Number	Class	Size 1	Size 2	Description	Material	Sch./WT	Rating	Tag No.
16	1	76.88.37.050.1	31440X	50		Spectacle Blind	ASTM A516-60/65/70		300#	
17	1	76.88.37.056.1	31440X	150		Spectacle Blind	ASTM A516-60/65/70		300#	
18	1	85.41.36.374.1	31440X	150		Gasket Spiral Wound	AISI 316, graphite filled CS centring-/SS inner ring		300#	
19	4	85.41.36.404.1	31440X	15		Gasket Spiral Wound	AISI 316, graphite filled CS centring-/SS inner ring		300#	
20	2	85.41.36.414.1	31440X	50		Gasket Spiral Wound	AISI 316, graphite filled CS centring-/SS inner ring		300#	
21	5	NON MESC	31440X	50		Ball Valve 14313 RB Flgd	Body: ASTM A182 F55 UNS N32760/A995 Grade 6A Trim: SDSS, PTFE		300#	
22	1	NON MESC	31440X	150		Ball Valve 14313 FB Flgd	Body: ASTM A182 F55 UNS N32760/A995 Grade 6A Trim: SDSS, PTFE		300#	
23	2	77.30.05.353.1	31440X	15		Globe Valve Flgd	Body: ASTM A182 F55 UNS N32760/A995 Grade 6A Trim: SDSS, PTFE		300#	
24	16	81.38.66.155.1	31440X	.5	70	Stud Bolt With Nuts - Flange	ASTM A193-B7M/A194-2HM			
25	96	81.38.66.273.1	31440X	.625	100	Stud Bolt With Nuts - Flange	ASTM A193-B7M/A194-2HM			
26	144	81.38.66.337.1	31440X	.75	150	Stud Bolt With Nuts - Flange	ASTM A193-B7M/A194-2HM			
27	8	81.38.66.274.1	31440X	.625	110	Stud Bolt With Nuts - SP/SB	ASTM A193-B7M/A194-2HM			
28	12	81.38.66.340.1	31440X	.75	170	Stud Bolt With Nuts - SP/SB	ASTM A193-B7M/A194-2HM			



Isowise Material Take Off

Job Title : Nimr Sludge Pits System upgrade - FED & DD

Discipline : Mechanical & Piping

Area : NIMR

Line Number : P481335

Job No. : PAIP00405

Station :

Isometric Dwg No. : NIM-3-2144-017-DQ-3


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
Isowise MTO No. : NIM-3-2144-517-DQ-4

WBS No : NIM.IN.09.011

MTO Rev. No. : O

Prepared by 

Checked by 


Approved by

Notes :

1. UOM of Sizes are in mm except Stud Bolts (Size 1 in inch & Size 2 in mm).
2. PIPE Quantities are in meters & all other Items are in Numbers.

APPROVED FOR CONSTRUCTION



Isowise Material Take Off

Job Title : Nimr Sludge Pits System upgrade - FED & DD

Discipline : Mechanical & Piping

Area : NIMR

Line Number : P481335

Job No. : PAIP00405

Station :

Isometric Dwg No. : NIM-3-2144-018-DQ-3

Proj. Code : DQ

Isowise MTO No. : NIM-3-2144-518-DQ-4

WBS No : NIM.IN.09.011

MTO Rev. No. : O

MATERIAL FOR FABRICATION

Sr. No.	Quantity	MESC Number	Class	Size 1	Size 2	Description	Material	Sch./WT	Rating	Tag No.
1	3.5	74.30.03.020.1	31440X	15		Pipe	ASTM A106-B	S 160		
2	28.5	74.30.03.211.1	31440X	150		Pipe	ASTM A106-B	S 40		
3	8	74.30.05.373.1	11412	350		Pipe	ASTM A106-B	S20		
4	4	76.30.42.572.1	31440X	15		Elbow 90 Deg Bw	ASTM A234-WPB	S 160		
5	3	76.30.42.665.1	31440X	150		Elbow 90 Deg Bw	ASTM A234-WPB	S 40		
6	1	76.30.81.665.1	31440X	150		Equal Tee Bw	ASTM A234-WPB	S 40		
7	3	76.79.01.064.1	31440X	150	50	Branch Outlet Bw	ASTM A105	S 40 x S 80		
8	2	76.80.37.121.1	31440X	600	15	Branch Fitting Flgd	ASTM A105	S 160	300#	
9	9	76.62.78.566.1	31440X	150		Weld Neck Rf Flange	ASTM A105	S 40	300#	
10	2	76.62.78.610.1	31440X	50		Weld Neck Rf Flange	ASTM A105	S 80	300#	
11	6	76.62.78.652.1	31440X	15		Weld Neck Rf Flange	ASTM A105	S 160	300#	

MATERIAL FOR ERECTION

Sr. No.	Quantity	MESC Number	Class	Size 1	Size 2	Description	Material	Sch./WT	Rating	Tag No.
12	1	76.88.37.050.1	31440X	50		Spectacle Blind	ASTM A516-60/65/70		300#	
13	6	85.41.36.404.1	31440X	15		Gasket Spiral Wound	AISI 316, graphite filled CS centring-/SS inner ring		300#	
14	3	85.41.36.414.1	31440X	50		Gasket Spiral Wound	AISI 316, graphite filled CS centring-/SS inner ring		300#	
15	2	77.30.05.353.1	31440X	15		Globe Valve Flgd	Body: ASTM A182 F55 UNS N32760/A995 Grade 6A Trim: SDSS, PTFE		300#	
16	1	BY INST	300#	150		Emergency Shut Down Valve			300#	48-UZV-2660
17	24	81.38.66.155.1	31440	.5	70	Stud Bolt With Nuts - Flange	ASTM A193-B7M/A194-2HM			
18	8	81.38.66.273.1	31440X	.625	100	Stud Bolt With Nuts - Flange	ASTM A193-B7M/A194-2HM			
19	60	81.38.66.337.1	31440X	.75	150	Stud Bolt With Nuts - Flange	ASTM A193-B7M/A194-2HM			
20	16	81.38.66.274.1	31440X	.625	110	Stud Bolt With Nuts - SP/SB	ASTM A193-B7M/A194-2HM			
21	3	NON MESC	31440X	50	50	Modular Constr. SBBV	Body: ASTM A182 F55 UNS N32760/A995 Grade 6A Trim: SDSS, PTFE		300#	

Prepared by

Checked by

Approved by

Notes :

1. UOM of Sizes are in mm except Stud Bolts (Size 1 in inch & Size 2 in mm).
2. PIPE Quantities are in meters & all other Items are in Numbers.

APPROVED FOR CONSTRUCTION



Isowise Material Take Off

Job Title : Nimir Sludge Pits System upgrade - FED & DD

Discipline : Mechanical & Piping

Area : NIMR

Line Number : P481362

Job No. : PAIP00405

Station :

Isometric Dwg No. : NIM-3-2144-019-DQ-3

Proj. Code : DQ

Isowise MTO No. : NIM-3-2144-519-DQ-4

WBS No : NIM.IN.09.011

MTO Rev. No. : O

MATERIAL FOR FABRICATION

Sr. No.	Quantity	MESC Number	Class	Size 1	Size 2	Description	Material	Sch./WT	Rating	Tag No.
1	95	74.30.03.211.1	31440X	150		Pipe	ASTM A106-B	S 40		
2	8	74.30.05.373.1	11412	350		Pipe	ASTM A106-B	S20		
3	16	76.30.42.572.1	31440X	15		Elbow 90 Deg Bw	ASTM A234-WPB	S 160		
4	1	76.30.42.608.1	31440X	50		Elbow 90 Deg Bw	ASTM A234-WPB	S 80		
5	9	76.30.42.665.1	31440X	150		Elbow 90 Deg Bw	ASTM A234-WPB	S 40		
6	2	76.79.01.064.1	31440X	150	50	Branch Outlet Bw	ASTM A105	S 40 x S 80		
7	8	76.80.37.121.1	31440X	600	15	Branch Fitting Flgd	ASTM A105	S 160	300#	
8	28	76.62.78.566.1	31440X	150		Weld Neck Rf Flange	ASTM A105	S 40	300#	
9	8	76.62.78.610.1	31440X	50		Weld Neck Rf Flange	ASTM A105	S 80	300#	
10	12	76.62.78.652.1	31440X	15		Weld Neck Rf Flange	ASTM A105	S 160	300#	

MATERIAL FOR ERECTION

Sr. No.	Quantity	MESC Number	Class	Size 1	Size 2	Description	Material	Sch./WT	Rating	Tag No.
11	1	76.62.11.120.1	31440X	50		Blind Flange	ASTM A105		300#	
12	1	76.88.37.050.1	31440X	50		Spectacle Blind	ASTM A516-60/65/70		300#	
13	1	76.88.37.056.1	31440X	150		Spectacle Blind	ASTM A516-60/65/70		300#	
14	1	85.41.36.374.1	31440X	150		Gasket Spiral Wound	AISI 316, graphite filled CS centring-/SS inner ring		300#	
15	18	85.41.36.404.1	31440X	15		Gasket Spiral Wound	AISI 316, graphite filled CS centring-/SS inner ring		300#	
16	4	85.41.36.414.1	31440X	50		Gasket Spiral Wound	AISI 316, graphite filled CS centring-/SS inner ring		300#	
17	3	NON MESC	31440X	50		Ball Valve 14313 RB Flgd	Body: ASTM A182 F55 UNS N32760/A995 Grade 6A Trim: SDSS, PTFE		300#	
18	1	NON MESC	31440X	150		Ball Valve 14313 FB Flgd	Body: ASTM A182 F55 UNS N32760/A995 Grade 6A Trim: SDSS, PTFE		300#	
19	1	NON MESC	31440X	50		Check Valve Flgd	Body: ASTM A182 F55 UNS N32760/A995 Grade 6A Trim: SDSS, PTFE		300#	
20	64	81.38.66.155.1	31440X	.5	70	Stud Bolt With Nuts - Flange	ASTM A193-B7M/A194-2HM			
21	64	81.38.66.273.1	31440X	.625	100	Stud Bolt With Nuts - Flange	ASTM A193-B7M/A194-2HM			
22	168	81.38.66.337.1	31440X	.75	150	Stud Bolt With Nuts - Flange	ASTM A193-B7M/A194-2HM			
23	8	81.38.66.274.1	31440X	.625	110	Stud Bolt With Nuts - SP/SB	ASTM A193-B7M/A194-2HM			
24	12	81.38.66.340.1	31440X	.75	170	Stud Bolt With Nuts - SP/SB	ASTM A193-B7M/A194-2HM			

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Notes :

1. UOM of Sizes are in mm except Stud Bolts (Size 1 in inch & Size 2 in mm).
2. PIPE Quantities are in meters & all other Items are in Numbers.

APPROVED FOR CONSTRUCTION



Isowise Material Take Off

Job Title : Nimr Sludge Pits System upgrade - FED & DD

Discipline : Mechanical & Piping

Area : NIMR

Line Number : P481362

Job No. : PAIP00405

Station :

Isometric Dwg No. : NIM-3-2144-020-DQ-3

Proj. Code : DQ

Isowise MTO No. : NIM-3-2144-520-DQ-4

WBS No : NIM.IN.09.011

MTO Rev. No. : O

MATERIAL FOR FABRICATION

Sr. No.	Quantity	MESC Number	Class	Size 1	Size 2	Description	Material	Sch./WT	Rating	Tag No.
1	2	74.30.03.071.1	31440X	50		Pipe	ASTM A106-B	S 80		
2	36	74.30.03.211.1	31440X	150		Pipe	ASTM A106-B	S 40		
3	4	76.30.34.665.1	31440X	150		Elbow 45 Deg Bw	ASTM A234-WPB	S 40		
4	4	76.30.42.572.1	31440X	15		Elbow 90 Deg Bw	ASTM A234-WPB	S 160		
5	2	76.30.42.608.1	31440X	50		Elbow 90 Deg Bw	ASTM A234-WPB	S 80		
6	2	76.30.42.665.1	31440X	150		Elbow 90 Deg Bw	ASTM A234-WPB	S 40		
7	1	76.30.88.189.1	31440X	150	100	Tee Reducing Bw	ASTM A234-WPB	S 40 x S 40		
8	5	76.79.01.064.1	31440X	150	50	Branch Outlet Bw	ASTM A105	S 40 x S 80		
9	2	76.80.37.121.1	31440X	600	15	Branch Fitting Flgd	ASTM A105	S 160	300#	
10	1	76.62.78.564.1	31440X	100		Weld Neck Rf Flange	ASTM A105	S 40	300#	
11	22	76.62.78.566.1	31440X	150		Weld Neck Rf Flange	ASTM A105	S 40	300#	
12	11	76.62.78.610.1	31440X	50		Weld Neck Rf Flange	ASTM A105	S 80	300#	
13	2	76.62.78.652.1	31440X	15		Weld Neck Rf Flange	ASTM A105	S 160	300#	

MATERIAL FOR ERECTION

Sr. No.	Quantity	MESC Number	Class	Size 1	Size 2	Description	Material	Sch./WT	Rating	Tag No.
14	4	76.62.11.120.1	31440X	50		Blind Flange	ASTM A105		300#	
15	1	76.62.11.126.1	31440X	150		Blind Flange	ASTM A105		300#	
16	1	76.88.37.056.1	31440X	150		Spectacle Blind	ASTM A516-60/65/70		300#	
17	4	85.41.36.404.1	31440X	15		Gasket Spiral Wound	AISI 316, graphite filled CS centring-/SS inner ring		300#	
18	6	85.41.36.414.1	31440X	50		Gasket Spiral Wound	AISI 316, graphite filled CS centring-/SS inner ring		300#	
19	4	NON MESC	31440X	50		Ball Valve 14313 RB Flgd	Body: ASTM A182 F55 UNS N32760/A995 Grade 6A Trim: SDSS, PTFE		300#	
20	2	77.30.05.353.1	31440X	15		Globe Valve Flgd	Body: ASTM A182 F55 UNS N32760/A995 Grade 6A Trim: SDSS, PTFE		300#	
21	1	NON MESC	31440X	50		Check Valve Flgd	Body: ASTM A182 F55 UNS N32760/A995 Grade 6A Trim: SDSS, PTFE		300#	
22	1	NON MESC	31440X	150		Check Valve Flgd	Body: ASTM A182 F55 UNS N32760/A995 Grade 6A Trim: SDSS, PTFE		300#	
23	16	81.38.66.155.1	31440X	.5	70	Stud Bolt With Nuts - Flange	ASTM A193-B7M/A194-2HM			
24	104	81.38.66.273.1	31440X	.625	100	Stud Bolt With Nuts - Flange	ASTM A193-B7M/A194-2HM			
25	144	81.38.66.337.1	31440X	.75	150	Stud Bolt With Nuts - Flange	ASTM A193-B7M/A194-2HM			
26	12	81.38.66.340.1	31440X	.75	170	Stud Bolt With Nuts - SP/SB	ASTM A193-B7M/A194-2HM			
27	1	NON MESC	31440X	50	50	Modular Constr. SBBV	Body: ASTM A182 F55 UNS N32760/A995 Grade 6A Trim: SDSS, PTFE		300#	



Isowise Material Take Off

Job Title : Nimr Sludge Pits System upgrade - FED & DD

Discipline : Mechanical & Piping

Area : NIMR

Line Number : P481362

Job No. : PAIP00405

Station :

Isometric Dwg No. : NIM-3-2144-020-DQ-3

Proj. Code : DQ

Isowise MTO No. : NIM-3-2144-520-DQ-4

WBS No : NIM.IN.09.011

MTO Rev. No. : O

Prepared by

Checked by

Approved by

Notes :

1. UOM of Sizes are in mm except Stud Bolts (Size 1 in inch & Size 2 in mm).
2. PIPE Quantities are in meters & all other Items are in Numbers.

APPROVED FOR CONSTRUCTION



Isowise Material Take Off

Job Title : Nimir Sludge Pits System upgrade - FED & DD

Discipline : Mechanical & Piping

Area : NIMR

Line Number : P481334

Job No. : PAIP00405

Station :

Isometric Dwg No. : NIM-3-2144-023-DQ-3

Proj. Code : DQ

Isowise MTO No. : NIM-3-2144-523-DQ-4

WBS No : NIM.IN.09.011

MTO Rev. No. : 0

MATERIAL FOR FABRICATION

Sr. No.	Quantity	MESC Number	Class	Size 1	Size 2	Description	Material	Sch./WT	Rating	Tag No.
1	9	74.30.03.071.1	11440	50		Pipe	ASTM A106-B	S80		
2	2	76.30.42.608.1	11440	50		Elbow 90 Deg Bw	ASTM A234-WPB	S80		
3	4	76.62.78.360.1	11440	50		Weld Neck Rf Flange	ASTM A105	S80	150#	

MATERIAL FOR ERECTION

Sr. No.	Quantity	MESC Number	Class	Size 1	Size 2	Description	Material	Sch./WT	Rating	Tag No.
4	2	76.62.11.070.1	11440	50		Blind Flange	ASTM A105		150#	
5	2	76.88.37.020.1	11440	250		Spectacle Blind	ASTM A516-60/65/70		150#	
6	2	85.41.36.314.1	11440	50		Gasket Spiral Wound	AISI 316, graphite filled CS centring-/SS inner ring		150#	
7	2	85.41.36.328.1	11440	250		Gasket Spiral Wound	AISI 316, graphite filled CS centring-/SS inner ring		150#	
8	2	85.46.03.066.1	11440	50		Insulating Gasket	GRE G10 - Mylar	S80	150#	
9	2	NON MESC	11440X	50		Ball Valve RB Flgd.	Body: ASTM A182 F55 UNS N32760/A995 Grade 6A Trim: SDSS, PTFE		150#	
10	1	NON MESC	11440X	250		Ball Valve 14313 FB Flgd	Body: ASTM A105/A216 WCB/WCC WITH ALLOY 625 CLAD Trim: SDSS, PTFE		150#	
11	8	81.38.66.271.1	11440	.625	90	Stud Bolt With Nuts - Flange	ASTM A193-B7M/A194-2HM			
12	8	81.38.66.273.1	11440	.625	100	Stud Bolt With Nuts - SP/SB	ASTM A193-B7M/A194-2HM			

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Notes :

1. UOM of Sizes are in mm except Stud Bolts (Size 1 in inch & Size 2 in mm).
2. PIPE Quantities are in meters & all other Items are in Numbers.

APPROVED FOR CONSTRUCTION



Isowise Material Take Off

Job Title : Nimir Sludge Pits System upgrade - FED & DD

Discipline : Mechanical & Piping

Area : NIMR

Line Number : P481357

Job No. : PAIP00405

Station :

Isometric Dwg No. : NIM-3-2144-024-DQ-3

Proj. Code : DQ

Isowise MTO No. : NIM-3-2144-524-DQ-4

WBS No : NIM.IN.09.011

MTO Rev. No. : O

MATERIAL FOR FABRICATION

Sr. No.	Quantity	MESC Number	Class	Size 1	Size 2	Description	Material	Sch./WT	Rating	Tag No.
1	.5	74.30.03.020.1	31440	15		Pipe	ASTM A106-B	S160		
2	1.5	74.30.03.071.1	31440	50		Pipe	ASTM A106-B	S80		
3	1	76.30.42.572.1	31440	15		Elbow 90 Deg Bw	ASTM A234-WPB	S160		
4	2	76.30.42.608.1	31440	50		Elbow 90 Deg Bw	ASTM A234-WPB	S80		
5	2	76.30.81.608.1	31440	50		Equal Tee Bw	ASTM A234-WPB	S80		
6	1	76.30.67.141.1	31440	20	15	Reducer Ecc.Bw	ASTM A234-WPB	S160 × S160		
7	1	76.30.67.193.1	31440	50	20	Reducer Ecc.Bw	ASTM A234-WPB	S80 × S160		
8	3	76.62.78.610.1	31440	50		Weld Neck Rf Flange	ASTM A105	S80	300#	
9	2	76.62.78.652.1	31440	15		Weld Neck Rf Flange	ASTM A105	S160	300#	

MATERIAL FOR ERECTION

Sr. No.	Quantity	MESC Number	Class	Size 1	Size 2	Description	Material	Sch./WT	Rating	Tag No.
10	2	85.41.36.404.1	31440	15		Gasket Spiral Wound	AISI 316, graphite filled CS centring-/SS inner ring		300#	
11	1	77.30.05.353.1	31440	15		Globe Valve Flgd	Body: ASTM A105/A216-WCB/WCC Trim: AISI 316, Stellite 6		300#	
12	8	81.38.66.155.1	31440	.5	70	Stud Bolt With Nuts - Flange	ASTM A193-B7M/A194-2HM			

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Notes :

1. UOM of Sizes are in mm except Stud Bolts (Size 1 in inch & Size 2 in mm).
2. PIPE Quantities are in meters & all other Items are in Numbers.

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Isowise Material Take Off

Job Title : Nimr Sludge Pits System upgrade - FED & DD

Discipline : Mechanical & Piping

Area : NIMR

Line Number : D48183 / P48079

Job No. : PAIP00405

Station :

Isometric Dwg No. : NIM-3-2144-025-DQ-3

Proj. Code : DQ

Isowise MTO No. : NIM-3-2144-525-DQ-4

WBS No : NIM.IN.09.011


MTO Rev. No. : 0

MATERIAL FOR ERECTION

Sr. No.	Quantity	MESC Number	Class	Size 1	Size 2	Description	Material	Sch./WT	Rating	Tag No.
1	1	76.62.11.070.1	11440	50		Blind Flange	ASTM A105		150#	
2	1	76.62.11.074.1	11440	100		Blind Flange	ASTM A105		150#	
3	1	85.41.36.314.1	11440	50		Gasket Spiral Wound	AISI 316, graphite filled CS centring-/SS inner ring		150#	
4	1	85.41.36.320.1	11440	100		Gasket Spiral Wound	AISI 316, graphite filled CS centring-/SS inner ring		150#	
5	4	81.38.66.271.1	11440	.625	90	Stud Bolt With Nuts - Flange	ASTM A193-B7M/A194-2HM			
6	8	81.38.66.273.1	11440	.625	100	Stud Bolt With Nuts - Flange	ASTM A193-B7M/A194-2HM			

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Notes :

1. UOM of Sizes are in mm except Stud Bolts (Size 1 in inch & Size 2 in mm).
2. PIPE Quantities are in meters & all other Items are in Numbers.

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Isowise Material Take Off

Job Title : Nimir Sludge Pits System upgrade - FED & DD

Discipline : Mechanical & Piping

Area : NIMR

Line Number : P481329

Job No. : PAIP00405

Station :

Isometric Dwg No. : NIM-3-2144-027-DQ-3

Proj. Code : DQ

Isowise MTO No. : NIM-3-2144-527-DQ-4

WBS No : NIM.IN.09.011

MTO Rev. No. : O

MATERIAL FOR FABRICATION

Sr. No.	Quantity	MESC Number	Class	Size 1	Size 2	Description	Material	Sch./WT	Rating	Tag No.
1	.5	74.36.33.026.1	33411	20		Pipe	ASTM A312-TP316L	S40S		
2	1	76.33.85.618.1	33411	20	15	Tee Reducing Bw	ASTM A403-WP316L	S40S× S40S		
3	1	76.65.80.402.1	33411	15		Weld Neck Rf Flange	ASTM A182-F316	S40S	300#	
4	2	76.65.80.404.1	33411	20		Weld Neck Rf Flange	ASTM A182-F316	S40S	300#	

MATERIAL FOR ERECTION

Sr. No.	Quantity	MESC Number	Class	Size 1	Size 2	Description	Material	Sch./WT	Rating	Tag No.
5	1	76.65.10.412.1	33411	15		Blind Flange	ASTM A182-F316		300#	
6	1	76.65.10.414.1	33411	20		Blind Flange	ASTM A182-F316		300#	
7	2	85.41.36.404.1	33411	15		Gasket Spiral Wound	AISI 316, graphite filled CS centring-/SS inner ring		300#	
8	4	85.41.36.406.1	33411	20		Gasket Spiral Wound	AISI 316, graphite filled CS centring-/SS inner ring		300#	
9	1	77.23.03.353.1	33411	15		Gate Valve Flgd	Body: ASTM A182-F316/A351-CF8M Trim: AISI 316, Stellite 6		300#	
10	1	77.23.03.354.1	33411	20		Gate Valve Flgd	Body: ASTM A182-F316/A351-CF8M Trim: AISI 316, Stellite 6		300#	
11	1	77.13.19.354.1	33411	20		Check Valve Flgd	Body: ASTM A182-F316/A351-CF8M Trim: AISI 316, Stellite 6		300#	
12	8	81.38.61.155.1	33411	.5	70	Stud Bolt With Nuts - Flange	ASTM A193-B7/A194-2H			
13	16	81.38.61.269.1	33411	.625	80	Stud Bolt With Nuts - Flange	ASTM A193-B7/A194-2H			

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Notes :

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2. PIPE Quantities are in meters & all other Items are in Numbers.

APPROVED FOR CONSTRUCTION



Isowise Material Take Off

Job Title : Nimr Sludge Pits System upgrade - FED & DD

Discipline : Mechanical & Piping

Area : NIMR

Line Number : B481024

Job No. : PAIP00405

Station :

Isometric Dwg No. : NIM-3-2144-028-DQ-3

Proj. Code : DQ

Isowise MTO No. : NIM-3-2144-528-DQ-4

WBS No : NIM.IN.09.011

MTO Rev. No. : O

MATERIAL FOR FABRICATION

Sr. No.	Quantity	MESC Number	Class	Size 1	Size 2	Description	Material	Sch. WT	Rating	Tag No.
1	3	74.30.03.109.1	11440	80		Pipe	ASTM A106-B	S80		
2	2	76.30.42.628.1	11440	80		Elbow 90 Deg Bw	ASTM A234-WPB	S80		
3	1	76.62.78.362.1	11440	80		Weld Neck Rf Flange	ASTM A105	S80	150#	

MATERIAL FOR ERECTION

Sr. No.	Quantity	MESC Number	Class	Size 1	Size 2	Description	Material	Sch. WT	Rating	Tag No.
4	1	85.46.03.082.1	11440	80		Insulating Gasket	GRE G10 - Mylar	S80	150#	
5	4	81.38.66.273.1	11440	.625	100	Stud Bolt With Nuts - Flange	ASTM A193-B7M/A194-2HM			

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Notes :

1. UOM of Sizes are in mm except Stud Bolts (Size 1 in inch & Size 2 in mm).
2. PIPE Quantities are in meters & all other Items are in Numbers.

APPROVED FOR CONSTRUCTION



Isowise Material Take Off

Job Title : Nimr Sludge Pits System upgrade - FED & DD

Discipline : Mechanical & Piping

Area : NIMR

Line Number : B481025

Job No. : PAIP00405

Station :

Isometric Dwg No. : NIM-3-2144-029-DQ-3

Proj. Code : DQ

Isowise MTO No. : NIM-3-2144-529-DQ-4

WBS No : NIM.IN.09.011

MTO Rev. No. : O

MATERIAL FOR FABRICATION

Sr. No.	Quantity	MESC Number	Class	Size 1	Size 2	Description	Material	Sch./WT	Rating	Tag No.
1	3	74.30.03.109.1	11440	80		Pipe	ASTM A106-B	S80		
2	2	76.30.42.628.1	11440	80		Elbow 90 Deg Bw	ASTM A234-WPB	S80		
3	1	76.62.78.362.1	11440	80		Weld Neck Rf Flange	ASTM A105	S80	150#	

MATERIAL FOR ERECTION

Sr. No.	Quantity	MESC Number	Class	Size 1	Size 2	Description	Material	Sch./WT	Rating	Tag No.
4	1	85.46.03.082.1	11440	80		Insulating Gasket	GRE G10 - Mylar	S80	150#	
5	4	81.38.66.273.1	11440	.625	100	Stud Bolt With Nuts - Flange	ASTM A193-B7M/A194-2HM			

Prepared by

Checked by

Approved by

Notes :

1. UOM of Sizes are in mm except Stud Bolts (Size 1 in inch & Size 2 in mm).
2. PIPE Quantities are in meters & all other Items are in Numbers.

APPROVED FOR CONSTRUCTION



Isowise Material Take Off

Job Title : Nimr Sludge Pits System upgrade - FED & DD

Discipline : Mechanical & Piping

Area : NIMR

Line Number : B481031

Job No. : PAIP00405

Station :

Isometric Dwg No. : NIM-3-2144-030-DQ-3

Proj. Code : DQ

Isowise MTO No. : NIM-3-2144-530-DQ-4

WBS No : NIM.IN.09.011


MTO Rev. No. : O


MATERIAL FOR FABRICATION

Sr. No.	Quantity	MESC Number	Class	Size 1	Size 2	Description	Material	Sch./WT	Rating	Tag No.
1	6.5	74.30.03.071.1	31440X	50		Pipe	ASTM A106-B	S 80		
2	1	76.30.34.608.1	31440X	50		Elbow 45 Deg Bw	ASTM A234-WPB	S 80		
3	3	76.30.42.608.1	31440X	50		Elbow 90 Deg Bw	ASTM A234-WPB	S 80		
4	1	76.30.81.608.1	31440X	50		Equal Tee Bw	ASTM A234-WPB	S 80		
5	9	76.62.78.610.1	31440X	50		Weld Neck Rf Flange	ASTM A105	S 80	300#	

MATERIAL FOR ERECTION

Sr. No.	Quantity	MESC Number	Class	Size 1	Size 2	Description	Material	Sch./WT	Rating	Tag No.
6	1	76.62.11.120.1	31440X	50		Blind Flange	ASTM A105		300#	
7	1	76.88.37.050.1	31440X	50		Spectacle Blind	ASTM A516-60/65/70		300#	
8	1	85.41.36.414.1	31440X	50		Gasket Spiral Wound	AISI 316, graphite filled CS centring-/SS inner ring		300#	
9	2	NON MESC	31440X	50		Ball Valve 14313 RB Flgd	Body: ASTM A182 F55 UNS N32760/A995 Grade 6A Trim: SDSS, PTFE		300#	
10	56	81.38.66.273.1	31440X	.625	100	Stud Bolt With Nuts - Flange	ASTM A193-B7M/A194-2HM			
11	8	81.38.66.274.1	31440X	.625	110	Stud Bolt With Nuts - SP/SB	ASTM A193-B7M/A194-2HM			

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Notes :

1. UOM of Sizes are in mm except Stud Bolts (Size 1 in inch & Size 2 in mm).
2. PIPE Quantities are in meters & all other Items are in Numbers.

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Isowise Material Take Off

Job Title : Nimr Sludge Pits System upgrade - FED & DD

Discipline : Mechanical & Piping

Area : NIMR

Line Number : B481032

Job No. : PAIP00405

Station :

Isometric Dwg No. : NIM-3-2144-031-DQ-3

Proj. Code : DQ

Isowise MTO No. : NIM-3-2144-531-DQ-4

WBS No : NIM.IN.09.011

MTO Rev. No. : O

MATERIAL FOR FABRICATION

Sr. No.	Quantity	MESC Number	Class	Size 1	Size 2	Description	Material	Sch./WT	Rating	Tag No.
1	8	74.30.03.071.1	31440X	50		Pipe	ASTM A106-B	S 80		
2	3	76.30.42.608.1	31440X	50		Elbow 90 Deg Bw	ASTM A234-WPB	S 80		
3	1	76.30.81.608.1	31440X	50		Equal Tee Bw	ASTM A234-WPB	S 80		
4	8	76.62.78.610.1	31440X	50		Weld Neck Rf Flange	ASTM A105	S 80	300#	

MATERIAL FOR ERECTION

Sr. No.	Quantity	MESC Number	Class	Size 1	Size 2	Description	Material	Sch./WT	Rating	Tag No.
5	1	76.62.11.120.1	31440X	50		Blind Flange	ASTM A105		300#	
6	1	76.88.37.050.1	31440X	50		Spectacle Blind	ASTM A516-60/65/70		300#	
7	1	85.41.36.414.1	31440X	50		Gasket Spiral Wound	AISI 316, graphite filled CS centring-/SS inner ring		300#	
8	2	NON MESC	31440X	50		Ball Valve 14313 RB Flgd	Body: ASTM A182 F55 UNS N32760/A995 Grade 6A Trim: SDSS, PTFE		300#	
9	48	81.38.66.273.1	31440X	.625	100	Stud Bolt With Nuts - Flange	ASTM A193-B7M/A194-2HM			
10	8	81.38.66.274.1	31440X	.625	110	Stud Bolt With Nuts - SP/SB	ASTM A193-B7M/A194-2HM			

Prepared by

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Notes :

1. UOM of Sizes are in mm except Stud Bolts (Size 1 in inch & Size 2 in mm).
2. PIPE Quantities are in meters & all other Items are in Numbers.

APPROVED FOR CONSTRUCTION



Isowise Material Take Off

Job Title : Nimr Sludge Pits System upgrade - FED & DD

Discipline : Mechanical & Piping

Area : NIMR

Line Number : B481036

Job No. : PAIP00405

Station :

Isometric Dwg No. : NIM-3-2144-032-DQ-3

Proj. Code : DQ

Isowise MTO No. : NIM-3-2144-532-DQ-4

WBS No : NIM.IN.09.011

MTO Rev. No. : O

MATERIAL FOR FABRICATION

Sr. No.	Quantity	MESC Number	Class	Size 1	Size 2	Description	Material	Sch./WT	Rating	Tag No.
1	26.5	74.30.03.071.1	11440	50		Pipe	ASTM A106-B	S80		
2	5	76.30.42.608.1	11440	50		Elbow 90 Deg Bw	ASTM A234-WPB	S80		
3	3	76.30.81.608.1	11440	50		Equal Tee Bw	ASTM A234-WPB	S80		
4	3	76.62.78.360.1	11440	50		Weld Neck Rf Flange	ASTM A105	S80	150#	
5	2	76.62.78.610.1	31440	50		Weld Neck Rf Flange	ASTM A105	S80	300#	

MATERIAL FOR ERECTION

Sr. No.	Quantity	MESC Number	Class	Size 1	Size 2	Description	Material	Sch./WT	Rating	Tag No.
6	1	76.88.37.010.1	11440	50		Spectacle Blind	ASTM A516-60/65/70		150#	
7	3	85.41.36.314.1	11440	50		Gasket Spiral Wound	AISI 316, graphite filled CS centring-/SS inner ring		150#	
8	1	77.00.25.008.1	11440	50		Ball Valve RB Flgd.	Body: ASTM A105/A216-WCB/WCC Trim: AISI 316, PTFE		150#	
9	4	81.38.66.271.1	11440	.625	90	Stud Bolt With Nuts - Flange	ASTM A193-B7M/A194-2HM			
10	4	81.38.66.273.1	11440	.625	100	Stud Bolt With Nuts - SP/SB	ASTM A193-B7M/A194-2HM			

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Notes :

1. UOM of Sizes are in mm except Stud Bolts (Size 1 in inch & Size 2 in mm).
2. PIPE Quantities are in meters & all other Items are in Numbers.

APPROVED FOR CONSTRUCTION



Isowise Material Take Off

Job Title : Nimr Sludge Pits System upgrade - FED & DD

Discipline : Mechanical & Piping

Area : NIMR

Line Number : B481039

Job No. : PAIP00405

Station :

Isometric Dwg No. : NIM-3-2144-033-DQ-3

Proj. Code : DQ

Isowise MTO No. : NIM-3-2144-533-DQ-4

WBS No : NIM.IN.09.011

MTO Rev. No. : O

MATERIAL FOR FABRICATION

Sr. No.	Quantity	MESC Number	Class	Size 1	Size 2	Description	Material	Sch./WT	Rating	Tag No.
1	63.5	74.30.03.071.1	11440	50		Pipe	ASTM A106-B	S80		
2	5	76.30.42.608.1	11440	50		Elbow 90 Deg Bw	ASTM A234-WPB	S80		
3	2	76.62.78.360.1	11440	50		Weld Neck Rf Flange	ASTM A105	S80	150#	

MATERIAL FOR ERECTION

Sr. No.	Quantity	MESC Number	Class	Size 1	Size 2	Description	Material	Sch./WT	Rating	Tag No.
4	1	76.88.37.010.1	11440	50		Spectacle Blind	ASTM A516-60/65/70		150#	
5	3	85.41.36.314.1	11440	50		Gasket Spiral Wound	AISI 316, graphite filled CS centring-/SS inner ring		150#	
6	1	77.00.25.008.1	11440	50		Ball Valve RB Flgd.	Body: ASTM A105/A216- WCB/WCC Trim: AISI 316, PTFE		150#	
7	4	81.38.66.271.1	11440	.625	90	Stud Bolt With Nuts - Flange	ASTM A193-B7M/A194-2HM			
8	4	81.38.66.273.1	11440	.625	100	Stud Bolt With Nuts - SP/SB	ASTM A193-B7M/A194-2HM			

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Notes :

1. UOM of Sizes are in mm except Stud Bolts (Size 1 in inch & Size 2 in mm).
2. PIPE Quantities are in meters & all other Items are in Numbers.

APPROVED FOR CONSTRUCTION



Isowise Material Take Off

Job Title : Nimir Sludge Pits System upgrade - FED & DD

Discipline : Mechanical & Piping

Area : NIMR

Line Number : A48911

Job No. : PAIP00405

Station :

Isometric Dwg No. : NIM-3-2144-036-DQ-3

Proj. Code : DQ

Isowise MTO No. : NIM-3-2144-536-DQ-4

WBS No : NIM.IN.09.011


MTO Rev. No. : O


MATERIAL FOR FABRICATION

Sr. No.	Quantity	MESC Number	Class	Size 1	Size 2	Description	Material	Sch./WT	Rating	Tag No.
1	.5	74.13.08.018.1	18011	15		Pipe	API 5L-B (galvanised)	S80		
2	.5	74.13.08.028.1	18011	25		Pipe	API 5L-B (galvanised)	S80		
3	1	76.06.85.034.1	18011	25	15	Tee Reducing Thrd	ASTM A234-WPB (galvanised)	S80 × S80		
4	1	76.06.28.016.1	18011	25		Coupling Thrd	ASTM A234-WPB (galvanised)	S80		
5	1	76.06.66.008.1	18011	15		Plug Npt	ASTM A234-WPB (galvanised)	S80		
6	1	76.06.91.016.1	18011	25		Union Thrd	ASTM A234-WPB (galvanised)	S80		

MATERIAL FOR ERECTION

Sr. No.	Quantity	MESC Number	Class	Size 1	Size 2	Description	Material	Sch./WT	Rating	Tag No.
7	1	77.07.03.153.1	18011	15		Ball Valve Float RB Thrd.	ASTM B148-UNS C95400, TRIM: ALUMINIUM BRONZE, PTFE		800#	

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Notes :
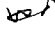
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2. PIPE Quantities are in meters & all other Items are in Numbers.

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Isowise Material Take Off

Job Title : Nimir Sludge Pits System upgrade - FED & DD

Discipline : Mechanical & Piping

Area : NIMR

Line Number : D482612

Job No. : PAIP00405

Station :

Isometric Dwg No. : NIM-3-2144-037-DQ-3

Proj. Code : DQ

Isowise MTO No. : NIM-3-2144-537-DQ-4

WBS No : NIM.IN.09.011

MTO Rev. No. : O

MATERIAL FOR FABRICATION

Sr. No.	Quantity	MESC Number	Class	Size 1	Size 2	Description	Material	Sch./WT	Rating	Tag No.
1	2.2	74.30.03.071.1	11440	50		Pipe	ASTM A106-B	S80		
2	26	74.30.03.149.1	11440	100		Pipe	ASTM A106-B	S40		
3	4	76.30.42.608.1	11440	50		Elbow 90 Deg Bw	ASTM A234-WPB	S80		
4	5	76.30.42.645.1	11440	100		Elbow 90 Deg Bw	ASTM A234-WPB	S40		
5	1	76.30.81.645.1	11440	100		Equal Tee Bw	ASTM A234-WPB	S40		
6	2	76.30.88.157.1	11440	100	50	Tee Reducing Bw	ASTM A234-WPB	S40 x S80		
7	4	76.62.78.314.1	11440	100		Weld Neck Rf Flange	ASTM A105	S40	150#	
8	2	76.62.78.360.1	11440	50		Weld Neck Rf Flange	ASTM A105	S80	150#	

MATERIAL FOR ERECTION

Sr. No.	Quantity	MESC Number	Class	Size 1	Size 2	Description	Material	Sch./WT	Rating	Tag No.
9	1	76.88.37.014.1	11440	100		Spectacle Blind	ASTM A516-60/65/70		150#	
10	4	85.41.36.320.1	11440	100		Gasket Spiral Wound	AISI 316, graphite filled CS centring-/SS inner ring		150#	
11	1	77.00.25.012.1	11440	100		Ball Valve RB Flgd.	Body: ASTM A105/A216-WCB/WCC Trim: AISI 316, PTFE		150#	
12	16	81.38.66.273.1	11440	.625	100	Stud Bolt With Nuts - Flange	ASTM A193-B7M/A194-2HM			
13	8	81.38.66.274.1	11440	.625	110	Stud Bolt With Nuts - SP/SB	ASTM A193-B7M/A194-2HM			

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Notes :

1. UOM of Sizes are in mm except Stud Bolts (Size 1 in inch & Size 2 in mm).
2. PIPE Quantities are in meters & all other Items are in Numbers.

APPROVED FOR CONSTRUCTION



Isowise Material Take Off

Job Title : Nimr Sludge Pits System upgrade - FED & DD

Discipline : Mechanical & Piping

Area : NIMR

Line Number : D482625

Job No. : PAIP00405

Station :

Isometric Dwg No. : NIM-3-2144-038-DQ-3

Proj. Code : DQ

Isowise MTO No. : NIM-3-2144-538-DQ-4

WBS No : NIM.IN.09.011

MTO Rev. No. : O

MATERIAL FOR FABRICATION

Sr. No.	Quantity	MESC Number	Class	Size 1	Size 2	Description	Material	Sch./WT	Rating	Tag No.
1	65.5	74.30.03.149.1	11440	100		Pipe	ASTM A106-B	S40		
2	6	76.30.42.645.1	11440	100		Elbow 90 Deg Bw	ASTM A234-WPB	S40		
3	2	76.62.78.314.1	11440	100		Weld Neck Rf Flange	ASTM A105	S40	150#	

MATERIAL FOR ERECTION

Sr. No.	Quantity	MESC Number	Class	Size 1	Size 2	Description	Material	Sch./WT	Rating	Tag No.
4	1	76.88.37.014.1	11440	100		Spectacle Blind	ASTM A516-60/65/70		150#	
5	3	85.41.36.320.1	11440	100		Gasket Spiral Wound	AISI 316, graphite filled CS centring-/SS inner ring		150#	
6	1	77.00.25.012.1	11440	100		Ball Valve RB Flgd.	Body: ASTM A105/A216-WCB/WCC Trim: AISI 316, PTFE		150#	
7	8	81.38.66.273.1	11440	.625	100	Stud Bolt With Nuts - Flange	ASTM A193-B7M/A194-2HM			
8	8	81.38.66.274.1	11440	.625	110	Stud Bolt With Nuts - SP/SB	ASTM A193-B7M/A194-2HM			

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Notes :

1. UOM of Sizes are in mm except Stud Bolts (Size 1 in inch & Size 2 in mm).
2. PIPE Quantities are in meters & all other Items are in Numbers.

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Isowise Material Take Off

Job Title : Nmr Sludge Pits System upgrade - FED & DD

Discipline : Mechanical & Piping

Area : NIMR

Line Number : D482626

Job No. : PAIP00405

Station :

Isometric Dwg No. : NIM-3-2144-039-DQ-3

Proj. Code : DQ

Isowise MTO No. : NIM-3-2144-539-DQ-4

WBS No : NIM.IN.09.011

MTO Rev. No. : O

MATERIAL FOR FABRICATION

Sr. No.	Quantity	MESC Number	Class	Size 1	Size 2	Description	Material	Sch./WT	Rating	Tag No.
1	7	74.30.03.071.1	31440X	50		Pipe	ASTM A106-B	S 80		
2	1	76.30.42.608.1	31440X	50		Elbow 90 Deg Bw	ASTM A234-WPB	S 80		
3	1	76.30.81.608.1	31440X	50		Equal Tee Bw	ASTM A234-WPB	S 80		
4	11	76.62.78.610.1	31440X	50		Weld Neck Rf Flange	ASTM A105	S 80	300#	

MATERIAL FOR ERECTION

Sr. No.	Quantity	MESC Number	Class	Size 1	Size 2	Description	Material	Sch./WT	Rating	Tag No.
5	1	76.62.11.120.1	31440X	50		Blind Flange	ASTM A105		300#	
6	1	76.88.37.050.1	31440X	50		Spectacle Blind	ASTM A516-60/65/70		300#	
7	3	85.41.36.414.1	31440X	50		Gasket Spiral Wound	AISI 316, graphite filled CS centring-/SS inner ring		300#	
8	3	NON MESC	31440X	50		Ball Valve 14313 RB Flgd	Body: ASTM A182 F55 UNS N32760/A995 Grade 6A Trim: SDSS, PTFE		300#	
9	1	NON MESC	31440X	50		Check Valve Flgd	Body: ASTM A182 F55 UNS N32760/A995 Grade 6A Trim: SDSS, PTFE		300#	
10	80	81.38.66.273.1	31440X	.625	100	Stud Bolt With Nuts - Flange	ASTM A193-B7M/A194-2HM			
11	8	81.38.66.274.1	31440X	.625	110	Stud Bolt With Nuts - SP/SB	ASTM A193-B7M/A194-2HM			

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Notes :

1. UOM of Sizes are in mm except Stud Bolts (Size 1 in inch & Size 2 in mm).
2. PIPE Quantities are in meters & all other Items are in Numbers.

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Isowise Material Take Off

Job Title : Nimir Sludge Pits System upgrade - FED & DD

Discipline : Mechanical & Piping

Area : NIMR

Line Number : D482627

Job No. : PAIP00405

Station :

Isometric Dwg No. : NIM-3-2144-040-DQ-3

Proj. Code : DQ

Isowise MTO No. : NIM-3-2144-540-DQ-4

WBS No : NIM.IN.09.011

MTO Rev. No. : O

MATERIAL FOR FABRICATION

Sr. No.	Quantity	MESC Number	Class	Size 1	Size 2	Description	Material	Sch./WT	Rating	Tag No.
1	8.5	74.30.03.071.1	31440X	50		Pipe	ASTM A106-B	S 80		
2	1	76.30.42.608.1	31440X	50		Elbow 90 Deg Bw	ASTM A234-WPB	S 80		
3	1	76.30.81.608.1	31440X	50		Equal Tee Bw	ASTM A234-WPB	S 80		
4	11	76.62.78.610.1	31440X	50		Weld Neck Rf Flange	ASTM A105	S 80	300#	

MATERIAL FOR ERECTION

Sr. No.	Quantity	MESC Number	Class	Size 1	Size 2	Description	Material	Sch./WT	Rating	Tag No.
5	1	76.62.11.120.1	31440X	50		Blind Flange	ASTM A105		300#	
6	1	76.88.37.050.1	31440X	50		Spectacle Blind	ASTM A516-60/65/70		300#	
7	3	85.41.36.414.1	31440X	50		Gasket Spiral Wound	AISI 316, graphite filled CS centring-/SS inner ring		300#	
8	3	NON MESC	31440X	50		Ball Valve 14313 RB Flgd	Body: ASTM A182 F55 UNS N32760/A995 Grade 6A Trim: SDSS, PTFE		300#	
9	1	NON MESC	31440X	50		Check Valve Flgd	Body: ASTM A182 F55 UNS N32760/A995 Grade 6A Trim: SDSS, PTFE		300#	
10	80	81.38.66.273.1	31440X	.625	100	Stud Bolt With Nuts - Flange	ASTM A193-B7M/A194-2HM			
11	8	81.38.66.274.1	31440X	.625	110	Stud Bolt With Nuts - SP/SB	ASTM A193-B7M/A194-2HM			

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Notes :

1. UOM of Sizes are in mm except Stud Bolts (Size 1 in inch & Size 2 in mm).
2. PIPE Quantities are in meters & all other Items are in Numbers.

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Isowise Material Take Off

Job Title : Nimr Sludge Pits System upgrade - FED & DD

Discipline : Mechanical & Piping

Area : NIMR

Line Number : D482624

Job No. : PAIP00405

Station :

Isometric Dwg No. : NIM-3-2144-041-DQ-3

Proj. Code : DQ

Isowise MTO No. : NIM-3-2144-541-DQ-4

WBS No : NIM.IN.09.011

MTO Rev. No. : 0

MATERIAL FOR FABRICATION

Sr. No.	Quantity	MESC Number	Class	Size 1	Size 2	Description	Material	Sch./WT	Rating	Tag No.
1	32	74.30.03.071.1	11440	50		Pipe	ASTM A106-B	S80		
2	1	74.30.03.109.1	11440	80		Pipe	ASTM A106-B	S80		
3	1	76.30.34.608.1	11440	50		Elbow 45 Deg Bw	ASTM A234-WPB	S80		
4	2	76.30.42.608.1	11440	50		Elbow 90 Deg Bw	ASTM A234-WPB	S80		
5	1	76.30.81.608.1	11440	50		Equal Tee Bw	ASTM A234-WPB	S80		
6	2	76.30.81.628.1	11440	80		Equal Tee Bw	ASTM A234-WPB	S80		
7	1	76.30.66.237.1	11440	80	50	Reducer Conc.Bw	ASTM A234-WPB	S80 x S80		
8	6	76.62.78.360.1	11440	50		Weld Neck Rf Flange	ASTM A105	S80	150#	
9	3	76.62.78.362.1	11440	80		Weld Neck Rf Flange	ASTM A105	S80	150#	
10	1	76.62.78.610.1	31440	50		Weld Neck Rf Flange	ASTM A105	S80	300#	

MATERIAL FOR ERECTION

Sr. No.	Quantity	MESC Number	Class	Size 1	Size 2	Description	Material	Sch./WT	Rating	Tag No.
11	1	76.62.11.070.1	11440	50		Blind Flange	ASTM A105		150#	
12	1	76.62.11.072.1	11440	80		Blind Flange	ASTM A105		150#	
13	5	85.41.36.314.1	11440	50		Gasket Spiral Wound	AISI 316, graphite filled CS centring-/SS inner ring		150#	
14	4	85.41.36.318.1	11440	80		Gasket Spiral Wound	AISI 316, graphite filled CS centring-/SS inner ring		150#	
15	1	77.00.25.008.1	11440	50		Ball Valve RB Flgd.	Body: ASTM A105/A216-WCB/WCC Trim: AISI 316, PTFE		150#	
16	1	77.00.25.010.1	11440	80		Ball Valve RB Flgd.	Body: ASTM A105/A216-WCB/WCC Trim: AISI 316, PTFE		150#	
17	1	77.10.05.008.1	11440	50		Check Valve Flgd	Body: ASTM A105/A216-WCB/WCC Trim: AISI 316, Stellite 6		150#	
18	20	81.38.66.271.1	11440	.625	90	Stud Bolt With Nuts - Flange	ASTM A193-B7M/A194-2HM			
19	16	81.38.66.273.1	11440	.625	100	Stud Bolt With Nuts - Flange	ASTM A193-B7M/A194-2HM			

Prepared by

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Notes :

1. UOM of Sizes are in mm except Stud Bolts (Size 1 in inch & Size 2 in mm).
2. PIPE Quantities are in meters & all other Items are in Numbers.

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Isowise Material Take Off

Job Title : Nimr Sludge Pits System upgrade - FED & DD

Discipline : Mechanical & Piping

Area : NIMR

Line Number : D482643

Job No. : PAIP00405

Station :

Isometric Dwg No. : NIM-3-2144-043-DQ-3

Proj. Code : DQ

Isowise MTO No. : NIM-3-2144-543-DQ-4

WBS No : NIM.IN.09.011

MTO Rev. No. : O

MATERIAL FOR FABRICATION

Sr. No.	Quantity	MESC Number	Class	Size 1	Size 2	Description	Material	Sch./WT	Rating	Tag No.
1	1.5	74.30.05.028.1	11412	20		Pipe	ASTM A106-B	S80		
2	2	76.30.40.574.1	11412	20		Elbow 90 Deg Bw	ASTM A234-WPB	S80		
3	1	76.29.46.192.1	11412	50	20	Reducer Conc.Bw	ASTM A234-WPB	S40 x S80		

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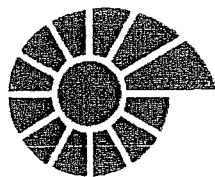
Notes :

1. UOM of Sizes are in mm except Stud Bolts (Size 1 in inch & Size 2 in mm).
2. PIPE Quantities are in meters & all other Items are in Numbers.

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Electrical Scope of Work

PAIP00405- Nimr Sludge Pit Up gradation.



PETROLEUM DEVELOPMENT OMAN

Specification for 415V Junction Boxes For Nimr Sludge pit system upgrade -FED / DD

Project No PAIP00405





WBS NO.C.OM. NIM. IN. 09.011
Contract No.: C 31/0606

AVME Code : 4.16.6
Criticality rating: 4

By



WorleyParsons – Arabian Industries (JV)

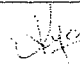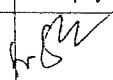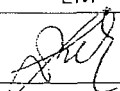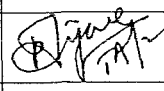Rev. No.	Date	Description	Prepared by	Checked by	Approved by	
					WPAI	PDO
O	Sep 2010	Issued for Comment	KD	PVT	LM	OSE/29N
A	May 2011	Issued for Enquiry	KD	PVT	LM	
B	Aug'2011	Revised & Re-issued for enquiry				
WPAI Document No.:					PAIP00405/RQ/402	

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Attachments

Attachment- 1 Junction Box G.A Drawing (415V power supply J.B))

Attachment-2 Junction box G.A Drawing (Lighting J.B)



1. SCOPE OF SUPPLY

This specification covers the minimum requirements for the supply of 415V Junction Box for Nimr Sludge pit system upgrade -FED / DD Project of Petroleum Development Oman LLC (PDO), hereafter referred to as the Company/ Principal.

2. SPECIFICATION

Item	Description	Qty
1	<p>Junction box Ex'e' type suitable to mount on steel structure complete with drilled gland plate, cable glands, blanking plugs and terminals as detailed below.</p> <p>Application : 415V Power Supply Distribution in Hazardous area, Zone-2.</p> <p>Explosion protection : EExe IIC T6</p> <p>Ingress protection : IP 65 as per IEC 529</p> <p>Housing material : Polyester resin Impact strength > 7Nm, Material self extinguishing and flame resistant</p> <p>Gasket : EPDM</p> <p>Terminals : 8 Nos. for 240mm² & 8 Nos. for 50mm² cable</p> <p>Earth Terminals : 1 x 25 sq.mm + 3 x 2.5 sq.</p> <p>Earth Continuity : Internal earth plate for metal glands</p> <p>Cable glands and blanking plug : Refer Attachment-1</p> <p>Cable entries shall be from bottom, Refer Attachment-1 for general arrangement.</p> <p>The JB shall be provided with following label.</p> <p>1 No. Power JB : 48-JB-001</p>	01
2	<p>Junction box Ex'e' type suitable to mount on steel structure complete with drilled gland plate, cable glands, blanking plugs and terminals as detailed below.</p> <p>Application : 415V Power Supply Distribution in Hazardous area, Zone-2.</p> <p>Explosion protection : EExe IIC T6</p> <p>Ingress protection : IP 65 as per IEC 529</p> <p>Housing material : Polyester resin Impact strength > 7Nm, Material self extinguishing and flame resistant</p> <p>Gasket : EPDM</p> <p>Terminals : 8 Nos. for 10mm² & 8 Nos. for 2.5 mm² cable</p> <p>Earth Terminals : 1 x 25 sq.mm + 3 x 2.5 sq.</p> <p>Earth Continuity : Internal earth plate for metal glands</p> <p>Cable glands and blanking plug : Refer Attachment-2</p> <p>Cable entries shall be from bottom, Refer Attachment-2 for general arrangement.</p> <p>The JB shall be provided with following labels.</p> <p>8 Nos. Area Lighting JB : FLP-1 To FLP-8 and</p> <p>1 No. Shed Lighting JB : LTG JB-1</p>	10



3. QUALITY REQUIREMENTS

The quality requirements for criticality rating category 4 equipments are as below.


- 3.1 All requirements of SP-1171 and ISO 9001:2000 shall be complied.
- 3.2 Any non-compliance, deficiencies or defects revealed at any stage during execution of the supply shall be rectified / corrected by the Supplier at his cost and expenses.
- 3.3 All material certification shall affirm compliance with relevant Company technical specifications. Manufacturer shall have a quality system certified by a competent body established within the EC, and having undergone a specific assessment for materials.
- 3.4 Supplier shall establish a documented procedure for source/receiving inspection and verification of material certificates of all base materials/brought out items used.
- 3.5 All material shall be inspected by PDO on arrival at Majan stores and any material if found non conforming to the requirements of this specification in total shall be rejected.



Attachment-1
Junction Box G.A Drawing (415V)



JUNCTION BOX

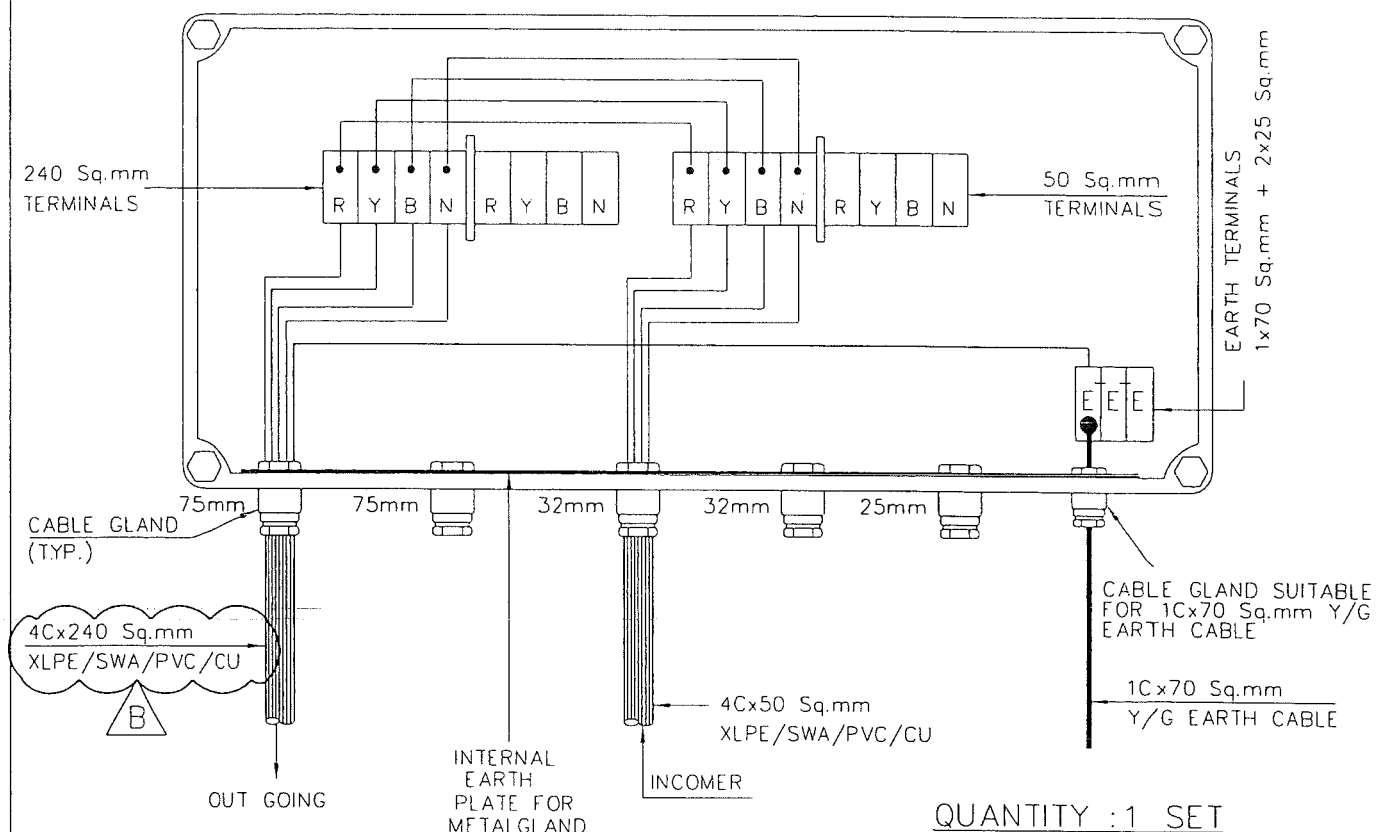

QUANTITY : 1 SET

NOTES:

1. LINKS BETWEEN TERMINALS AND CONNECTION TO TERMINAL BLOCK SHALL BE PROVIDED BY THE VENDOR
2. TERMINAL ARRANGEMENT SHOWN IS INDICATIVE ONLY.
3. VENDOR TO PROVIDE BARRIER BETWEEN PHASE TERMINALS. PHASE TERMINALS.
4. VENDOR TO PROVIDE HAWKE 501/453 OR EQUIVALENT TYPE OF CABLE GLANDS AS SHOWN IN THE SKETCH. IN ADDITION VENDOR SHALL SUPPLY SUITABLE THREADED BLANKING PLUGS FOR 1 NOS OF 75mm, 32mm AND 25mm CABLE ENTRIES EACH.

ATTACHMENT-1
TO REON.

PAIP00405/RQ/402

SHEET 1 OF 2

APPROVED FOR
CONSTRUCTION

THIS COMPLETE DRAWING IS NEW
AND FORMS PART OF SCOPE OF
PROJECT WBS# C.OM.NIM.IN.09.011



ورلي بارسونز - الصناعات العربية (محصنة)
WorleyParsons - Arabian Industries (JV)

CONTRACT NO.: C31/0606 PROJ. NO.: PAIP-00405

B	June '11	Khalid			REVISED & RE-ISSUED AS AFC	IN.09.011	OSE/28N	
A	MAY '11	Khalid	NMN	LM	APPROVED FOR CONSTRUCTION	IN.09.011	OSE/28N	
O	SEP '10	Khalid	KD	PVT	ISSUED FOR COMMENTS	IN.09.011	OSE/28N	
REV.	DATE	DRAWN BY	CHECKED BY	APPROVED BY	DESCRIPTION	WBS NO.	PROJ. ENG.	SIGNATURE
								P D O APPROVAL

PROJECT DRAWING REVISION


IN CASE OF DEVIATIONS A MARKED UP PRINT SHALL BE SENT TO THE PROJECT ENGINEER

AREA : NIMR			SCALE : — 0 1 2 3 4 5 6 7 					CAD DRAWING		
SUB AREA : NIMR SLUDGE PIT AREA		NO. 05	 شركة تنمية نفط عُمان Petroleum Development Oman							
DRWG. TYPE : TYPICAL			DRWG	AREA CODE	ENG SECT	SERIAL NUMBER	SHEET	PROJ CODE	DWG SIZE	REV
DESCRIPTION : ELECTRICAL JUNCTION BOX 48-JB-001			NO	NIM	4	6414	001	DQ	4	B

Attachment-2
Junction Box G.A Drawing (Lighting J.B)



JUNCTION BOX FOR AREA LIGHTING

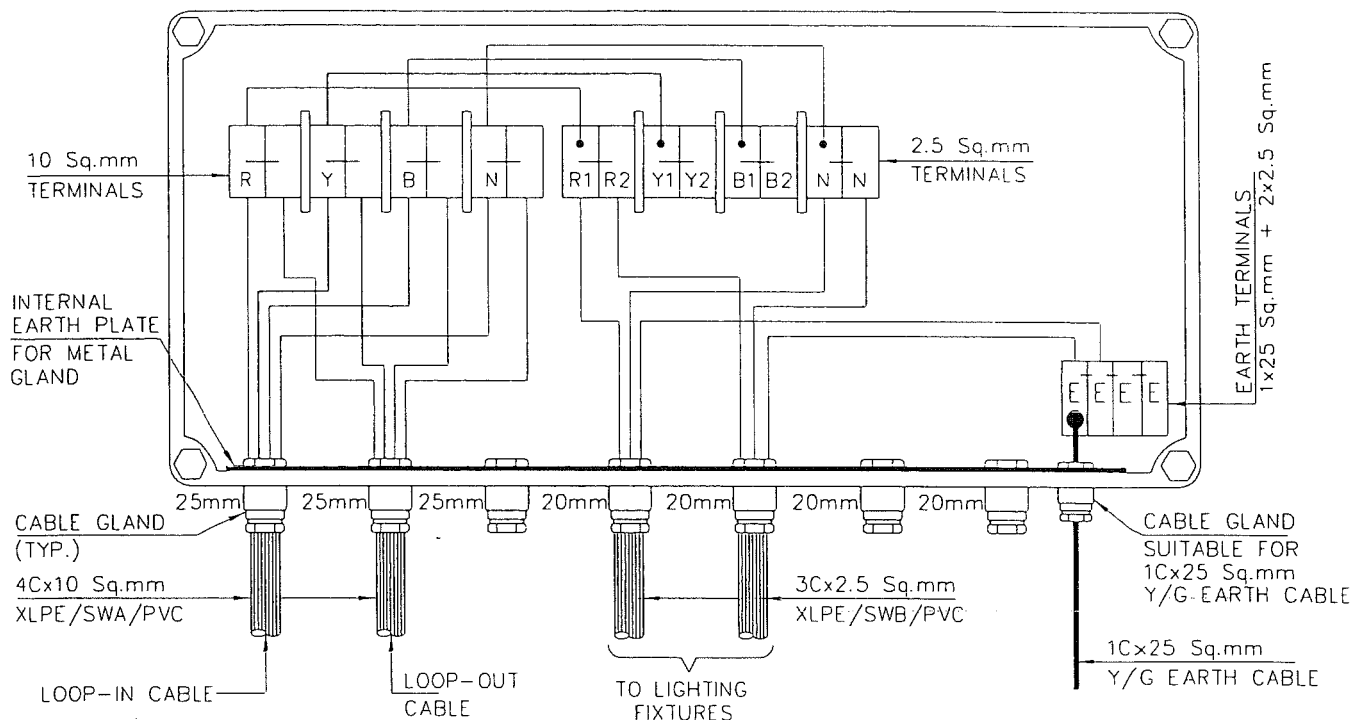

SPECIFICATION:

VOLTAGE RATING	: 415V, 3ph, 50Hz
APPLICATION	: AREA LIGHTING JB ON POLE
MOUNTING	: SUITABLE FOR MOUNTING ON A CHANNEL POST/STEEL STRUCTURE
EXPLOSION PROTECTION	: EEx d IIC T6
INGRESS PROTECTION	: IEC 60529 IP 65
HOUSING MATERIAL	: POLYESTER RESIN IMPACT STRENGTH > 7Nm, MATERIAL SELF EXTINGUISHING AND FLAME RESISTANT
GASKET	: EDPM
TERMINALS	: 8 NOS. 10 Sq.mm + 8 NOS. 2.5 Sq.mm AND 1 No 25 Sq.mm + 4 Nos. 2.5 Sq.mm EARTH TERMINALS
EARTH CONTINUITY	: INTERNAL EARTH PLATE FOR METAL GLANDS
CABLE ENTRIES	: 2 x 25 mm + : 2 x 20 mm
LABELS	: FLP-1 TO FLP-8

NOTES:

1. LINKS BETWEEN TERMINALS AND CONNECTION TO TERMINAL BLOCK SHALL BE PROVIDED BY THE VENDOR
2. TERMINAL ARRANGEMENT SHOWN IS INDICATIVE ONLY.
3. VENDOR TO PROVIDE BARRIER BETWEEN PHASE TERMINALS.
4. VENDOR SHALL PROVIDE THREADED BLANKED HOLES WITH PLUGS FOR CABLE ENTRIES.

QUANTITY : 8 NOS.

ATTACHMENT-1
TO REQN.

PAIP00405/RQ/402

SHEET 2 OF 2

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AND FORMS PART OF SCOPE OF
PROJECT WBS# C.OM.NIM.IN.09.011



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WorleyParsons - Arabian Industries (JV)

CONTRACT NO.: C31/0606


PROJ. NO.: PAIP 00405

REV.	DATE	DRAWN BY	CHECKED BY	APPROVED BY	DESCRIPTION	WBS NO.	PROJ. ENG.	SIGNATURE
0	AUG '11	Kholid			ISSUED FOR COMMENTS	IN.09.011	OSE/28N	
P D O APPROVAL								

PROJECT DRAWING REVISION

IN CASE OF DEVIATIONS A MARKED UP PRINT SHALL BE SENT TO THE PROJECT ENGINEER

AREA	: NIMR	SCALE : NTS	CAD DRAWING
SUB AREA	: NIMR SLUDGE PIT AREA	NO. 05	
DRWG. TYPE	: TYPICAL		
DESCRIPTION	: JUNCTION BOX AREA LIGHTING		
DRWG	AREA CODE	ENG SECT	SERIAL NUMBER
NO	NIM	4	6422 001DQ
PROJ CODE	DWG SIZE	REV.	
	4	0	

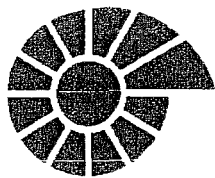

PETROLEUM DEVELOPMENT OMAN

Specification of Outdoor Distribution Board For Nimr Sludge pit system upgrade -FED / DD

Project No PAIP00405

WBS NO.C.OM. NIM. IN. 09.011

Contract No.: C 31/0606





AVME Code: 4.10.2

Criticality rating : 3

By



WorleyParsons – Arabian Industries (JV)

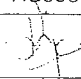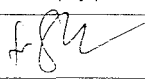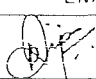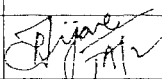Rev. No.	Date	Description	Prepared by	Checked by	Approved by	
					WPAI	PDO
O	Sep 2010	Issued for Comment	KD	PVT	LM	OSE/29M
A	May 2011	Issued for Enquiry	Nasser	PVT	LM	
B	Aug'2011	Revised & Re-issued for enquiry				
WPAI Document No.:					PAIP00405/RQ/401	

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Attachment – 1- Technical Requirements

Attachment – 2 - Table of Compliance

Attachment – 3 - Site Climatic & Outdoor Conditions

Attachment – 4 - System Voltage and Frequency

Attachment – 5 - Requisition for Vendor Engineering Documents

Attachment – 6 - Single Line Diagram

Attachment – 7 - Vendor transmittal Format

Attachment – 8 – SAP-PM Format



1. INTRODUCTION

This specification covers the minimum requirements for the design, manufacture, assembly, inspection, testing, supply, packing and delivery of Outdoor Distribution board for Nimr Sludge pit system upgrade -FED / DD Project of Petroleum Development Oman LLC (PDO), hereafter referred to as the Company/ Principal.

2. SCOPE OF SUPPLY

The Vendor's scope of work includes supply of the following Distribution board as per the Specifications detailed/referred in this requisition.

Item No	Description	Rating	Qty	Remarks
1	Outdoor Distribution Board	415V, 125A, 3Ph +N 50Hz, 10 kA for 1sec	1 Nos	Refer Single line diagram (attachment 6)

3. SPECIFICATION

3.1. General Requirements


- 3.1.1 All equipment, materials and systems shall be designed, manufactured, tested, supplied in accordance with the specification and attached data sheets. As a minimum, equipment and the system supplied by the Vendor shall satisfy the requirements of this specification and also shall meet the working and operating condition requirements listed in other sections of this document such as data sheets / DEP / SP.
- 3.1.2 It shall be the responsibility of the vendor to provide work/materials in accordance with the best modern practice and nothing written or implied in this specification shall relieve the vendor of his responsibility for the quality and soundness of the finished work, which must be adequate for the duty intended.
- 3.1.3 The Vendor shall be in possession of the latest Shell DEPs and PDO Specification (SP). Non-availability of these documents will not be accepted as an excuse for non-compliance. The order of precedence shall be as follows:
- Decrees and Laws of the Sultanate of Oman
 - This Technical specification/Contract/Enquiry Document.
 - Specifications (SP)
 - SIPM Design and Engineering Practices (DEP's)
 - International Codes and Standards
- 3.1.4 Unless alternative standards are specifically mentioned in the Specifications, all materials and equipment used and provided for the Work shall be in accordance with SP and DEP recommendations. Where no such recommendation exists, then materials shall be in accordance with IEC or ISO or such other standards, as in the opinion of the Company ensures an equivalent



or higher quality. The standards used shall be the latest published at the time of tender / bid / offer submission.

3.2. Technical requirements

- 3.2.1 The incoming and out going feeder details for Distribution Board shall be as per the Single line diagram attached as attachment-6.
- 3.2.2 The Distribution Board shall be designed for outdoor installation conditions as indicated in Attachment – 3 and shall be suitable for outdoor structural mounting type.
- 3.2.3 The Distribution Board shall be metal enclosed with form-2 type construction. Incoming and busbar shall be in separate compartments.
- 3.2.4 For motor feeders, ratings of contactor, overload relays & fuses shown in the single line diagram are tentative. Vendor shall select the components to conform to type-2 co-ordination as specified in IEC 947-4-1. The non-latchable contactor feeders for motors shall have restart facility with settable time delay. The internal wiring of the motor feeders shall be as per PDO standards.
- 3.2.5 Cable entries for all shall be from bottom. The Distribution Board shall be provided with cable glands of HAWKE or equivalent type for fixing cables. The lowest cable termination point shall not be less than 200mm from the gland. Gland plate shall be Non-magnetic.
- 3.2.6 Labelling on the Distribution Board shall conform to the following:
- Main name plate as referred to in DEP 33.67.01.31 Gen. clause 5.1.1
 - Circuit labels as referred to in DEP 33.67.01.31 Gen. clause 5.1.2 (a) & (b).
 - Distribution Board identification label.
- 3.2.7 Painting and coating shall be to RAL 7036 in accordance with SP-1246 Part-1 to 5.
- 3.2.8 The distribution board shall be provided with IP55 protection.

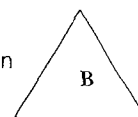

3.3 Drawing/Documents required along with offer

- 3.3.1 The following drawings/documents shall be submitted for approval before manufacturing:
- Filled in requisition data sheets attached under (Attachment-1)
 - Filled in Table of Compliance attached under (Attachment-2)
 - General arrangement drawing with dimensions for the Power DB.
 - Single line diagrams
 - List of commissioning spares with quantity
 - List of any special tools or accessories required for installation
 - Schedule for design, manufacture and supply
 - Type test certificate for similar Power DB.
- 3.3.2 All drawings and documents shall be submitted as per the RED (Refer attachment-5) form enclosed with the requisition. Final certified drawings and transparencies (or floppies) shall be submitted after agreement and incorporation of all comments made by the principal / consultant.
- 3.3.3 Offer shall include commissioning spares. Similarly the list of spare parts required for two years of operation shall be offered as a separate item in the quotation. Manufacturer to complete and



submit the E-SPIR form. SPIR form. SPIR forms shall be collected by the successful bidder from PDO as described in DEP 70.10.90.11-Gen. Spare parts Manual, Clause 1.3.2.

- 3.3.4 The equipment shall be suitably packed for transportation & submit the packing details for purchaser approval.

4. APPLICABLE STANDARDS

The applicable PDO Documents, Codes and Standards are listed below:

DEPs/SPs	DESCRIPTION
SP-1103	Electrical Engineering Guide lines (Amendment to DEP 33.64.10.10-Gen).
SP-1121	Specification for LV Switchgear and Control Assemblies.
SP-1100	Specification for Testing and Commissioning of Electrical Equipments.
SP-2047	Preparation and Content of Engineering Drawings.
SP-1285-E	Specification for Civil and Building Utility Services.
SP-1107	Electrical Protection System
SP-1105	Electrical Standard Drawing
SP-1171	Specification for Quality Assurance of Design, Construction and Engineering Works
SP 1246	Engineering standard specification for painting and coating systems for oil & gas facilities
PR 1443	Spare Parts and Interchangeability Record
SP-1099	Electrical Installation Practice
DEP 33.64.10.10-GEN	Electrical Engineering Design
DEP 33.67.01.31	Low voltage switchgear and controlgear assemblies

5. QUALITY REQUIREMENTS

The quality requirements for criticality rating, category 3 equipments are as below.

- 5.1. All requirements of SP-1171 and ISO 9001:2000 shall be complied in all phases of the Service.
- 5.2. Any non-compliance, deficiencies or defects revealed at any stage during execution of the supply shall be rectified / corrected by the Supplier at his cost and expenses.
- 5.3. All material certification shall affirm compliance with relevant Company technical specifications. Manufacturer shall have a quality system certified by a competent body established within the EC, and having undergone a specific assessment for materials.



- 5.4. Supplier shall establish a documented procedure for source/receiving inspection and verification of material certificates of all base materials/brought out items used.
- 5.5. The Vendor shall submit quality control plan in accordance with SP-1171 for approval of purchaser's QA Manager/Inspector. The quality control plan shall cover all phases of design, manufacture, installation & testing including list of all applicable standards, planned data for each test, evidence of compliance with ISO 9001, Identify Hold, Witness, Review, Monitor, and Surveillance points for confirmation to purchaser.
- 5.6. The vendor shall seek prior approval of Sub-Supplier list from WPAI /PDO, if outside the PGSC List.
- 5.7. All necessary facilities shall be extended by vendor to the purchaser for witnessing the functional or final tests as per clause number 6 below.
- 5.8. The Equipment /Material shall be certified by the third party inspection agency (TPI) arranged by PDO. TPI shall issue certificate as required by SP-1171.
- 5.9. Vendor shall furnish inspection reports as per RED form attached with the requisition.

6. TESTING AND INSPECTION

- 6.1. Type test certificates for similar equipment shall be provided with the offer.
- 6.2. The Distribution Board shall be tested at Manufacturer's works for routine test as per cl. 8.00 of DEP 33.67.01.31-GEN (only applicable clauses). The Vendor shall submit Works Inspection Test Procedure for all the inspection & tests to be conducted at Manufacturer's work. All test reports shall be submitted for company's approval before dispatch the DB.
- 6.3. Equipment shall be dispatched from the manufacturer's factories only after the factory tests, approval of packing/transport details & dispatch clearance granted by the Purchasers.

7. SPECIAL TOOLS

The Vendor shall recommend and include special tools which may be required for the installation, operation & maintenance of the equipment being supplied. A list of special tools & tackles shall be supplied with the offer.

8. WARRANTY

Warranty for equipment shall be in accordance with applicable, relevant DEP/ SP

9. PACKING, TRANSPORT & SHIPMENT

Packing, transport & shipment shall be in accordance with DEP 33.67.51.31 & SP-1120 and packing / forwarding details to be approved by purchaser prior to dispatch

10. DELIVERY, INSURANCE & PAYMENT TERMS



Delivery, insurance & payment terms shall be in accordance with the commercial part of the requisition/ purchase order.



ATTACHMENT – 1 TECHNICAL REQUIREMENTS



Requisition sheet for DISTRIBUTION BOARD		Contr. Job No. PAIP00405				
		MESC No.				
1 REQUIREMENTS AND CONDITIONS						
2 General						
3	Specific requirements	: DEP 33.67.01.31-Gen, SP-1121, SP-1107				
4	Schedule	: + REFER SLD UNDER ATTACHMENT 6 (Form Dep 33.67.01.81-Gen)				
5	Power system type	: TN-S/ 415V, 3Ph+N, 4 wire				
6	Rated current of busbar system	: 125A				
7	Rated short time withstand current	: 10kA for 1 Sec.				
8	Service conditions	: temperate /tropical/ indoors /outdoors				
9	Special service conditions	: NIL				
10	Type of enclosure	: metal / insulating material , multi-box / multi-cubicle				
11	Type of mounting	: structural / floor / wall				
12	Framework required	: yes / no	Cable entries : incoming: below/above			
13	Type of fuses	: DIN/BS/HRC	: outgoing: below/above			
14	Inspection required	: yes / no	Cable gland plate : drilled/undrilled			
15	Language on documents	: English/	Glands required : yes / no			
16	on equipment	: English/	Glands type : weather proof double compression			
17						
18						
19						
20 INFORMATION TO BE SUBMITTED BY MANUFACTURER WITH THE QUOTATION						
21	Make and type					
22	Short-circuit strength	: Thermal: kA rms, 1s; dynamic: kA crest				
23	Type of enclosure					
24	Type of mounting					
25	Degree of protection	: IP - 55				
26	Rain canopy	: yes / no				
27	Total mass of equipment	: kg				
28	Specified tender document attached	: yes / no				
29	Any deviations from specification	: no				
30	(if yes, list deviations)					
31						
32						
33						
34						
35						
41						
42						
43						
44						
45						
46	SPECIAL REQUIREMENTS AND REMARKS		REMARKS ON REVISIONS			
47	1. Panel shall be constructed in form-2 configuration.		0 - ISSUED FOR COMMENTS			
48			A - ISSUED FOR ENQUIRY			
49	2. Live parts inside the cubicle shall have min. degree of protection					
50	of IP-20 when the door is open.					
51						
52						
53						
54						
55						
56						
57						
Made by	KD	EQUIPMENT: OUTDOOR DISTRIBUTION BOARD PLANT : NIMR SLUDGE PIT AREA CONSIGNEE: PETROLEUM DEVELOPMENT OMAN LLC	Rev letter	O	A	
Checked by	PVT		Date	SEP'10	MAY'11	
Appr. by	LM		Signature	KD		
10-08-11			Sheet No. 1 cont'd on sheet -			
Eng. by : WorleyParsons Oman Engineering L.L.C.			Equipment No.			
Principal : PETROLEUM DEVELOPMENT OMAN LLC			Req. No. PAIP00405RQ/401			

ATTACHMENT – 2 TABLE OF COMPLIANCE



TABLE OF COMPLIANCE

The Vendor shall confirm below that he has accepted all the clauses contained in the specification or otherwise made clarifications or exceptions as furnished below:

Spec. Ref Paragraph	Conform Y/N	Alternatives Y/N	Noted Y/N	Clarification
1				
2				
3.1.1				
3.1.2				
3.1.3				
3.1.4				
3.2.1				
3.2.2				
3.2.3				
3.2.4				
3.2.5				
3.2.6				
3.2.7				
3.2.8				
3.3.1				
3.3.2				
3.3.3				
3.3.4				
4				
5.1				
5.2				
5.3				
5.4				
5.5				
5.6				
5.7				
5.8				
5.9				



Spec. Ref Paragraph	Conform Y/N	Alternatives Y/N	Noted Y/N	Clarification
6.1				
6.2				
6.3				
7				
8				
9				
10				
ATTACHMENT-1				
ATTACHMENT-3				
ATTACHMENT-4				
ATTACHMENT-5				
ATTACHMENT-6				
ATTACHMENT-7				
ATTACHMENT-8				
ATTACHMENT-9				



ATTACHMENT – 3 SITE CLIMATIC & INDOOR CONDITIONS



SITE CLIMATIC AND INDOOR CONDITIONS
(EXTRACT FROM SP-1103)

1. SITE CLIMATIC CONDITIONS

Maximum black bulb temperature	:	82 °C
Peak shade temperature, two hours	:	60 °C
Continuous ambient temperature	:	55 °C
Minimum average ambient temperature	:	5 °C
Maximum daily variation in temperature	:	25 °C
Maximum relative humidity	:	98%
Maximum ground temperature at various below-grade-levels		
	:	35 °C @ 800 mm
	:	38 °C @ 650 mm
	:	40 °C @ 500 mm
Minimum ground temperature	:	20 °C @ 1000 mm below grade
Soil Thermal Resistivity	:	240 °C cm/W
Maximum infrequent heavy rainfall	:	25 mm/hour
No earthquakes		
Elevation not greater than	:	120 m A.S.L.
Maximum Isokeraunic level	:	10 days per annum
Maximum 3 second gust wind speed	:	122 km/hour
Solar radiation	:	120 mW/cm ²

Local conditions are characterised by frequent sand storms when the atmosphere becomes heavily laden with dust particles. Rain is infrequent but is often combined with hail and sand storms. At certain times of the year early morning dew occurs.

Equipment installed outdoors shall be designed for operation in the environment stated above. For continuous temperature rating of such equipment, reference shall be made to the various equipment DEPs and SPs.

2. INDOOR CONDITIONS

Indoor conditions exist inside control rooms, switch rooms, substations, battery rooms etc. and such rooms are considered to be air-conditioned (redundant system). Inside temperature is maximum 25°C with all units operating and 35 °C with one unit out of service. Equipment installed in such rooms shall be specified for a continuous operating temperature of 40 °C, and at 50 °C for two hours in one day.



ATTACHMENT – 4 SYSTEM VOLTAGE AND FREQUENCY



(A) SYSTEM VOLTAGE AND FREQUENCY

(Extract from SP-1103)

1. STANDARD VOLTAGES, FREQUENCY AND NEUTRAL EARTHING

- | | | | | |
|-----------------|---|-----------|-------------------|---------------------------------------|
| a) Frequency | : | 50 Hz | | |
| b) High voltage | : | 132 kV | 3 phase | solidly earthed |
| c) High voltage | : | 33 kV | 3 phase | solidly earthed |
| d) High voltage | : | 11 kV | 3 phase | resistance earthed (see note 1, 2, 3) |
| e) High voltage | : | 6.6 kV | 3 phase | resistance earthed (see note 1, 2) |
| f) Low voltage | : | 415/240 V | 3 phase & neutral | solidly earthed |

- Notes:
1. For distribution systems, the earth fault current shall be limited to approximately the nominal current of the supply equipment.
 2. For generators and motor unit transformers, the earth fault current shall be limited to 5A
 3. The use of 11 kV should be limited to ring circuits for camps.

2. SUPPLY VARIATIONS

- a) Steady state:
- | | | |
|-----------|---|--|
| Voltage | : | $\pm 10\%$ at a voltage of 132 kV and $\pm 5\%$ at voltages below 132 kV |
| Frequency | : | $\pm 2\%$ |
- b) Dynamic:
- | | | |
|---------|---|-----------------------------|
| Voltage | : | $\pm 15\%$ at common buses. |
|---------|---|-----------------------------|

3. EQUIPMENT OPERATING VOLTAGES

Equipment shall be suitable for operation at the following voltages:

- | | | |
|----------------------------|---|--|
| a) Motors above 2200 kW | : | By unit transformer from 33 kV or 132 kV |
| b) Motors 185 kW-2200 kW | : | 6.6 kV (see note 1 below) |
| c) Motors up to 160 kW | : | 415 V |
| d) Lighting supply | : | 415/240 V; 3 phase & neutral |
| e) Lighting systems | : | 240 V; phase & neutral |
| f) Instruments (non-vital) | : | 240 V; phase & neutral |
| g) Instruments (vital) | : | 240 V; phase & neutral (see note 2) |
| h) Instruments (vital) | : | 24 V DC floating |
| i) Welding outlets | : | 415 V; 3 phase & neutral |
| j) Convenience outlets | : | 240 V; phase & neutral |
| k) Switchgear closing | : | 110 V DC floating |
| l) Switchgear tripping | : | 110V DC floating |
| m) Electrical SCADA system | : | 48 V DC positive earth |

- Notes:
1. Preferred voltage for HV motors is 6.6 kV
 2. Supply from Uninterruptible Power Supply System (UPS).



ATTACHMENT – 5 REQUISITION FOR VENDOR ENGINEERING DOCUMENTS




REQUISITION FOR ENGINEERING DOCUMENTS						"RED" form
The following addresses shall be inserted by Seller in the relevant space on the "Approval Drawing Specification" (ADS) from DEP 05.00.54.81-Gen. or the "Final Drawing Specification" (FDS) form DEP 05.00.54.82-Gen.						
Purchasing (Procurement) Office		Principal			Distribution Office (Note2)	
		Petroleum Development Oman LLC Attn : P.O.B. 81, Postal Code 113 Muscat Sultanate Of Oman				
SPECIAL INSTRUCTIONS					Prints	Documents shall be submitted to
Production Schedule					3	Nominated inspector before pre-manufacturing meeting
Manufacturing, inspection and testing sequence plan					3	Within 2 weeks from the order date.
DRAWINGS		Required number for				TIMING FOR SUBMITTAL
		Approval		Final issue		
Approval drawings/Final drawings to be submitted under cover of an ADS form/ FDS form respectively		Transparencies	Prints	Originals (Note 1)	Prints	For Approval: Within 2 weeks of order placement
						For Final Document Submission: Within 2 weeks of the approval / order placement.
Drawing and Document List			3	1	3	Refer Note 4 below Refer Note 5 below
Quality Control Plan / Inspection and Test Plan			3	1	3	
Single Line Diagrams			3	1	3	
Schematics Drawings			3	1	3	
Bill of Materials			3	1	3	
Equipment Data sheets			3	1	3	
General Arrangement Drawings			3	1	3	
Installation Details			3	1	3	
SPARE PARTS DOCUMENTS					Prints	Documents shall be submitted to
E-SPIR plus 1 printed copy as per PR-1443.					3	Distribution Office (WPAI) by Vendor / Sub-contractor
						Within 6 weeks of order placement
TEST AND INSPECTION DOCUMENTS					Prints	Documents shall be submitted to
Approval/Final documents to be submitted under cover of an ADS/FDS form respectively						Distribution Office (WPAI) by Vendor / Sub-contractor
						Within 4 weeks of test of before final release whichever is sooner.
Manufacturing report to: DEP 31.22.10.35-Gen.					3	Note 4: Turn around time at WPAI for each submission of documents is 15 days or 10 working days whichever is higher Note 5: ITPs and/or any other documents requiring PDO approval as per SP-1122 or any other SPs, additional 5 working days or 1 week whichever is higher to be added to turnaround time mentioned in note 4 above.
Abridged manufacturing report to: DEP 31.22.10.35-Gen.					3	
Material certificates to ISO 10474: Type 3.1.B & CE marking or equivalent					3	
OPERATING DOCUMENTS						Documents shall be submitted to
Installation instructions					3	Distribution Office (WPAI) by Vendor / Sub-contractor
Operating instructions					3	
Maintenance instructions					3	
ADDITIONAL REQUIREMENTS						
Note 1: If the document is available in electronic form, a diskette containing the electronic file shall also be submitted.						
Note 2: The submitted document to be collected by vendor or by subcontractor from WPAI office as required.						
Note 3: In the absence of ADS or FDS form, vendor may submit the drawings with attached Vendor Document Transmittal Form						
REMARKS						
Invoice must certify that the drawings and engineering documents specified above have been despatched to all parties concerned. Any deviation from the timing for submittal of documents shall be notified to the Approval/Distribution Offices by E-mail or fax. Shop fabrication shall not be started before the required approval drawings have been released for construction by the party concerned, unless otherwise stated on the "Approval Drawing Specification". Each document shall bear the item/tag and order reference number, and shall be despatched by air mail unless specified otherwise.				Units/dimensions used on Engineering documents shall be SI. Exceptions to SI units are standardized imperial units for nominal sizes of pipe, valves flanges, bolting, etc. The documents shall be in English. Description on drawings and similar documents may be in other languages provided English translations are also given. Drawings and documents shall be suitable for microfilming and comply with accepted national or international standards for the preparation of technical drawings. Only the following standard sizes should be used: A4, A3, A2, A1		
				Attachment to Document: PAIP00405/RQ/401		

ATTACHMENT –6 SINGLE LINE DIAGRAM




FROM MDB-1
LOCATED AT SEWAGE TREATMENT PLANT
REF. DRG. NIM-4-2801-001-DQ

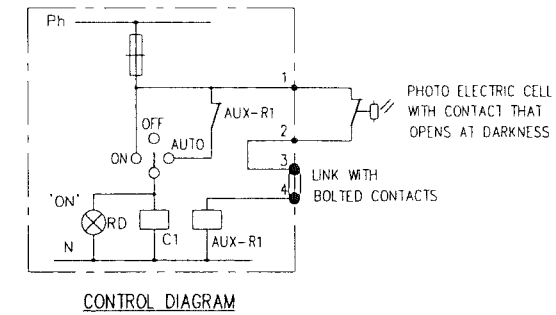

- LEGEND
- MCCB, 4P (MOULDED CASE CKT. BREAKER)
 - ON LOAD ISOLATING SWITCH
 - FUSE
 - CABLE GLAND (HAWKE TYPE 153 OR EQUIVALENT APPROVED)
 - EARTH LEAKAGE MONITOR
 - MCB + RCD
 - CONTACTOR WITH OVERLOAD RELAY
 - CURRENT TRANSFORMER 3 NOS.
 - CURRENT TRANSFORMER 1 NO.
 - JUNCTION BOX

DISTRIBUTION BOARD-G6951
LOCATION: SLUDGE PIT AREA

415V, 3Ph, 4W, 50Hz, 125A, 10kA/1sec.

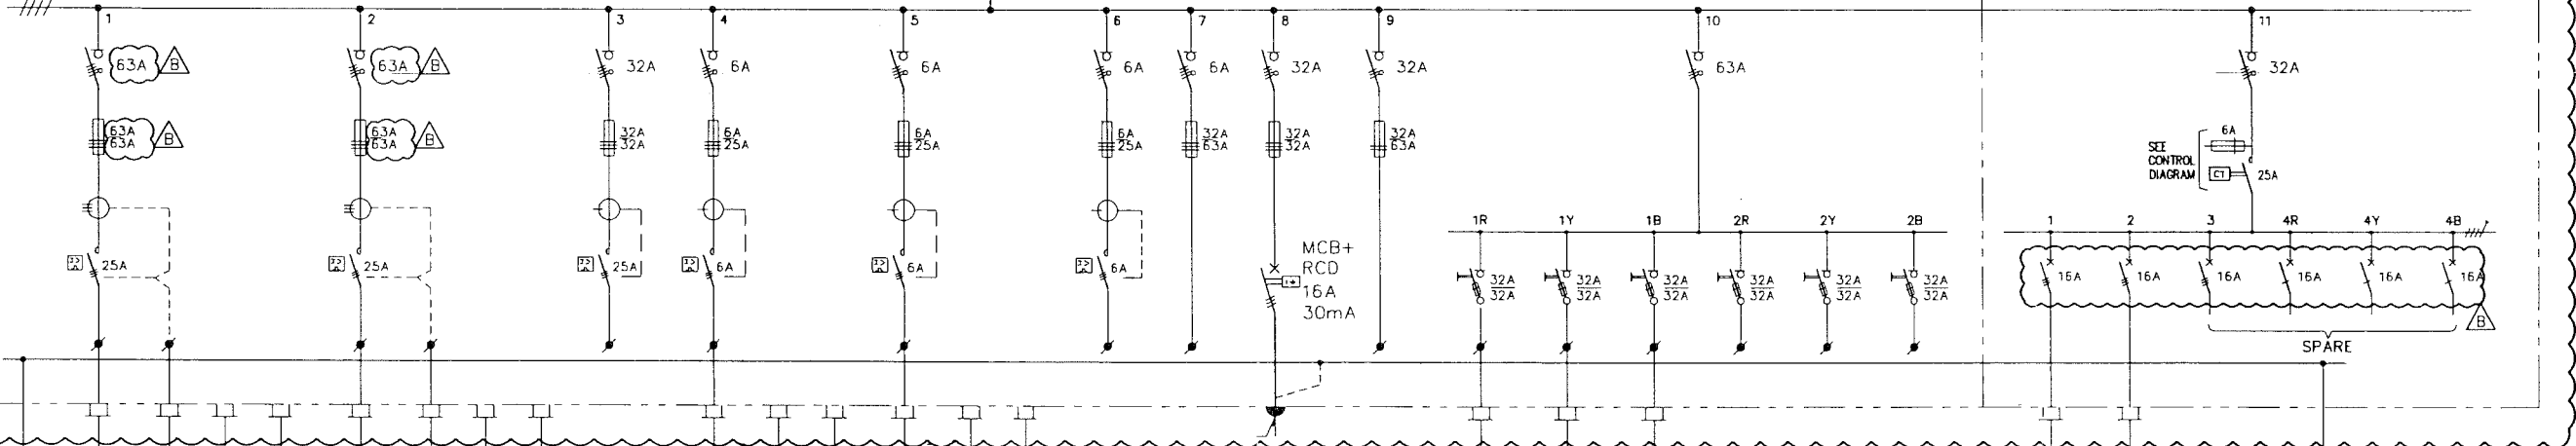

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SCOPE OF SUPPLY

ATTACHMENT-6
TO REQ.
PAIP00405/RO/401. REV.B

SHEET 1 OF 1

APPROVED FOR
CONSTRUCTION

THIS COMPLETE DRAWING IS NEW AND
FORMS PART OF SCOPE OF PROJECT
WBS# C.O.M. NIM.IN.09.011

* SOCKET OUTLETS SHALL BE
MOUNTED ON THE SIDE OF THE PANEL
AND WIRED BY THE VENDOR.

- NOTES
3. kW RATING IS ON HOLD DUE TO UNAVAILABLE OF VENDOR DATA.
 2. THE RATING OF FUSE, CONTACTOR AND SWITCHES INDICATED ON MOTOR FEEDER ARE INDICATIVE. THE SAME SHALL BE FINALIZED BY VENDOR ON TYPE-2 CO-ORDINATION.
 1. THE INCOMING CABLE SIZE TO THIS DISTRIBUTION BOARD IS 4Cx240 Sq.mm XLPE/SWA/PVC/CU CABLE.
 - SO VENDOR TO PROVIDE SUITABLE TERMINAL FOR TERMINATING THIS CABLE.

SLD - MAIN DISTRIBUTION BOARD
CABLE SCHEDULE
DRAWING CONTROL INDEX

DESCRIPTION
DRAWING NUMBER

REFERENCE DRAWINGS

MASTER DRAWING REVISION
IN CASE OF DEVIATIONS MARKED UP. PRINT SHALL BE SENT TO COASTAL DESIGN OFFICE

WorleyParsons - Arabian Industries (JV)
CONTRACT NO.: C31/0606 PROJ NO. PAIP-00405

REV	DATE	DRAWN BY	CHECKED BY	APPROVED BY	DESCRIPTION	WBS NO.	PROJ. ENG.	SIGNATURE
B	June '11	Khalid	AB	LM	REVISED & RE-ISSUED AS AFC	IN.09.011	OSE/28N	
A	MAY '11	AB	LM	LM	APPROVED FOR CONSTRUCTION	IN.09.011	OSE/28N	
0	SEP '10	Khalid	KD	PVT	ISSUED FOR COMMENTS	IN.09.011	OSE/28N	

PROJECT DRAWING REVISION
IN CASE OF DEVIATIONS A MARKED UP PRINT SHALL BE SENT TO THE PROJECT ENGINEER
CAD DRAWING

AREA	NIMR	SUB AREA	SLUDGE PIT FACILITY	NO. DS	
DRWG. TYPE	ELEC. SINGLE LINE DIAGRAM	DESCRIPTION	DISTRIBUTION BOARD	NO.	NIM 4 6411 001DQ 1 B

ATTACHMENT – 7 VENDOR TRANSMITTAL FORMAT





Vendor Document Transmittal Form

1. Date of Despatch	2. Date of Receipt	3. Date of Distribution	5. PART	6. COMPLETE				
7. WPAI Purchase Order Number		8. Vendor Work Order Reference	8a. Vendor Transmittal Number					
9. Name of the equipment								
10. Vendor Name / Address Contact Person: Telephone Number: Fax Number: GSM Number: Email ID:			11. Distribution (Approval Office) Office Name / Address WorleyParsons Arabian Industries JV PB 795, PC, 133, Al-Khuwair, Sultanate of Oman Attn: Document Controller (<u>Project Number PAIP00405</u>)					
12. Purchasing Office Name / Address Refer Purchase Order			13. Principal / Company Name / address Petroleum Development-Oman PB81, PC 100, Muscat, Sultanate of Oman					
14. Item #	15. Supplier Doc / Dwg Number	16. Dwg Rev #	17. Doc / Drawing Description or Title	18. Only as per RED Electronic	19. Only as per RED Print	20. Approval Office Drawing	21. Rev #	22. Code* Purpose of Submission
24. Additional Remarks by Supplier: Warning: Approval of drawings in no way absolves Vendor from responsibilities and obligation for their accuracy or for the design, construction and performance of the equipment / service. Refer document turnaround time mentioned in the RED form.								
Name, Signature and date by Supplier Representative								
25. Remarks by Distribution (Approval) office: The requirements for final drawings and the address to which they should be dispatched are given in RED form.								
Name, Signature and date by Distribution (Approval) Office Representative								
* Code for 22: A-Submitted for comments, B-Submitted for Review, C-Submitted for Approval, D- Submitted for action(Specify), E- Submitted for Information, F-Final Documentation								

ATTACHMENT – 8
SAP PM FORMAT
(Shall be provided later)





Document Control Index

Client : Petroleum Development Oman LLC (PDO)



Job No. : PAIP00405

Phase: AFC

Job Title : Nimr Sludge Pits System upgrade - FED & DD

Discipline Code: Electrical				Current Revision Detail			Earlier Revision Detail		
Item#	Document No	Size	Description:	Rev#	Date:	Status:	Rev#	Date:	Status:
1	NIM-1-2635-400-DQ	A4	Drawing Control Index	A	16-MAY-11	AFC	0	19-SEP-10	IFC
2	NIM-4-2801-001-DQ	A1	415V SLD Main Distribution Board (MDB-1)	B	04-JUN-11	AFC	A	16-MAY-11	AFC
							0	19-SEP-10	IFC
3	NIM-4-2815-002-DQ	A3	SLD OF MDB	A	16-MAY-11	AFC			
4	NIM-4-2817-001-DQ	A1	Cable Layout And DB Location	A	16-MAY-11	AFC	0	19-SEP-10	IFC
5	NIM-4-6411-001-DQ	A1	415 V SLD Power Distribution Board (PDB)	B	04-JUN-11	AFC	A	16-MAY-11	AFC
							0	19-SEP-10	IFC
6	NIM-4-6412-001-DQ	A3	Schematic Lighting Diagram	B	04-JUN-11	AFC	A	16-MAY-11	AFC
							0	19-SEP-10	IFC
7	NIM-4-6413-001-DQ	A3	LV Cable Schedule Cover Sheet	B	04-JUN-11	AFC	A	16-MAY-11	AFC
							0	19-SEP-10	IFC
8	NIM-4-6413-002-DQ	A3	LV Cable Schedule Index Sheet	B	04-JUN-11	AFC	A	16-MAY-11	AFC
							0	19-SEP-10	IFC
9	NIM-4-6413-003-DQ	A3	LV Cable Schedule	B	04-JUN-11	AFC	A	16-MAY-11	AFC
							0	19-SEP-10	IFC
10	NIM-4-6415-001-DQ	A1	Overall Cable Route Layout	A	16-MAY-11	AFC	0	19-SEP-10	IFC
11	NIM-4-6415-002-DQ	A1	Cable Route Layout at Sludge Pit Area	A	16-MAY-11	AFC	0	19-SEP-10	IFC
12	NIM-4-6416-001-DQ	A1	Overall Cable Trench Layout	A	16-MAY-11	AFC	0	19-SEP-10	IFC
13	NIM-4-6416-002-DQ	A1	Cable Trench Layout SWTP	A	16-MAY-11	AFC	0	19-SEP-10	IFC
14	NIM-4-6416-003-DQ	A1	Cable Trench Layout at Sludge Pit Area	A	16-MAY-11	AFC	0	19-SEP-10	IFC
15	NIM-4-6417-001-DQ	A1	Cable Trench Layout Sections	A	16-MAY-11	AFC	0	19-SEP-10	IFC
16	NIM-4-6418-001-DQ	A1	Earthing Layout at Sludge Pit Area	A	16-MAY-11	AFC	0	19-SEP-10	IFC
17	NIM-4-6420-001-DQ	A1	Electrical Control Diagram LV Motors (ABOVE 5.5kW)	A	16-MAY-11	AFC	0	19-SEP-10	IFC
18	NIM-4-6421-001-DQ	A1	Electrical Control Diagram LV Motors (5.5kW & BELOW)	A	16-MAY-11	AFC	0	19-SEP-10	IFC
19	PAIP00405/MTO/401	A4	Electrical Bulk MTO (5 Sheets)	B	20-AUG-11	IFE	0	06-APR-11	IFE
							A	06-APR-11	IFE

ELECTRICAL MTO

Project Title: Nimr Sludge Pit System Upgrade					Principal : PDO		Consignee: PDO		Engg : WorleyParsons Arabian Industries-JV			
Rev.	Date	Description	Prepared	Checked	Approved		Contract No.	Job No.	WBS No.	Revision		
					WPAI	PDO						
O	Oct 2010	Issued for Information	Domison	KD	LM	OSE28N	 	C-31/0606	PAIP00405	C.OM.NIM.IN.09.011	B	
A	April 2011	Issued for Enquiry	Khalid	SCB	LM	OSE28N						
B	Aug. 2011	Revised & Reissued for Enquiry										
									Doc. Title : Electrical MTO			
									Document No.	Total Sheets		
									PAIP00405/MTO/401		5	

The preliminary material take off (MTO), Bill of Quantities (BOQ) and quantity in BOQ or MTO provided with tender package shall not be considered for cost estimation. The MTO and BOQ provided with tender do not necessarily contain all the items or material required to complete the scope. The preliminary material take off (MTO), Bill of Quantities (BOQ) and quantity in BOQ or MTO provided with tender package are prepared prior to freezing the design and are preliminary.

Note 1: All cables should be supplied in single straight length. If this is not possible, prior approval shall be taken from Design Engineer prior to bidding, order placement and manufacturing.

Serial Number	Type	SAP #	MESC #	WPAI Spec #	AVME #	Description	UOM	Total Quantity	Rev #	Additional Qty. to be Procured	Remarks
1	Power DB					415V, 125A, 3Ph+N, 50Hz, 10kA for 1 Sec. Outdoor Distribution Board	Each	1	Rev. A		PAIP00405/RQ/401
2	Cable: LV	1000047762	68.44.14.459.1		4.15.1	LV Cable: 4Cx240 sq.mm, 600/1000V, XLPE/SWA/PVC Copper cable	Metre	1800	Rev. A		500mts/Drum size
3	Cable: LV	1000047757	68.44.14.437.1		4.15.1	LV Cable: 4Cx50 sq.mm, 600/1000V, XLPE/SWA/PVC Copper cable	Metre	50	Rev. A		
4	Cable: LV	1000047742	68.44.14.331.1		4.15.1	LV Cable: 3Cx16 sq.mm, 600/1000V, XLPE/SWA/PVC Copper cable	Metre	350	Rev. A		
5	Cable: LV	1000047754	68.44.14.409.1		4.15.1	LV Cable: 4Cx10 sq.mm, 600/1000V, XLPE/SWA/PVC Copper cable	Metre	1000	Rev. B		
6	Cable: LV	1000069262	--		4.15.1	LV Cable: 2Cx10 sq.mm, 600/1000V, Flexible PVC Copper cable	Metre	30	Rev. B		
7	Cable: LV	1000071265	--		4.15.1	LV Cable: 2Cx6 sq.mm, 600/1000V, XLPE/SWA/PVC Copper cable	Metre	300	Rev. A		
8	Cable: LV	1000047763	68.44.14.703.1		4.15.1	LV Cable: 7Cx2.5 sq.mm, 600/1000V, XLPE/SWA/PVC Copper cable	Metre	600	Rev. A		
9	Cable: LV	1000047751	68.44.14.403.1		4.15.1	LV Cable: 4Cx2.5 sq.mm, 600/1000V, XLPE/SWA/PVC Copper cable	Metre	350	Rev. B		
10	Cable: LV	1000047738	68.44.14.303.1		4.15.1	LV Cable: 3Cx2.5 sq.mm, 600/1000V, XLPE/SWA/PVC Copper cable	Metre	100	Rev. A		
11	Cable: LV	100047722			4.15.1	LV Cable: 3Cx2.5 sq.mm, 600/1000V, XLPE/SWB/PVC Copper cable	Metre	225	Rev. A		
12	Cable Joint	1000754004	--		4.16.1	Cable Jointing Kit suitable for 4Cx240 sq.mm, 600/1000V, XLPE/SWA/PVC Copper cable	Each	5	Rev. B		
13	Cable Gland	1000048326	68.80.58.744.1		4.16.5	Cable Gland suitable for 4CX240 sq.mm Cable (M75)	Each	3	Rev. A		
14	Cable Gland	1000048322	68.80.58.736.1		4.16.5	Cable Gland suitable for 4Cx50 sq.mm Cable (M32)	Each	3	Rev. A		
15	Cable Gland	1000048321	68.80.58.734.1		4.16.5	Cable Gland suitable for 3Cx16 sq.mm Cable (M25)	Each	5	Rev. A		
16	Cable Gland	1000048321	68.80.58.734.1		4.16.5	Cable Gland suitable for 4Cx10 sq.mm Cable (M25)	Each	17	Rev. A		
17	Cable Gland	1000048320	68.80.58.732.1		4.16.5	Cable Gland suitable for 2Cx10 sq.mm Cable (M20)	Each	2	Rev. A		
18	Cable Gland	1000048320	68.80.58.732.1		4.16.5	Cable Gland suitable for 2Cx6 sq.mm Cable (M20)	Each	4	Rev. A		
19	Cable Gland	1000048320	68.80.58.732.1		4.16.5	Cable Gland suitable for 7Cx2.5 sq.mm Cable (M20)	Each	10	Rev. A		
20	Cable Gland	1000048320	68.80.58.732.1		4.16.5	Cable Gland suitable for 4Cx2.5 sq.mm Cable (M20)	Each	18	Rev. A		
21	Cable Gland	1000048320	68.80.58.732.1		4.16.5	Cable Gland suitable for 3Cx2.5 sq.mm Cable (M20)	Each	38	Rev. A		
22	Lock Nut	1000048282	68.80.58.090.9		4.16.5	Lock Nut suitable for M75 Gland	Each	3	Rev. A		
23	Lock Nut	1000048278	68.80.58.076.9		4.16.5	Lock Nut suitable for M32 Gland	Each	3	Rev. A		
24	Lock Nut	1000048277	68.80.58.072.9		4.16.5	Lock Nut suitable for M25 Gland	Each	22	Rev. A		
25	Lock Nut	1000048276	68.80.58.068.9		4.16.5	Lock Nut suitable for M20 Gland	Each	72	Rev. A		
26	PVC Shroud	1000048262	68.80.56.924.9		4.16.5	PVC Shroud type-F suitable for M75 Gland	Each	3	Rev. A		

Serial Number	Type	SAP #	MESC #	WPAI Spec #	AVME #	Description	UOM	Total Quantity	Rev #	Additional Qty. to be Procured	Remarks
27	PVC Shroud	1000048258	68.80.56.916.9		4.16.5	PVC Shroud type-C suitable for M32 Gland	Each	3	Rev. A		
28	PVC Shroud	1000048257	68.80.56.914.9		4.16.5	PVC Shroud type-B suitable for M25 Gland	Each	22	Rev. A		
29	PVC Shroud	1000048256	68.80.56.912.9		4.16.5	PVC Shroud type-A suitable for M20 Gland	Each	72	Rev. A		
30	Earth Tag	1000255978	--		4.16.5	Earth Tag suitable for M75 Gland	Each	3	Rev. A		
31	Earth Tag	1000223714	--		4.16.5	Earth Tag suitable for M32 Gland	Each	3	Rev. A		
32	Earth Tag	1000223710	--		4.16.5	Earth Tag suitable for M25 Gland	Each	22	Rev. A		
33	Earth Tag	1000223708	--		4.16.5	Earth Tag suitable for M20 Gland	Each	72	Rev. A		
34	Cable Lug	1000048099	--		4.16.1	Cable Lug suitable for 240 sq.mm Cable	Each	10	Rev. B		
35	Cable Lug	1000048085	--		4.16.1	Cable Lug suitable for 50 sq.mm Cable	Each	10	Rev. B		
36	Cable Lug	1000048084	--		4.16.1	Cable Lug suitable for 16 sq.mm Cable	Each	15	Rev. B		
37	Cable Lug	1000048083	--		4.16.1	Cable Lug suitable for 10 sq.mm Cable	Each	75	Rev. B		
38	Cable Lug	1000048081	--		4.16.1	Cable Lug suitable for 6 sq.mm Cable	Each	20	Rev. B		
39	Cable Lug	1000048080	--		4.16.1	Cable Lug suitable for 2.5 sq.mm Cable	Each	260	Rev. B		
40	Cable Acces.	1000048555	68.85.12.419.1		4.16.1	Electrical Insulation Tape Yellow, 6 Metre/Roll	Roll	20	Rev. B		
41	Cable Acces.	--	--		4.16.1	Pin type terminal blocks & Ferrules	Pkt	A/R	Rev. B		
42	Trench	1000047983	68.76.81.106.9		4.16.3	Underground Cable Tiles size 1000mm x 240mm x 6mm thick	Each	2700	Rev. A		
43	Trench	1000048548	68.85.12.356.9		4.16.3	Underground Warning Tape 150mm width, 365mts/Roll	Metre	2700	Rev. A		
44	Trench	1000048104	68.79.02.006.9		4.16.3	Plain Lead Strip Underground Cable Nos. 19mm x 1.6mm x 300mm Long, 11 Metre/Roll	Roll	10	Rev. A		
45	Trench	1000075844	--		4.16.3	LV Cable Route Marker	Each	25	Rev. A		
46	Trench	1001205594	--		4.16.3	100mm Dia uPVC Pipe	Metre	60	Rev. A		
47	Trench	1000048206	68.80.50.914.9		4.16.3	150mm Dia uPVC Pipe	Metre	20	Rev. A		
						CABLE MARKER FOR ABOVE GROUND CABLE AS PER (STD-4-0108-001-4-E)					
48	Cable Acces.	1000521146	--		4.16.3	Cable Tie, Black, Nylon, 368 x 3.6mm	Pocket	2	Rev. A		
49	Cable Acces.	1000535192	--		4.16.3	4mm wide Nylon strapping Hellermann TY4-S1	Pocket	2	Rev. A		
50	Cable Acces.	--	--		4.16.3	Arrowtag Hellermann type AT3	Pocket	A/R	Rev. A		
51	Cable Acces.	--	--		4.16.3	Ovalgrip Marker Hellermann type H085	Pocket	A/R	Rev. A		
52	Cable Tray	1000069935	--		4.20.5	75mm wide heavy duty return flange G.I. Cable Tray	Metre	25	Rev. A		
53	Cable Tray	1000069990	--		4.20.5	Ventilated cover for 75mm wide Cable Tray	Metre	25	Rev. A		
54	Cable Tray	1000223944	--		4.20.5	Cable Tie 240mm Length	Pocket	2	Rev. A		
55	Cable Tray	--	--		4.20.5	Nut, Bolt & Clamps for fixing Trays	Each	A/R	Rev. A		
56	Other	--	--		4.20.5	G.I. Trunking 75mm x 75mm	Metre	50	Rev. A		




Serial Number	Type	SAP #	MESC #	WPAI Spec #	AVME #	Description	UOM	Total Quantity	Rev #	Additional Qty. to be Procured	Remarks
57	Other	--	--		4.20.5	20x20 Unistrut G.I. Slot Type / 12 Metre Length	Each	A/R	Rev. A		
58	Other	--	--		4.20.5	M6x30 Bolt (Bolt Head Half Round)	Each	A/R	Rev. A		
59	Other	--	--		4.20.5	M6 Spring Nut	Each	A/R	Rev. A		
60	Other	--	--		4.20.5	M25 PVC Gland	Each	A/R	Rev. A		
61	Earthing	1000047626	68.14.07.382.1		4.17.1	1Cx25 sq.mm Y/G Earth Cable	Metre	425	Rev. B		
62	Earthing	1000047627	68.14.07.392.1		4.17.1	1Cx70 sq.mm Y/G Earth Cable	Metre	1200	Rev. B		
63	Earthing	1000048060	68.78.90.426.1		4.17.1	Branch Connector suitable for 70/70 sq.mm	Each	10	Rev. A		
64	Earthing	1000048059	68.78.90.422.1		4.17.1	Branch Connector suitable for 70/25 sq.mm	Each	65	Rev. A		
65	Earthing	1000780669	--		4.17.1	Earthing Terminal Lugs 1Cx70 sq.mm Cable (Y/G)	Each	10	Rev. A		
66	Earthing	1000780666	--		4.17.1	Earthing Terminal Lugs 1Cx25 sq.mm Cable (Y/G)	Each	65	Rev. A		
67	Earthing	1000047994	68.77.02.126.9		4.17.1	Earth Boss	Each	55	Rev. A		
68	Earthing	1000048555	68.85.12.419.1		4.16.1	Electrical Insulation Tape Yellow, 6 Metre/Roll	Roll	2	Rev. A		
						STEEL EARTH PIT AS PER DRG. (STD-4-0310-001-4-F)					
69	Earthing	1000048666	68.89.20.148.9		4.17.1	Earth Inspection Pit, Steel housing & Cover	Each	6	Rev. B		
70	Earthing	1000707169	--		4.17.1	Extensible earth rod, Dia 15mm x LG 1220mm	Each	72	Rev. B		
71	Earthing	1000707154	--		4.17.1	Coupling screw, p-bz outer thread for 15mm	Each	66	Rev. B		
72	Earthing	1000707153	--		4.17.1	Steel driving cap, hardened, allow	Each	6	Rev. B		
73	Earthing	1000707170	--		4.17.1	Tips, Hardened steel for 15mm driving tip	Each	6	Rev. B		
74	Earthing	1000047990	68.77.02.078.1		4.17.1	70 sq.mm two way through clamp	Each	6	Rev. B		
75	Earthing	1000048060	68.78.90.426.1		4.17.1	Branch connector 70/70 sq.mm	Each	6	Rev. B		
76	Earthing	1001178461	--		4.17.1	Marconite	Pocket	24	Rev. B		
						EARTHING BUSBAR AS PER DRG. (STD-4-0303-001-4-D)					
77	Earthing	1000045040	67.28.36.188.1		4.17.1	950mm x 50mm x 10mm thick copper bar	Each	3	Rev. A		
78	Earthing	1000062976	81.26.25.112.1		4.17.1	M10 X 100mm Long rawlbolt or equal	Each	6	Rev. A		
79	Earthing	1000062970	81.04.62.188.1		4.17.1	M10 x 40mm Long brass nut and bolt	Each	60	Rev. A		
80	Earthing	--	81.78.06.160.1		4.17.1	M10 Brass washer	Each	60	Rev. A		
81	Earthing	1000524103	74.13.08.026.1		4.17.1	25mm Dia galvanised line pipe	Metre	1.5	Rev. A		
						EARTHING DETAILS GATE & FENCE AS PER DRG. (STD-4-0306-001-4-D)					
82	Earthing	1000069880	68.01.23.052.9		4.17.1	Flexible Braid Jumper Burndy Type BG-12	Metre	15	Rev. B		
83	Earthing	1000047993	68.77.02.106.9		4.17.1	Burndy Type GK 1826 earth clamp	Each	35	Rev. B		
84	Earthing	1000973324	74.86.05.215.1		4.17.1	25mm Heavy gauge PVC Pipe	Metre	28	Rev. A		
85	Earthing	1000049087	70.32.65.025.1		4.17.1	25mm Saddle	Each	55	Rev. A		
86	Earthing	1000063796	81.41.17.018.1		4.17.1	M10 Carbon Steel Nut	Each	16	Rev. A		
						EARTHING DETAILS FENCE POST AS PER DRG. (STD-4-0308-001-4-D)					
87	Earthing	1000973325	68.77.02.106.1		4.17.1	Burndy Type GK 1826 earth clamp	Each	35	Rev. B		

Project Number: PAIP00405
WBS Number: NIM.IN.09.011

WorleyParsons Arabian Industries JV
Material Take Off

Project Title: Nimr Sludge Pit System Upgrade
Disc:Electrical
MTO Rev #:B

Serial Number	Type	SAP #	MESC #	WPAI Spec #	AVME #	Description	UOM	Total Quantity	Rev #	Additional Qty. to be Procured	Remarks
88	Earthing	1000063796	81.41.17.018.1		4.17.1	M10 Carbon Steel Nut	Each	35	Rev. B		
89	Earthing	1000062587	78.39.10.104.1		4.17.1	12mm Round MS Bar	Metre	35	Rev. B		
90	Junction Box	--	--		4.16.6	Electrical Junction Box consists of 8 nos of 240 sq.mm terminal blocks, 8 nos of 50 sq.mm terminal blocks & 1x70 sq.mm + 2x25 sq.mm earth terminal blocks suitable for Hazardous area	Each	1	Rev. A		PAIP00405/RQ/402
91	Junction Box	--	--		4.16.6	Electrical Junction Box consists of 8 nos of 10 sq.mm terminal blocks, 8 nos of 2.5 sq.mm terminal blocks & 1x25 sq.mm + 3x2.5 sq.mm earth terminal blocks suitable for Hazardous area	Each	10	Rev. B		PAIP00405/RQ/402
92	Lighting Pole	1000048607	--		4.19.9	Flood Lighting Pole as Drg. STD-4-0203-001, 10M, Height Stepped Steel pole	Each	8	Rev. A		
93	Lighting Pole		--		4.19.5	Lighting Pole Type-5 as Drg. STD-4-0207-002	Each	2	Rev. A		
94	Lighting	1090000515	--		4.19.9	Flood Light Crossarm for 2-Way flood light bracket as Drg. STD-4-0205-001	Each	8	Rev. A		
95	Lighting	1000326313	69.61.22.250.9		4.19.5	250W Floodlight fitting complete with control gear and p.f improvement capacitor with H.P Sodium vapour lamp	Each	16	Rev. A		
96	Lighting	1090003156	--		4.19.5	2x36W Flourescent Light fittings, EEXe IP-55, normal type, Pole mounted	Each	2	Rev. A		
97	RCU	1000046061	67.92.61.130.1		4.11.3	Remote control unit 50/1A CT Operated 0-30A Ammeter	Each	2	Rev. B		
98	RCU	1000070070	67.92.61.104.1		4.11.3	Remote control unit 5/1A direct Ammeter 0-5A (RCU shall be suitable for 7Cx2.5 sq.mm Incoming cable & 3Cx2.5 sq.mm Outgoing cable) including 2 nos of M20 glands.	Each	2	Rev. A		
						INSTALLATION MATERIALS FOR RCU AS PER DRG STD-4-0109-001-4-D					
99	Access	1000052011	74086.05.345.9		4.20	50mm Heavy Gauge PVC Pipe	Metre	2	Rev. A		
100	Access	1000052014	74.86.05.570.9		4.20	110mm Heavy Gauge PVC Pipe	Metre	2	Rev. A		
101	Access	1000145612	78.47.31.053.1		4.20	100mm x 50mm x 6mm MS Channel	Metre	8	Rev. A		
102	Access	1000542348	--		4.20	Galvanised Cable Saddle, 20mm DIA	Each	16	Rev. A		
103	Access	1000062976	81.26.25.112.1		4.20	M10 x 100mm Expanding Bolt	Each	8	Rev. A		
104	Access	1000062606	78.43.30.116.1		4.20	6mm MS Plate, size 300mm x 300mm	Each	4	Rev. A		

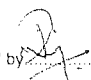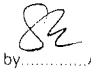
Prepared by  Checked by  Approved by 

ELECTRICAL CABLE SCHEDULE FOR
NIMR SLUDGE PITS SYSTEM UPGRADE-FED & DD

NOTES:-

- 1. CABLE LENGTH SHOWN ARE ESTIMATED FROM CABLE LAYOUT DRAWINGS.
- 2. ACTUAL ROUTE LENGTHS ARE TO BE VERIFIED AT SITE BEFORE CUTTING THE CABLE.

APPROVED FOR
CONSTRUCTION

<div><div><div>ورلي بارسونز - الصناعات العربية (مخاصة) WorleyParsons - Arabian Industries (JV)</div></div><div>CONTRACT NO.: C31/0606PROJECT NO. : PAIP-00405</div></div>						<table><tr><td></td><td></td><td></td><td></td><td></td><td></td><td></td><td></td><td></td><td></td></tr><tr><td>B</td><td>JUNE '11</td><td>Khalid</td><td></td><td></td><td></td><td>REVISED & RE-ISSUED AS AFC</td><td>IN.09.011</td><td>OSE/28N</td><td></td></tr><tr><td>A</td><td>MAY '11</td><td>Khalid</td><td>NMN</td><td>LM</td><td></td><td>APPROVED FOR CONSTRUCTION</td><td>IN.09.011</td><td>OSE/28N</td><td></td></tr><tr><td>0</td><td>SEP '10</td><td>Khalid</td><td>KD</td><td>PVT</td><td></td><td>ISSUED FOR COMMENTS</td><td>IN.09.011</td><td>OSE/28N</td><td></td></tr><tr><td>REV</td><td>DATE</td><td>DRAWN BY</td><td>CHECKED BY</td><td>APPROVED BY</td><td>DESCRIPTION</td><td>WBS. NO.</td><td>REF. ID.</td><td>SIGN.</td><td></td></tr><tr><td colspan="10">PDO APPROVAL</td></tr></table>														B	JUNE '11	Khalid				REVISED & RE-ISSUED AS AFC	IN.09.011	OSE/28N		A	MAY '11	Khalid	NMN	LM		APPROVED FOR CONSTRUCTION	IN.09.011	OSE/28N		0	SEP '10	Khalid	KD	PVT		ISSUED FOR COMMENTS	IN.09.011	OSE/28N		REV	DATE	DRAWN BY	CHECKED BY	APPROVED BY	DESCRIPTION	WBS. NO.	REF. ID.	SIGN.		PDO APPROVAL									
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						SUB AREA : SLUDGE PIT AREA NO: 05																																																															
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						DRWG. TYPE : COVER SHEET																																																															
NOTES & REFERENCE DRAWINGS						DESCRIPTION : CABLE SCHEDULE																																																															
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						DRWG AREA ENG SERIAL SHEET PROJ DWG REV.																																																															
						No. NIM 4 6413 001 DQ 3 B																																																															

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SR. No.	Description of cable					Description of run		Remarks
	Cable no.	Type	Length, m	Size, mm2	Volt. grade	From	To	
1	LV-48-6059	XLPE/SWA/PVC/CU	25	4Cx50	600/1000V	EXISTING 415V LV SWITCHBOARD FEEDER-02 AT SWTP	ELECTRICAL JUNCTION BOX 48-JB-001	B
2	LV-48-6060	XLPE/SWA/PVC/CU	1800	4Cx240	600/1000V	ELECTRICAL JUNCTION BOX 48-JB-001	DISTRIBUTION BOARD (G6951)	
3	LV-48-6061	XLPE/SWA/PVC/CU	250	3Cx16	600/1000V	DISTRIBUTION BOARD (G6951) FEEDER-1	P-48357 SLUDGE OIL TRANSFER PUMP	
4	LV-48-6062	XLPE/SWA/PVC/CU	250	7Cx2.5	600/1000V	DISTRIBUTION BOARD (G6951) FEEDER-1	RCU (P-48357)	
5	LV-48-6063	XLPE/SWA/PVC/CU	25	4Cx2.5	600/1000V	DISTRIBUTION BOARD (G6951) FEEDER-1	CONTROL (START/STOP) RTU PANEL	
6	LV-48-6064	XLPE/SWA/PVC/CU	25	4Cx2.5	600/1000V	DISTRIBUTION BOARD (G6951) FEEDER-1	INDICATION (RUNNING/STOPPED) RTU PANEL	
7	LV-48-6065	XLPE/SWA/PVC/CU	100	3Cx16	600/1000V	DISTRIBUTION BOARD (G6951) FEEDER-2	P-48358 SLUDGE OIL TRANSFER PUMP	
8	LV-48-6066	XLPE/SWA/PVC/CU	100	7Cx2.5	600/1000V	DISTRIBUTION BOARD (G6951) FEEDER-2	RCU (P-48358)	
9	LV-48-6067	XLPE/SWA/PVC/CU	25	4Cx2.5	600/1000V	DISTRIBUTION BOARD (G6951) FEEDER-2	CONTROL (START/STOP) RTU PANEL	
10	LV-48-6068	XLPE/SWA/PVC/CU	25	4Cx2.5	600/1000V	DISTRIBUTION BOARD (G6951) FEEDER-2	INDICATION (RUNNING/STOPPED) RTU PANEL	
11	LV-48-6069	XLPE/SWA/PVC/CU	100	7Cx2.5	600/1000V	DISTRIBUTION BOARD (G6951) FEEDER-4	RCU (P-48359)	
12	LV-48-6070	XLPE/SWA/PVC/CU	20	3Cx2.5	600/1000V	RCU (P-48359)	P-48359 OXYGEN SCAVENGER DOSING PUMP	
13	LV-48-6071	XLPE/SWA/PVC/CU	25	4Cx2.5	600/1000V	DISTRIBUTION BOARD (G6951) FEEDER-4	CONTROL (START/STOP) RTU PANEL	
14	LV-48-6072	XLPE/SWA/PVC/CU	25	4Cx2.5	600/1000V	DISTRIBUTION BOARD (G6951) FEEDER-4	INDICATION (RUNNING/STOPPED) RTU PANEL	
15	LV-48-6073	XLPE/SWA/PVC/CU	100	7Cx2.5	600/1000V	DISTRIBUTION BOARD (G6951) FEEDER-5	RCU (P-48360)	
16	LV-48-6074	XLPE/SWA/PVC/CU	20	3Cx2.5	600/1000V	RCU (P-48360)	P-48360 OXYGEN SCAVENGER DOSING PUMP	
17	LV-48-6075	XLPE/SWA/PVC/CU	25	4Cx2.5	600/1000V	DISTRIBUTION BOARD (G6951) FEEDER-5	CONTROL (START/STOP) RTU PANEL	
18	LV-48-6076	XLPE/SWA/PVC/CU	25	4Cx2.5	600/1000V	DISTRIBUTION BOARD (G6951) FEEDER-5	INDICATION (RUNNING/STOPPED) RTU PANEL	
19	LV-48-6077	XLPE/SWA/PVC/CU	125	2Cx6	600/1000V	DISTRIBUTION BOARD (G6951) FEEDER-10/R	ULTRASONIC FLOW METER	
20	LV-48-6078	XLPE/SWA/PVC/CU	75	4Cx10	600/1000V	DISTRIBUTION BOARD (G6951) FEEDER-11	FLOOD LIGHT POLE (FLP-2)	B
21	LV-48-6079	XLPE/SWA/PVC/CU	160	4Cx10	600/1000V	FLOOD LIGHT POLE (FLP-2)	FLOOD LIGHT POLE (FLP-3)	
22	LV-48-6080	XLPE/SWA/PVC/CU	175	4Cx10	600/1000V	FLOOD LIGHT POLE (FLP-3)	FLOOD LIGHT POLE (FLP-4)	
23	LV-48-6081	XLPE/SWA/PVC/CU	160	4Cx10	600/1000V	FLOOD LIGHT POLE (FLP-4)	FLOOD LIGHT POLE (FLP-5)	
24	LV-48-6082	XLPE/SWA/PVC/CU	250	4Cx10	600/1000V	DISTRIBUTION BOARD (G6951) FEEDER-11	FLOOD LIGHT POLE (FLP-1)	
25	LV-48-6083	XLPE/SWA/PVC/CU	160	4Cx10	600/1000V	FLOOD LIGHT POLE (FLP-1)	FLOOD LIGHT POLE (FLP-8)	
26	LV-48-6084	XLPE/SWA/PVC/CU	160	4Cx10	600/1000V	FLOOD LIGHT POLE (FLP-8)	FLOOD LIGHT POLE (FLP-7)	
27	LV-48-6085	XLPE/SWA/PVC/CU	170	4Cx10	600/1000V	FLOOD LIGHT POLE (FLP-7)	FLOOD LIGHT POLE (FLP-6)	
28	LV-48-6086	XLPE/SWA/PVC/CU	25	2Cx10	600/1000V	DISTRIBUTION BOARD (G6951) FEEDER-10/Y	RTU	
28	LV-48-6087	XLPE/SWA/PVC/CU	125	2Cx6	600/1000V	DISTRIBUTION BOARD (G6951) FEEDER-10/B	CORIOLIS FLOW METER	
30								
31								
32								
33								
34								
35								
36								
37								
38								
39								
40								

ورلي بارسونز - الصناعات العربية (محاصة)
WorleyParsons - Arabian Industries (JV)

CONTRACT NO.:C31/0606 PROJECT NO.:PAIP-00405

B	JUNE '11	Khalid			REVISED & RE-ISSUED AS AFC	IN.09.011	OSE/28N	
A	MAY '11	Khalid	NMN	LM	APPROVED FOR CONSTRUCTION	IN.09.011	OSE/28N	
0	SEP '10	Khalid	KD	PVT	ISSUED FOR COMMENTS	IN.09.011	OSE/28N	
REV	DATE	DRAWN BY	CHECKED BY	APPROVED BY	DESCRIPTION	WBS NO.	REF. IND.	SIGNATURE
								PDO APPROVAL

DRAWING CONTROL INDEX (NIM-12635-400-DQ-4)

Rev.

Date

APPROVED BY

DESCRIPTION

WBS NO.

PROJ. ENG.

PDO APPROVAL

NOTES & REFERENCE DRAWINGS

MASTER DRAWING REVISION

IN CASE OF DEVIATIONS MARKED UP PRINT SENT TO COASTAL DESIGN OFFICE

PROJECT DRAWING REVISION

IN CASE OF DEVIATIONS A MARKED UP PRINT SHALL BE SENT TO THE PROJECT ENGINEER

AREA :	NIMR	No. 05
SUB AREA :	SLUDGE PIT AREA	
DRWG. TYPE :	SCHEDULE	
DESCRIPTION :	LV CABLE SCHEDULE	

شركة تنمية نفط عُمان
PETROLEUM DEVELOPMENT OMAN

DRWG	AREA CODE	ENG SECT	SERIAL NUMBER	SHEET	PROJ CODE	DWG SIZE	REV.
No.	NIM	4	6413	003	DQ	3	B

UTILITY DATA SHEET

SR.NO.	DESCRIPTION	DRAWING NO.	REV. 0	REV. A	REV. B	REV. C
1	UTILITY DATA SHEET - 415V OUTDOOR DISTRIBUTION BOARD (G-6951)	NIM-6419-002	SEP'10	JUNE'11		

A	JUNE'11	KD			APPROVED FOR CONSTRUCTION	IN.09.011	OSE/28N	
O	SEP'10	KD	PVT	LM	ISSUED FOR COMMENTS	IN.09.011	OSE/28N	
REV	DATE	PPD. BY	CHK'D BY	APPRD. BY	DESCRIPTION	WBS NO.	PROJ.ENG.	SIGN.
							PDO APPROVAL	
PROJECT DRAWING REVISION								
IN CASE OF DEVIATIONS, MARKED UP PRINT SHALL BE SENT TO PROJECT ENGINEER								
AREA : NIMR								
SUB AREA : SLUDGE PIT FACILITY					5			
DRWG. TYPE : UTILITY DATA SHEET								
DESCRIPTION: UTILITY DATA SHEET FOR 415V LV OUTDOOR DB								
DRWG.	AREA CODE	ENGG. SECT.	SERIAL NUMBER	SHEET	PROJ CODE	DRG SIZE	REV	
NO.	NIM	4	6419	001	DQ	A3	A	

ورلي بارسونز - الصناعات العربية (محاصة)
WorleyParsons - Arabian Industries (JV)

CONTRACT NO. C31/0606 PROJ.NO. PAIP00405

1. DRAWING CONTROL INDEX	REV	DATE	APPROVED BY	DESCRIPTION	WBS NO.	PROJ.ENG.	SPEC.ENG.
MAR-1-2635-400-DQ							

NOTES / REFERENCE DRAWINGS


MASTER DRAWING REVISION

IN CASE OF DEVIATIONS, MARKED UP PRINT SHALL BE SENT TO COASTAL DESIGN OFFICE

شركة تنمية نفط عمان
Petrochem Development Oman

PLC CONTROL PANEL
LCP-01

BUSBAR 3P4W 415V 50Hz 200A (10KA)

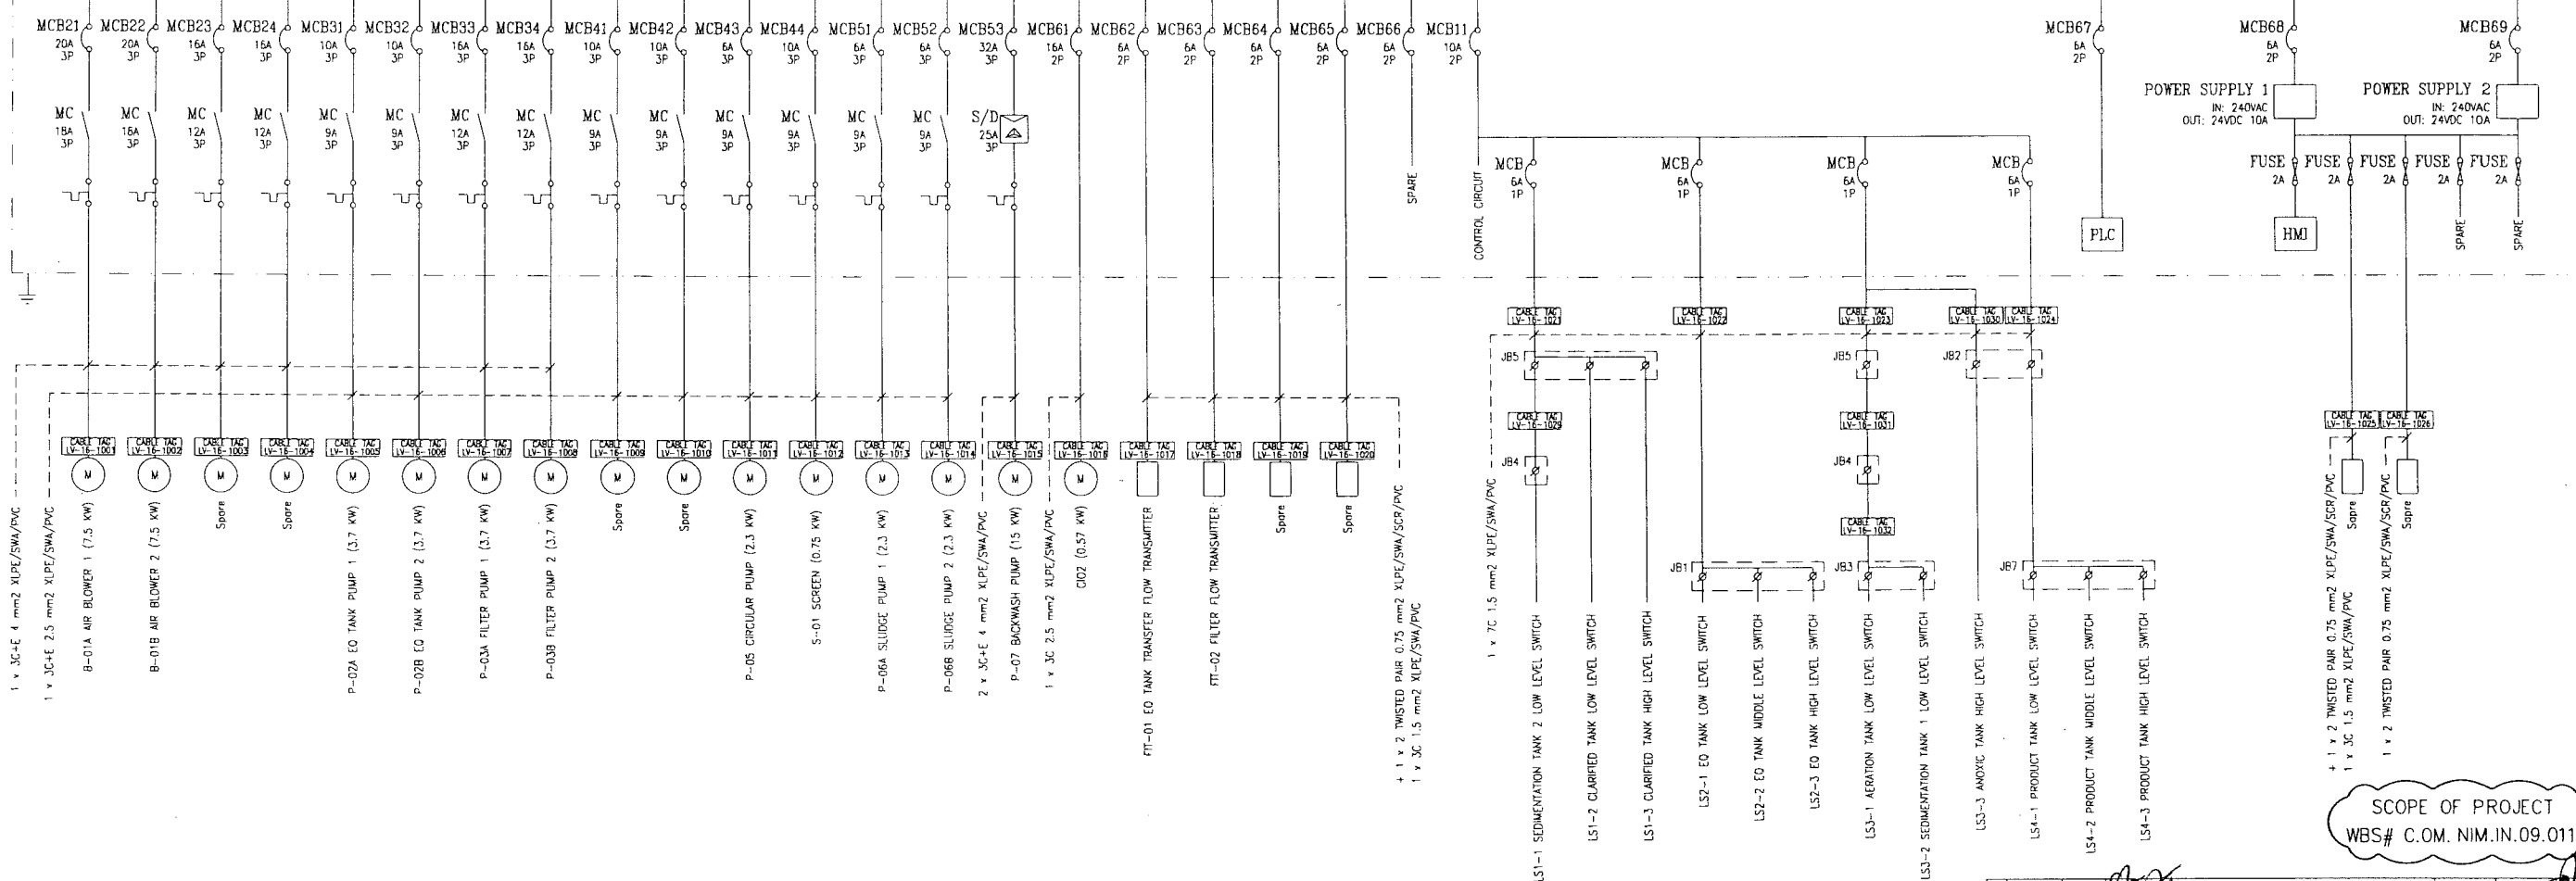

APPROVED FOR
CONSTRUCTION




WorleyParsons - Arabian Industries (JV)

SCOPE OF PROJECT
WBS# C.O.M. NIM.IN.09.011

CABLE SCHEDULE				DRAWING CONTROL INDEX				REFERENCE DRAWINGS			
NIM	4	6413	1/3 DO 3	NIM	4	2635	400 DO 4	NIM	4	2801	001 DO 1
DATE	9/3/10	APPROVED BY		DATE	9/3/10	APPROVED BY		DATE	9/3/10	APPROVED BY	
1. THE FEEDER 02 SHALL BE USED FOR FEEDING THE NEW DB LOCATED IN SLUDGE PIT AREA.				AS BUILT FOR PROJECT				MASTER DRAWING REVISION			
NOTES				IN CASE OF DEVIATIONS MARKED UP PRINT SHALL BE SENT TO COASTAL DESIGN OFFICE				IN CASE OF DEVIATIONS A MARKED UP PRINT SHALL BE SENT TO THE PROJECT ENGINEER			

B	JUNE '11	Khalid		REVISED & RE-ISSUED AS AFC	IN.09.011	OSE/2BN	
A	MAY '11	AB	NIMN	APPROVED FOR CONSTRUCTION	IN.09.011	OSE/2BN	
D	SEP '10	Khalid	KD	ISSUED FOR COMMENTS	IN.09.011	OSE/2BN	
REV	DATE	DRAWN BY	CHECKED BY	APPROVED BY	DESCRIPTION	WBS NO	PROJ. ENG. SIGNATURE
						F D C APPROVAL	
PROJECT DRAWING REVISION							
IN CASE OF DEVIATIONS A MARKED UP PRINT SHALL BE SENT TO THE PROJECT ENGINEER							
AREA : NIMR				SCALE : 1 : 1 CAD DRAWING			
SUB AREA : CONTRACTOR'S CAMP NIMR				NO. 16			
DRWG. TYPE : SINGLE LINE DIAGRAM				شركة تنمية نفط عمان Petroleum Development Oman			
DESCRIPTION : SINGLE LINE DIAGRAM FOR LCP-01				DRWG. AREA CODE ENG. SECT. SERIAL NUMBER SHEET PROJECT DRWG. NO. REV. NO. NIM 4 2801 001 DO 1 B			

Single Line Diagram

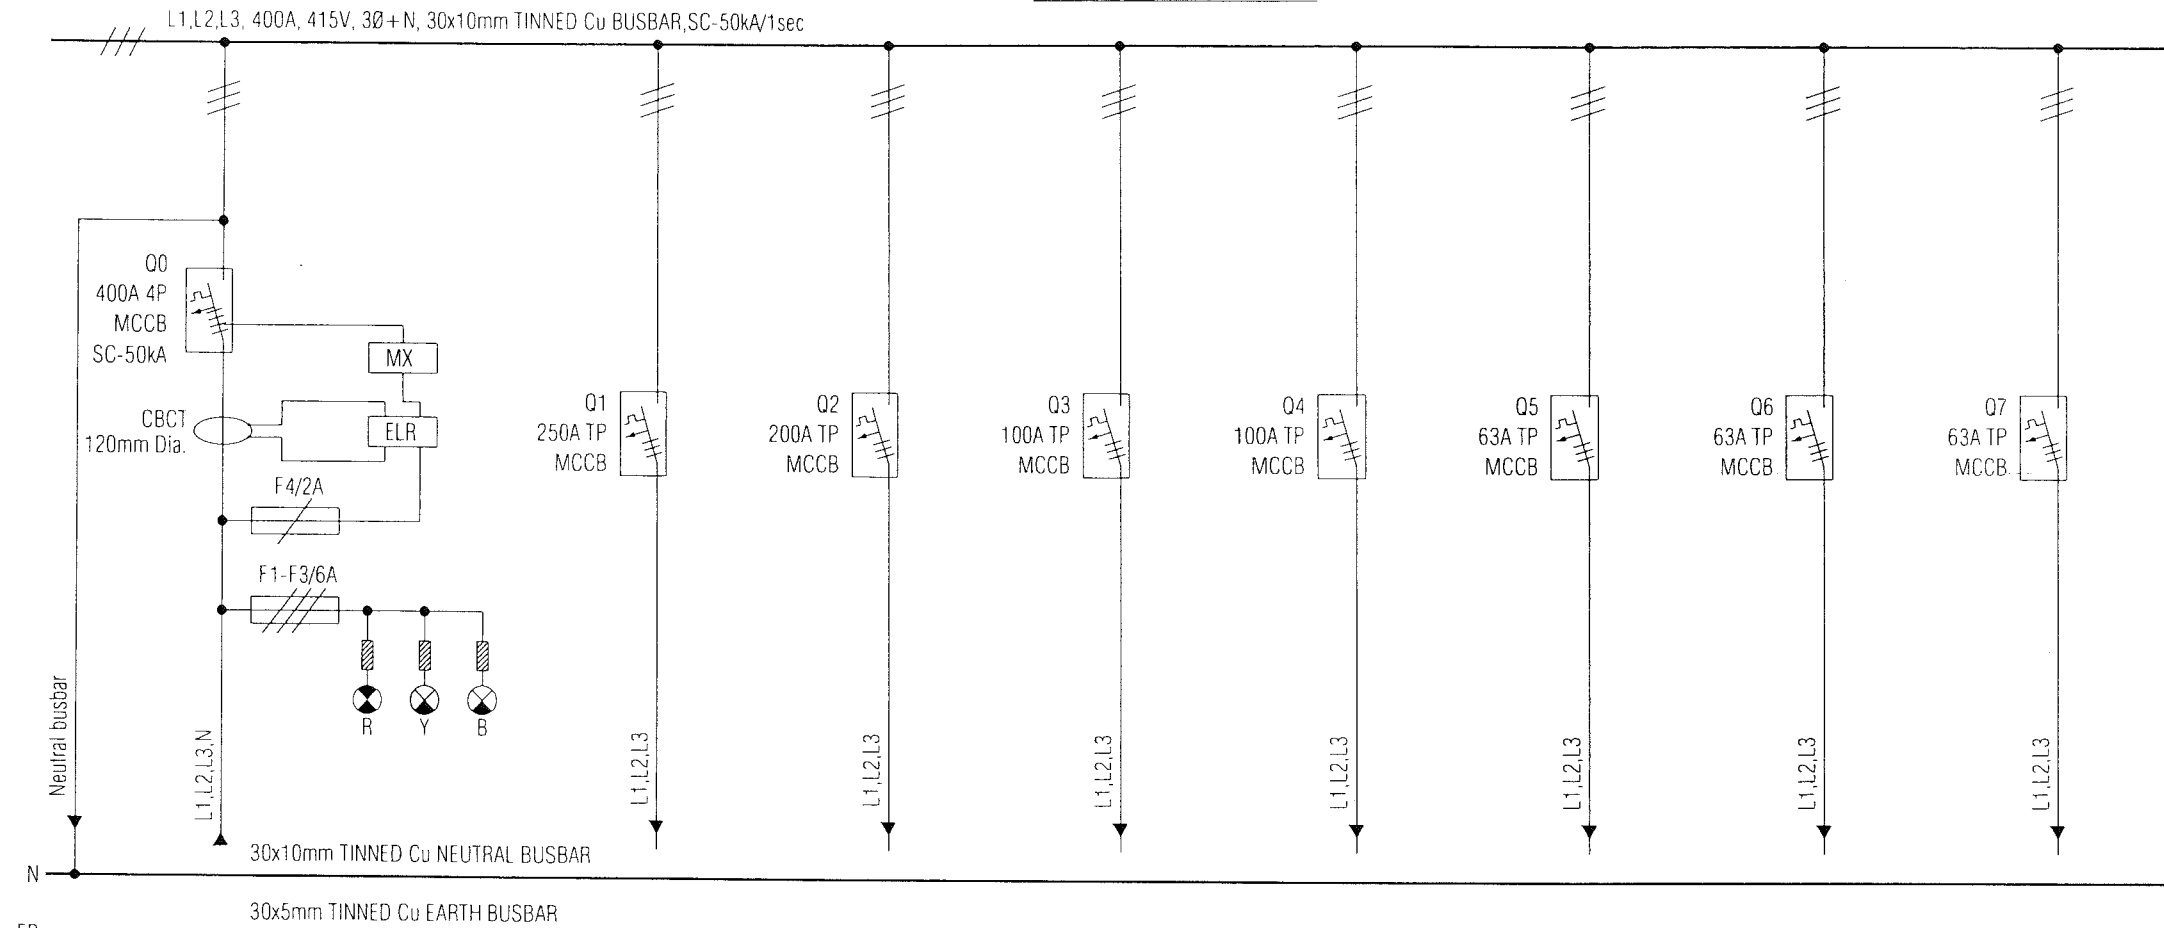

FEEDER NO	Q0	Q1	Q2	Q3	Q4	Q5	Q6	Q7
DESCRIPTION	INCOMING SUPPLY	LCP-1	48-JB-001	SPARE	DB-3	LIGHTING DB INSIDE CONTROL ROOM	SPARE	SPARE
RATING/KW	-	-	-	-	-	-	-	-
MCCB RATING	400A, 4P MCCB O/C&S/C Release	250A TP MCCB O/C&S/C Release	200A TP MCCB O/C&S/C Release	100A TP MCCB O/C&S/C Release	100A TP MCCB O/C&S/C Release	63A TP MCCB O/C&S/C Release	63A TP MCCB O/C&S/C Release	63A TP MCCB O/C&S/C Release
CABLE TAG & SIZE	LV-16-1029 4Cx120 Sq mm.	LV-16-1027 4Cx95 Sq mm.	LV-48-6059 4Cx50 Sq mm.	-	-	-	-	-

APPROVED FOR CONSTRUCTION

SCOPE OF PROJECT
WBS# CO.OM.NIM.IN.09.011

3. 4Cx240 Sq.mm. LV CABLE SHALL BE LAID FROM JUNCTION BOX 48-JB-001 LOCATED NEAR MDB-1 TO DISTRIBUTION BOARD LOCATED AT SLUDGE PIT AREA.
2. 4Cx50 Sq.mm. LV CABLE SHALL BE CONNECTED FROM FEEDER Q2 TO JUNCTION BOX 48-JB-001.
1. ALL DIMENSIONS ARE IN MILLIMETRES, ELEVATIONS & CO-ORDINATES ARE IN METRES.

DESCRIPTION	DRAWING NUMBER	REV	DATE	APPROVED BY	DESCRIPTION	WBS NO.	PROJ. ENG.	SPEC. ENG.	PDD APPROVAL
SINGLE LINE DIAGRAM	NIM 4 6411	001	DO 1						
CABLE SCHEDULE	NIM 4 6413	1/3	DO 3						
DRAWING CONTROL INDEX	NIM 1 2635	400	DO 4						


REFERENCE DRAWINGS

MASTER DRAWING REVISION
IN CASE OF DEVIATIONS MARKED UP PRINT SHALL BE SENT TO COASTAL DESIGN OFFICE

CONTRACT NO : C31/0606 PROJ. NO. : PAIP-00405
WorleyParsons - Arabian Industries (JV)


A		MAY '11		AS		APPROVED FOR CONSTRUCTION		IN.09.011		OSE /ZBN		A					
0		SEP '10		Khalid		KD		AB		ISSUED FOR COMMENTS		IN.09.011		OSE /ZBN		A	
REV		DATE		DRAWN BY		TEAM		JENG		DESCRIPTION		WBS NO		PROJ. ENG.		SIGNATURE	
								CHECKED						P.D.O. APPROVAL			
PROJECT DRAWING REVISION																	
IN CASE OF DEVIATIONS A MARKED UP PRINT SHALL BE SENT TO THE PROJECT ENGINEER																	
AREA		SOUTH OMAN NIMR															
SUB AREA		CONTRACTOR'S CAMP NIMR										NO. 16		شركة نفط عمان			
DRWG. TYPE		MDB															
DESCRIPTION		SINGLE LINE DIAGRAM OF MDB															
SCALE : NTS		CAD DRAWING															
0		1 2 3 4															
Petrochem Development Oman		شركة نفط عمان															
DRWG.		AREA CODE		ENG. SECT		SERIAL NUMBER		SHEET		PROJ. ENG.		DWG. CODE		REV.			
NO		NIM 4		2815		002 DO		3		A							

FROM MDB-1
LOCATED AT SEWAGE TREATMENT PLANT
REF. DRG. NIM-4-2801-001-DO

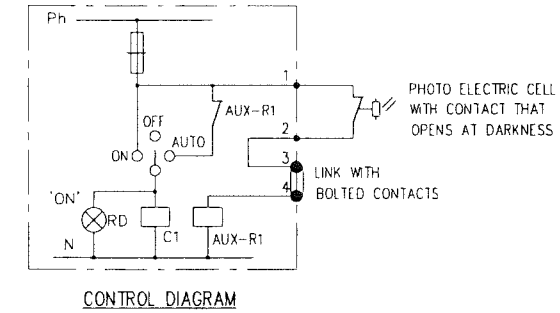

- LEGEND
- MCCB, 4P (MOULDED CASE CKT. BREAKER)
 - ON LOAD ISOLATING SWITCH
 - FUSE
 - CABLE GLAND (HAWKE TYPE 153 OR EQUIVALENT APPROVED)
 - EARTH LEAKAGE MONITOR
 - MCB + RCD
 - CONTACTOR WITH OVERLOAD RELAY
 - CURRENT TRANSFORMER 3 NOS.
 - CURRENT TRANSFORMER 1 NO.
 - JUNCTION BOX

DISTRIBUTION BOARD-G6951
LOCATION: SLUDGE PIT AREA

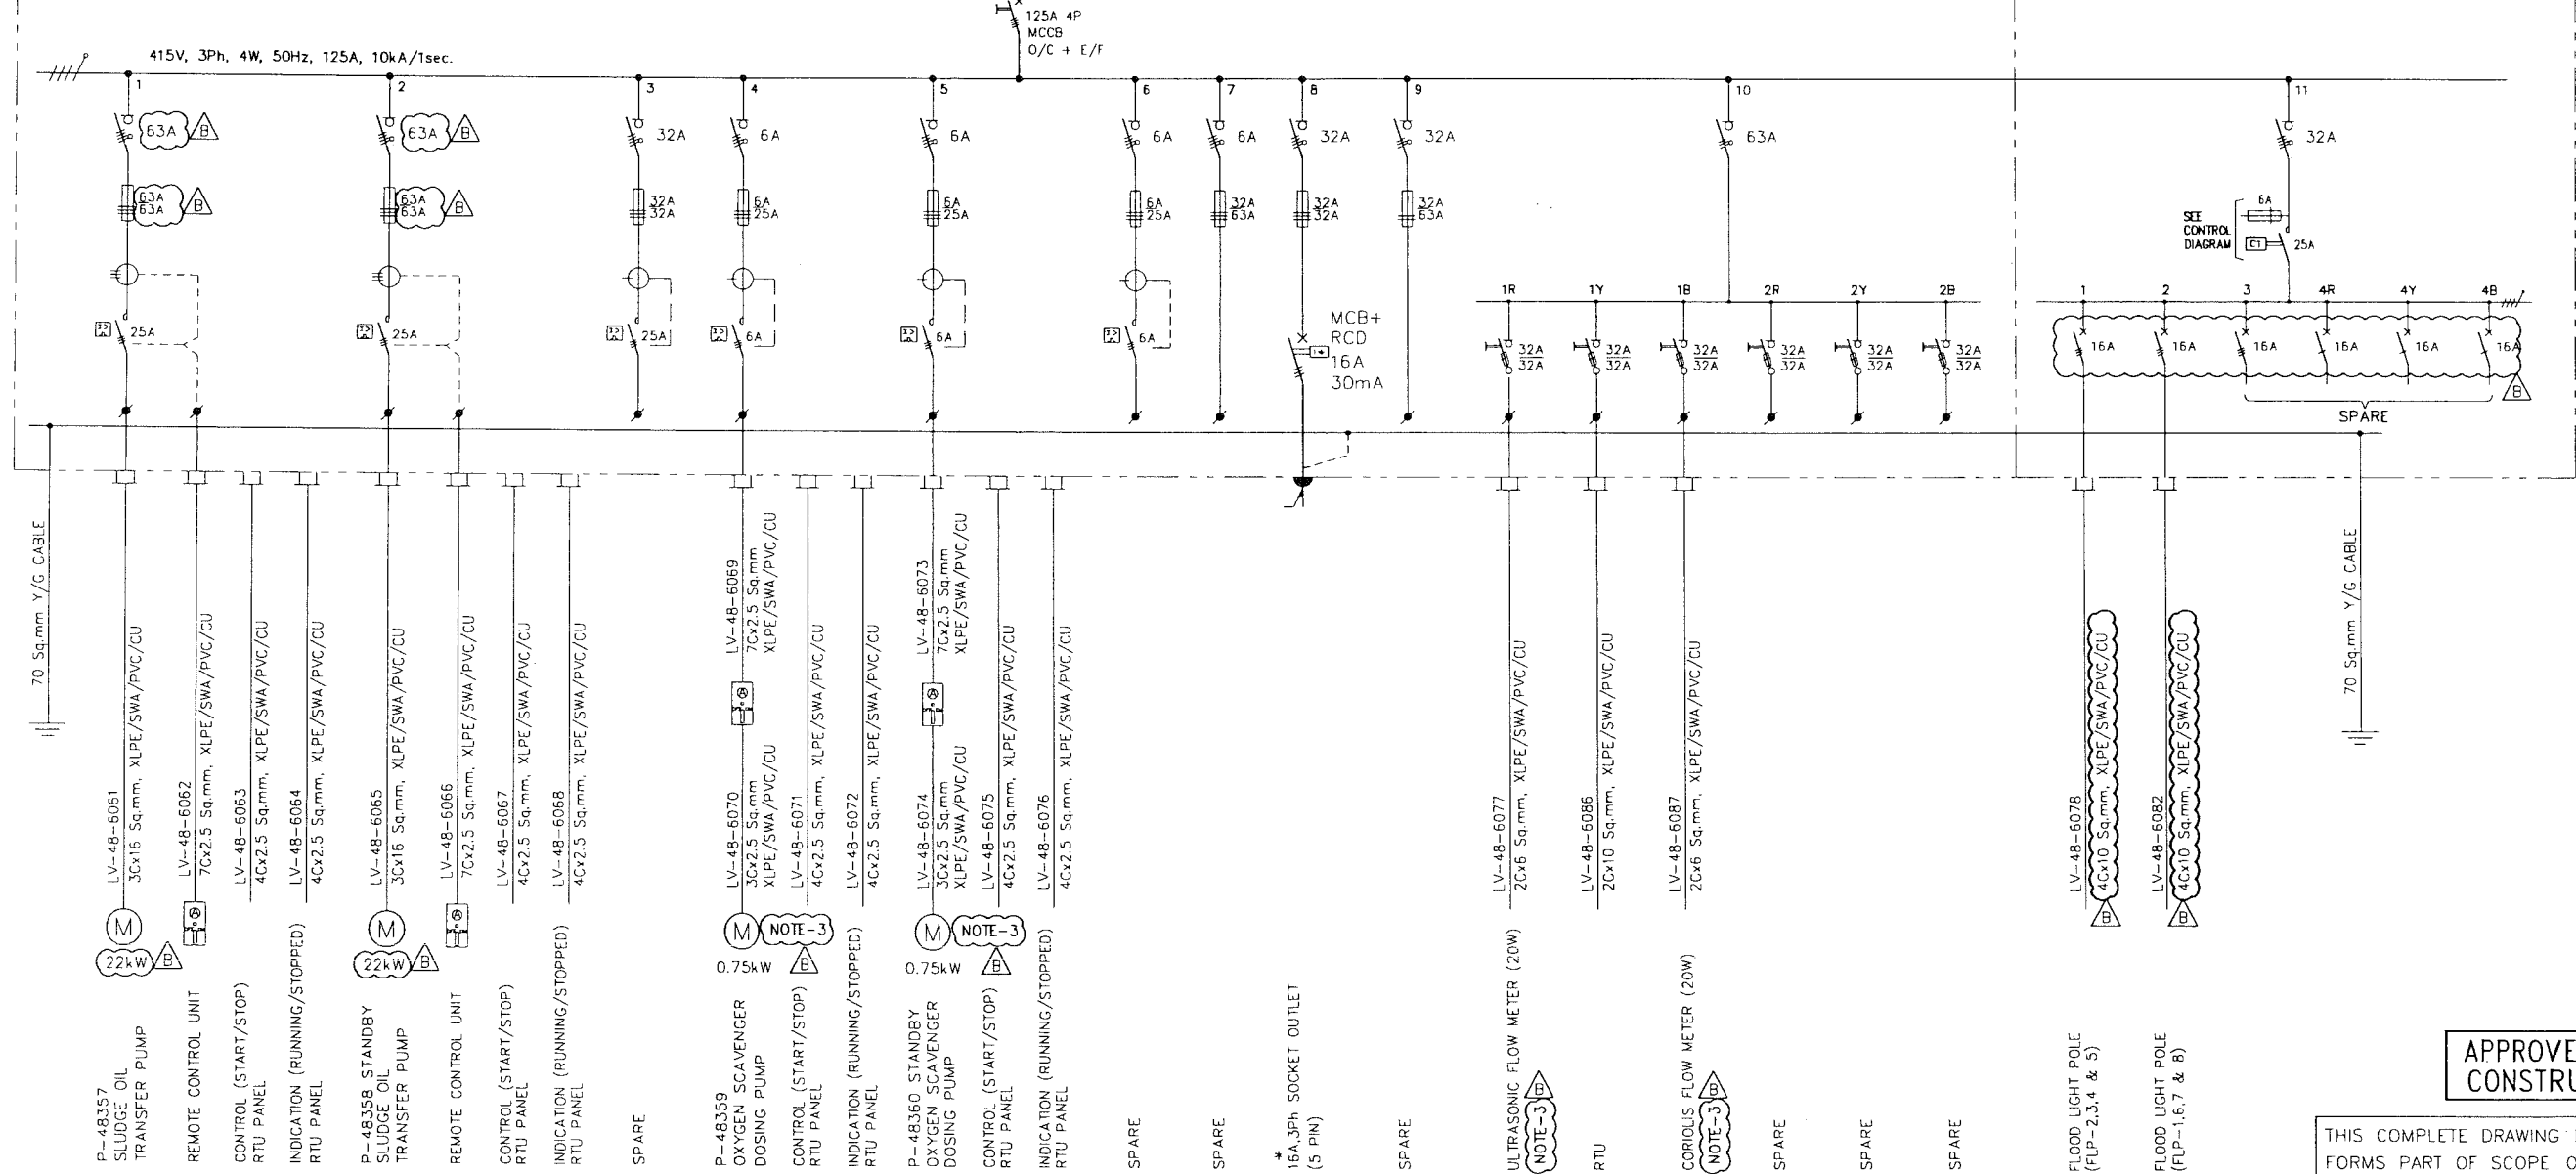

APPROVED FOR
CONSTRUCTION

THIS COMPLETE DRAWING IS NEW AND
FORMS PART OF SCOPE OF PROJECT
WBS# C.O.M. NIM.IN.09.011

* SOCKET OUTLETS SHALL BE
MOUNTED ON THE SIDE OF THE PANEL
AND WIRED BY THE VENDOR.



CONTRACT NO: C31/0606 PROJ NO: PAIP-00405

REV	DATE	BY	CHKD	APPROVED	DESCRIPTION	WBS NO.	PROJ. ENG.	SIGNATURE
B	June '11	Khalid			REVISED & RE-ISSUED AS AFC	IN.09.011	OSE/ZBN	
A	MAY '11	AB	NMN	LM	APPROVED FOR CONSTRUCTION	IN.09.011	OSE/ZBN	
0	SEP '10	Khalid	KD	PVT	ISSUED FOR COMMENTS	IN.09.011	OSE/ZBN	

3. kW RATING IS ON HOLD DUE TO UNAVAILABLE OF VENDOR DATA.
4. THE RATING OF FUSE, CONTACTOR AND SWITCHES INDICATED ON MOTOR FEEDER ARE INDICATIVE. THE SAME SHALL BE
FINALIZED BY VENDOR ON TYPE-2 CO-ORDINATION.
5. THE INCOMING CABLE SIZE TO THIS DISTRIBUTION BOARD IS 4Cx240 Sq.mm XLPE/SWA/PVC/CU CABLE
SO VENDOR TO PROVIDE SUITABLE TERMINAL FOR TERMINATING THIS CABLE.


SLD - MAIN DISTRIBUTION BOARD
CABLE SCHEDULE
DRAWING CONTROL INDEX

NIM	4	2815	002	DO	3
NIM	4	6413	1/3	DO	3
NIM	1	2635	400	DO	4

REFERENCE DRAWINGS
MASTER DRAWING REVISION
IN CASE OF DEVIATIONS MARKED UP PRINT SHALL BE SENT TO COASTAL DESIGN OFFICE

AREA : NIMR
SUB AREA : SLUDGE PIT FACILITY
NO. 05
ELEC. SINGLE LINE DIAGRAM
DISTRIBUTION BOARD

SCALE :
Petroleum Development Oman
NIM 4 6411 001 DO 1 B

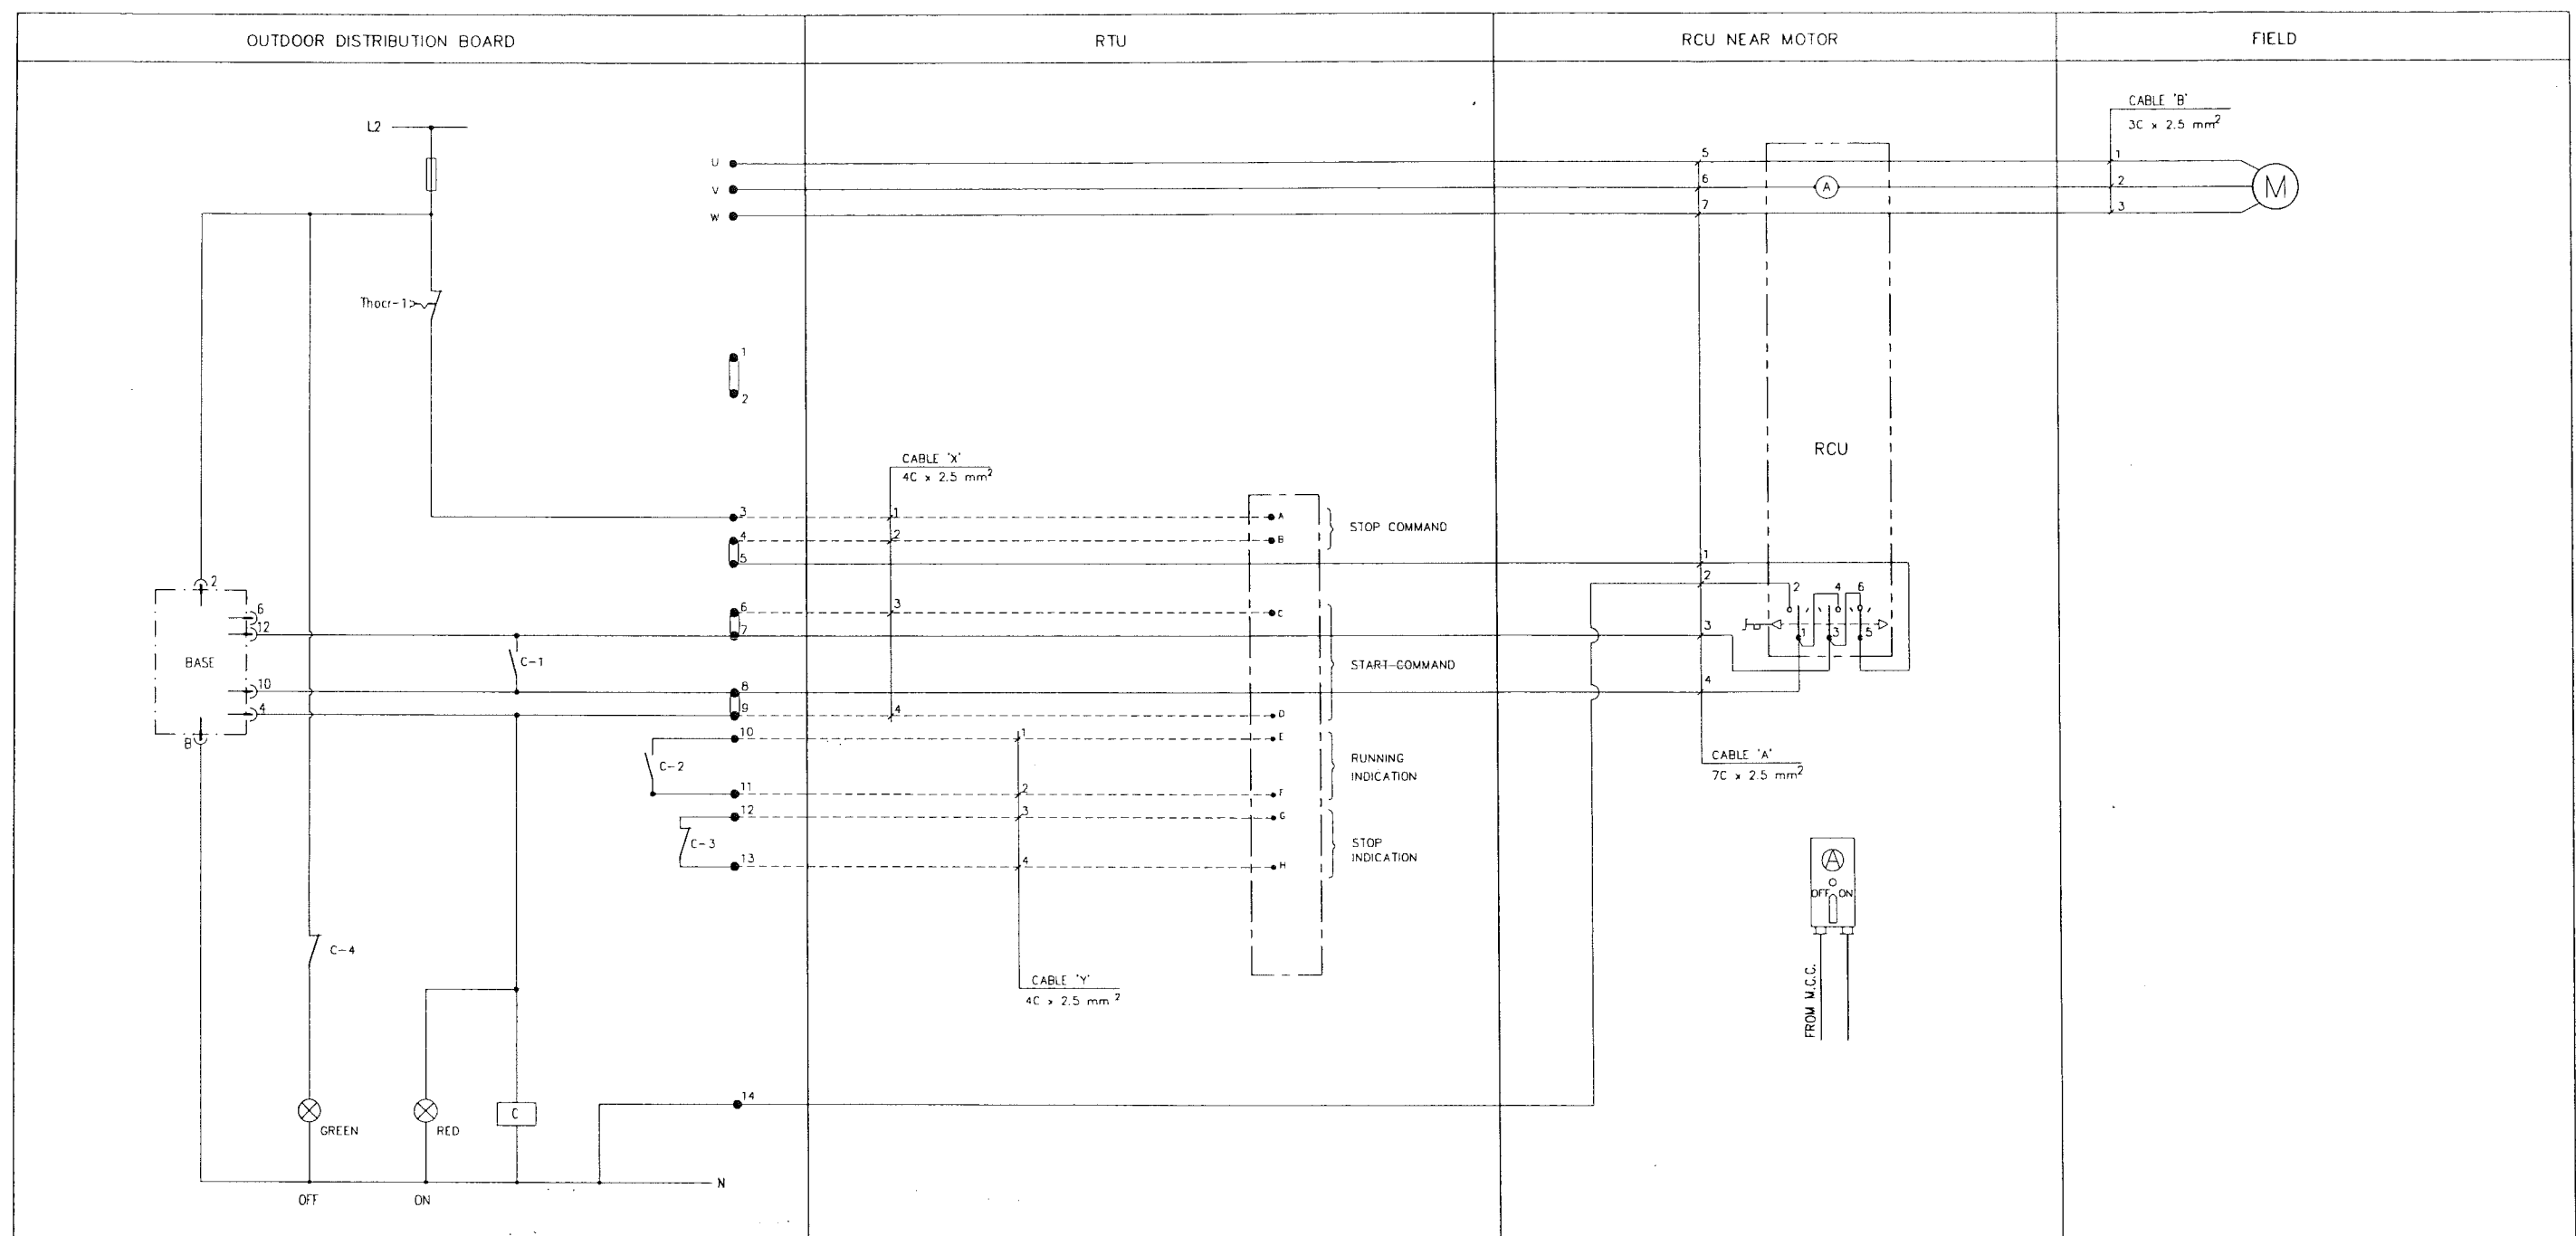

MOTOR (EQUIPMENT) No.	kW	MAIN PUMP	PANEL MODULE No.	CABLE 'A'		CABLE 'B' No.	CABLE 'X'				CABLE No.	CABLE 'Y'				
				CABLE SIZE	CABLE No.		CABLE No.	TERMINAL NUMBERS				TERMINAL NUMBERS				
								A	B	C		D	E	F	G	H
OXYGEN SCAVENGER DOSING PUMP MOTOR	0.37	P-48359	4	3Cx2.5	LV-48-6069	LV-48-6070	LV-48-6071	*	*	*	*	LV-48-6072	*	*	*	*
OXYGEN SCAVENGER DOSING PUMP MOTOR	0.37	P-48360	5	3Cx2.5	LV-48-6073	LV-48-6074	LV-48-6075	*	*	*	*	LV-48-6076	*	*	*	*

* TERMINAL NUMBERS BY C&A FOR DETAILS REF. DRG. NO. NIM-5-4745-xxx-DO

APPROVED FOR
CONSTRUCTION

THIS COMPLETE DRAWING IS NEW AND
FORMS PART OF SCOPE OF PROJECT
WBS# C.O.M. NIM.IN.09.011

REV.	DATE	BY	CHKD	APPROVED	DESCRIPTION	WBS NO.	PROJ. ENG.	SIGNATURE
A	MAY '11	AB			APPROVED FOR CONSTRUCTION	IN.09.011	OSI/28N	
D	SEPT. '09	Kholid	MD	PM	ISSUED FOR COMMENTS	IN.09.011	OSI/28N	

PROJECT DRAWING REVISION

IN CASE OF DEVIATIONS A MARKED UP PRINT SHALL BE SENT TO THE PROJECT ENGINEER

AREA : NIMR

SUB AREA : SLUDGE PIT FACILITY

SCALE : N.T.S.

NO. 05

DESCRIPTION : ELECTRICAL CONTROL DIAGRAM

DESCRIPTION : LV MOTOR (5.5kW & BELOW)

CONTRACT NO. : C31/0606

PROJ. NO. : PAIP 00405

WorleyParsons - Arabian Industries (JV)

WBS NO.

PROJ. ENG.

SPEC. ENG.

PROJ. APPROVAL

NO. NIM 4 6421 001 DO 1 A


CABLE SCHEDULE	DESCRIPTION	AREA	SERIAL	SPL	F	REV.	DATE	APPROVED BY	DESCRIPTION	WBS NO.	PROJ. ENG.	SPEC. ENG.	PROJ. APPROVAL
NIM 4 6413 1/3 DO 3													
NIM 1 2635 400 DO 4													

NOTES

REFERENCE DRAWINGS

MASTER DRAWING REVISION

IN CASE OF DEVIATIONS MARKED UP PRINT SHALL BE SENT TO COASTAL DESIGN OFFICE

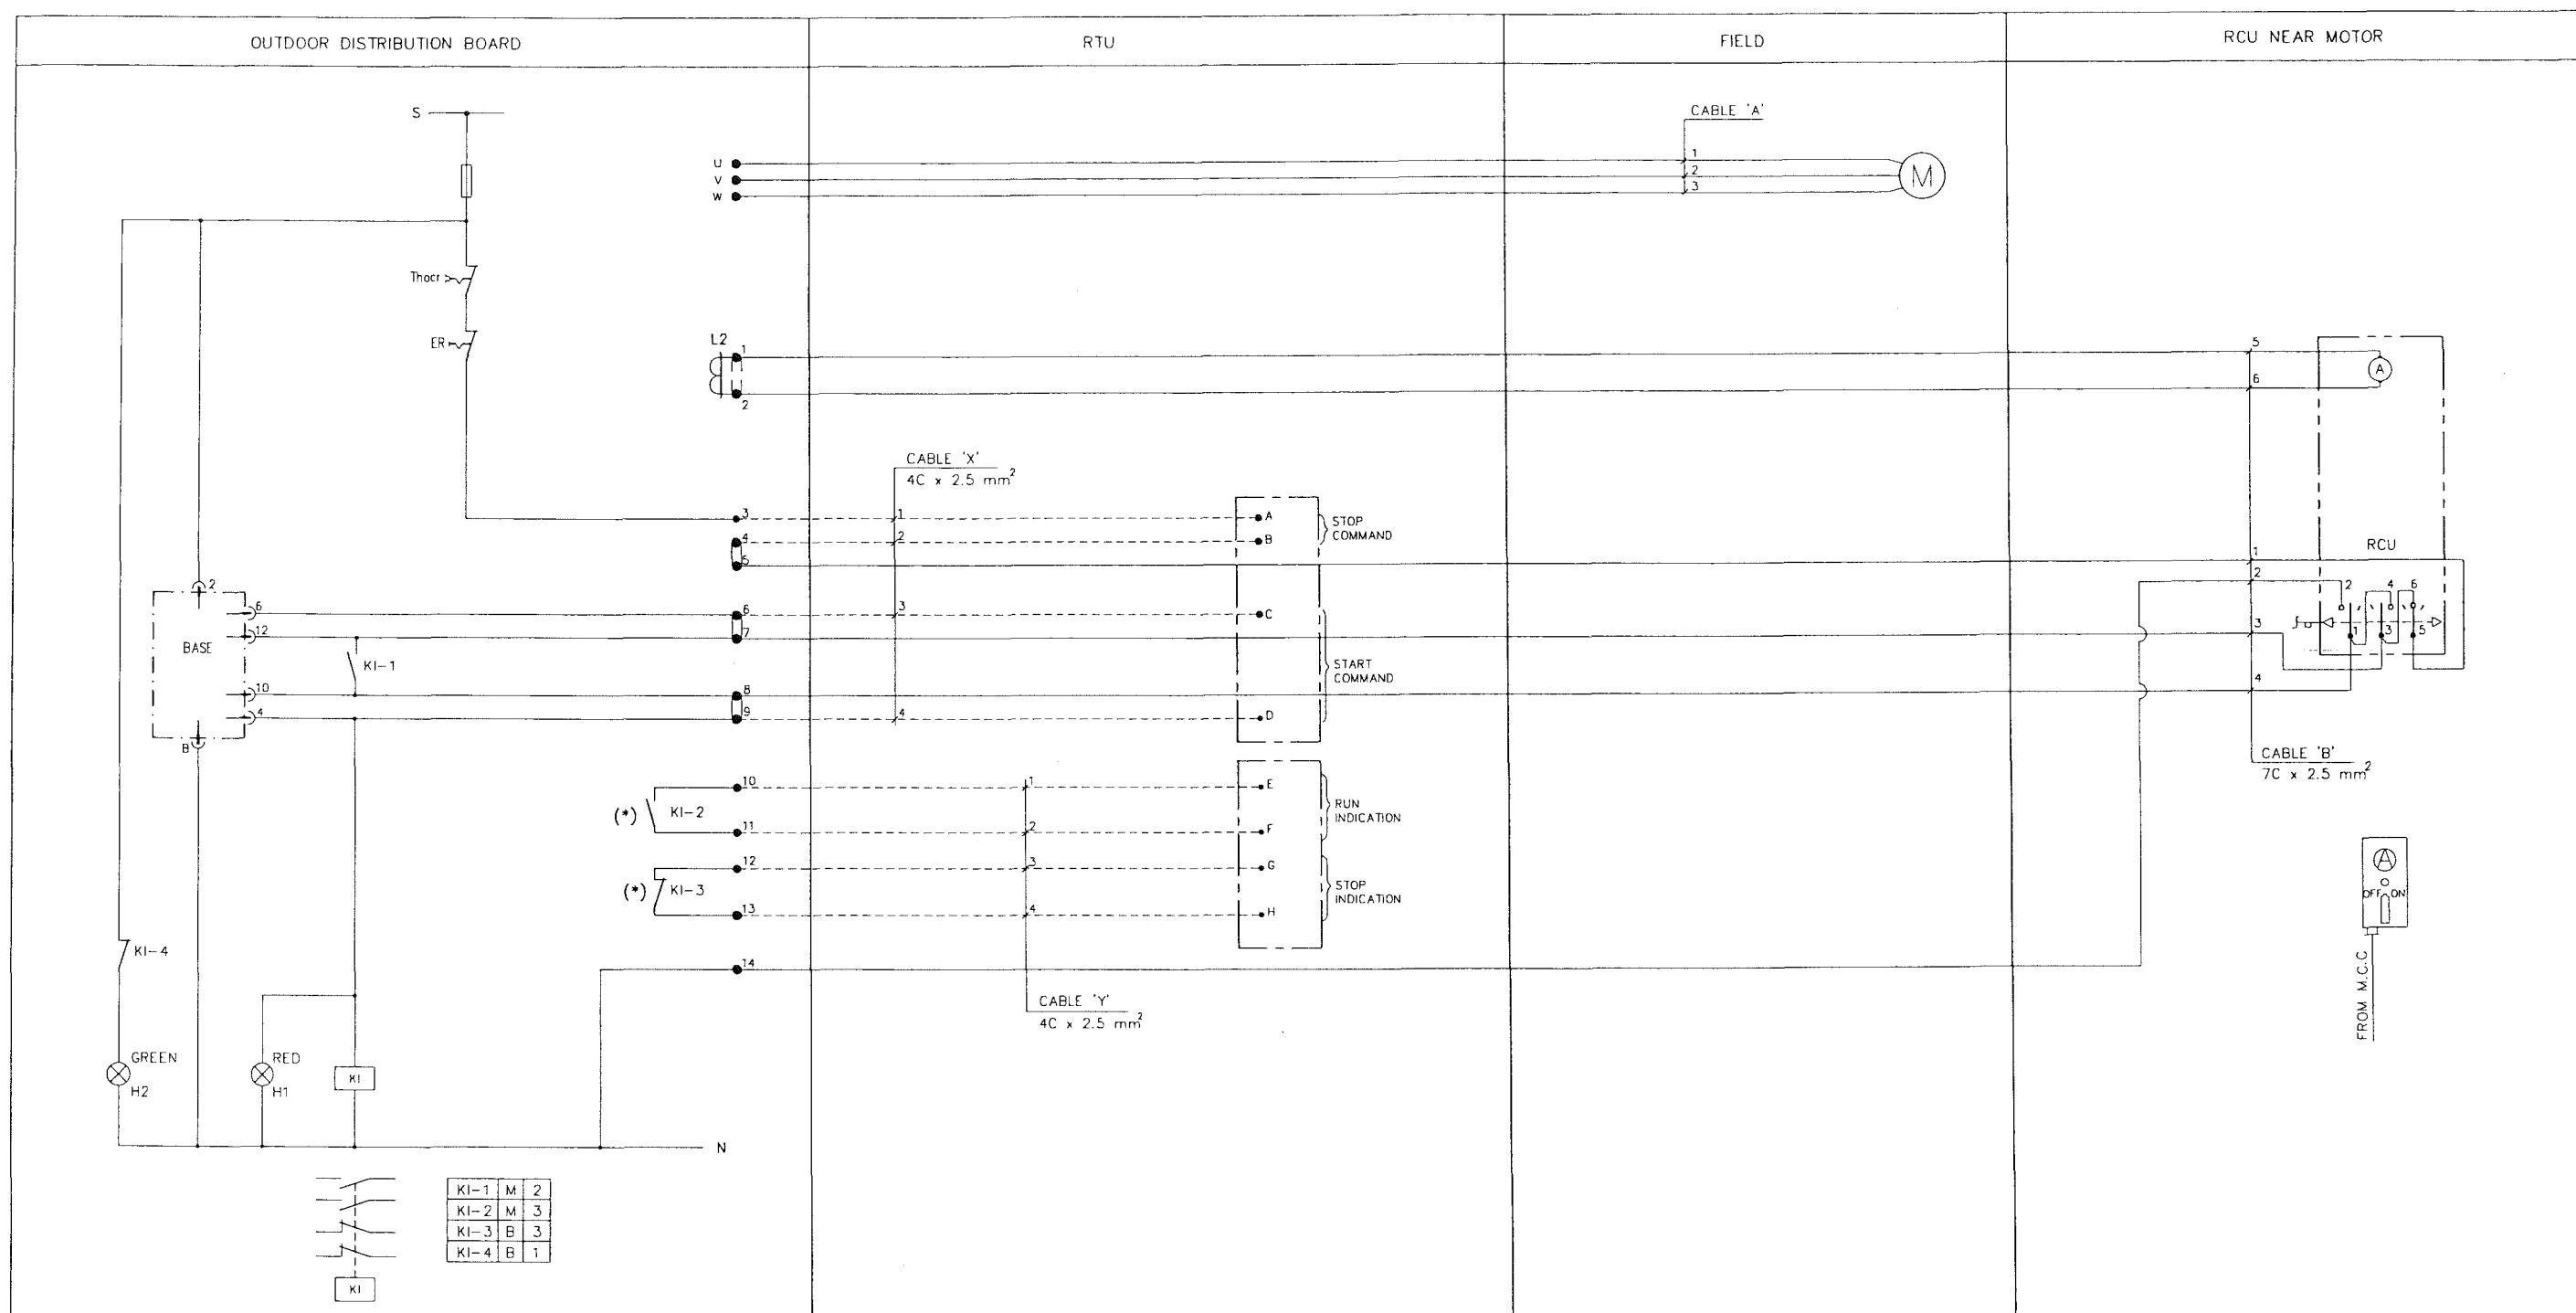


MOTOR (EQUIPMENT) No.	kW	MAIN PUMP	PANEL MODULE No.	CABLE 'A'		CABLE 'B' No.	CABLE 'X'				CABLE No.	CABLE 'Y'				
				CABLE SIZE	CABLE No.		CABLE No.	TERMINAL NUMBERS L2				CABLE No.	TERMINAL NUMBERS			
								A	B	C			D	E	F	G
SLUDGE OIL TRANSFER PUMP	13	P-48357	1	3C x 16	LV-48-6061	LV-48-6062	LV-48-6063	*	*	*	*	LV-48-6064	*	*	*	*
SLUDGE OIL TRANSFER PUMP	13	P-48358	2	3C x 16	LV-48-6065	LV-48-6066	LV-48-6067	*	*	*	*	*	*	*	*	*

* TERMINAL NUMBERS BY C&A FOR DETAILS REF. DRG. NO. NIM-5-4745-xxx-DQ

APPROVED FOR
CONSTRUCTION

THIS COMPLETE DRAWING IS NEW AND
FORMS PART OF SCOPE OF PROJECT
WBS# C.OM. NIM.IN.09.011

A MAY '11 0 SEPT '09		AB Khalid		KD PVT		APPROVED FOR CONSTRUCTION ISSUED FOR COMMENTS		IF.09.011 OSE/2BN		IF.09.011 OSE/2BN	
CONTRACT NO. C31/0606		PROJ. NO. PAIP 00405		PROJECT DRAWING REVISION		IN CASE OF DEVIATIONS A MARKED UP PRINT SHALL BE SENT TO THE PROJECT ENGINEER		SCALE: N.T.S.		CAD DRAWING	
AREA: NIMR		SUB AREA: SLUDGE PIT FACILITY		NO. 05		ELECTRICAL CONTROL DIAGRAM		DESCRIPTION: LV MOTOR (ABOVE 5.5kW)		NO. NIM 4 6420 001 DQ 1 A	
DRAWING TYPE:		AREA CODE:		ENG. CODE:		SERIAL NUMBER:		SHEET:		PROJ. CODE:	
DATE:		DESIGNED BY:		CHECKED BY:		APPROVED BY:		DATE:		APPROVED BY:	

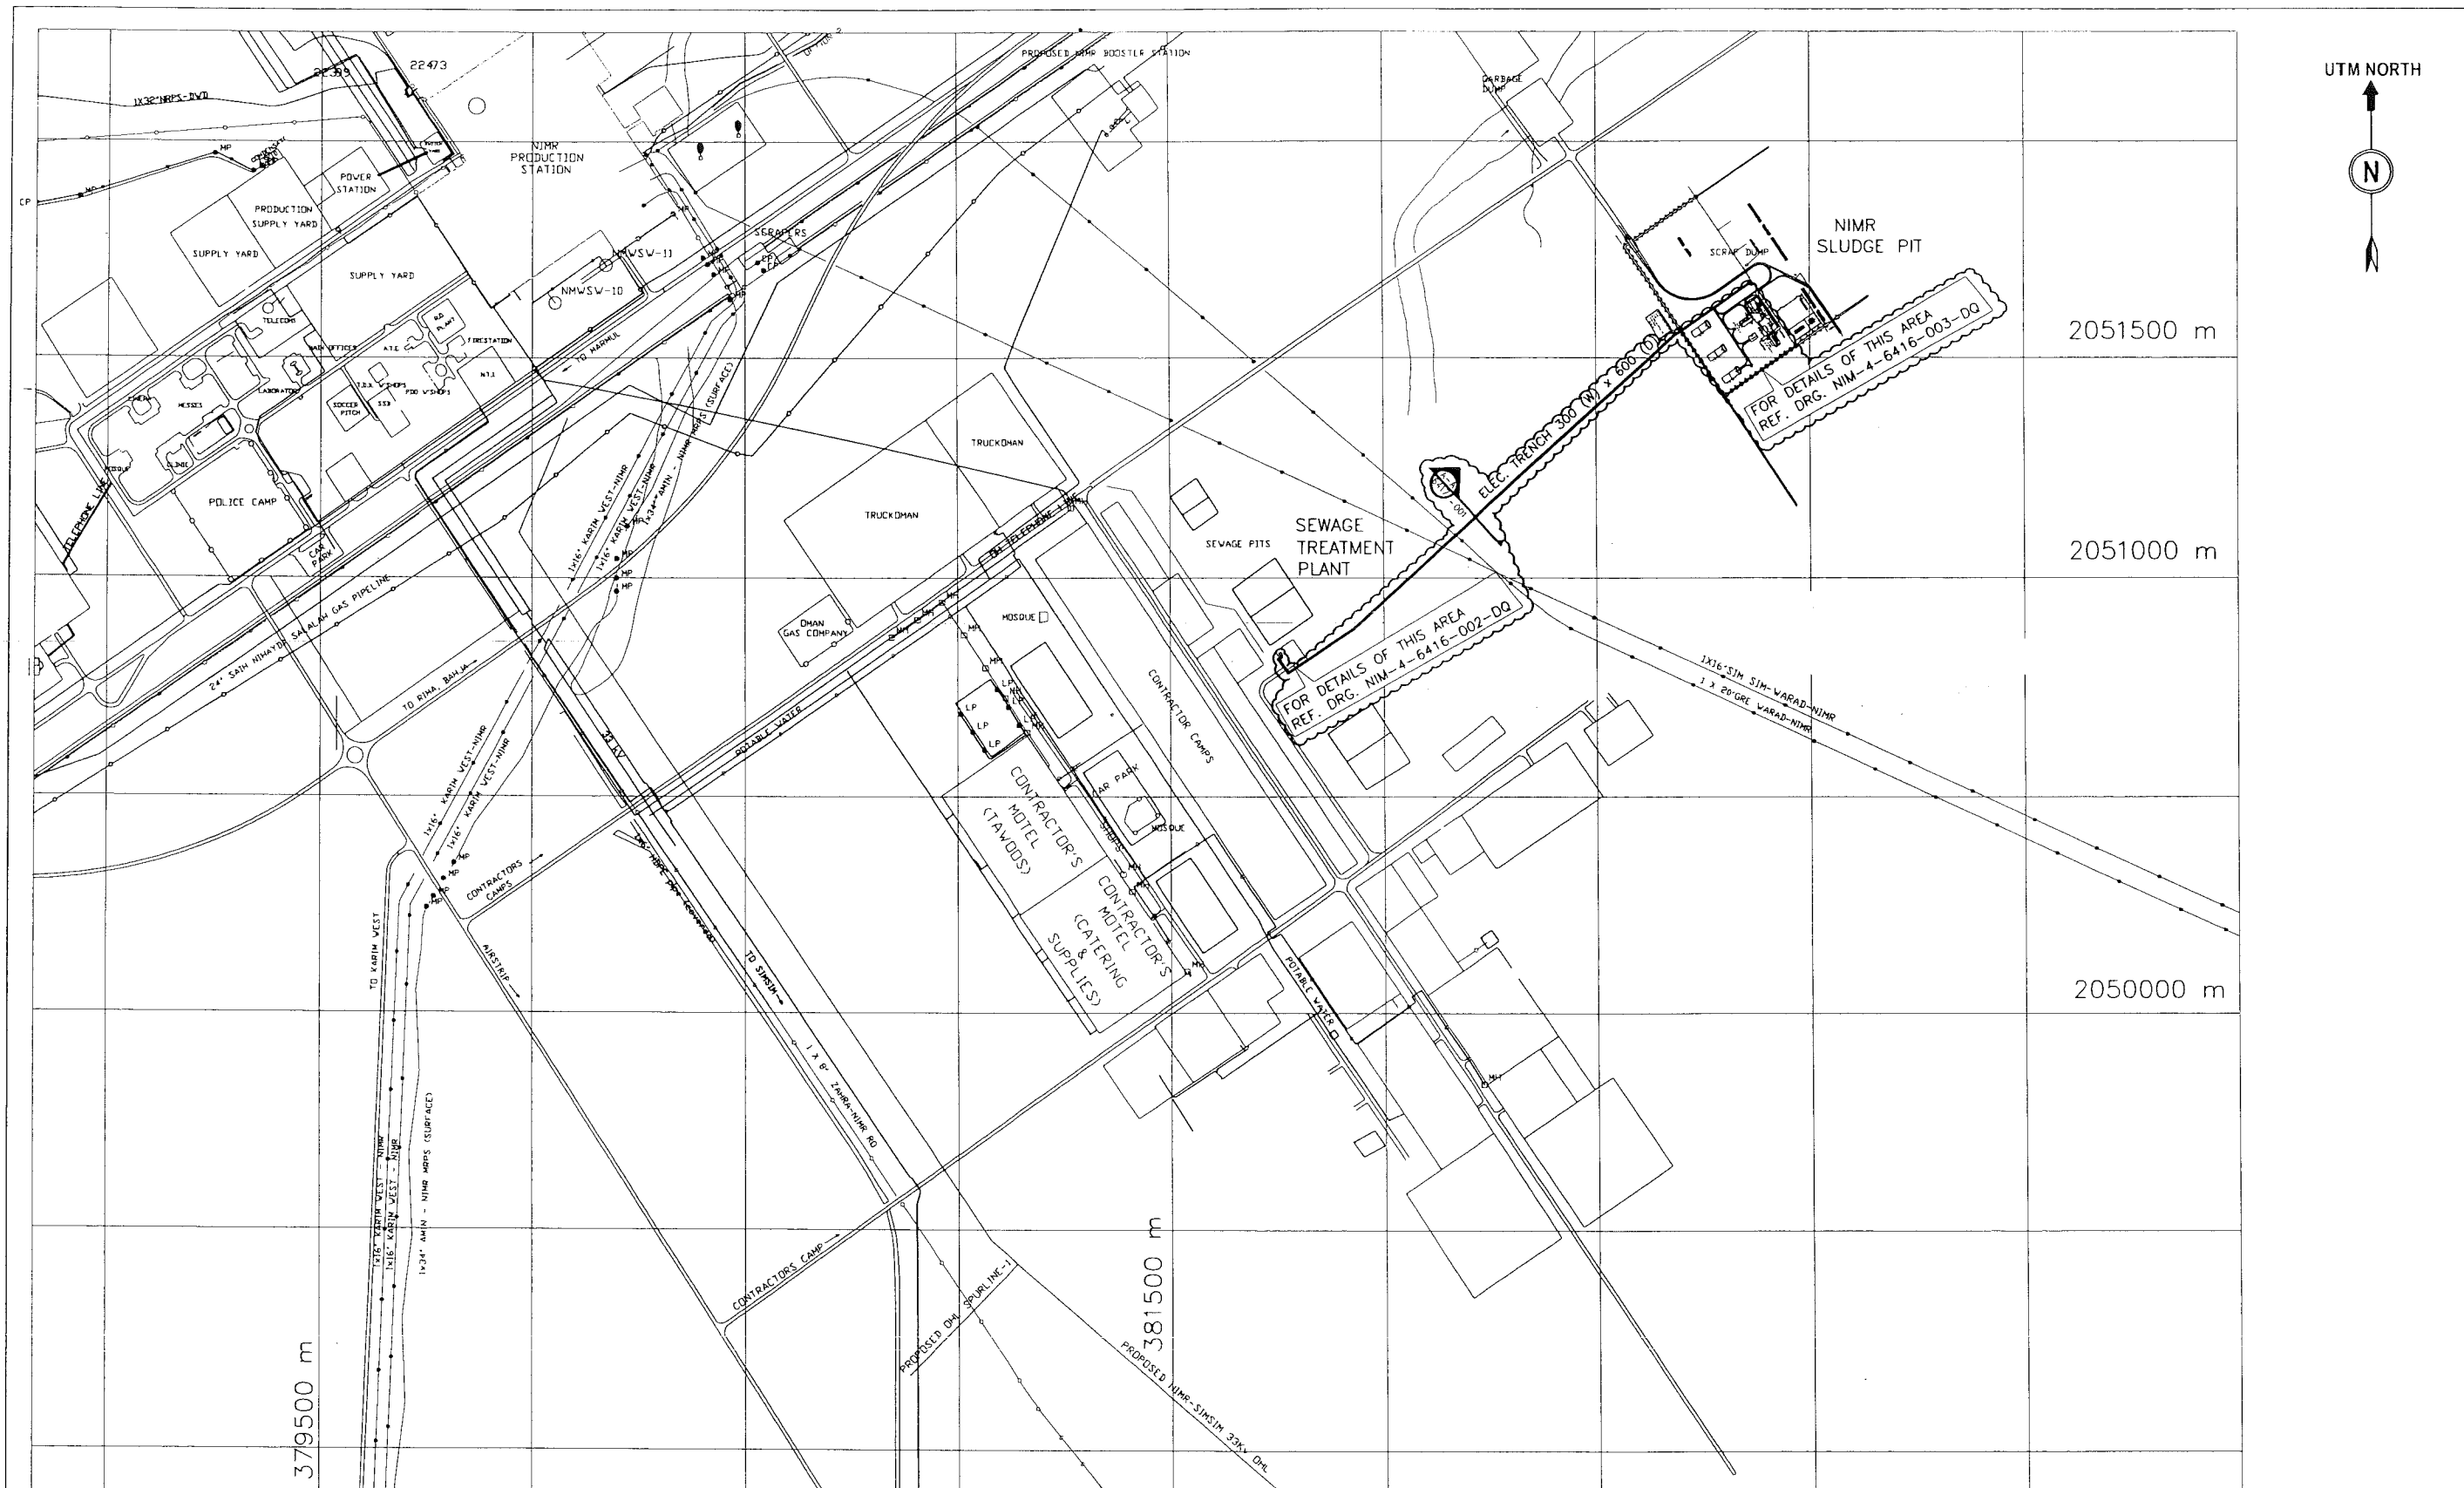


SCOPE OF PROJECT
WBS# C.OM.NIM.IN.09.011

APPROVED FOR
CONSTRUCTION

THIS COMPLETE DRAWING IS NEW
AND FORMS PART OF SCOPE OF
PROJECT WBS# C.OM.NIM.IN.09.011

واري بومونز، الصناعات الوعية (محصنة)
WorleyParsons - Arabian Industries (JV)
CONTRACT NO: C31/0606 PROJ NO: PAIP-00405


REV	DATE	DRAWN BY	TEAM	JENG	CHECKED	DESCRIPTION	BL NO	PROJ ENG	SIGNATURE
A	MAY '11	AB	8/2/11	APPROVED FOR CONSTRUCTION			IN.09.011	OSL/28N	
D	SEP '10	Khafid	KD	ISSUED FOR COMMENTS			IN.09.011	OSL/28N	

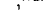PROJECT DRAWING REVISION													
IN CASE OF DEVIATIONS A MARKED UP PRINT SHALL BE SENT TO THE PROJECT ENGINEER													
AREA : NIMR					SCALE : NONE CAD DRAWING								
SUB AREA : FIELD FACILITY					NO. 05								
DRAWING TYPE : LAYOUT													
					Petroleum Development Oman								
DESCRIPTION : OVERALL CABLE TRENCH LAYOUT					DRWG	AREA	ENG	SERIAL	SHEET	PROJ.	ENG	REV.	
					CODE	CODE	NUMBER	CODE	SIZE				
					NO.	NIM 4 6416 001DQ 1 A							

NOTES
1. LV CABLE TRENCH 300mm (W) x 600mm (D) SHALL BE CONSTRUCTED FROM SEWAGE TREATMENT PLANT TO SLUDGE PIT AREA DB.

DRAWING CONTROL INDEX									
DESCRIPTION	REFERENCE DRAWINGS								
	NIM	1	2635	400	DO	4			
	AREA	5	SERIAL	51	1	1			

MASTER DRAWING REVISION
IN CASE OF DEVIATIONS MARKED UP PRINT SHALL BE SENT TO COASTAL DESIGN OFFICE

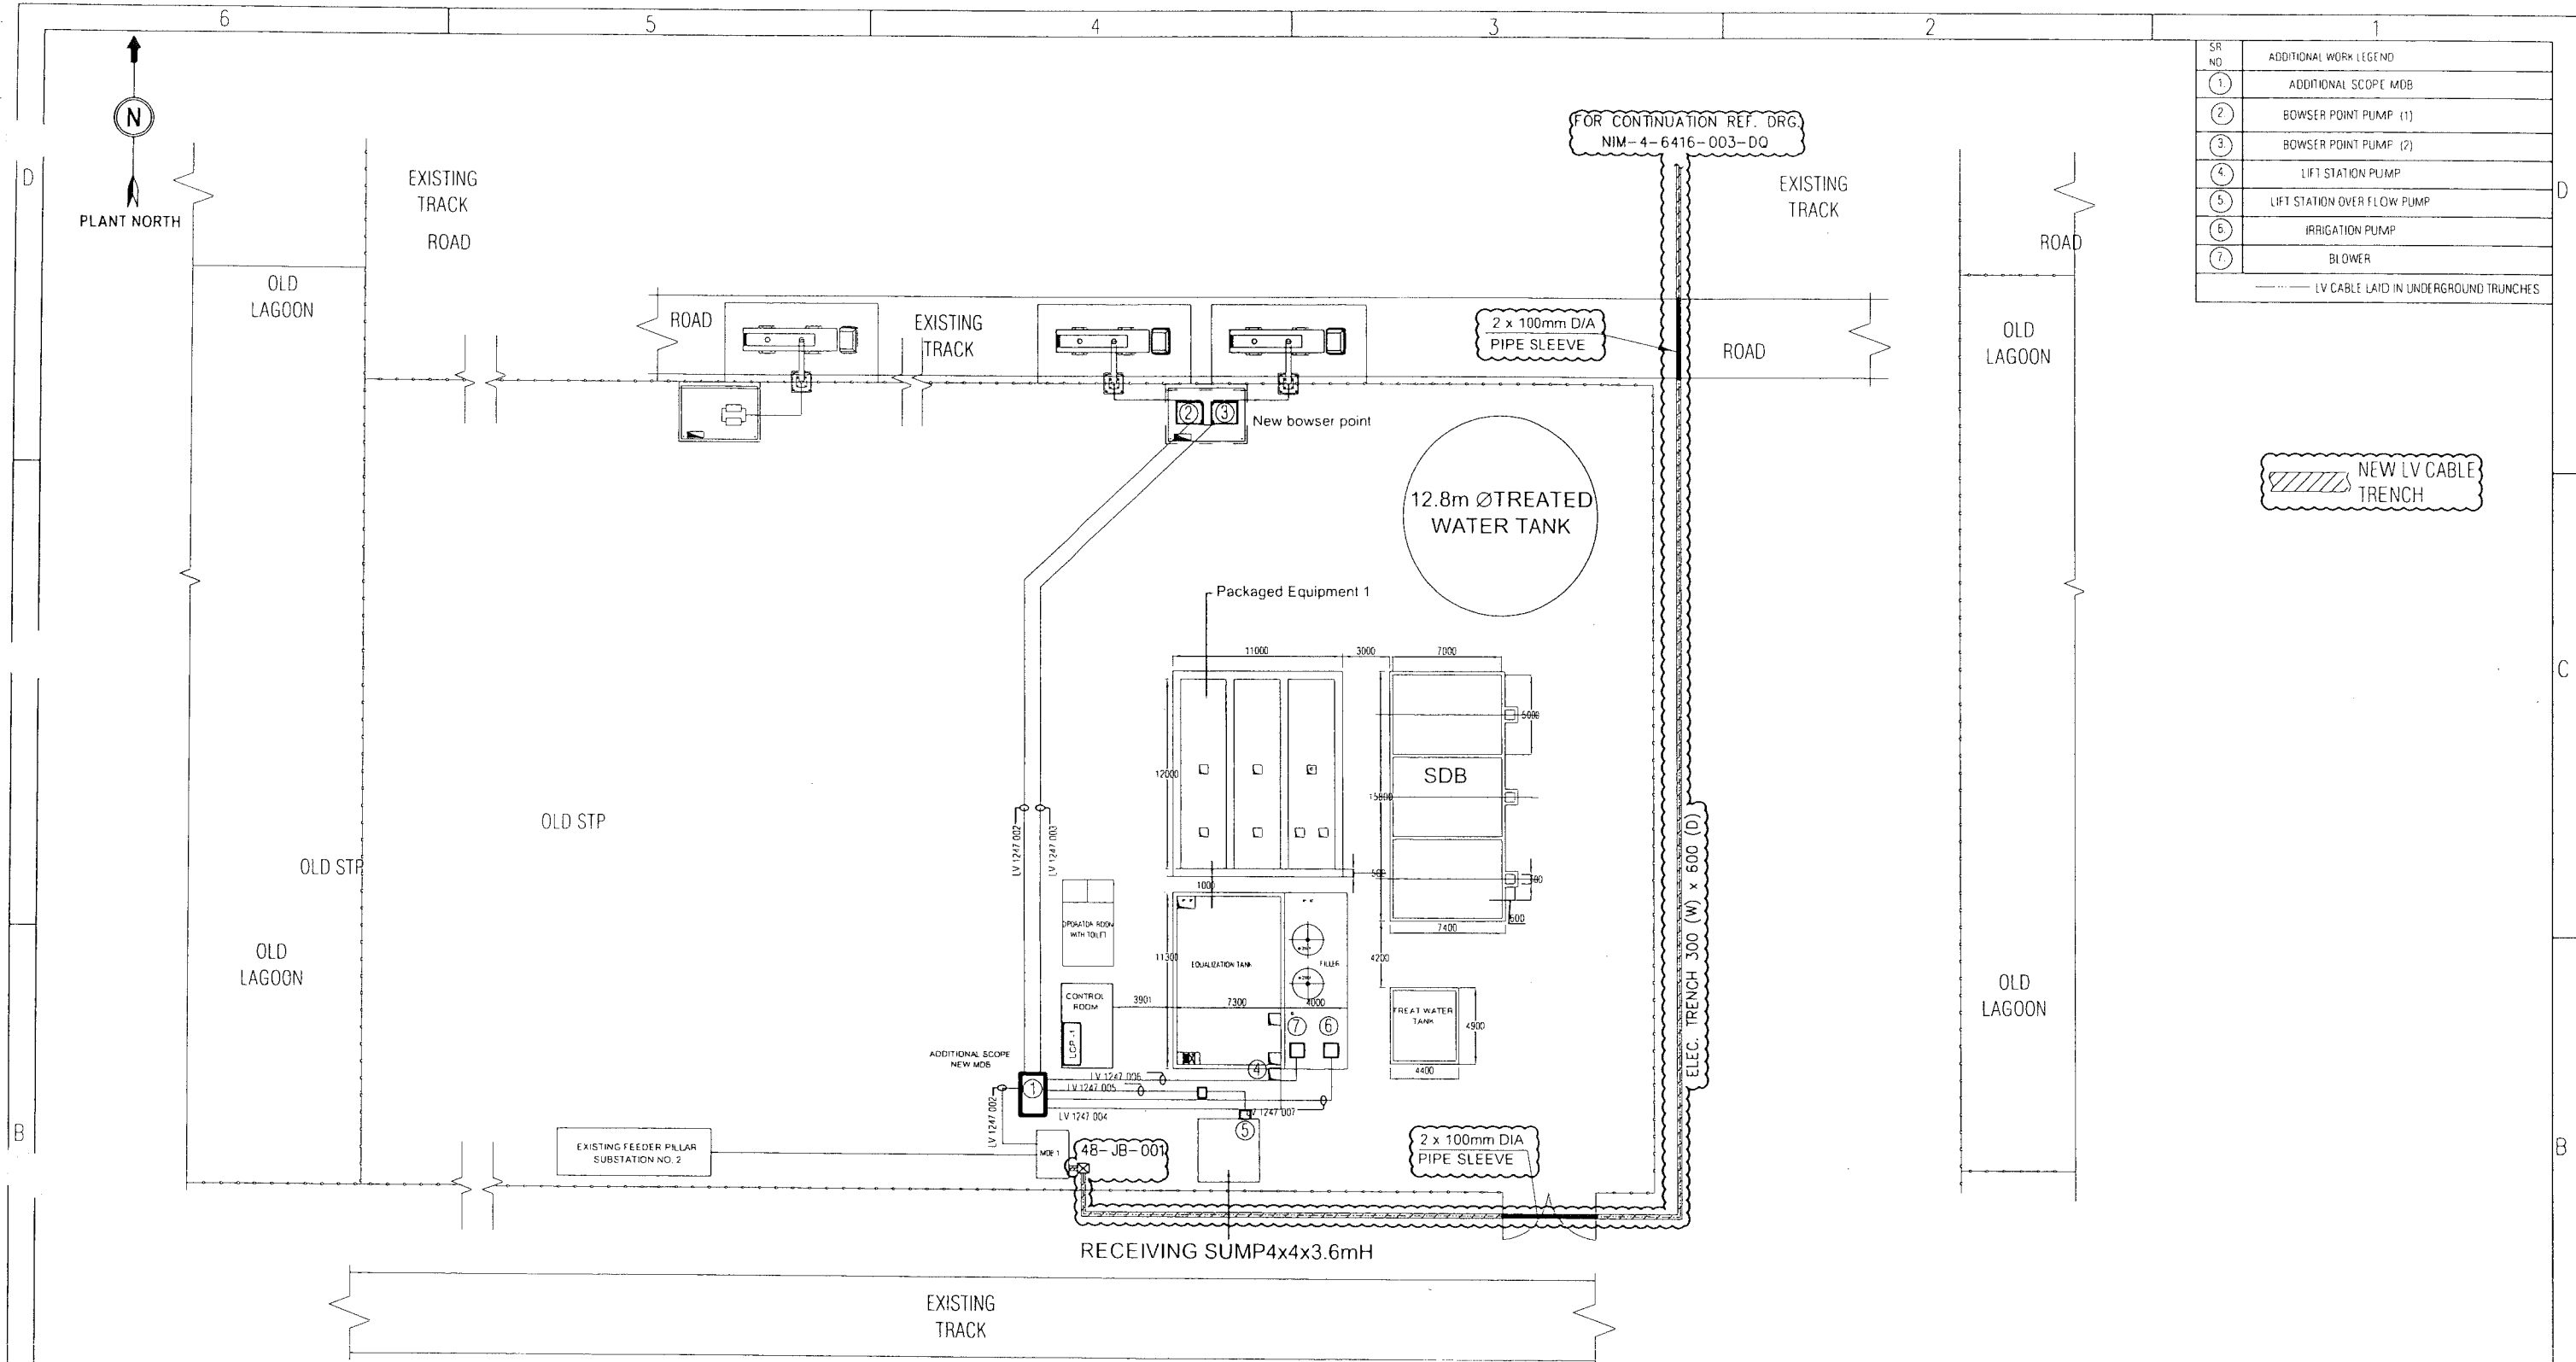

SR NO	ADDITIONAL WORK LEGEND
1	ADDITIONAL SCOPE MDS
2	BOWSER POINT PUMP (1)
3	BOWSER POINT PUMP (2)
4	LIFT STATION PUMP
5	LIFT STATION OVER FLOW PUMP
6	IRRIGATION PUMP
7	BLOWER
----- LV CABLE LAID IN UNDERGROUND TRUNCHES	

NEW LV CABLE TRENCH


SITE LAYOUT



APPROVED FOR CONSTRUCTION



SCOPE OF PROJECT
WBS# C.OM.NIM.IN.09.011

THIS COMPLETE DRAWING IS NEW AND FORMS PART OF SCOPE OF PROJECT WBS# C.OM.NIM.IN.09.011

WorleyParsons - Arabian Industries (JV)										APPROVED FOR CONSTRUCTION		IN.09.011		OSE/28N		DATE																																																																																																																																																																																																																																																																																																																																																																																																																																																																																																																																																																																																																																																																																																																																																																																																																																																																																																																																																																																																																																																																																																																																																																																																																																																																																																																																																																																																																																																																																																																																																																																																																																																																																																																																																																																																																																																																																																																																																																																																																																																																																																																																																																																																																																																																																																																																																																																																																																																																																																																																																																																																																																																																																																																																																																																																																																																																																																																																																																																																																																																																																																																																																																																																																																																																																																																																																																																																																																																																																																																																																																																																																																																																																																																																																																																																																																																																																																																																																																																																																																																																																																																																																																																																																																																																																																																																																																																																																																																																																																																																																																																																																																																																																																																																									
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SCOPE OF PROJECT
WBS# C.OM.NIM.IN.09.011

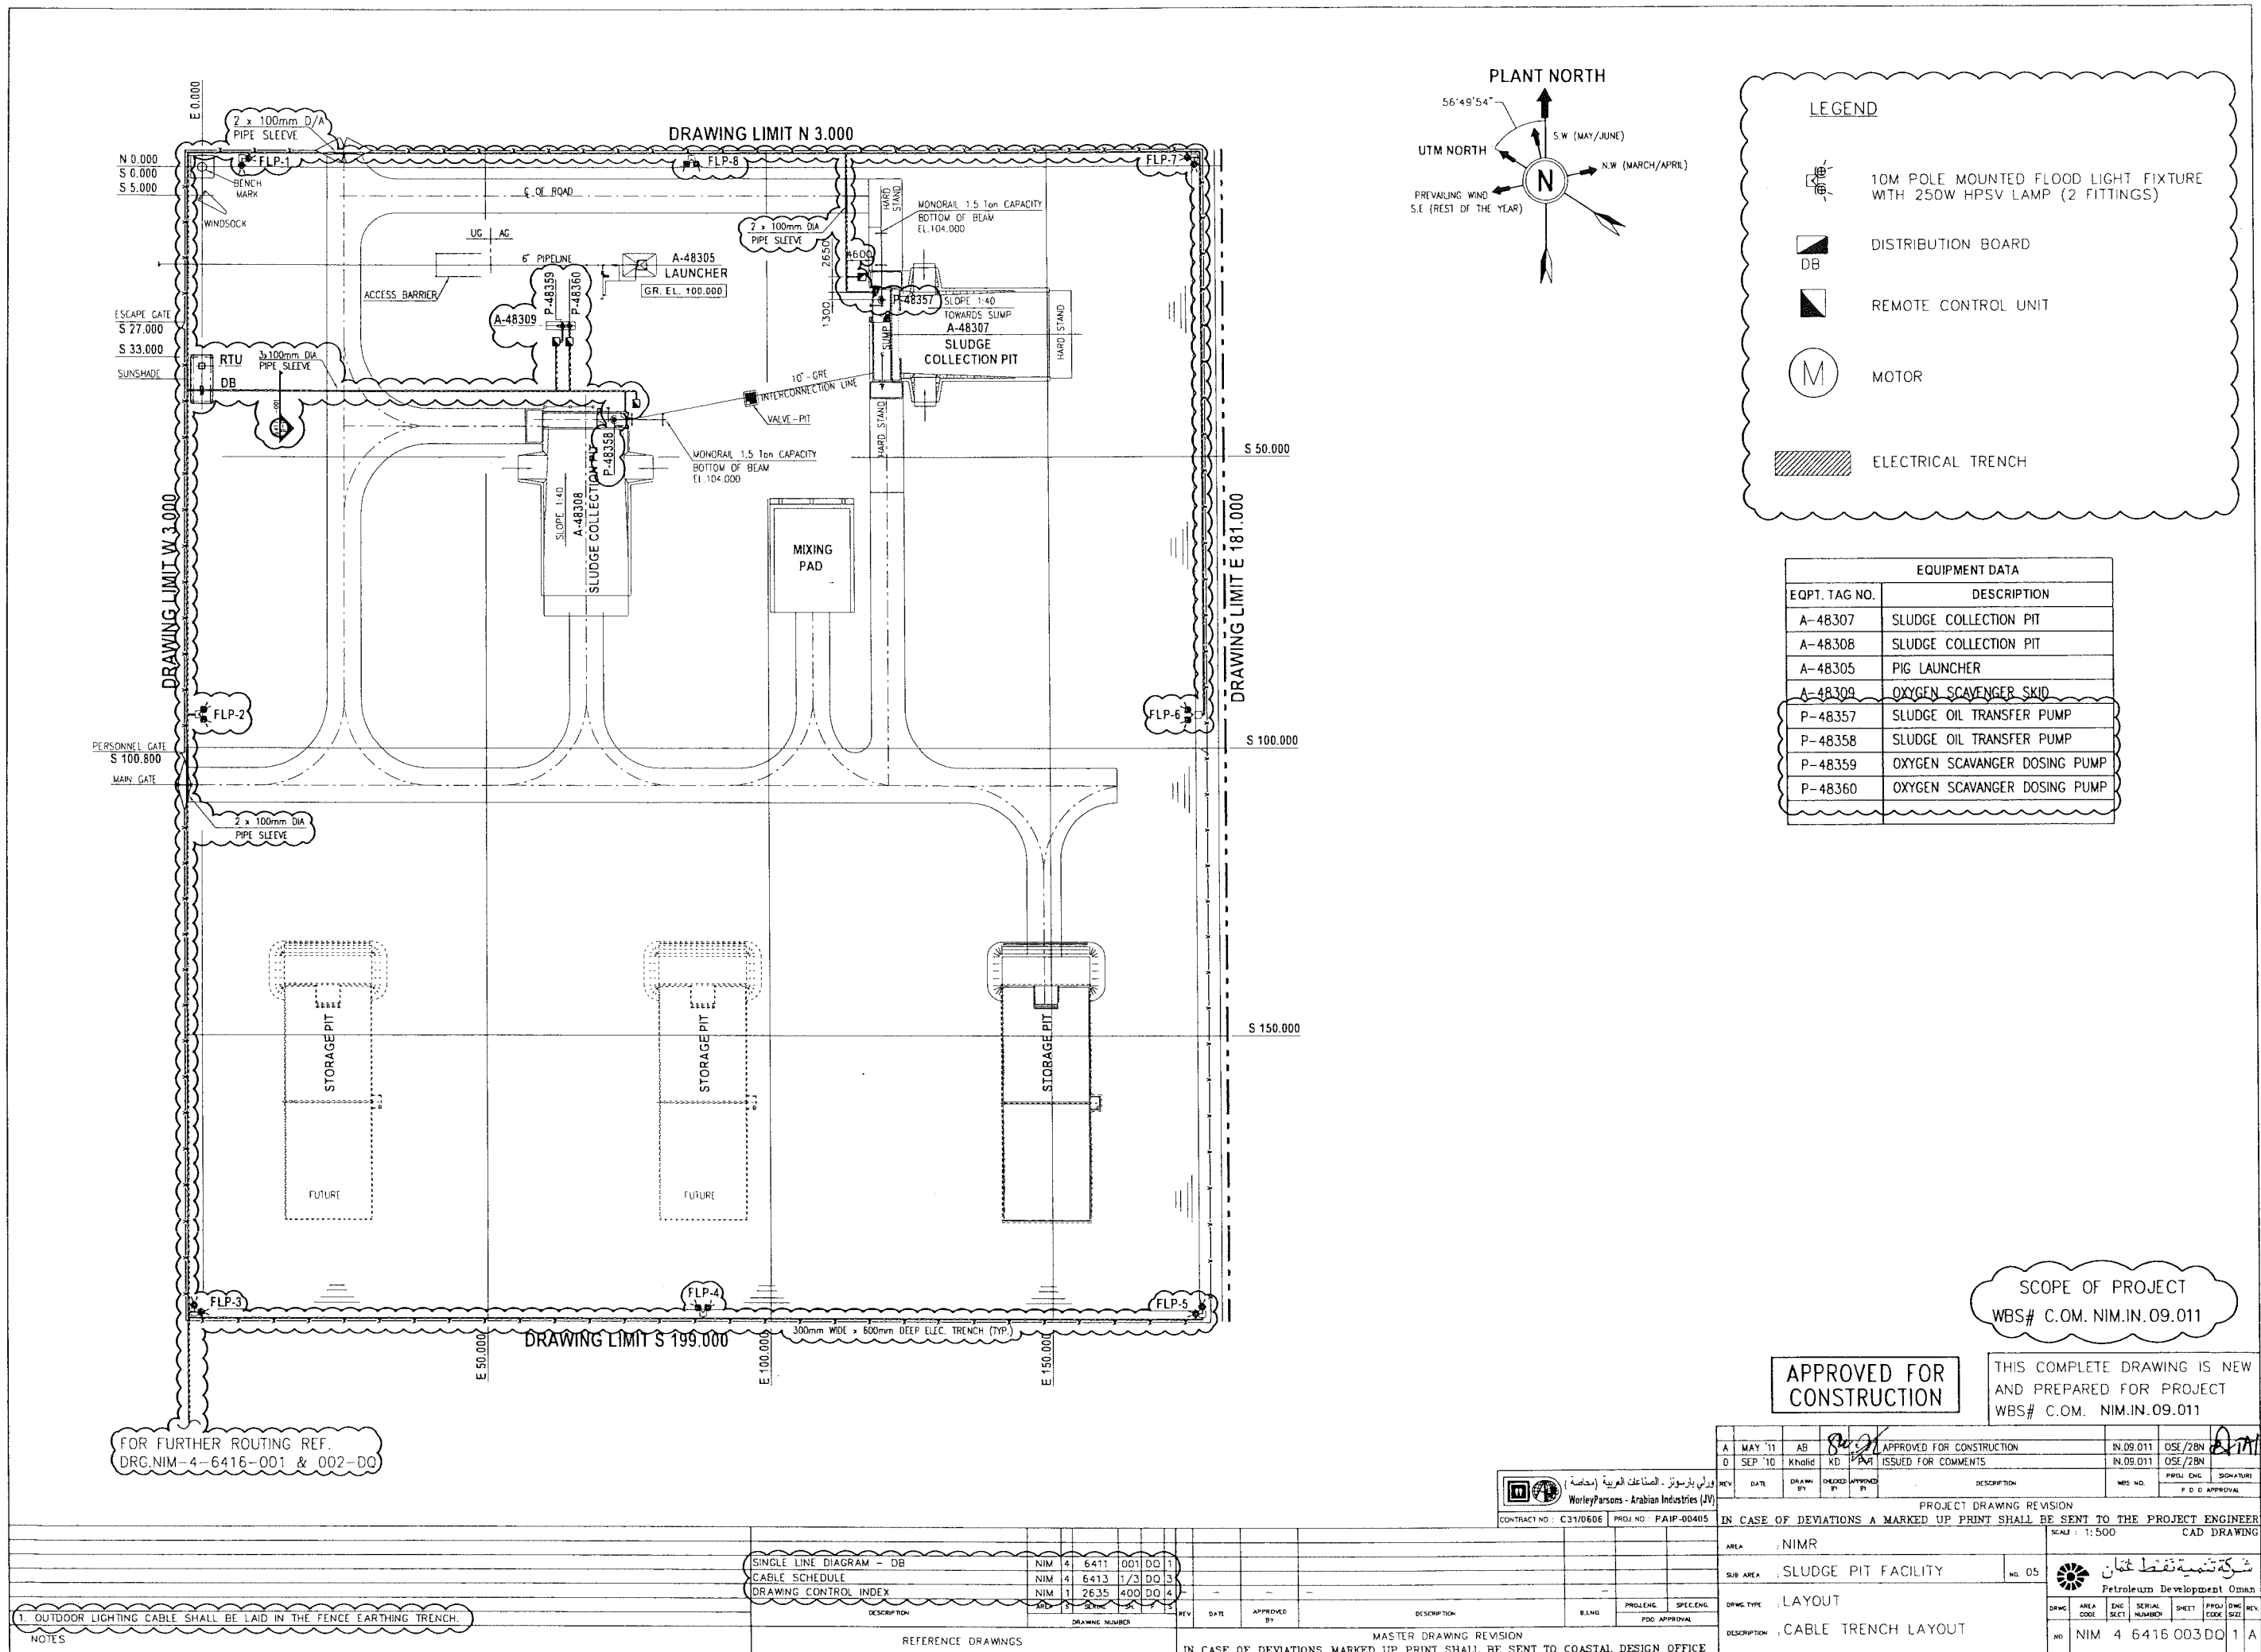APPROVED FOR
CONSTRUCTION

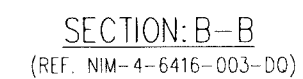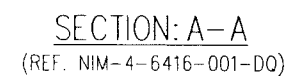THIS COMPLETE DRAWING IS NEW
AND FORMS PART OF SCOPE OF
PROJECT WBS# C.OM.NIM.IN.09.011

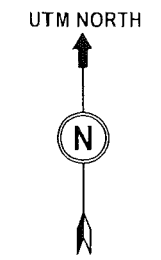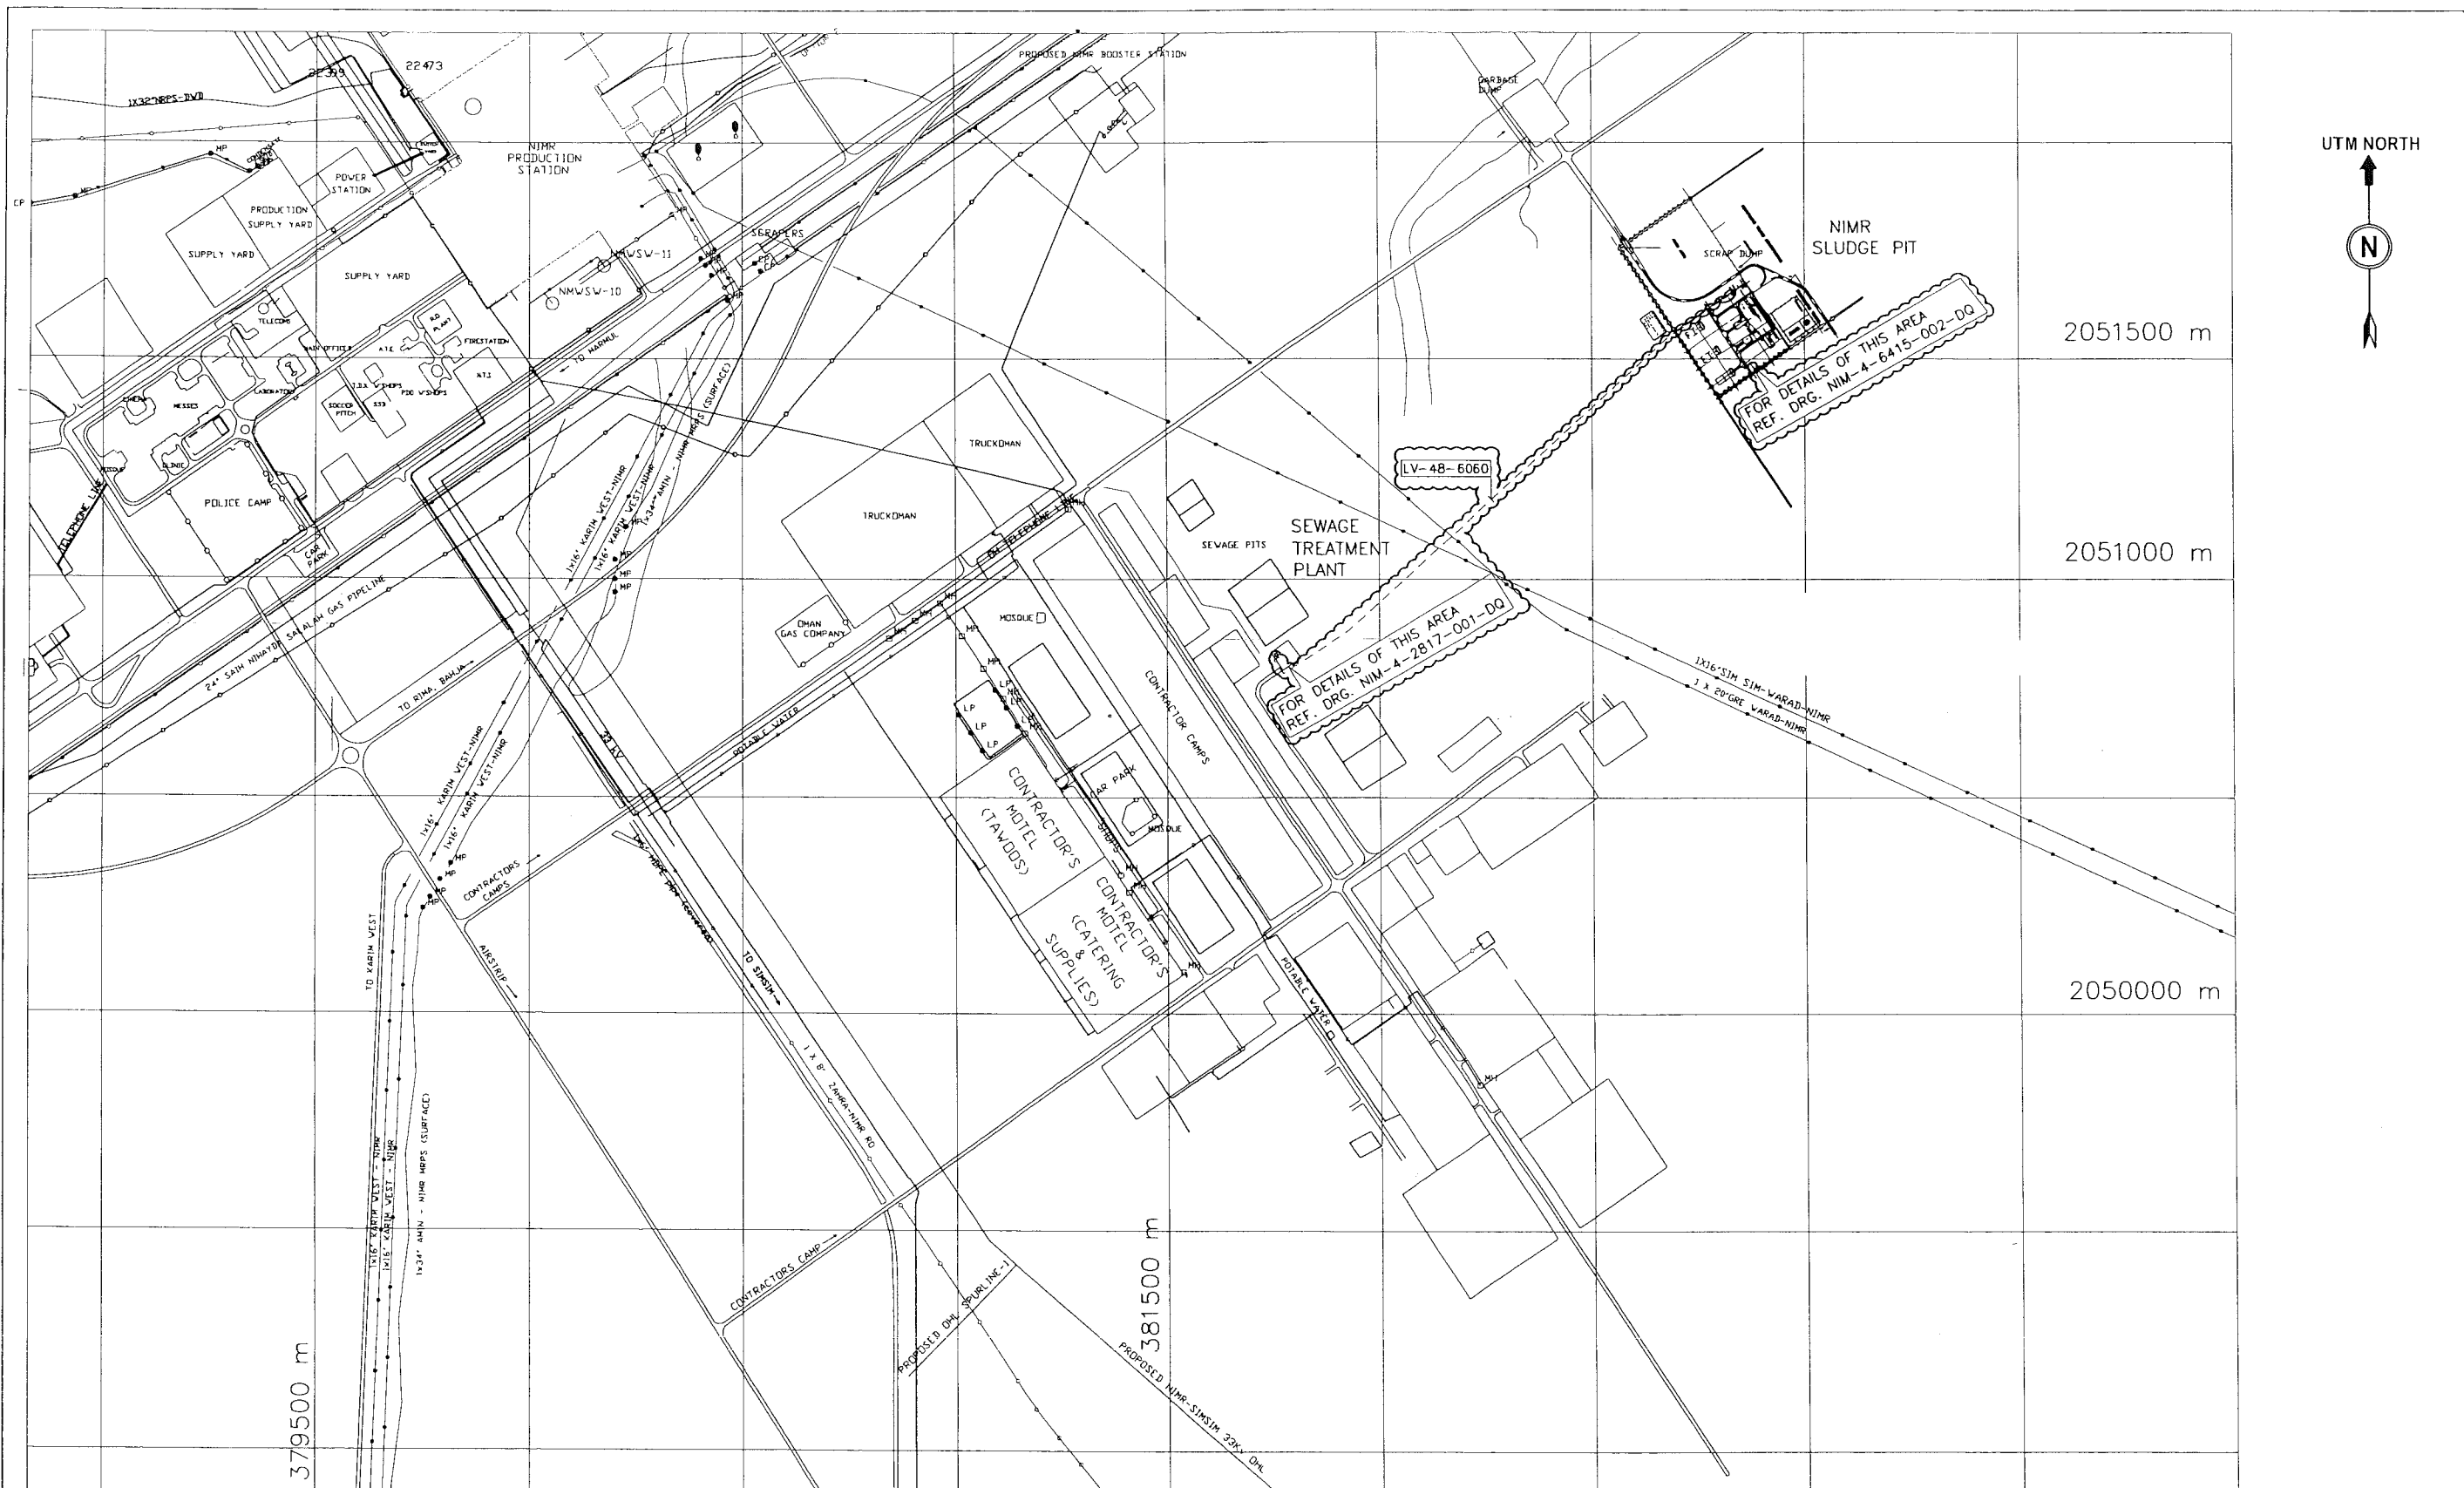WorleyParsons - Arabian Industries (JV)
CONTRACT NO.: C31/0606 PROJ NO.: PAIP-00405


REV	DATE	DRAWN BY	CHECKED	TEAM LEADER	DESCRIPTION	IN.09.011	OSI/2BN	DATE	OSI/2BN
0	SEP '10	Khalid	KD	PTI	ISSUED FOR COMMENTS	IN.09.011	OSI/2BN		
A	MAY '11	AB	AB	AB	APPROVED FOR CONSTRUCTION	IN.09.011	OSI/2BN		

AREA	NIMR	NO.05
SUB AREA	FIELD	
DWG TYPE	LAYOUT	
DESCRIPTION	OVERALL CABLE ROUTE LAYOUT	
DWG CODE	NIM 4 6415 001DQ	1 A

NOTES
1. 4Cx240 Sq.mm. LV CABLE SHALL BE LAID IN UNDERGROUND CABLE TRENCH FROM MDB-1 LOCATED AT SEWAGE TREATMENT PLANT TO DB (G-6951) LOCATED AT SLUDGE PIT AREA.

DESCRIPTION	DRAWING NUMBER	REV	DATE	APPROVED BY	DESCRIPTION	BLND	PROJ ENG	SPEC ENG
CABLE SCHEDULE	NIM 4 6413 1/3 DO 3							
DRAWING CONTROL INDEX	NIM 1 2635 400 DO 4							

IN CASE OF DEVIATIONS MARKED UP PRINT SHALL BE SENT TO COASTAL DESIGN OFFICE

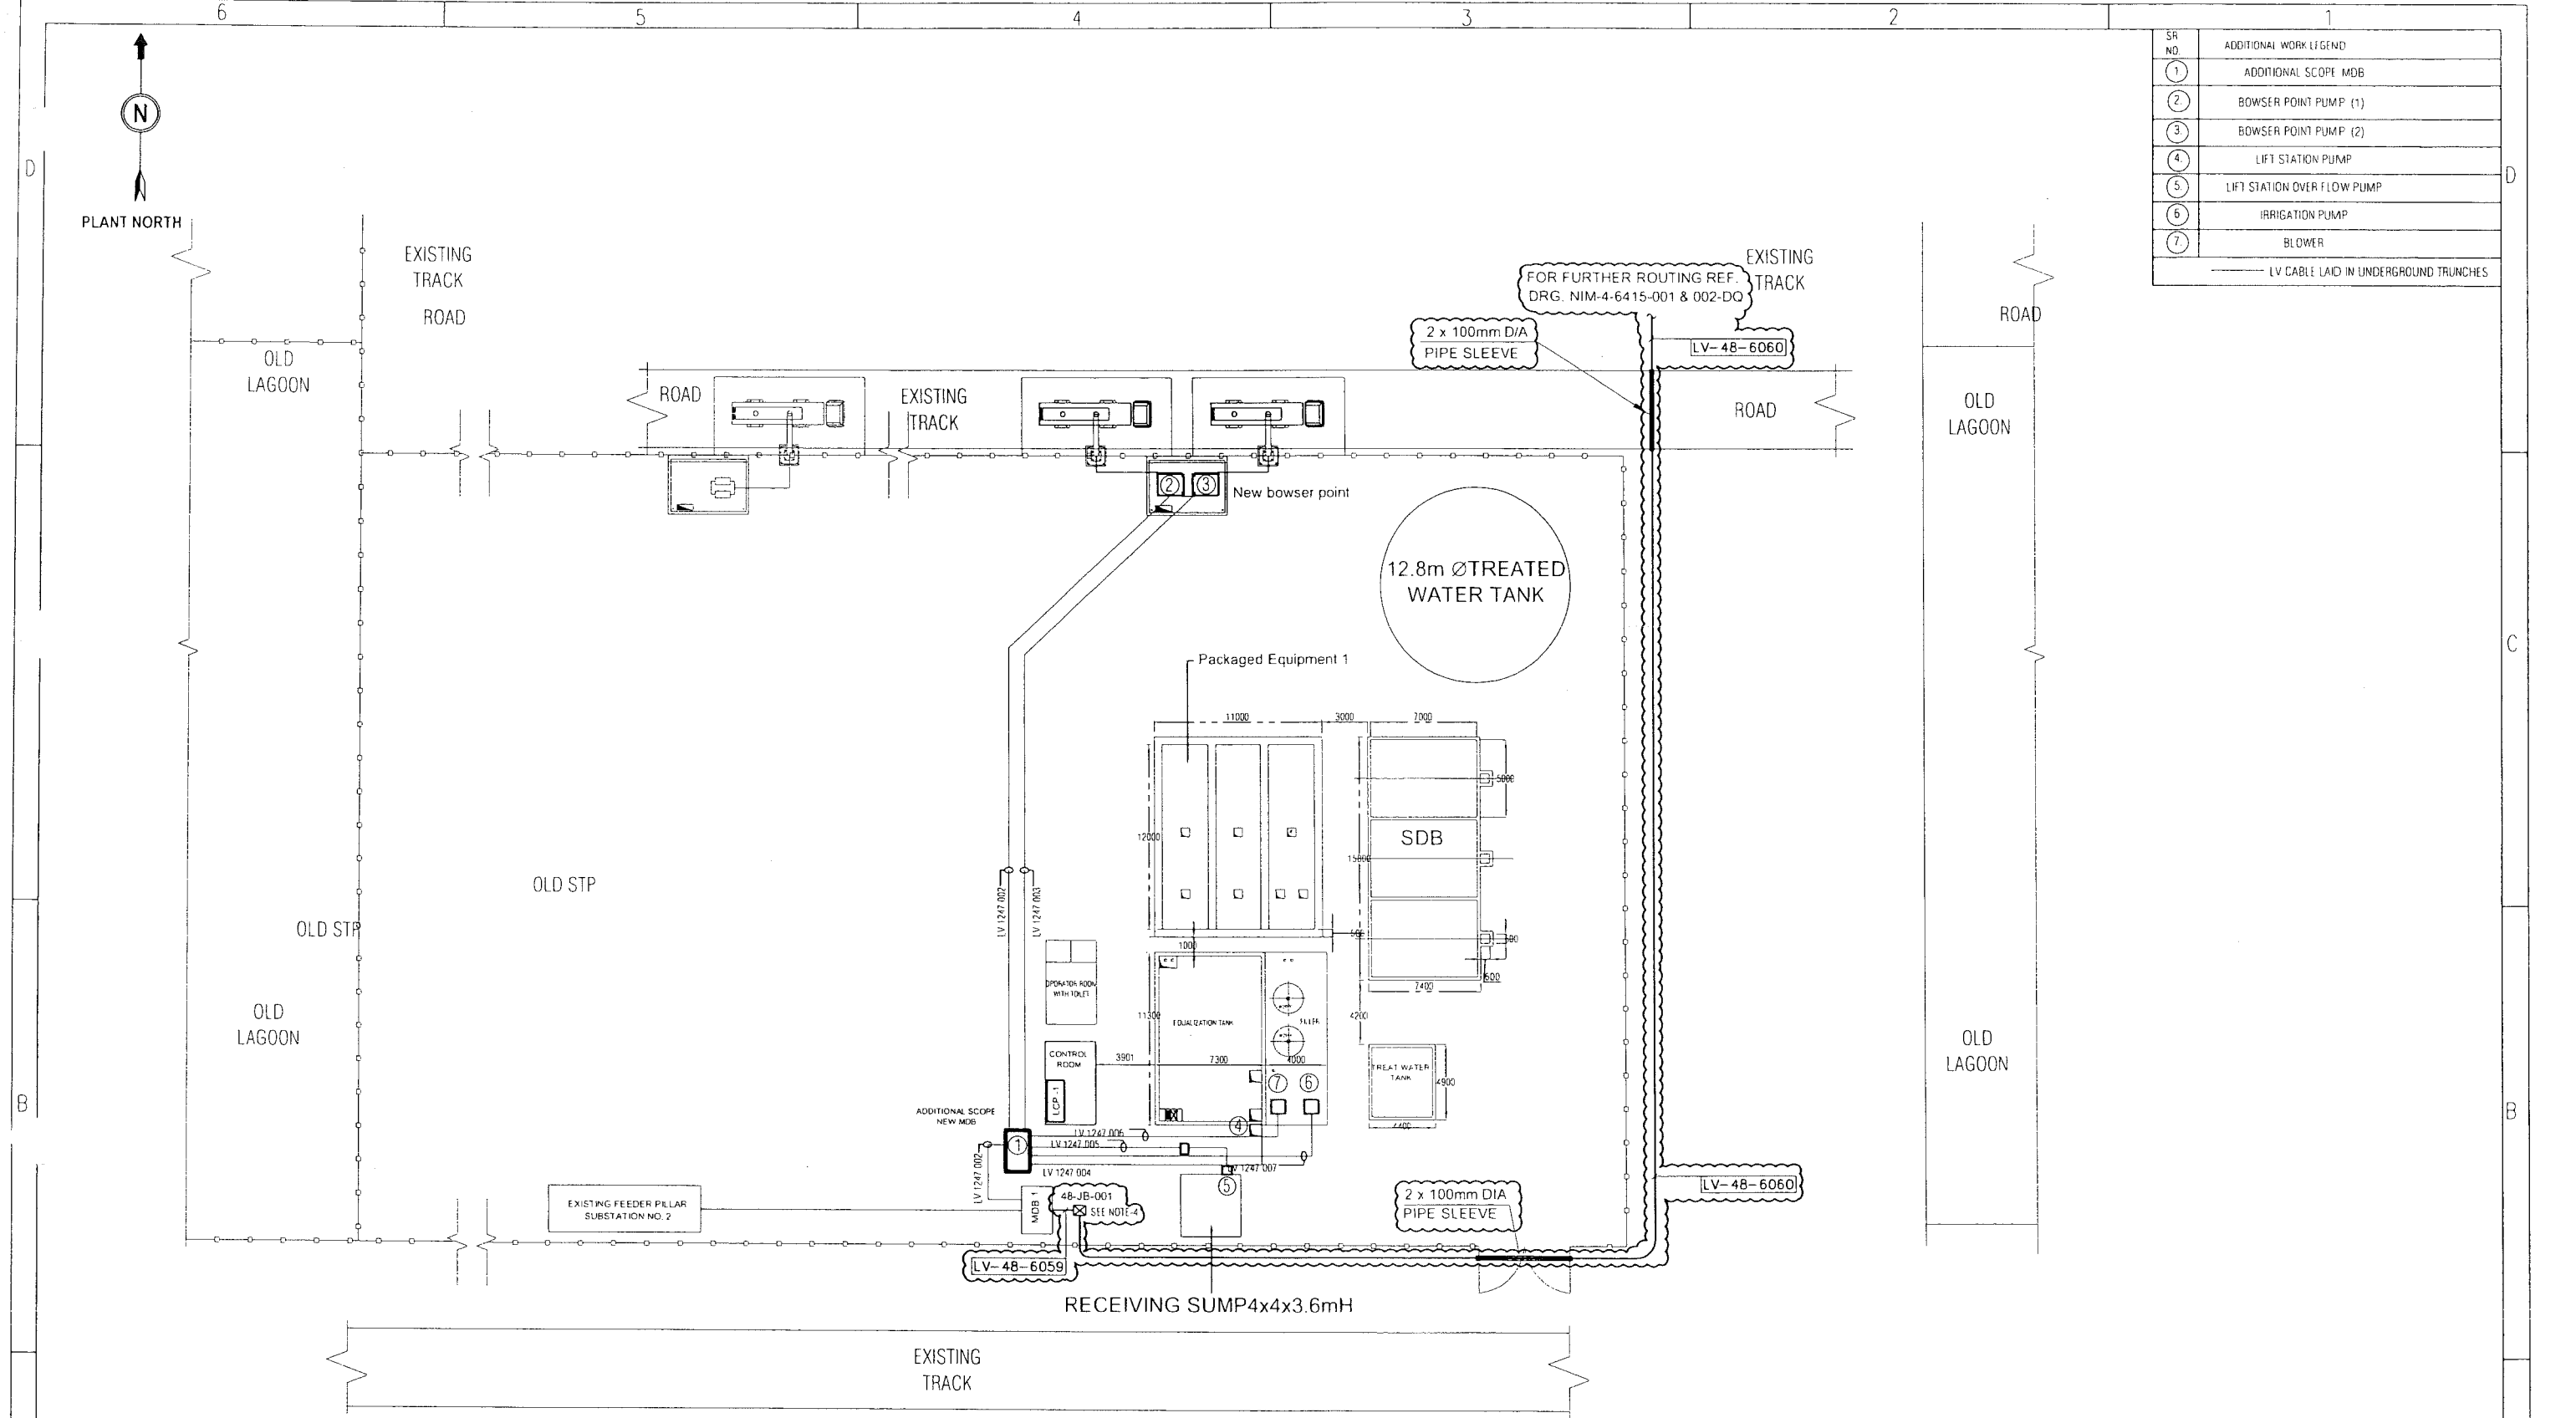

SR NO.	ADDITIONAL WORK LEGEND
1	ADDITIONAL SCOPE MDB
2	BOWSER POINT PUMP (1)
3	BOWSER POINT PUMP (2)
4	LIFT STATION PUMP
5	LIFT STATION OVER FLOW PUMP
6	IRRIGATION PUMP
7	BLOWER
— LV CABLE LAID IN UNDERGROUND TRUNDLES	

SITE LAYOUT

APPROVED FOR CONSTRUCTION

SCOPE OF PROJECT
WBS# C.OM.NIM.IN.09.011



- 4. CONSTRUCTION MATERIAL FOR JUNCTION BOX SHALL BE BY CONTRACTOR.
- 3. REFER DRAWING NO. NIM-4-6415-001-DQ FOR OVERALL CABLE ROUTING.
- 2. JUNCTION BOX JB-48-001 SHALL BE LOCATED ADJACENT TO MDB-1 TO SUIT SITE CONDITIONS.
- 1. ALL DIMENSIONS ARE IN MILLIMETRES, ELEVATIONS & CO-ORDINATES ARE IN METRES.

DESCRIPTION	DRAWING NUMBER	REV	DATE	APPROVED BY
SINGLE LINE DIAGRAM FOR LCP-D1	NIM 4 2801 001 DO 1			
CABLE SCHEDULE	NIM 4 6413 1/3 DO 3			
DRAWING CONTROL INDEX	NIM 1 2635 400 DO 4			

MASTER DRAWING REVISION
IN CASE OF DEVIATIONS MARKED UP PRINT SHALL BE SENT TO COASTAL DESIGN OFFICE

WorleyParsons - Arabian Industries (JV)
CONTRACT NO: C31/0606 PROJ NO: PAIP-00405

REV	DATE	BY	CHECKED	DESCRIPTION	WBS NO	PROJ. ENG.	SIGNATURE
A	MAY '11	Khalid		APPROVED FOR CONSTRUCTION	IN.09.011	OSE/28N	
D	SEP '10	Khalid		ISSUED FOR COMMENTS	IN.09.011	OSE/28N	
PROJECT DRAWING REVISION							
IN CASE OF DEVIATIONS A MARKED UP PRINT SHALL BE SENT TO THE PROJECT ENGINEER							
AREA	SOUTH OMAN NIMR			SCALE: 1: NTS	CAD DRAWING		
SUB AREA	CONTRACTOR'S CAMP NIMR			NO. 05	شركة تنمية نفط عمان		
DRWG. TYPE	CABLE LAYOUT AND DB LOCATION			DRWG. NO.	NIM 4 2817 001 DO 1 A		
DESCRIPTION	CABLE LAYOUT FOR ADDITIONAL WORK			NO.	NIM 4 2817 001 DO 1 A		

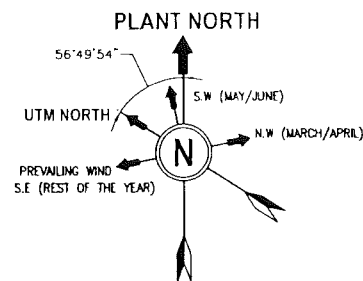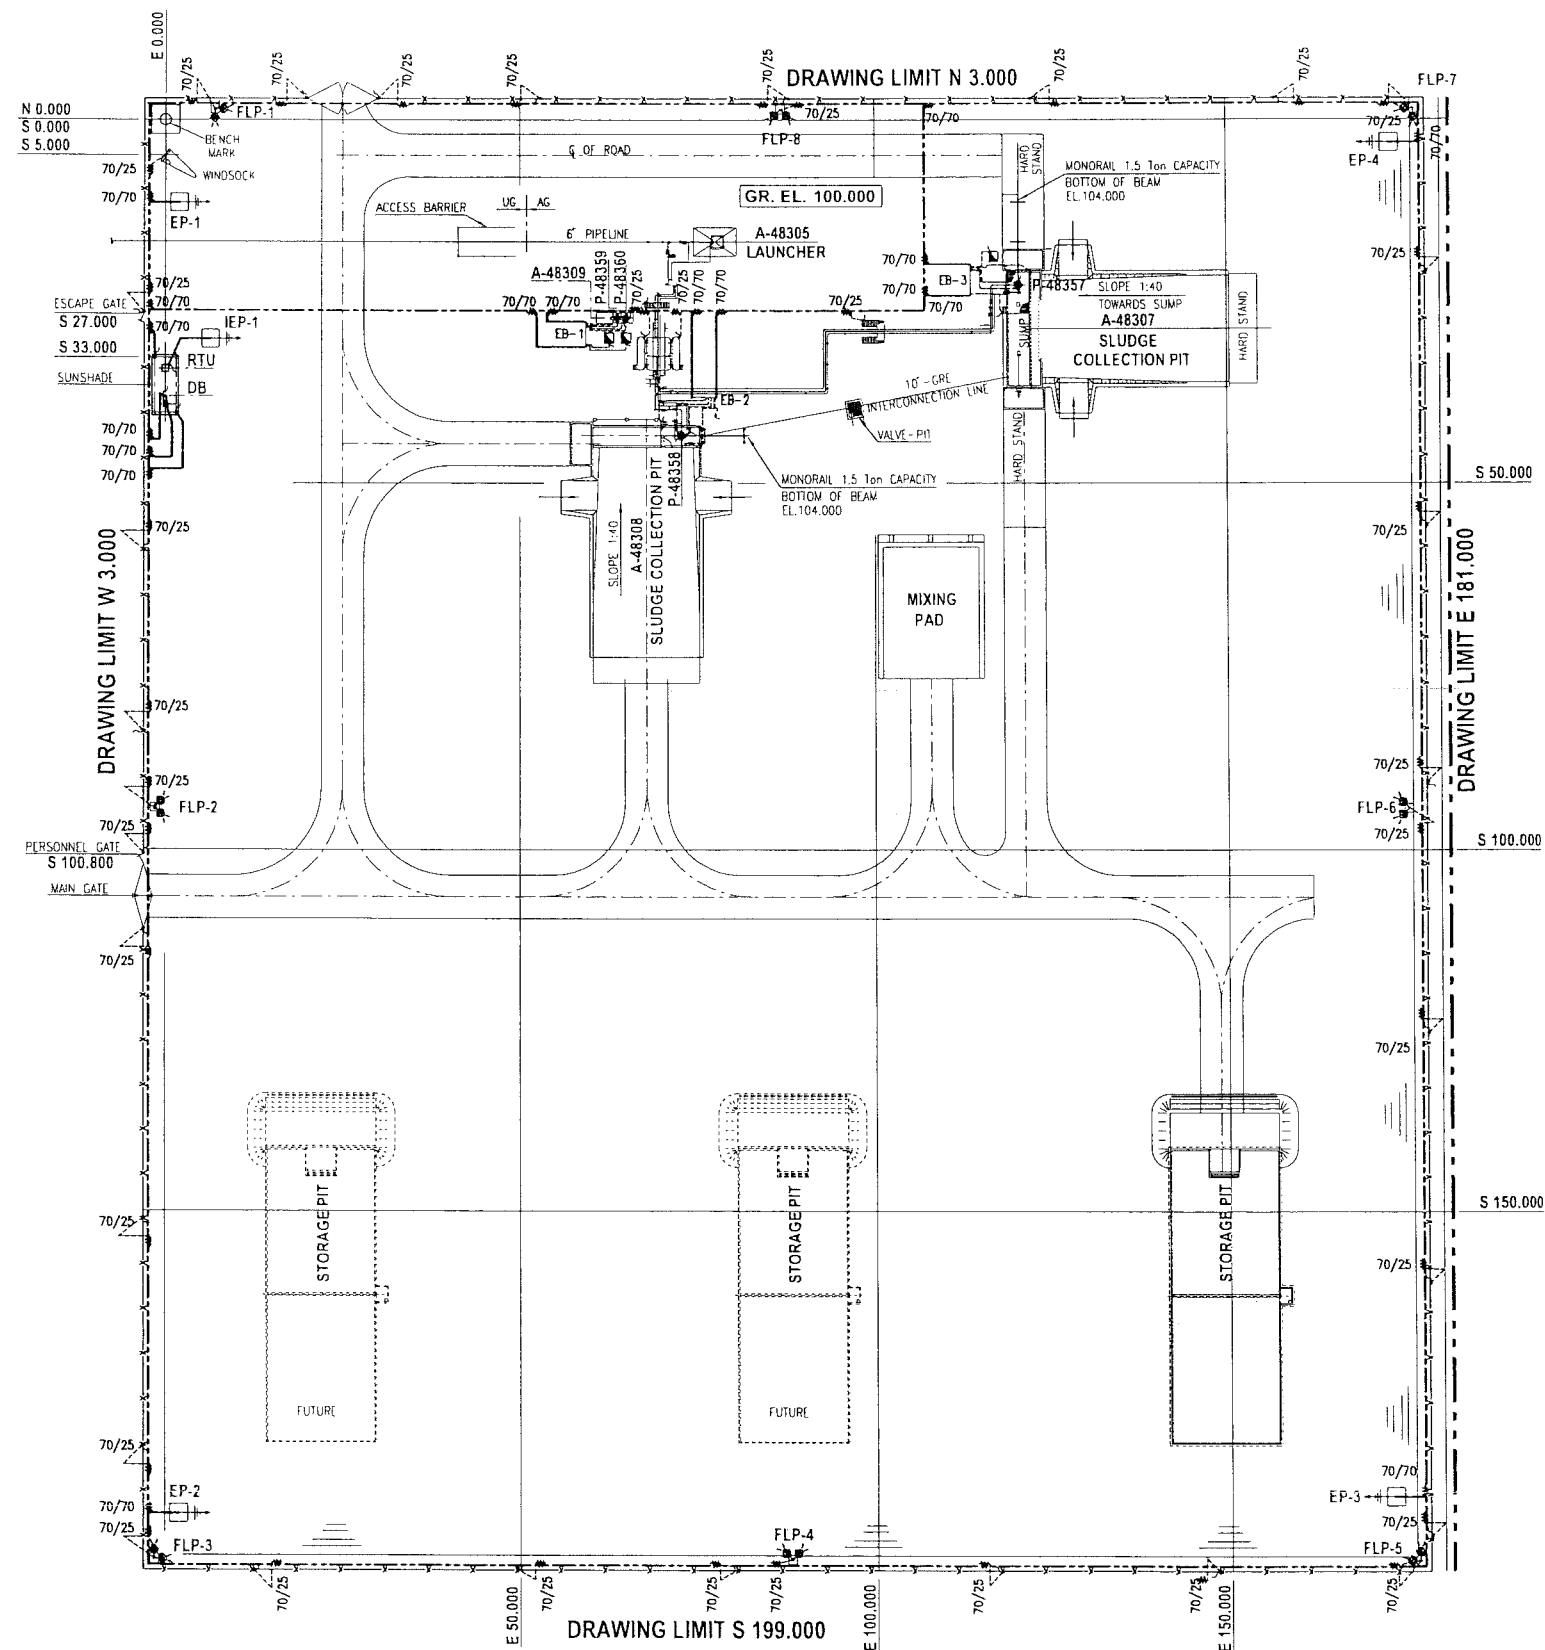

LEGEND	DESCRIPTION
---	1Cx70 Sq.mm Y/G PVC INSULATED COPPER EARTH CABLE
---	1Cx25 Sq.mm Y/G PVC INSULATED COPPER EARTH CABLE
⊕	EARTH BOSS
W	70/70 & 70/25 BRANCH CONNECTOR
EB-	EARTH BUSBAR
⊕	EARTH PIT
M	MOTOR
□	REMOTE CONTROL UNIT
■	DISTRIBUTION BOARD

APPROVED FOR
CONSTRUCTION

THIS COMPLETE DRAWING IS NEW
AND PREPARED FOR PROJECT
WBS# C.OM. NIM.IN.09.011



WorleyParsons - Arabian Industries (JV)

CONTRACT NO. : C31/0606 PROJ. NO. : PAIP-00405

REV	DATE	BY	CHKD	APP'D	DESCRIPTION	WBS NO.	PROJ. ENG.	SIGNATURE
A	MAY '11	AB			APPROVED FOR CONSTRUCTION	IN.09.011	OSE /ZBN	
0	SEP '10	Khdid	KD		ISSUED FOR COMMENTS	IN.09.011	OSE /ZBN	

PROJECT DRAWING REVISION
IN CASE OF DEVIATIONS A MARKED UP PRINT SHALL BE SENT TO THE PROJECT ENGINEER

AREA	SUB AREA	NO.	SCALE	DATE	BY	CHKD	APP'D	DESCRIPTION
NIMR	SLUDGE PIT FACILITY	05	1:500					
AREA	CODE	ENG. SECT.	SERIAL NUMBER	SHEET	PROJ. CODE	DATE	REV.	

1. ADDITIONAL EARTH PITS FOR SAFETY EARTHING SHALL BE INSTALLED BY THE CONTRACTOR TO ACHIEVE THE EARTH GRID RESISTANCE OF LESS THAN 4 OHMS, AS PER SITE REQUIREMENTS.

NOTES

DRAWING CONTROL INDEX

DESCRIPTION

REFERENCE DRAWINGS

NIM 1 2635 400 00 4

AREA S SERIAL SP P S

DRAWING NUMBER

DATE


APPROVED BY

MASTER DRAWING REVISION


IN CASE OF DEVIATIONS MARKED UP PRINT SHALL BE SENT TO COASTAL DESIGN OFFICE

AREA	SUB AREA	NO.	SCALE	DATE	BY	CHKD	APP'D	DESCRIPTION
NIMR	SLUDGE PIT FACILITY	05	1:500					
AREA	CODE	ENG. SECT.	SERIAL NUMBER	SHEET	PROJ. CODE	DATE	REV.	

DISTRBUTION BOARD FEEDER-11/1
REF. NIM-4-6411-001-DQ

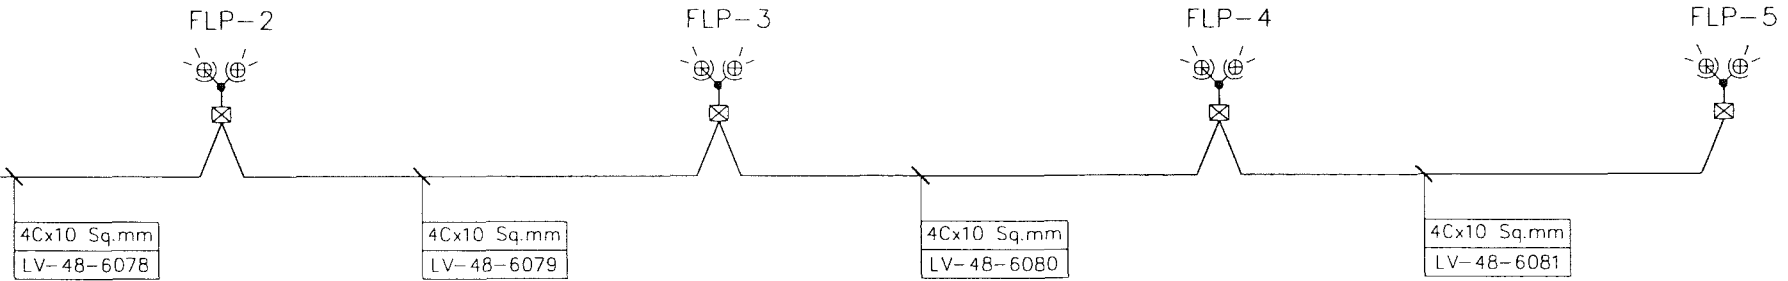


DISTRBUTION BOARD FEEDER-11/2
REF. NIM-4-6411-001-DQ

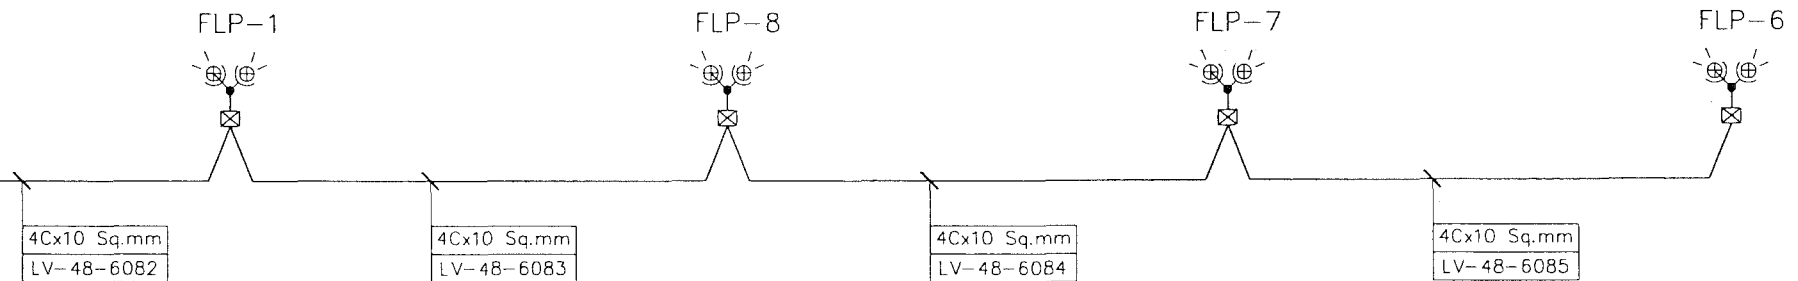

APPROVED FOR
CONSTRUCTION

THIS COMPLETE DRAWING IS NEW
AND FORMS PART OF SCOPE OF
PROJECT WBS# C.OM.NIM.IN.09.011

ITEM	LEGEND	DESCRIPTION
1		10M POLE MOUNTED FLOOD LIGHT FIXTURE WITH 250W HPSV LAMP (2 FITTINGS) TYPE: THORN SONPACK 250W HPS. T.

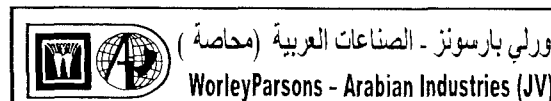

CONTRACT NO.: C31/0606 PROJ. NO.: PAIP-00405

REV	DATE	DRAWN BY	CHECKED BY	APPROVED BY	DESCRIPTION	WBS NO.	PROJ. ENG.	SIGNATURE
B	June '11	Khalid			REVISED & RE-ISSUED AS AFC	IN.09.011	OSE/28N	
A	MAY '11	AB	NMN	LM	APPROVED FOR CONSTRUCTION	IN.09.011	OSE/28N	
O	SEP '10	KHALID	KD	PVT	ISSUED FOR COMMENTS	IN.09.011	OSE/28N	
P D O APPROVAL								

PROJECT DRAWING REVISION
IN CASE OF DEVIATIONS A MARKED UP PRINT SHALL BE SENT TO THE PROJECT ENGINEER

REV	DATE	APPROVED BY	DESCRIPTION	B.I.NO.	PROJ.ENG.	SPEC.ENG.
3.			SLD DB NIM-4-6411-001-DQ			
2.			CABLE SCHEDULE NIM-4-6413-1/3-DQ			
1.			DRAWING CONTROL INDEX NIM-1-2635-400-DQ			
NOTES/REFERENCE DRAWINGS						
MASTER DRAWING REVISION IN CASE OF DEVIATIONS MARKED UP PRINT SHALL BE SENT TO COASTAL DESIGN OFFICE						

DRWG	AREA CODE	ENG SECT	SERIAL NUMBER	SHEET	PROJ CODE	DWG SIZE	REV.
NO	NIM	4	6412	001DQ	3	B	

Control & Automation Drawings

PAIP00405- Nimr Sludge Pit Up gradation.



Client : Petroleum Development Oman LLC (PDO)

Job No. : PAIP00405

Phase: AFC

Job Title : Nimr Sludge Pits System upgrade - FED & DD

Discipline Code: Control & Automation				Current Revision Detail			Earlier Revision Detail		
Item#	Document No	Size	Description:	Rev#	Date:	Status:	Rev#	Date:	Status:
1	NIM-5-4745-001-DQ	A3	Instrument loop Diagram (37 Sheets)	A	20-SEP-11	AFC	0	31-MAY-11	IF
2	NIM-5-5588-DQ	A3	SGS Functional Logic Diagram (9 Sheets)	A	20-SEP-11	AFC	0	08-JUN-11	IF
3	NIM-5-6079-DQ	A3	DCS Functional Logic Diagram (6 Sheets)	A	20-SEP-11	AFC	0	08-JUN-11	IF
4	NIM-5-6531-DQ	A3	Functional Logic Diagram-Sludge Pit (15 Sheets)	A	20-SEP-11	AFC	0	08-JUN-11	IF

FUNCTIONAL LOGIC DIAGRAMS

NIMR SLUDGE PIT

THIS COMPLETE DRAWING IS NEW AND
FORMS PART OF SCOPE OF PROJECT 'DQ'
WBS No. NIM.IN.09.011

**APPROVED FOR
CONSTRUCTION**

A	SEPT.'11	SUAD		APPROVED FOR CONSTRUCTION	IN.09.011	OSE/23N
0	JUNE'11	Hilal	PT BM	ISSUED FOR COMMENTS	IN.09.011	OSE/23N OSE/23N
REV	DATE	DRAWN BY	TEAML. J.ENG. CHECKED	DESCRIPTION	B.I. NO	PROJ. ENG. SIGNATURE P D O APPROVAL

PROJECT DRAWING REVISION
IN CASE OF DEVIATIONS A MARKED UP PRINT SHALL BE SENT TO THE PROJECT ENGINEER

AREA : NIMR	SCALE : — 0 1 2 3 4 5 6 7
SUB AREA : NIMR SLUDGE PIT	 شركة تنمية نفط عُمان Petroleum Development Oman
DRWG. TYPE : RTU FUNCTIONAL LOGIC DIAGRAM	
DESCRIPTION : COVER SHEET	

DRWG	AREA CODE	ENG SECT	SERIAL NUMBER	SHEET	PROJ CODE	DWG SIZE	REV.
NO	NIM	5	6531	001DQ	3	A	

REV	DATE	APPROVED BY	DESCRIPTION	WBS No 'B.I.'NO.	PROJ.ENG.	SPEC.ENG.

NOTES/REFERENCE DRAWINGS
IN CASE OF DEVIATIONS MARKED UP PRINT SHALL BE SENT TO COASTAL DESIGN OFFICE


MASTER DRAWING REVISION




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001	Cover SHEET	JUNE'11	SEPT.'11				037						
002	REVISION/INDEX SHEET	JUNE'11	SEPT.'11				038						
003							039						
004							040						
005							041						
006							042						
007	SYMBOLS & GENERAL NOTES	JUNE'11	SEPT.'11				043						
008							044						
009							045						
010	48-UZ-2656/58: SLUDGE OIL TRANSFER PUMPS P-48357/58	JUNE'11	SEPT.'11				046						
011	48-UZ-2656/58: SLUDGE OIL TRANSFER PUMPS P-48357/58	JUNE'11	SEPT.'11				047						
012	48-UZ-2656/58: SLUDGE OIL TRANSFER PUMPS P-48357/58	JUNE'11	SEPT.'11				048						
013	48-UZ-2656/58: SLUDGE OIL TRANSFER PUMPS P-48357/58	JUNE'11	SEPT.'11				049						
014	48-UZ-2656/58: SLUDGE OIL TRANSFER PUMPS P-48357/58	JUNE'11	SEPT.'11				050						
015	48-UZ-2656/58: SLUDGE OIL TRANSFER PUMPS P-48357/58	JUNE'11	SEPT.'11				051						
016	48-UZ-2656/58: SLUDGE OIL TRANSFER PUMPS P-48357/58	JUNE'11	SEPT.'11				052						
017	SPARE						053						
018	48-UZ-2657: OXYGEN SCAVANGER DOSING PUMPS P-48359/60	JUNE'11	SEPT.'11				054						
019	48-UZ-2657: OXYGEN SCAVANGER DOSING PUMPS P-48359/60	JUNE'11	SEPT.'11				055						
020	48-UZ-2657: OXYGEN SCAVANGER DOSING PUMPS P-48359/60	JUNE'11	SEPT.'11				056						
021	48-UZ-2657: OXYGEN SCAVANGER DOSING PUMPS P-48359/60	JUNE'11	SEPT.'11				057						
022	48-UZ-2657: OXYGEN SCAVANGER DOSING PUMPS P-48359/60	JUNE'11	SEPT.'11				058						
023							059						
024							060						
025							061						
026							062						
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<div style="display: flex; justify-content: space-between;"> <div style="width: 45%;"> <table border="1" style="width: 100%; border-collapse: collapse;"> <thead> <tr> <th>REV</th> <th>DATE</th> <th>APPROVED BY</th> <th>DESCRIPTION</th> <th>WBS No B.I.NO.</th> <th>PROJ.ENG.</th> <th>SPEC.ENG.</th> </tr> </thead> <tbody> <tr> <td> </td> <td> </td> <td> </td> <td> </td> <td> </td> <td> </td> <td> </td> </tr> </tbody> </table> </div> <div style="width: 45%;"> <p>DRWG TYPE : RTU FUNCTIONAL LOGIC DIAGRAM</p> <p>DESCRIPTION : REVISION/INDEX SHEET</p> </div> </div>								REV	DATE	APPROVED BY	DESCRIPTION	WBS No B.I.NO.	PROJ.ENG.	SPEC.ENG.								 شركة تنمية نفط عمان Petroleum Development Oman		<table border="1" style="width: 100%; border-collapse: collapse;"> <thead> <tr> <th>DRWG</th> <th>AREA CODE</th> <th>ENG SECT</th> <th>SERIAL NUMBER</th> <th>SHEET</th> <th>PROJ CODE</th> <th>DWG SIZE</th> <th>REV.</th> </tr> </thead> <tbody> <tr> <td> </td> <td> </td> <td> </td> <td> </td> <td> </td> <td> </td> <td> </td> <td> </td> </tr> </tbody> </table>		DRWG	AREA CODE	ENG SECT	SERIAL NUMBER	SHEET	PROJ CODE	DWG SIZE	REV.								
REV	DATE	APPROVED BY	DESCRIPTION	WBS No B.I.NO.	PROJ.ENG.	SPEC.ENG.																																			
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NO																																									
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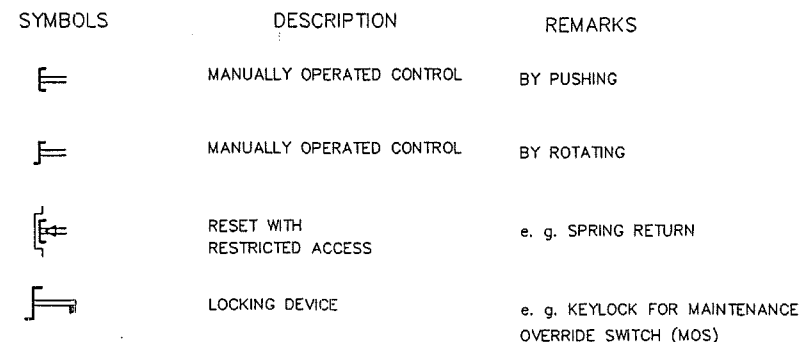
BII / LOGIC FUNCTION SYMBOLS




INPUT/OUTPUT FUNCTION SYMBOLS

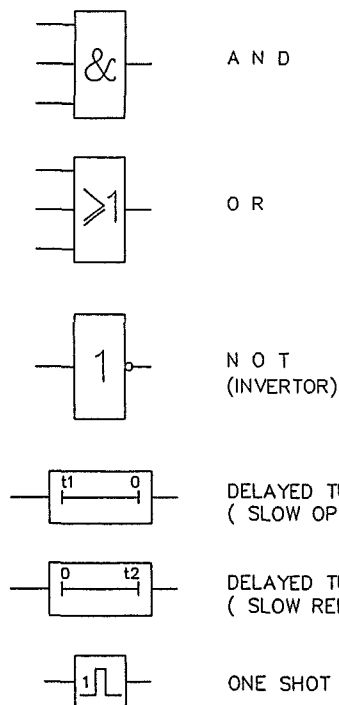


INPUT LOGIC ELEMENTS 'X' AND 'Y'

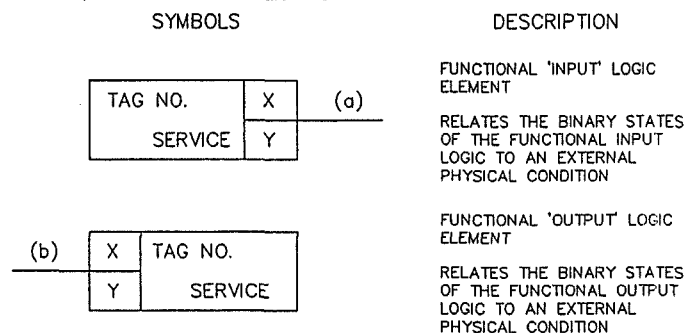

ALARM OUTPUT SIGNAL

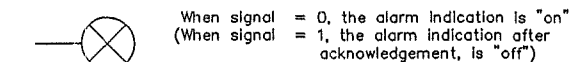


STATUS OUTPUT SIGNAL

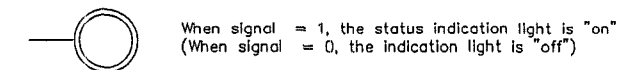

SIGNAL POWER

ALL SIGNALS TO IFB AND TO ESD VALVES TO BE POWERED 24V DC CONTACTS

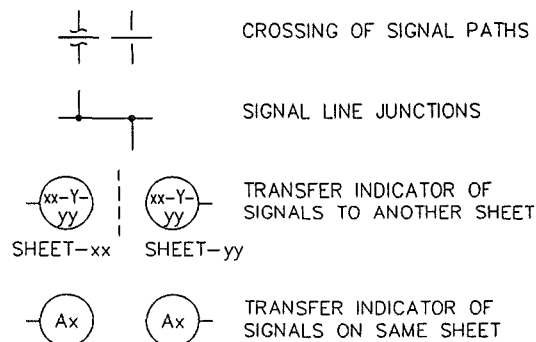



ABBREVIATIONS

A	=	ALARM
DCS	=	DISTRIBUTED CONTROL SYSTEM
F	=	FIRE
FLD	=	FIELD
HW	=	HARD WIRED
IFB	=	INTERFACE BOX
OC	=	ESD PANEL ON OPERATOR CONSOLE
RML	=	REMOTE MANIFOLD LOCATION
ROV	=	REMOTE OPERATED VALVE
RTD	=	RESISTANCE TEMPERATURE DEVICE
SCADA	=	SUPERVISORY CONTROL AND DATA ACQUISITION
SK	=	SOFTKEY
SL	=	SERIAL LINK
SSL	=	SAFEGUARDING SYSTEM LOGIC
S/D	=	SHUTDOWN
UCP	=	UNIT CONTROL PANEL
xx-DS-xxx	=	TAGNUMBER FOR COMMUNICATION DCS — SSL
MCC	=	INTERGRATED MOTOR CONTROL CENTER

AREA : NIMR								SCALE : 0 1 2 3 4 5 6 7								CAD DRAWING			
SUB AREA : NIMR SLUDGE PIT								No. 05								شركة تنمية نفط عمان Petroleum Development Oman			
DRWG. TYPE : RTU FUNCTIONAL LOGIC DIAGRAM								DRWG. AREA ENG SECT SERIAL NUMBER SHEET PROJ CODE DWG SIZE REV.											
DESCRIPTION : SYMBOLS & GENERAL NOTES								NO NIM 5 6531 007 DQ 3 A											
NOTES/REFERENCE DRAWINGS IN CASE OF DEVIATIONS MARKED UP PRINT SHALL BE SENT TO COASTAL DESIGN OFFICE								MASTER DRAWING REVISION APPROVED BY DATE DESCRIPTION B.I.NO. PROJ.ENG. SPEC.ENG. PDO APPROVAL											



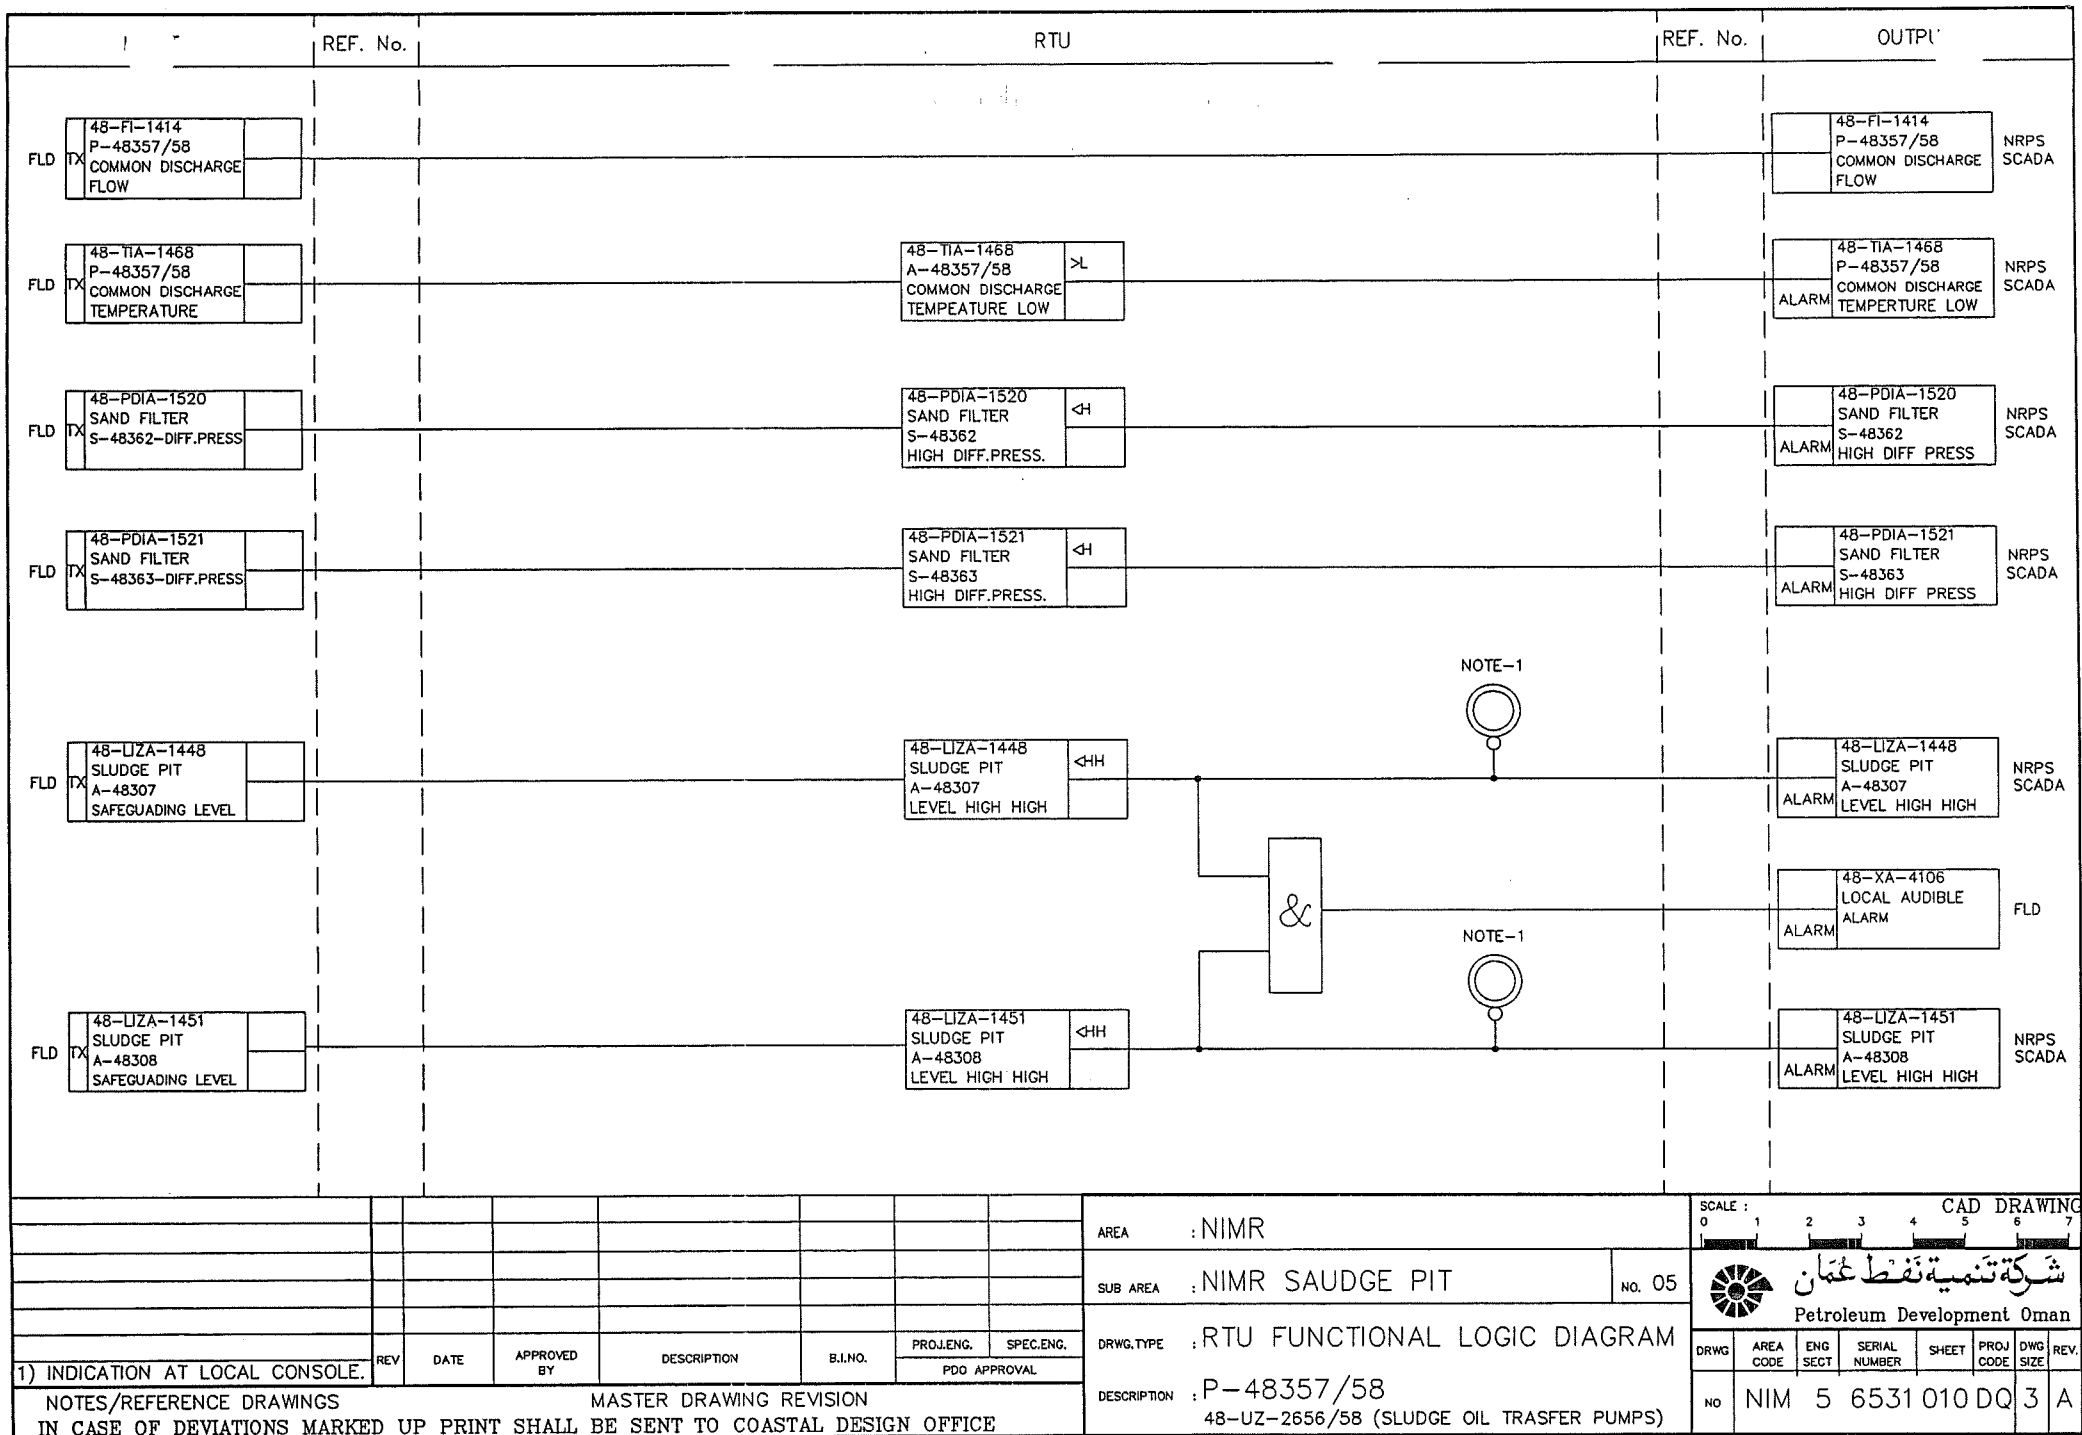


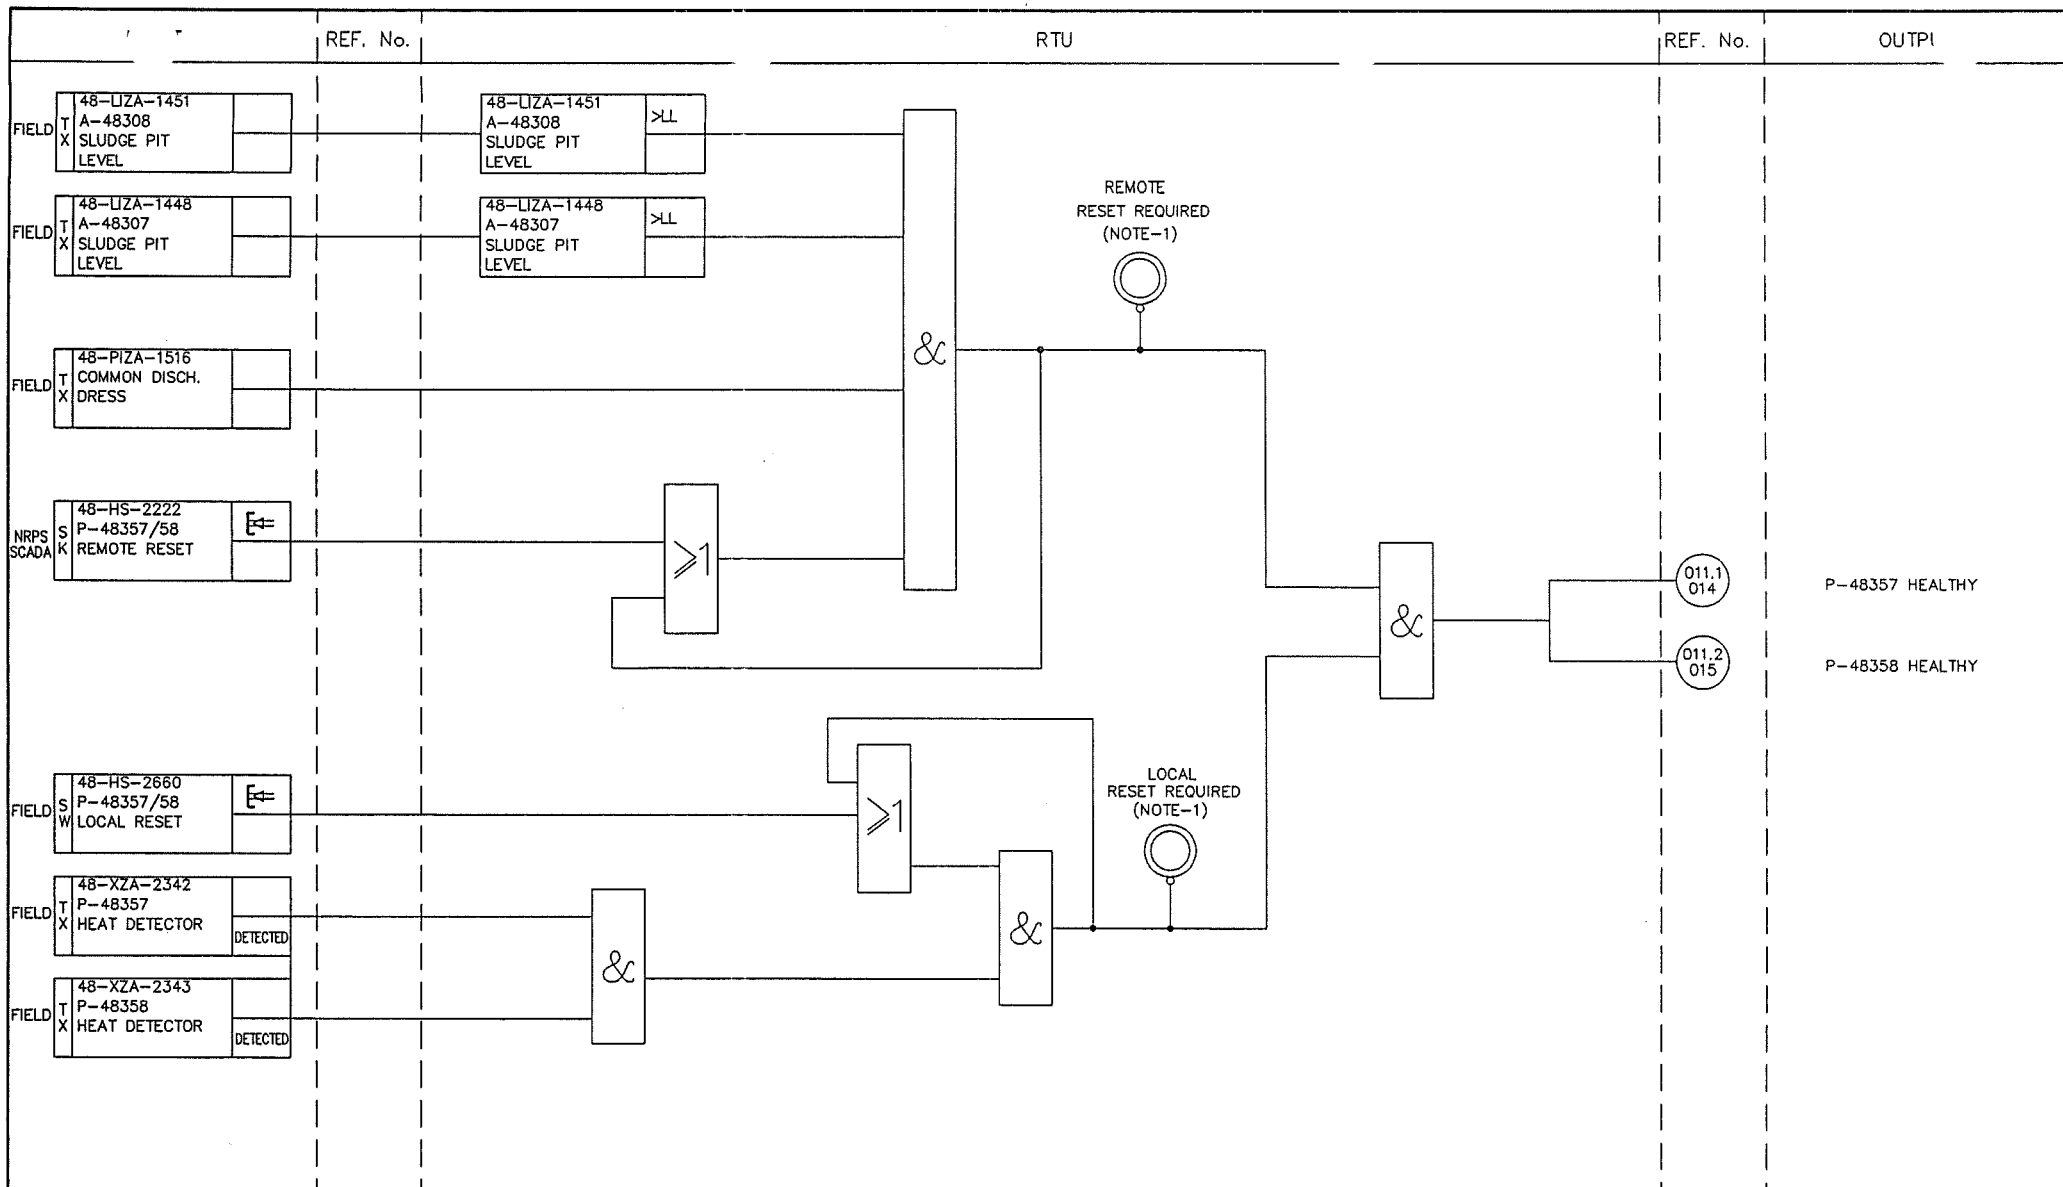


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										SUB AREA : NIMR SLUDGE PIT		CAD DRAWING	
										NO. 05			
										DRWG. TYPE : RTU FUNCTIONAL LOGIC DIAGRAM		شركة تنمية نفط عمان Petroleum Development Oman	
										DESCRIPTION : P-48357/58		DRWG AREA ENG SERIAL SHEET PROJ DWG REV. NO NIM 5 6531 011 DQ 3 A	
										48-UZ-2656/58 (SLUDGE OIL TRASFER PUMPS)			


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NOTES/REFERENCE DRAWINGS MASTER DRAWING REVISION
 IN CASE OF DEVIATIONS MARKED UP PRINT SHALL BE SENT TO COASTAL DESIGN OFFICE

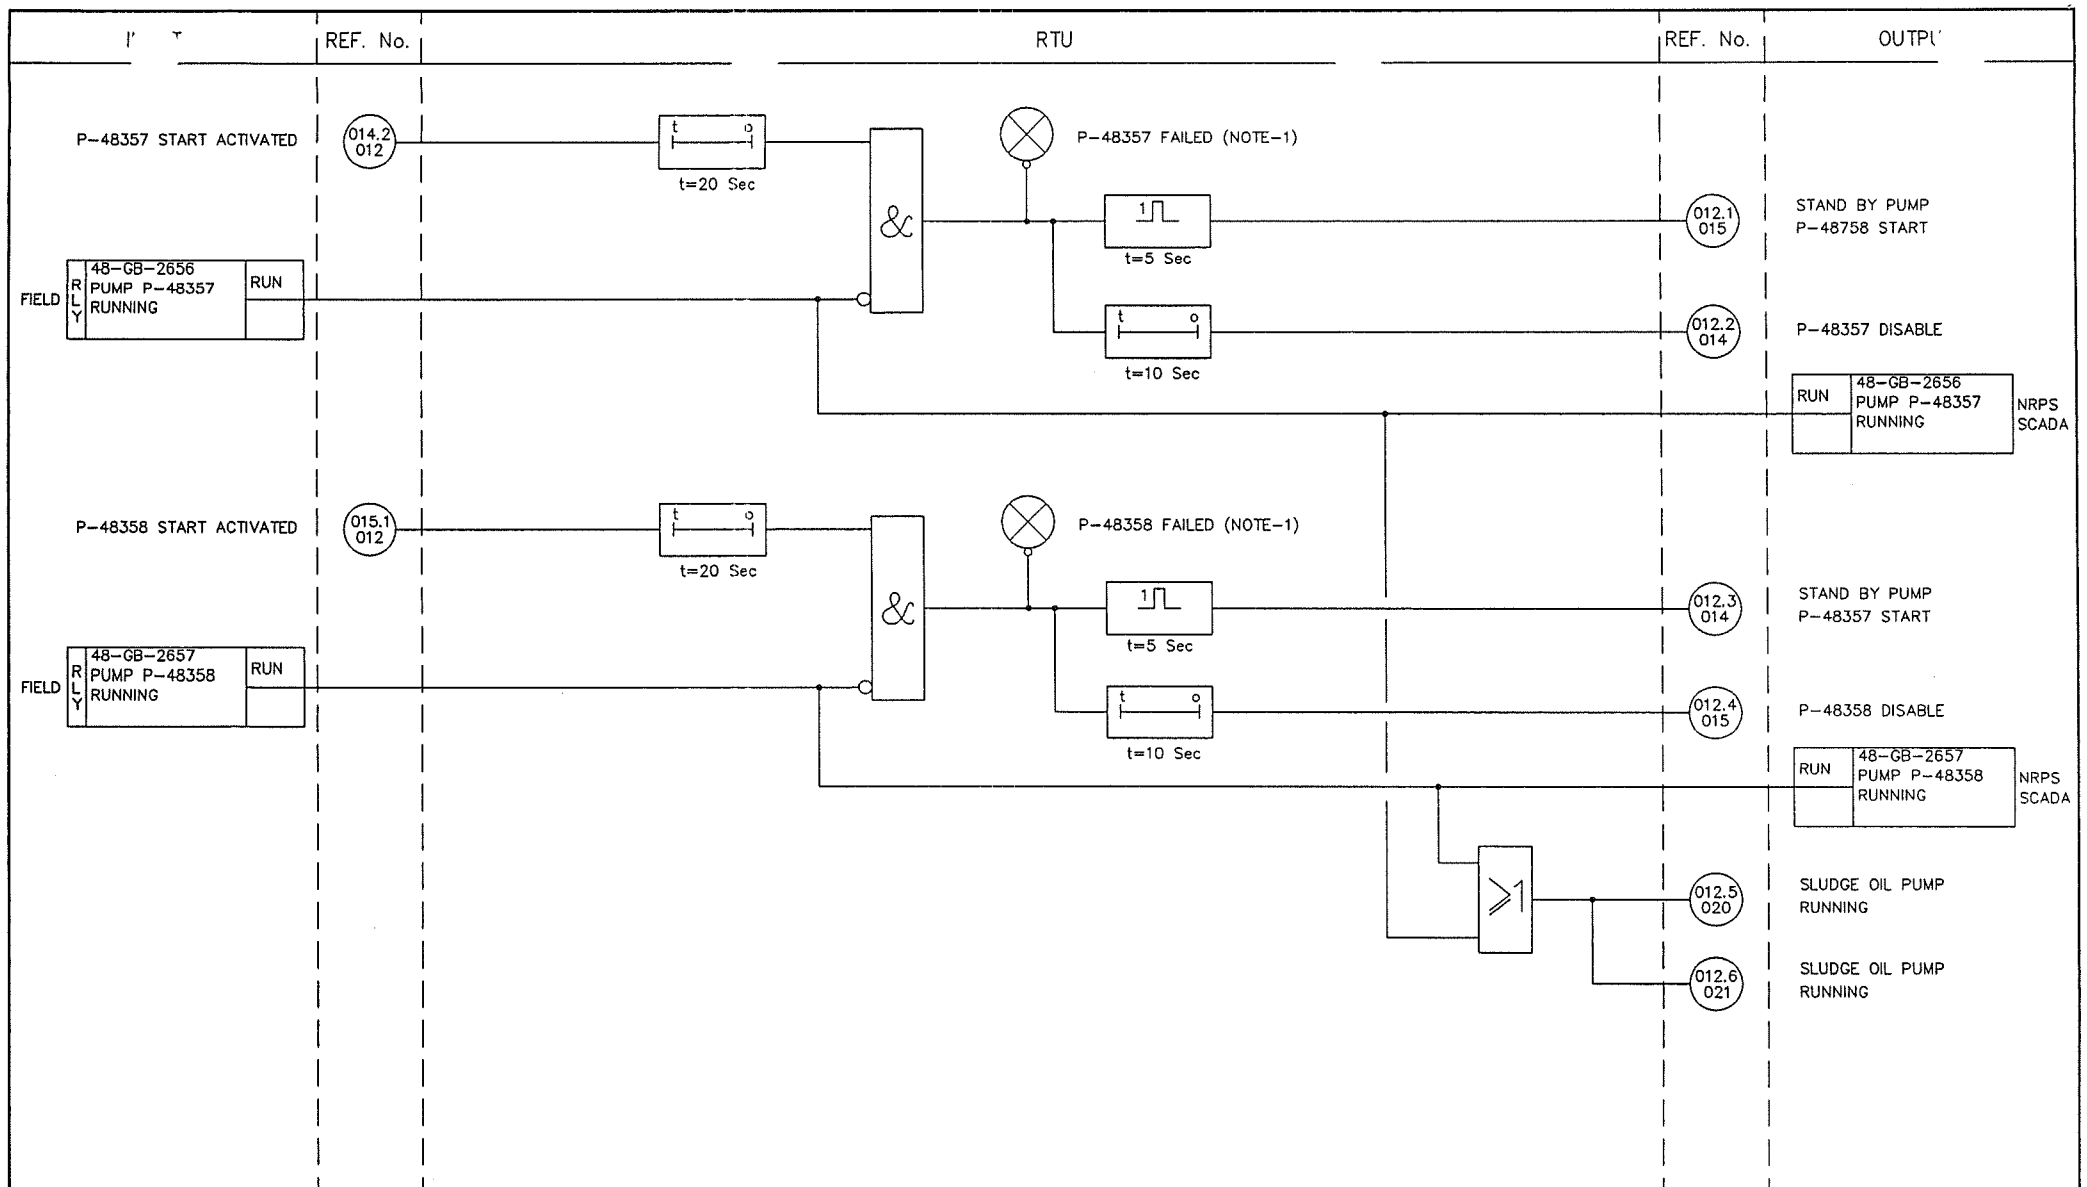



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						SUB AREA : NIMR SLUDGE PIT		NO. 05		شركة تنمية نفط عمان Petroleum Development Oman	
						DRWG. TYPE : RTU FUNCTIONAL LOGIC DIAGRAM				DRWG AREA ENG SERIAL SHEET PROJ DWG REV CODE SECT NUMBER NUMBER CODE SIZE	
						DESCRIPTION : P-48357/58				NO NIM 5 6531 012 DQ 3 A	
						48-UZ-2656/58 (SLUDGE OIL TRASFER PUMPS)					
REV	DATE	APPROVED BY	DESCRIPTION	B.I.NO.	PROJ.ENG.	SPEC.ENG.					
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NOTES/REFERENCE DRAWINGS						MASTER DRAWING REVISION					
IN CASE OF DEVIATIONS MARKED UP PRINT SHALL BE SENT TO COASTAL DESIGN OFFICE											

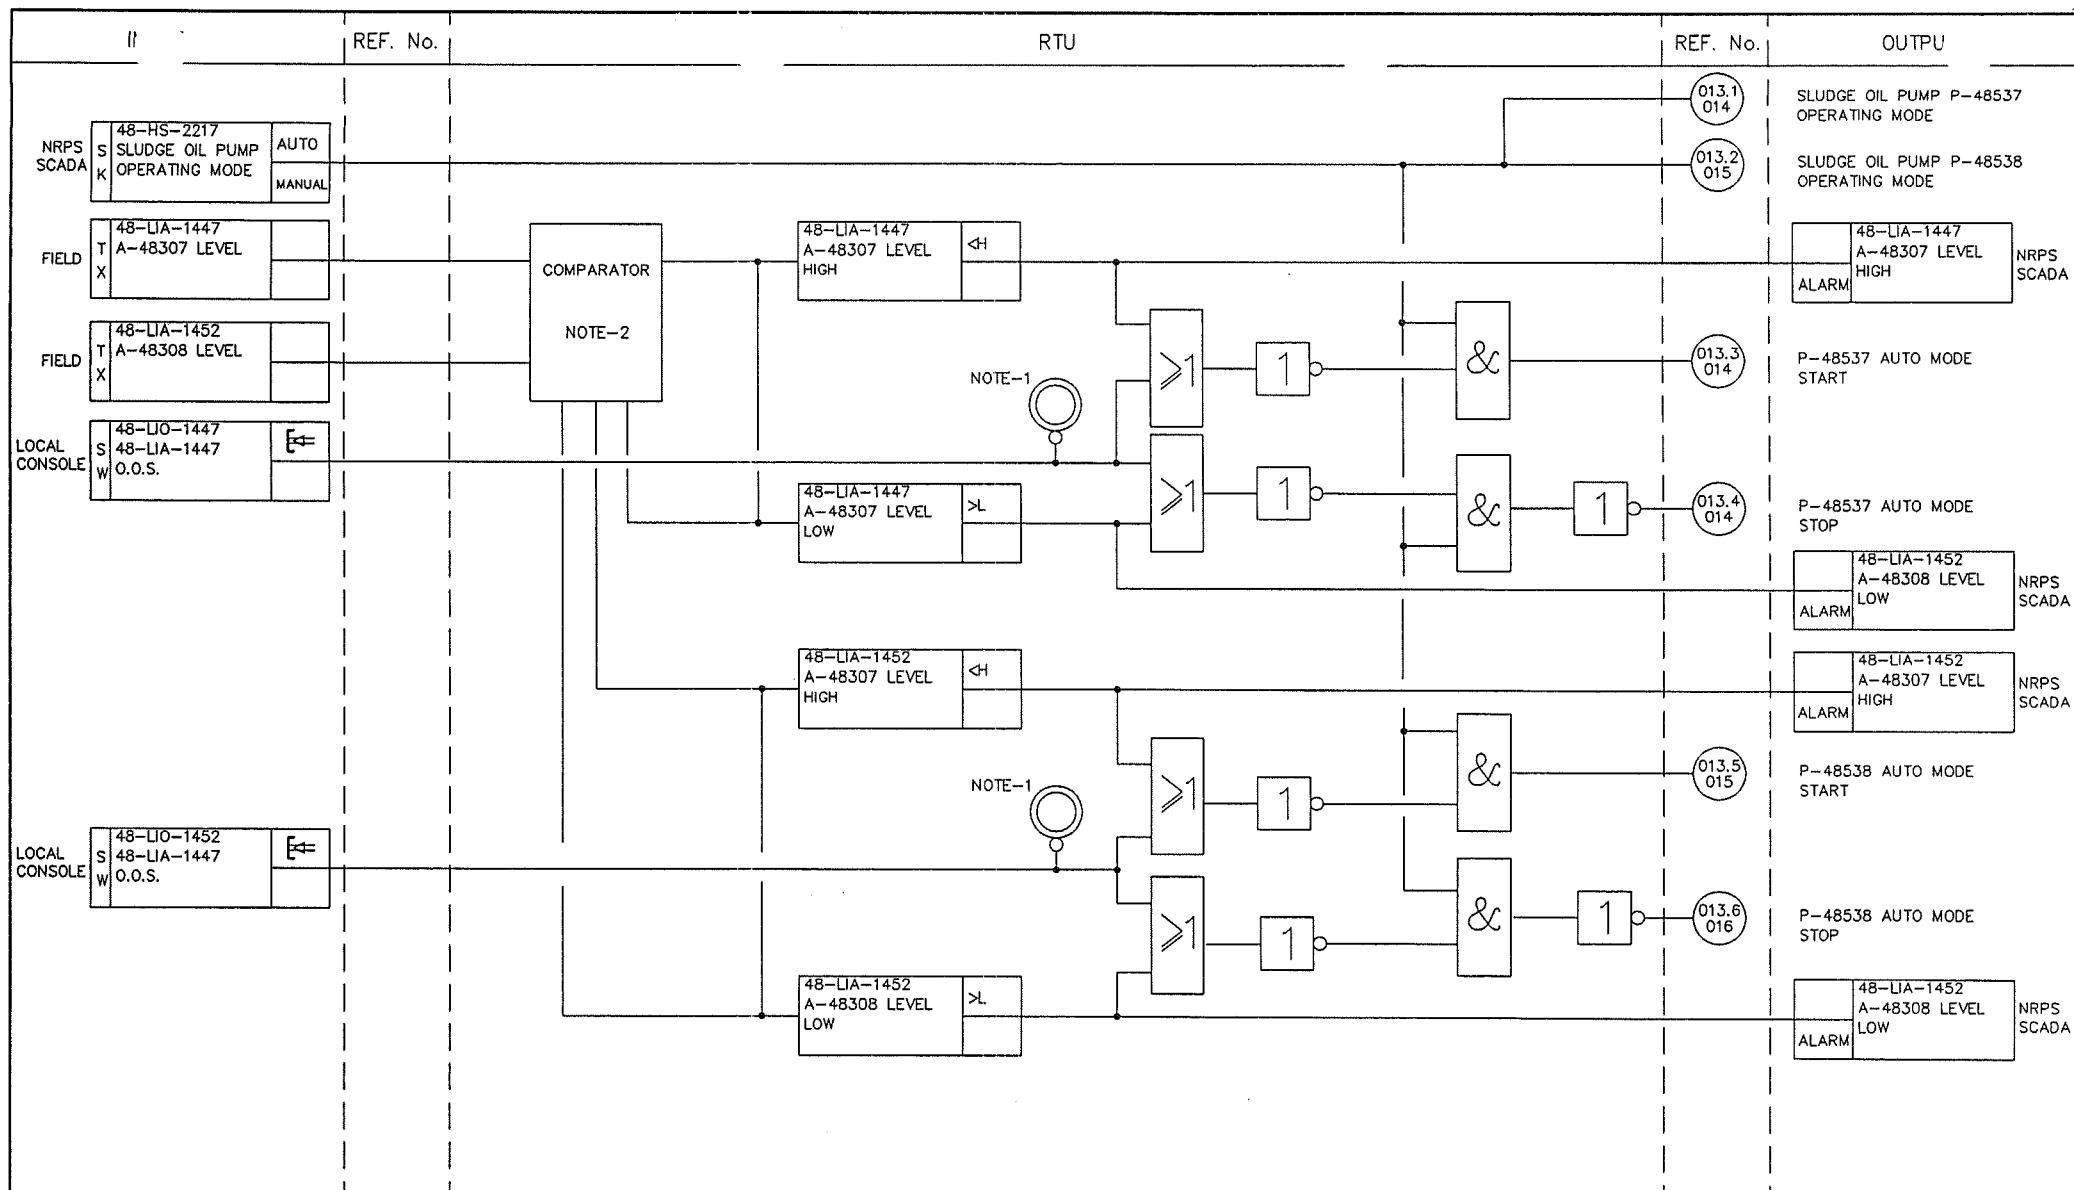


2) THIS FN. BLOCK SELECTS HIGHER VALUE OF										AREA : NIMR		SCALE : 0 1 2 3 4 5 6 7		CAD DRAWING		
LEVELS IN BOTH THE PITS, WHEN THE										SUB AREA : NIMR SLUDGE PIT		NO. 05		 شركة تنمية نفط عمان Petroleum Development Oman		
LEVEL INCREASES ABOVE 1000mm & SELECTS										DRWG. TYPE : RTU FUNCTIONAL LOGIC DIAGRAM						
LOWER VALUE WHEN THE LEVEL DECREASES										DESCRIPTION : P-48357/58		DRWG		AREA	ENG	
BELOW 1000mm.		REV	DATE	APPROVED BY	DESCRIPTION	B.I.NO.	PROJ.ENG.	SPEC.ENG.		48-UZ-2656/58 (SLUDGE OIL TRANSFER PUMP)		NO	CODE	SECT	SHEET	
1) INDICATION AT LOCAL CONSOLE.							PDO APPROVAL						NUMBER	PROJ CODE	DWG SIZE	
NOTES/REFERENCE DRAWINGS		MASTER DRAWING REVISION								NO NIM 5 6531 013 DQ 3 A						
IN CASE OF DEVIATIONS MARKED UP PRINT SHALL BE SENT TO COASTAL DESIGN OFFICE																



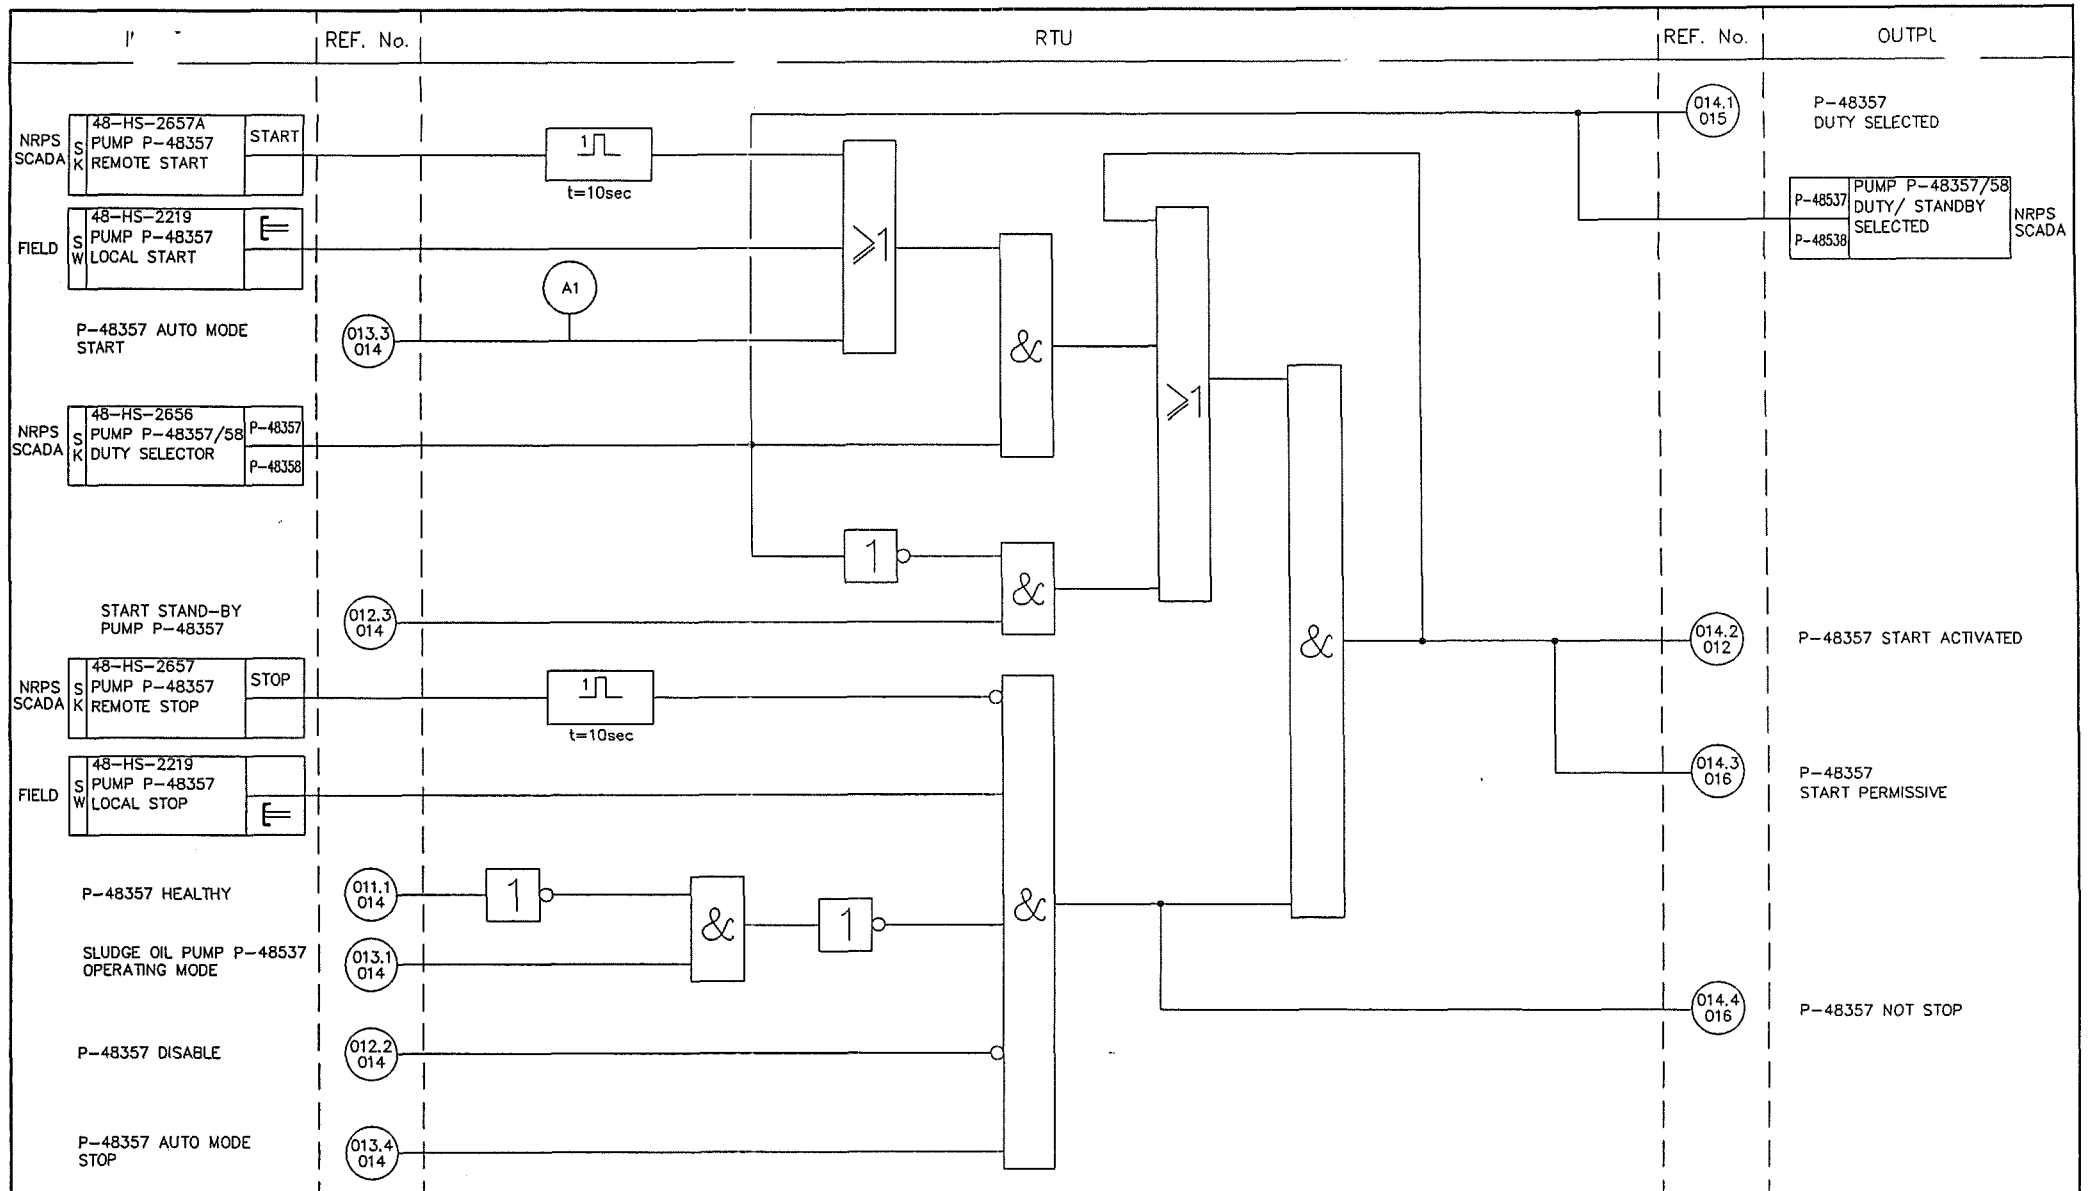


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											ENG SECT	
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											SHEET	
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											NO	
											NIM 5 6531 014 DQ 3 A	

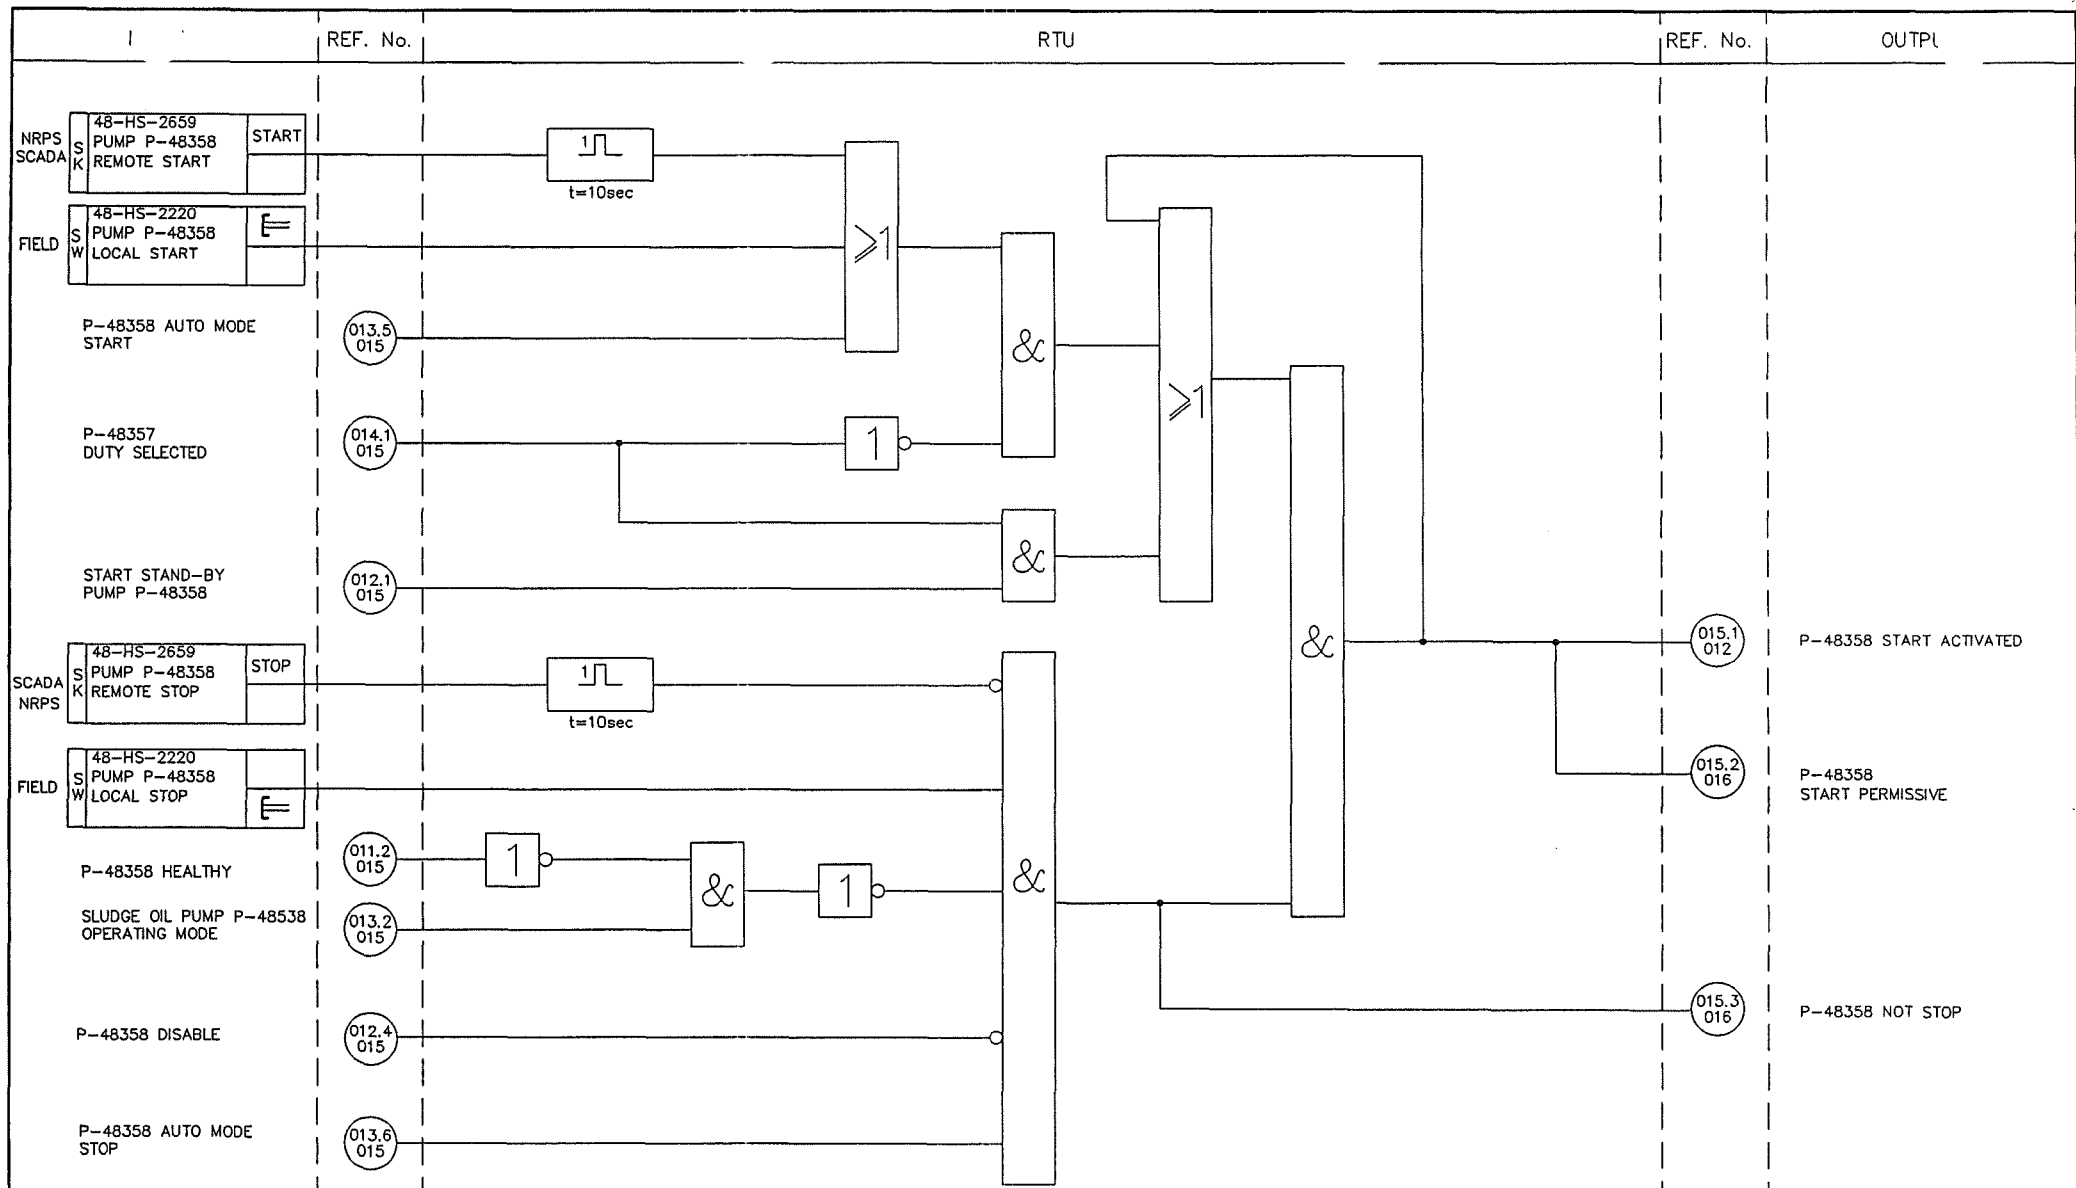

								SCALE : 0 1 2 3 4 5 6 7		CAD DRAWING	
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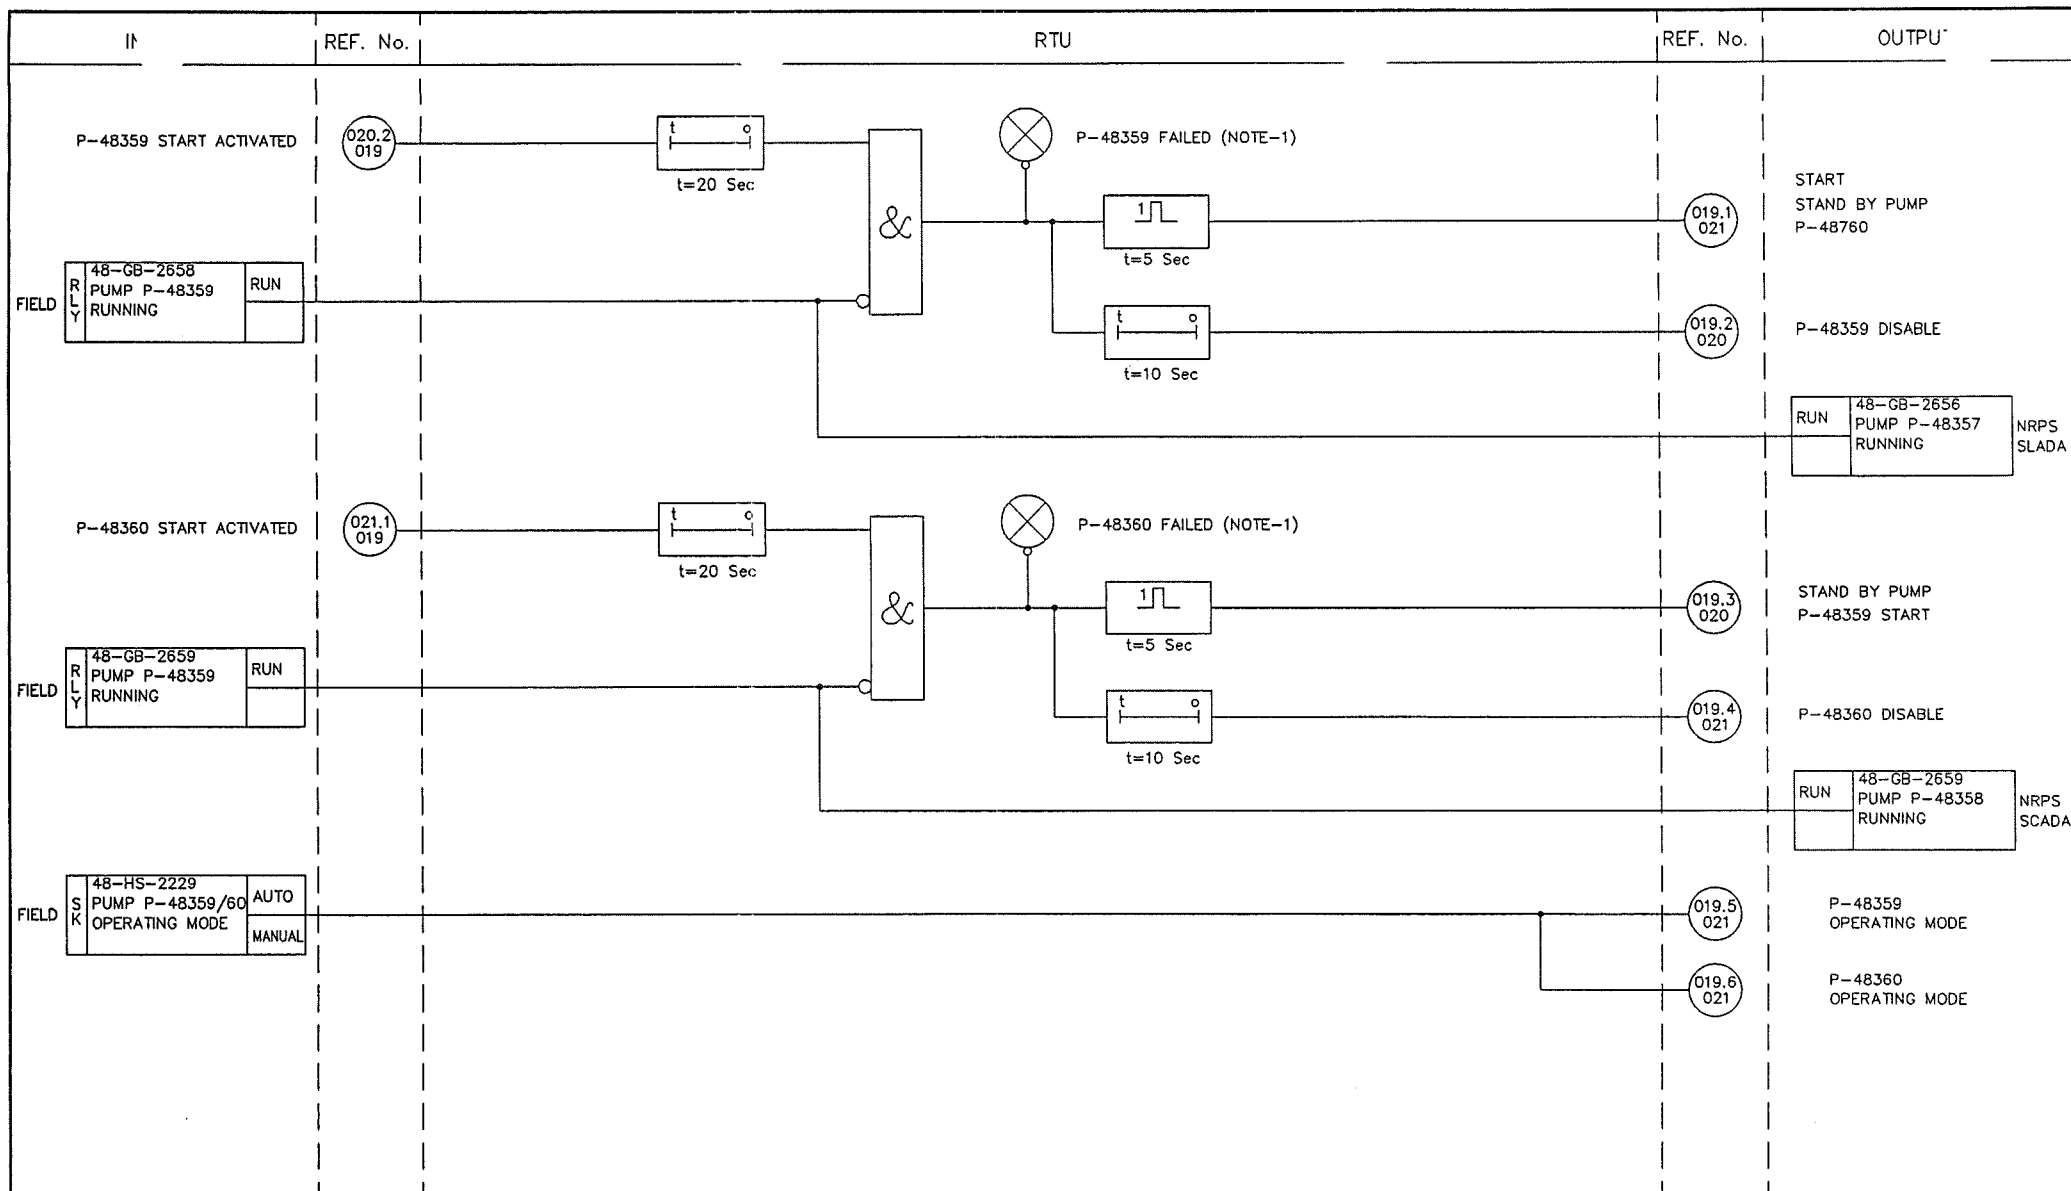
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NOTES/REFERENCE DRAWINGS MASTER DRAWING REVISION
 IN CASE OF DEVIATIONS MARKED UP PRINT SHALL BE SENT TO COASTAL DESIGN OFFICE



					AREA : NIMR		SCALE : 0 1 2 3 4 5 6 7		CAD DRAWING		
					SUB AREA : NIMR PRODUCTION STATION		No. 01		شركة تنمية نفط عمان Petroleum Development Oman		
					DRWG TYPE : RTU FUNCTIONAL LOGIC DIAGRAM						
					DESCRIPTION : 48-UZ-2657 P-48359/60 (OXYGEN SCAVENGER DOSING PUMPS)		DRWG NO : NIM 5 6531 018 DQ 3 A				
					1) INDICATION AT LOCAL CONSOLE.		REV DATE APPROVED BY DESCRIPTION B.I.NO. PROJ.ENG. SPEC.ENG. PDO APPROVAL				
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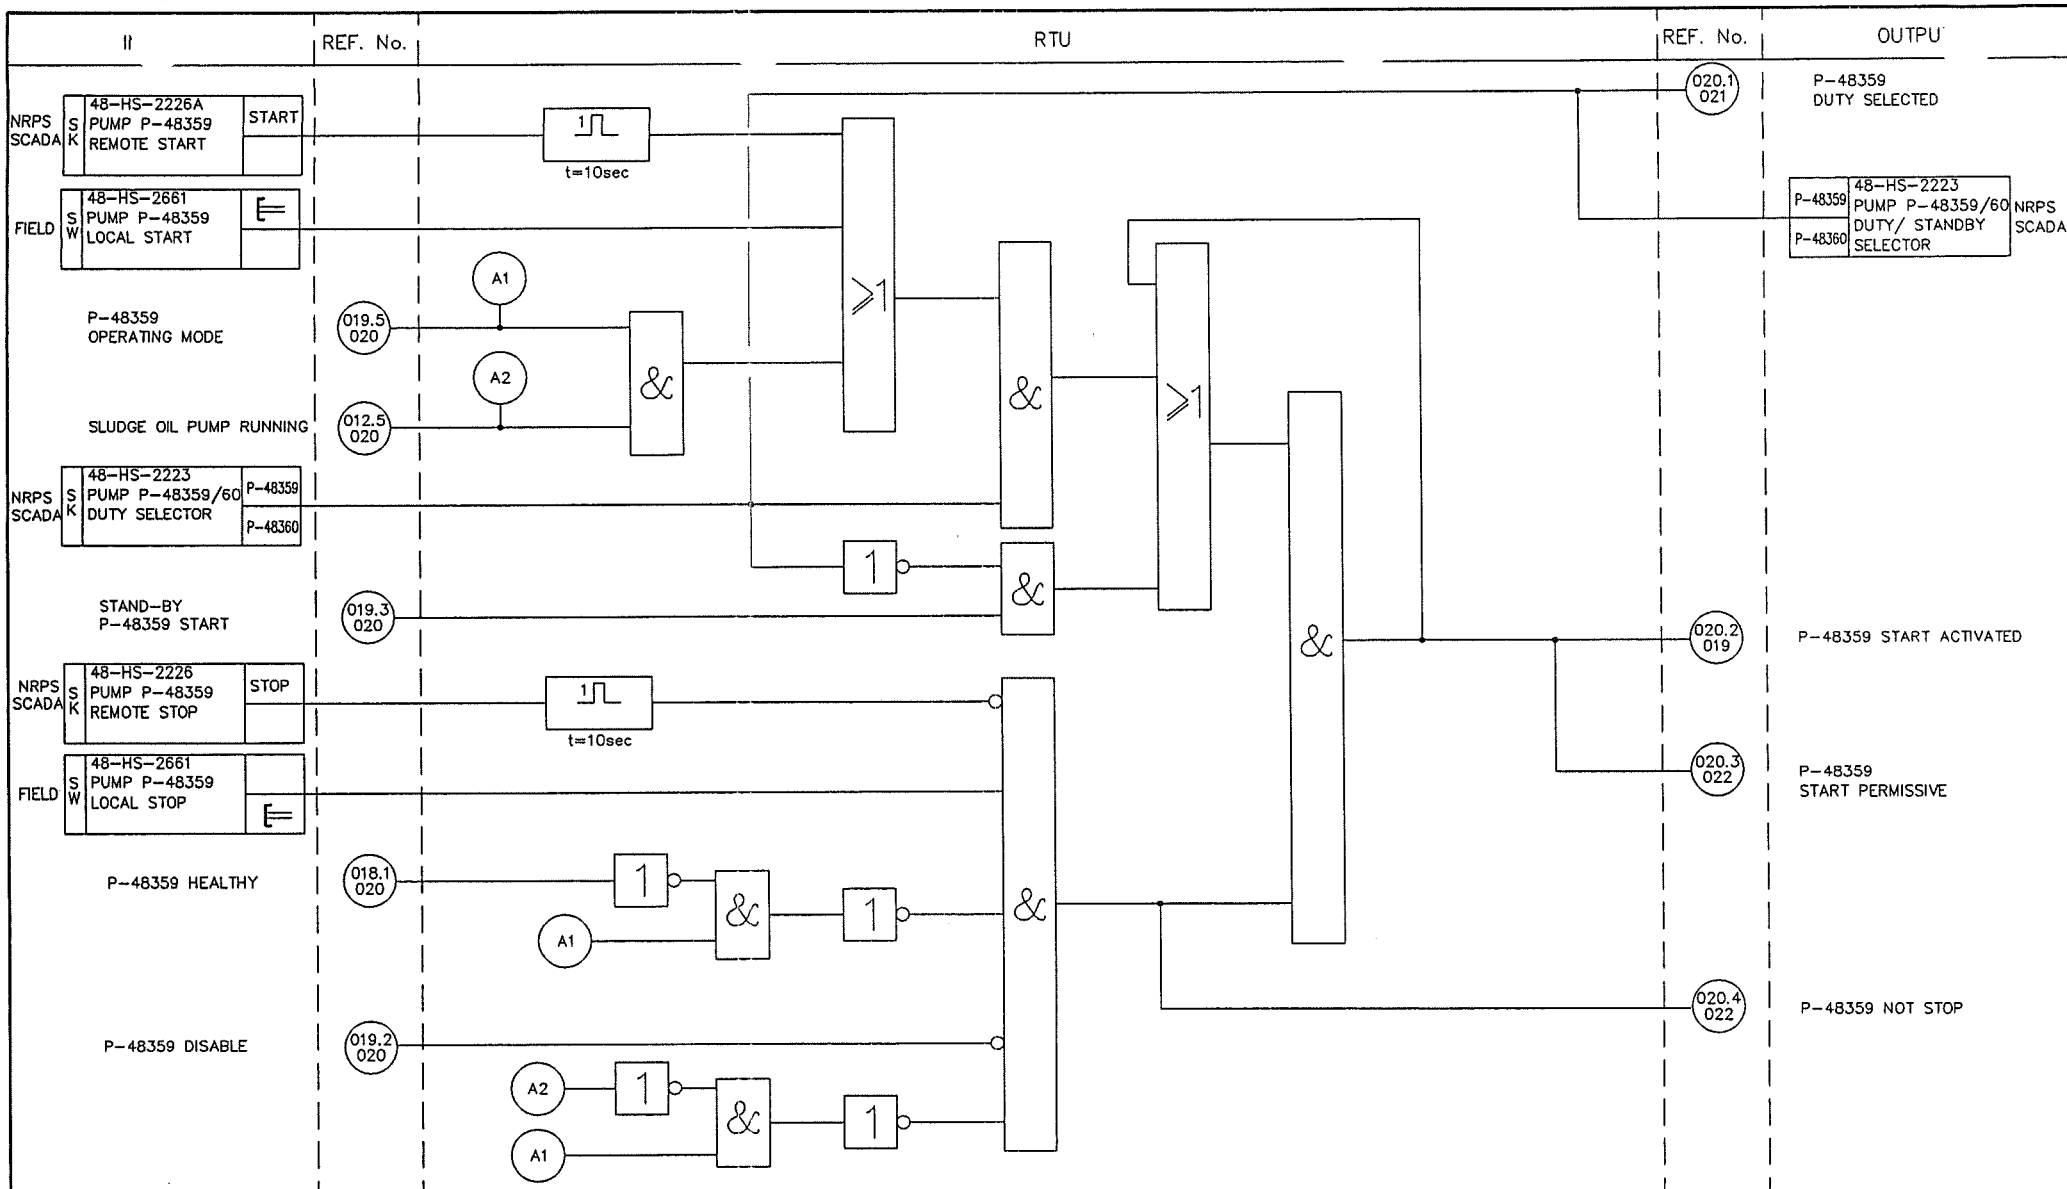
1) ALARM AT NRPS

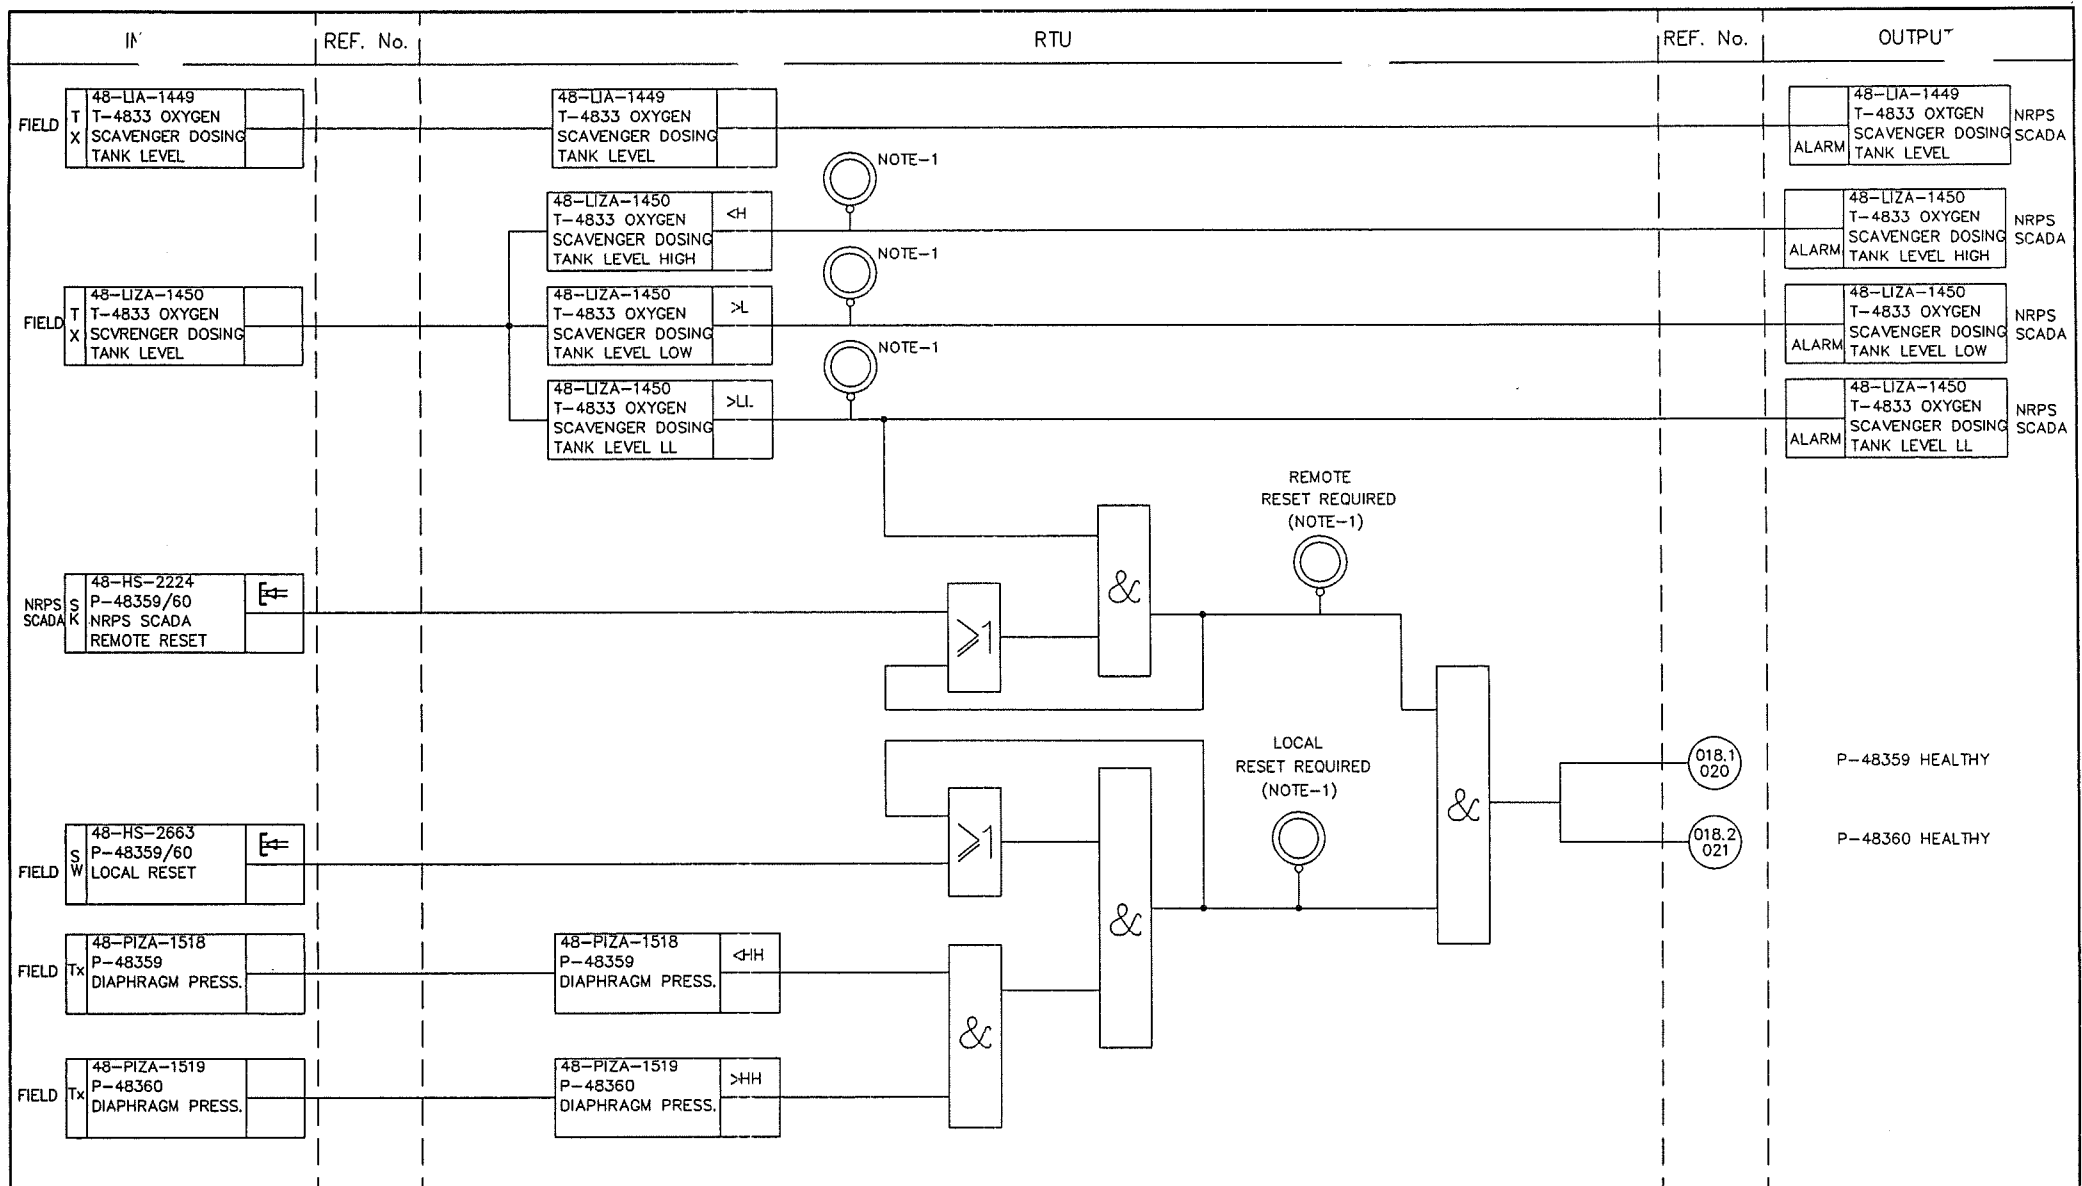								AREA : NIMR		SCALE : 0 1 2 3 4 5 6 7 CAD DRAWING																	
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								DRWG. TYPE : RTU FUNCTIONAL LOGIC DIAGRAM																			
								DESCRIPTION : 48-UZ-2657 P-48359/60 (OXYGEN SCAVENGER DOSING PUMPS)																			
REV	DATE	APPROVED BY	DESCRIPTION	B.I.NO.	PROJ.ENG.	SPEC.ENG.	PDD APPROVAL	<div style="display: flex; align-items: center;"> <div style="text-align: right;"> <p>شركة تنمية نفط عمان</p> <p>Petroleum Development Oman</p> </div> </div> <table border="1" style="width: 100%; border-collapse: collapse; font-size: 8px;"> <tr> <th>DRWG</th> <th>AREA CODE</th> <th>ENG SECT</th> <th>SERIAL NUMBER</th> <th>SHEET</th> <th>PROJ CODE</th> <th>DWG SIZE</th> <th>REV.</th> </tr> <tr> <td>NIM</td> <td>5</td> <td>6531</td> <td>019</td> <td>DQ</td> <td>3</td> <td>A</td> <td></td> </tr> </table>				DRWG	AREA CODE	ENG SECT	SERIAL NUMBER	SHEET	PROJ CODE	DWG SIZE	REV.	NIM	5	6531	019	DQ	3	A	
DRWG	AREA CODE	ENG SECT	SERIAL NUMBER	SHEET	PROJ CODE	DWG SIZE	REV.																				
NIM	5	6531	019	DQ	3	A																					

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MASTER DRAWING REVISION






										AREA : NIMR		SCALE : 0 1 2 3 4 5 6 7 CAD DRAWING																	
										SUB AREA : NIMR PRODUCTION STATION		NO. 01																	
										DRWG. TYPE : RTU FUNCTIONAL LOGIC DIAGRAM		 شركة تنمية نفط عمان Petroleum Development Oman																	
										DESCRIPTION : 48-UZ-2657 P-48359 (OXYGEN SCAVENGER DOSING PUMP)		<table border="1" style="width:100%; border-collapse: collapse;"> <tr> <th>DRWG.</th> <th>AREA CODE</th> <th>ENG SECT</th> <th>SERIAL NUMBER</th> <th>SHEET</th> <th>PROJ CODE</th> <th>DWG SIZE</th> <th>REV.</th> </tr> <tr> <td>NO</td> <td>NIR</td> <td>5</td> <td>6531</td> <td>020</td> <td>DQ</td> <td>3</td> <td>A</td> </tr> </table>		DRWG.	AREA CODE	ENG SECT	SERIAL NUMBER	SHEET	PROJ CODE	DWG SIZE	REV.	NO	NIR	5	6531	020	DQ	3	A
DRWG.	AREA CODE	ENG SECT	SERIAL NUMBER	SHEET	PROJ CODE	DWG SIZE	REV.																						
NO	NIR	5	6531	020	DQ	3	A																						

REV	DATE	APPROVED BY	DESCRIPTION	B.I.NO.	PROJ.ENG.	SPEC.ENG.	P.D.O. APPROVAL


NOTES/REFERENCE DRAWINGS MASTER DRAWING REVISION
IN CASE OF DEVIATIONS MARKED UP PRINT SHALL BE SENT TO COASTAL DESIGN OFFICE

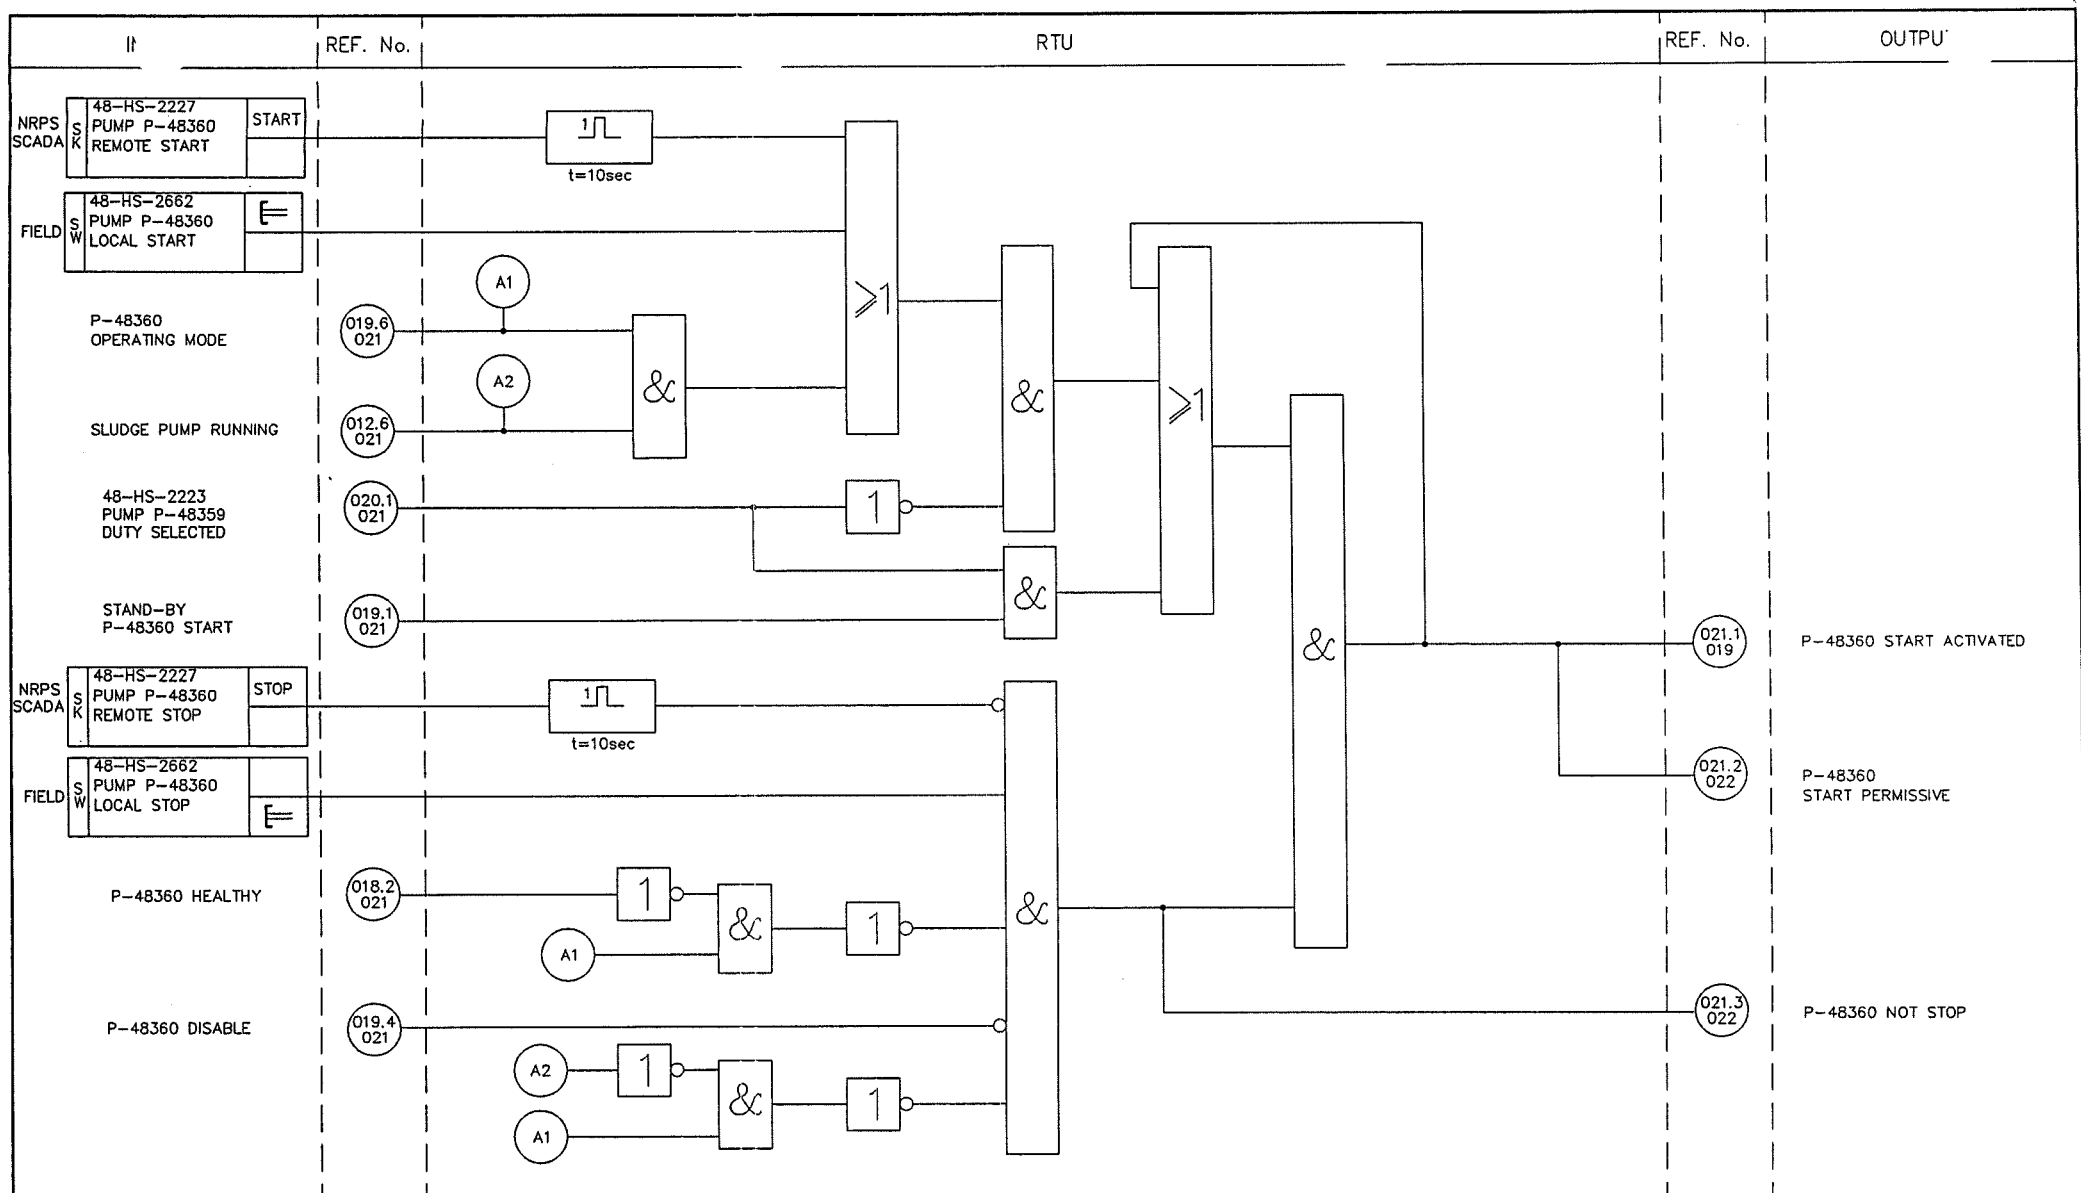

								SCALE : 0 1 2 3 4 5 6 7		CAD DRAWING	
								AREA : NIMR		SUB AREA : NIMR PRODUCTION STATION NO. 01	
								DRWG. TYPE : RTU FUNCTIONAL LOGIC DIAGRAM		DESCRIPTION : 48-UZ-2657 P-48360 (OXYGEN SCAVENGER DOSING PUMP)	
								REV		NO	
								DATE		REV	
								APPROVED BY		REV	
								DESCRIPTION		REV	
								B.I.NO.		REV	
								PROJ.ENG.		REV	
								SPEC.ENG.		REV	
								P.D.O. APPROVAL		REV	
								NOTES/REFERENCE DRAWINGS		MASTER DRAWING REVISION	
								IN CASE OF DEVIATIONS MARKED UP PRINT SHALL BE SENT TO COASTAL DESIGN OFFICE			



IT	REF. No.	RTU	REF. No.	OUTPUT
PUMP P-48359 START PERMISSIVE	020.3 022			<div>START</div> <div>P-48359 "START"</div> <div>TO PUMP MOTOR CB</div>
PUMP P-48359 NOT STOP	020.4 022			<div>STOP</div> <div>P-48359 "STOP"</div> <div>TO PUMP MOTOR CB</div>
PUMP P-48360 START PERMISSIVE	021.2 022			<div>START</div> <div>P-48360 "START"</div> <div>TO PUMP MOTOR CB</div>
PUMP P-48360 NOT STOP	021.3 022			<div>STOP</div> <div>P-48360 "STOP"</div> <div>TO PUMP MOTOR CB</div>

								AREA : NIMR		SCALE : 0 1 2 3 4 5 6 7		CAD DRAWING	
								SUB AREA : NIMR PRODUCTION STATION		NO. 05		 شركة تنمية نفط عُمان Petroleum Development Oman	
								DRWG. TYPE : RTU FUNCTIONAL LOGIC DIAGRAM				DRWG AREA ENG SERIAL SHEET PROJ DWG REV. CODE CODE SECT NUMBER CODE SIZE	
								DESCRIPTION : 48-UZ-2657 P-48359/60 (OXYGEN SCAVENGER DOSING PUMP)				NO NIM 5 6531022DQ 3 A	
NOTES/REFERENCE DRAWINGS IN CASE OF DEVIATIONS MARKED UP PRINT SHALL BE SENT TO COASTAL DESIGN OFFICE								MASTER DRAWING REVISION PDO APPROVAL					



DCS FUNCTIONAL LOGIC DIAGRAMS


"NIMR PRODUCTION STATION"

NOTES -

- 1) SERIAL LINK SIGNALS FROM THE SGS WHICH REQUIRE NO FUNCTIONAL LOGIC IN THE DCS ARE NOT SHOWN IN DCS FLD'S. SEE SGS FLD'S NIM-5-6080 FOR FULL SIGNAL DETAIL.
- 2) THESE FLD'S ONLY SHOW SCADA CONNECTIONS WHERE THESE ARE RELATED TO FUNCTIONAL LOGIC WITHIN THE DCS. SEE DOCUMENT No. NIM-5-5606-001- TELEMETRY POINT LIST.

SCOPE OF 'DQ' PROJECT
WBS NO.:NIM.IN.09.011

APPROVED FOR
CONSTRUCTION

REV	DATE	DRAWN BY	TEAM L	J.ENG.	CHECKED	DESCRIPTION	B.I. NO	PROJ. ENG.	SIGNATURE
A	SEPT.'11	SUAD	SG	SG		APPROVED FOR CONSTRUCTION	IN.09.011	OSE/23N	
O	JAN.'11	Mrp	SG	SG		ISSUED FOR COMMENTS	IN.09.011	OSE/23N	
PROJECT DRAWING REVISION									
IN CASE OF DEVIATIONS A MARKED UP PRINT SHALL BE SENT TO THE PROJECT ENGINEER									
AREA : NIMR							SCALE : 0 1 2 3 4 5 6 7		
SUB AREA : PRODUCTION STATION							No. 05		
DRWG. TYPE : DCS FUNCTIONAL LOGIC DIAGRAM							 شركة تنمية نفط عمان Petroleum Development Oman		
DESCRIPTION : COVER SHEET							DRWG AREA ENG SERIAL SHEET PROJ DWG REV. NO NIM 5 6079 001 DQ 3 A		

	D	NOV.'08	ASD	AS BUILT UPTO NOV.'08	0T.08.005	OSO/22N	SK
	C	FEB'02		AS BUILT FOR PROJ.3R	00.818	OME/26	
	B	JUN'01		AS BUILT FOR PROJ.2W	99.614	ONE/22	
	A	JULY'00		AS BUILT FOR PROJ.'7G'	00.826	ONE/23	
	O	APR.'98		AS BUILT FOR PROJECT M7	96.898		
	REV	DATE	APPROVED BY	DESCRIPTION	B.I.NO.	PROJ.ENG.	SPEC.ENG.
						PDO APPROVAL	

NOTES/REFERENCE DRAWINGS
IN CASE OF DEVIATIONS MARKED UP PRINT SHALL BE SENT TO COASTAL DESIGN OFFICE

MASTER DRAWING REVISION







SHEET NO.	DESCRIPTION	REV.0	REV.A	REV.B	REV.C	REV.D	REV.E	REV.F	SHEET NO.	DESCRIPTION	REV.0	REV.A	REV.B	REV.C	REV.D	REV.E	REV.F
001	COVER SHEET	APR.98	JULY'00	JUNE'01	FEB'02	NOV.'08	JAN.'11	SEPT.'11	036								
002	REVISION/INDEX SHEET					NOV.'08	JAN.'11	SEPT.'11	037								
003									038	F & G ALARMS	APR.98		JUNE'01				
004	REVISION/INDEX SHEET	APR.98	JULY'00	JUNE'01		NOV.'08			039								
005	REVISION/INDEX SHEET	AUG'00							040								
006									041								
007									042								
008									043								
009	REVISION/INDEX SHEET	APR.98		JUNE'01					044								
010	REVISION/INDEX SHEET				FEB'02				045								
011									046								
012									047								
013									048								
014									049								
015									050	48-UZ-2659 SLUDGE OIL TANK T-4807				JAN.'11	SEPT.'11		
016									051								
017									052								
018	GENERAL NOTES	APR.98					JAN.'11	SEPT.'11	053								
019	TYP. ARRANGEMENT FOR VALVES WITH SCADA CONNECTIONS						JAN.'11	SEPT.'11	054								
020	LEGEND SHEET						JAN.'11	SEPT.'11	055								
021									056								
022									057								
023									058								
024									059								
025									060								
026									061								
027									062								
028									063								
029									064								
030									065								
031									066								
032									067								
033									068								
034									069								
035									070								

REV	DATE	APPROVED BY	DESCRIPTION	B.I.NO.	PROJ.ENG.	SPEC.ENG.	PDO APPROVAL	AREA : NIMR	SUB AREA : PRODUCTION STATION	NO. 05	SCALE : 0 1 2 3 4 5 6 7	CAD DRAWING
D	NOV.'08	ASD	AS BUILT UPTO NOV.'08	01.08.005	OSO/22M	SK						
C	FEB'02		AS BUILT FOR PROJ.3R	00.818	ONE/26							
B	JUN'01		AS BUILT FOR PROJ.2W	99.614	ONE/22							
A	JULY'00		AS BUILT FOR PROJ.'7G'	00.826	ONE/23							
O	APR.98		AS BUILT FOR PROJECT M7	96.898								
NOTES/REFERENCE DRAWINGS								MASTER DRAWING REVISION				
IN CASE OF DEVIATIONS MARKED UP PRINT SHALL BE SENT TO COASTAL DESIGN OFFICE								DESCRIPTION : REVISION / INDEX SHEET				
								DRWG. TYPE : DCS FUNCTIONAL LOGIC DIAGRAM				
								NO : NIM 5 6079002DQ 3 A				




IN JTS		REF NR.	DCS LOGIC				REF NR.	OUTPUT	
<div><div>SGS</div><div>VF</div><div>-UZ- OPEN/CLOSE COMMAND</div><div>O</div><div>C</div></div> <div><div>FLD</div><div>VF</div><div>-GBS- -UZ- FULLY OPEN</div><div>O</div><div></div></div> <div><div>FLD</div><div>VF</div><div>-GBS- -UZ- FULLY CLOSED</div><div>C</div><div></div></div>			<div><div>NOTE 3</div><div>NOTE 4</div><div><div>GDEV BLOCK NOTE 2</div><div>STAIND</div></div><div>STATUS WORD (NOTE 1)</div></div>					<div><div>-UZ- VALVE STATUS</div><div>SCADA (SL)</div></div>	
		<div>NOTES :- 1.</div> <div><div>VALUE</div><div>DEFINITION</div><div>1 VALVE CLOSED</div><div>2 VALVE OPEN</div><div>3 TRAVELLING TO CLOSED STATE</div><div>4 TRAVELLING TO OPEN STATE</div><div>5 FAULT COND. VALVE SHOULD BE CLOSED BUT FEEDBACK IS NOT CORRECT. (NO CLOSED SIGNAL, NO OPEN SIGNAL)</div><div>6 FAULT COND. VALVE SHOULD BE CLOSED BUT FEEDBACK IS NOT CORRECT. (OPEN SIGNAL AND NO CLOSED SIGNAL)</div><div>7 FAULT COND. VALVE SHOULD BE CLOSED BUT FEEDBACK IS NOT CORRECT. (CLOSED AND OPEN SIGNAL BOTH)</div><div>8 FAULT COND. VALVE SHOULD BE CLOSED BUT FEEDBACK IS NOT CORRECT. (OPEN SIGNAL WITH NO CLOSED LIMIT SWITCH CONFIGURED)</div><div>9 FAULT COND. VALVE SHOULD BE OPEN BUT FEEDBACK IS NOT CORRECT. (NO CLOSED SIGNAL, NO OPEN SIGNAL)</div><div>10 FAULT COND. VALVE SHOULD BE OPEN BUT FEEDBACK IS NOT CORRECT. (CLOSED SIGNAL AND NO OPEN SIGNAL)</div><div>11 FAULT COND. VALVE SHOULD BE OPEN BUT FEEDBACK IS NOT CORRECT. (CLOSED AND OPEN SIGNAL BOTH)</div><div>12 FAULT COND. VALVE SHOULD BE OPEN BUT FEEDBACK IS NOT CORRECT. (CLOSED SIGNAL WITH NO OPEN LIMIT SWITCH CONFIGURED)</div></div>		<div><div>2) BLOCK NAME TO BE UZXXX</div><div>3) REPRESENTS VALVE STATUS INDICATION ON DISPLAY (VALVE SYMBOL GREEN WHEN OPEN, YELLOW WHEN CLOSED)</div><div>4) REPRESENTS FAIL ALARM INDICATION ON DISPLAY (VALVE SYMBOL RED) AND ALARM IN ALARM-LOG.</div><div>5) TIMER SETTINGS FOR DELAYS BETWEEN COMMAND SIGNAL AND STATUS VERIFICATION ARE TO BE DETERMINED DURING COMMISSIONING, AND WILL BE STROKING TIMES.</div></div>					
				<div>FOR INFORMATION ONLY</div>					
				<div>SCALE : 0 1 2 3 4 5 6 7</div> <div>CAD DRAWING</div> <div><div>شركة تنمية نفط عُمان</div><div>Petroleum Development Oman</div></div> <div><div>AREA : NIMR</div><div>SUB AREA : PRODUCTION STATION</div><div>NO. 05</div><div>DRWG. TYPE : DCS FUNCTIONAL LOGIC DIAGRAM</div><div>DESCRIPTION : TYPICAL ARRANGEMENT FOR VALVES WITH SCADA CONNECTIONS</div></div> <div><div>REV</div><div>DATE</div><div>APPROVED BY</div><div>DESCRIPTION</div><div>B.I.NO.</div><div>PROJ.ENG.</div><div>SPEC.ENG.</div><div>PDO APPROVAL</div></div> <div><div>NO</div><div>AREA CODE</div><div>ENG SECT</div><div>SERIAL NUMBER</div><div>SHEET</div><div>PROJ CODE</div><div>DWG SIZE</div><div>REV.</div></div>					
				<div>NOTES/REFERENCE DRAWINGS</div> <div>MASTER DRAWING REVISION</div> <div>IN CASE OF DEVIATIONS MARKED UP PRINT SHALL BE SENT TO COASTAL DESIGN OFFICE</div>					

BII / LOGIC FUNCTION SYMBOLS

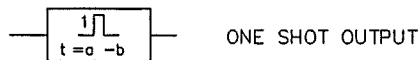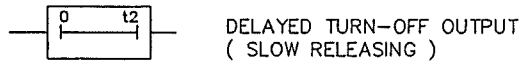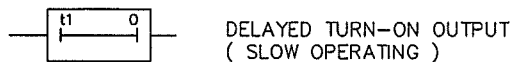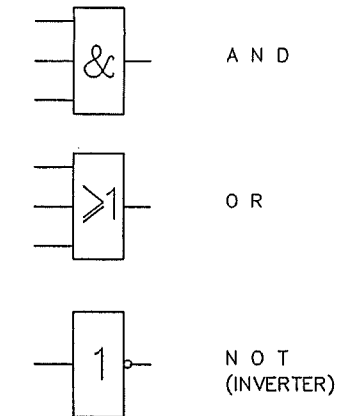


INPUT/OUTPUT FUNCTION SYMBOLS

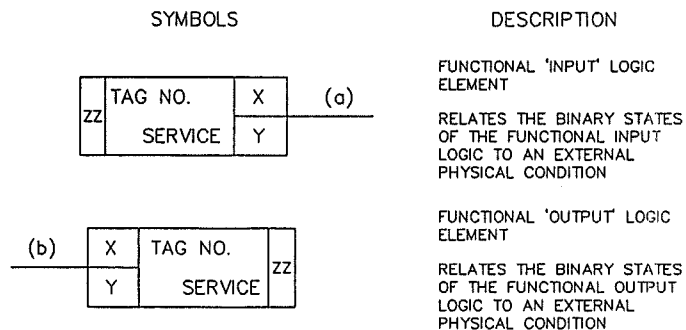



INPUT LOGIC ELEMENTS 'X' AND 'Y'

SYMBOLS	DESCRIPTION	REMARKS
	MANUALLY OPERATED CONTROL	BY PUSHING
	MANUALLY OPERATED CONTROL	BY ROTATING
	RESET WITH RESTRICTED ACCESS	e. g. SPRING RETURN
	LOCKING DEVICE	e. g. KEYLOCK FOR MAINTENANCE OVERRIDE SWITCH (MOS)
	AUTOMATIC RESET	
	SPRING RETURN PUSH BUTTON	MOMENTARY CONTACT

ALARM INDICATION

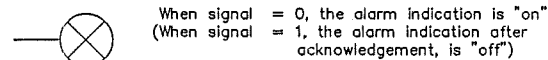

STATUS INDICATION

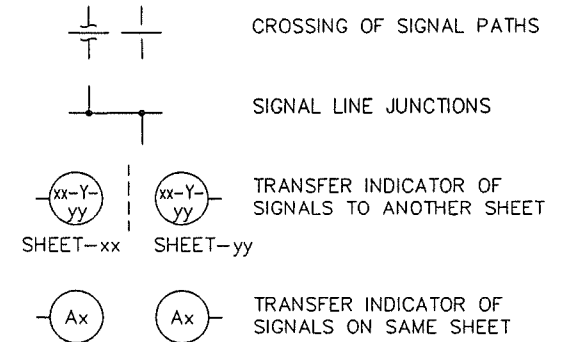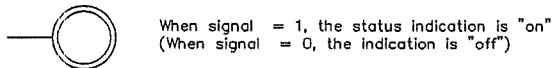

ABBREVIATIONS

A	=	ALARM
CCP	=	CENTRAL CONTROL PANEL
DCS	=	DISTRIBUTED CONTROL SYSTEM
F	=	FIRE
FLD	=	FIELD
IFB	=	INTERFACE BOX
MOS	=	MAINTENANCE OVERRIDE SWITCH
OC	=	OPERATOR CONSOLE (ESD PANEL)
OOS	=	OPERATIONAL OVERRIDE SWITCH
RCT	=	RELAY CABINET
RML	=	REMOTE MANIFOLD LOCATION
ROV	=	REMOTE OPERATED VALVE
RTD	=	RESISTANCE TEMPERATURE DETECTOR
RTU	=	REMOTE TELEMETRY UNIT
SCADA	=	SUPERVISORY CONTROL AND DATA ACQUISITION
SK	=	SOFTKEY
SL	=	SERIAL LINK
SGS	=	SAFEGUARDING SYSTEM
S/D	=	SHUTDOWN
TC	=	THERMOCOUPLE INPUT
Tx	=	TRANSMITTER (4-20 mA)
UCP	=	UNIT CONTROL PANEL (INST.AIR COMPRESSOR)
VF	=	VOLT FREE CONTACT
BSP	=	BURNER START PANEL (HEATER)
GFS	=	FIRE AND GAS PANEL

<div style="display: flex; justify-content: space-between;"> <div> <p>NOTES/REFERENCE DRAWINGS</p> <p>IN CASE OF DEVIATIONS MARKED UP PRINT SHALL BE SENT TO COASTAL DESIGN OFFICE</p> </div> <div> <p>MASTER DRAWING REVISION</p> </div> </div>										<p>AREA : NIMR</p>		<p>SCALE : 0 1 2 3 4 5 6 7</p>	
<p>0 APR.98 AS BUILT FOR PROJECT M7 96.898</p>										<p>SUB AREA : PRODUCTION STATION NO.</p>		<p>CAD DRAWING</p>	
<p>PROJ.ENG. SPEC.ENG. PDO APPROVAL</p>										<p>DRWG. TYPE : FUNCTIONAL LOGIC DIAGRAM</p>		<p>شركة تنمية نفط عُمان Petroleum Development Oman</p>	
<p>DESCRIPTION : LEGEND SHEET</p>										<p>DRWG. AREA CODE ENG. SERIAL NUMBER SHEET PROJ. CODE DWG. SIZE REV.</p>		<p>NO NIM 5 6079 020 DQ 3 A</p>	

II	TS	REF NR.	DCS LOGIC	REF NR.	OUTP'														
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FLD	VF	48-GBS-2660 T-4807 INLET VALVE OPEN	0																
FLD	VF	48-GBS-2660 T-4807 INLET VALVE CLOSED	C																
SGS (SL)		48-GBS-2660 T-4807 INLET VLV. O/C COMMAND FOR MONITORING	0 C																
48-UZV-2660 T-4807 INLET VALVE STATUS	SCADA (SL)																		
<div style="border: 1px solid black; padding: 5px; display: inline-block;">NEW SHEET</div>																			

<table border="1" style="width: 100%; border-collapse: collapse;"> <tr> <td style="width: 10%;">AREA</td> <td colspan="3">: NIMR</td> </tr> <tr> <td>SUB AREA</td> <td>: PRODUCTION STATION</td> <td style="width: 10%;">NO. 05</td> <td></td> </tr> <tr> <td>DRWG. TYPE</td> <td colspan="3">: DCS FUNCTIONAL LOGIC DIAGRAM</td> </tr> <tr> <td>DESCRIPTION</td> <td colspan="3">: SLUDGE OIL TANK T-4807 48-UZ-2659</td> </tr> </table>	AREA	: NIMR			SUB AREA	: PRODUCTION STATION	NO. 05		DRWG. TYPE	: DCS FUNCTIONAL LOGIC DIAGRAM			DESCRIPTION	: SLUDGE OIL TANK T-4807 48-UZ-2659			<div style="display: flex; justify-content: space-between;"> <div> <table border="1" style="width: 100%; border-collapse: collapse;"> <tr> <td>SCALE : —</td> <td>CAD DRAWING</td> </tr> <tr> <td>0 1 2 3 4 5 6 7</td> <td></td> </tr> </table> </div> <div style="text-align: center;"> <p>شركة تنمية نفط عمان Petroleum Development Oman</p> </div> </div> <table border="1" style="width: 100%; border-collapse: collapse;"> <tr> <td>DRWG</td> <td>AREA CODE</td> <td>ENG SECT</td> <td>SERIAL NUMBER</td> <td>SHEET</td> <td>PROJ CODE</td> <td>DWG SIZE</td> <td>REV.</td> </tr> <tr> <td>NO</td> <td>NIM</td> <td>5</td> <td>6079050DQ</td> <td>3</td> <td>A</td> <td></td> <td></td> </tr> </table>	SCALE : —	CAD DRAWING	0 1 2 3 4 5 6 7		DRWG	AREA CODE	ENG SECT	SERIAL NUMBER	SHEET	PROJ CODE	DWG SIZE	REV.	NO	NIM	5	6079050DQ	3	A		
AREA	: NIMR																																				
SUB AREA	: PRODUCTION STATION	NO. 05																																			
DRWG. TYPE	: DCS FUNCTIONAL LOGIC DIAGRAM																																				
DESCRIPTION	: SLUDGE OIL TANK T-4807 48-UZ-2659																																				
SCALE : —	CAD DRAWING																																				
0 1 2 3 4 5 6 7																																					
DRWG	AREA CODE	ENG SECT	SERIAL NUMBER	SHEET	PROJ CODE	DWG SIZE	REV.																														
NO	NIM	5	6079050DQ	3	A																																

NOTES/REFERENCE DRAWINGS

IN CASE OF DEVIATIONS MARKED UP PRINT SHALL BE SENT TO COASTAL DESIGN OFFICE

MASTER DRAWING REVISION



SGS FUNCTIONAL LOGIC DIAGRAMS

'NIMR PRODUCTION STATION'

SCOPE OF 'DQ' PROJECT
WBS NO.: NIM.IN.09.011

APPROVED FOR
CONSTRUCTION

V	NOV.'08	ASD	AS BUILT UP TO NOV.'08	01.08.005	OSO/22N	SK
U	APR.'05		AS BUILT FOR PROJ.'5X'	02.001		BW
T	JAN.'05		AS-BUILT FOR PROJ. '3Y/X4'	00.394/95.052		BW
S	DEC.'04		AS BUILT FOR PROJ. '5R'	01.116	OSE/24N	
R	DEC.'04		AS BUILT FOR PROJ. '5V'	IN.02.002	TTP/57	
Q	MAR.'02		AS BUILT FOR PROJECT '4P'	00.802	OME/41	JAMAL
P	FEB.'02		AS BUILT FOR PROJECT '3N'	00.818	OME/26	
M	JULY.'00		AS BUILT FOR PROJ S8,T1,M9	00.826	ONE/24	
D	SEP.'98		AS BUILT FOR PROJECT V2	92.640	ONE/24	
REV	DATE	APPROVED BY	DESCRIPTION	WBS No & L.Ng.	PROJ.ENG. SPEC.ENG.	PDO APPROVAL

A	SEPT.'11	SUAG	SG	SG	APPROVED FOR CONSTRUCTION	IN.09.011	OSE/23N
0	JAN.'11	NS	SG	SG	ISSUED FOR COMMENTS	IN.09.011	OSE/23N
REV	DATE	DRAWN BY	TEAM L	J.ENG.	DESCRIPTION	WBS NO.	PROJ. ENG.
			CHECKED				P D O APPROVAL

PROJECT DRAWING REVISION
IN CASE OF DEVIATIONS A MARKED UP PRINT SHALL BE SENT TO THE PROJECT ENGINEER

AREA	: NIMR	SCALE :	0 1 2 3 4 5 6 7	CAD DRAWING
SUB AREA	: PRODUCTION STATION	NO. 05		
DRWG. TYPE	: SGS FUNCTIONAL LOGIC DIAGRAM			
DESCRIPTION	: COVER SHEET			
DRWG	AREA CODE	ENG SECT	SERIAL NUMBER	SHEET
NO	NIM 5 5588 001DQ	3	A	

NOTES/REFERENCE DRAWINGS
IN CASE OF DEVIATIONS MARKED UP PRINT SHALL BE SENT TO COASTAL DESIGN OFFICE

MASTER DRAWING REVISION



SHEET NO.	DESCRIPTION	REV.0	REV.N	REV.R	REV.S	V.T	REV.U	REV.0	REV.A	SHEET NO.	DESCRIPTI	REV.0	REV.P	REV.R	REV.T	REV.U	REV.0	REV.A
001	COVER SHEET	JULY'97	JUN'01	DEC'04	DEC'04	JAN'05	APR'05	JAN.'11	SEPT.'11	036	48-UZ-100 : ESD LOGIC SYSTEM	JULY.97	FEB'02					
002	REVISION/INDEX SHEET							JAN.'11	SEPT.'11	037	48-UZ-100 : ESD LOGIC SYSTEM			DEC'04			JAN.'11	SEPT.'11
003	REVISION/INDEX SHEET							JAN.'11	SEPT.'11	038	48-UZ-100 : ESD LOGIC SYSTEM							
004	REVISION/INDEX SHEET							JAN.'11	SEPT.'11	039	48-UZ-100 : ESD LOGIC SYSTEM							
005	REVISION/INDEX SHEET		JUN'01	DEC'04				JAN.'11	SEPT.'11	040	48-UZ-100 : ESD LOGIC SYSTEM				JAN.05			
006	REVISION/INDEX SHEET									041	48-UZ-100 : ESD LOGIC SYSTEM							
007	REVISION/INDEX SHEET					JAN'05				042	48-UZ-100 : ESD LOGIC SYSTEM							
008	REVISION/INDEX SHEET		JUN'01							043	48-UZ-100 : ESD LOGIC SYSTEM							
009	REVISION/INDEX SHEET					JAN'05				044	48-UZ-100 : ESD LOGIC SYSTEM		FEB'02			APR.05		
010	REVISION/INDEX SHEET									045	48-UZ-100 : ESD LOGIC SYSTEM							
011	REVISION/INDEX SHEET									046	48-UZ-100 : ESD LOGIC SYSTEM							
012	SPARE									047	48-UZ-100 : ESD LOGIC SYSTEM							
013	REVISION/INDEX SHEET				DEC'04		APR.05			048	48-UZ-100 : ESD LOGIC SYSTEM	OCT'99						
014	REVISION/INDEX SHEET									049	SPARE							
015	REVISION/INDEX SHEET	OCT'99	JUN'01							050								
016	SPARE									051								
017										052								
018	MOS WIRING (TYPICAL)	JULY.97		DEC'04	DEC'04			JAN.'11	SEPT.'11	053	48-UZ-2659:SLUDGE OIL TANK T-4807 INLET ESDV						JAN.'11	SEPT.'11
019	SGS I/O ADDRESS (TYPICAL)									054	SPARE							
020	LEGEND SHEET									055								
021	48-UZ-060 : INLET MANIFOLDS									056								
022	SPARE									057								
023										058	48-UZ-110 : INLET FROM GATHERING STATION	JULY.97		DEC'04				
024										059	48-UZ-110 : INLET FROM GATHERING STATION	DEC.98	FEB'02					
025										060	SPARE							
026										061	48-UZ-120 : INLET MANIFOLDS	JULY.97						
027										062	48-UZ-120 : INLET MANIFOLDS							
028										063	48-UZ-120 : INLET MANIFOLDS							
029										064	48-UZ-120 : INLET MANIFOLDS	SEP.98						
030	48-UZ-090:RECOVERED OIL SYSTEM(4th TRAIN)	JULY.97					APR.05			065	48-UZ-130 : RECOVERED OIL SYSTEM	JULY.97				APR.05		
031	SPARE									066	SPARE							
032										067								
033	48-UZ-100 : ESD LOGIC SYSTEM	JULY.97								068	48-UZ-140 : FREE WATER KO TANK T-4801	JULY.97						
034	48-UZ-100 : ESD LOGIC SYSTEM		JUN'01							069	SPARE							
035	48-UZ-100 : ESD LOGIC SYSTEM			DEC'04			APR.05			070								

<table border="1"> <tr> <td>V</td><td>NOV.'08</td><td>ASD</td><td>AS BUILT UP TO NOV.'08</td><td>01.08.005</td><td>OSO/22N</td><td>SK</td></tr> <tr> <td>U</td><td>APR.'05</td><td></td><td>AS BUILT FOR PROJ.'5X'</td><td>02.001</td><td></td><td>BW</td></tr> <tr> <td>T</td><td>JAN.'05</td><td></td><td>AS-BUILT FOR PROJ. '3Y/X4'</td><td>00.394/95.052</td><td></td><td>BW</td></tr> <tr> <td>S</td><td>DEC'04</td><td></td><td>AS BUILT FOR PROJ. '5V'</td><td>01.116</td><td>OSE/24N</td><td></td></tr> <tr> <td>R</td><td>DEC'04</td><td></td><td>AS BUILT FOR PROJ. '5V'</td><td>IN.02.002</td><td>TTP/57</td><td></td></tr> <tr> <td>Q</td><td>MAR'02</td><td></td><td>AS BUILT FOR PROJECT '4P'</td><td>00.802</td><td>OME/41</td><td>JAMAL</td></tr> <tr> <td>P</td><td>FEB'02</td><td></td><td>AS BUILT FOR PROJECT '3R'</td><td>00.818</td><td>OME/26</td><td></td></tr> <tr> <td>N</td><td>JUN'01</td><td></td><td>AS BUILT FOR PROJ.'2W'</td><td>99.614</td><td>ONE/22</td><td></td></tr> <tr> <td>L</td><td>MAR'00</td><td></td><td>AS BUILT FOR PROJ.'3F/3G/1S'</td><td>97.009</td><td>ONE/22</td><td></td></tr> <tr> <td>REV</td><td>DATE</td><td>APPROVED BY</td><td>DESCRIPTION</td><td>WBS No &#x2D; No</td><td>PROJ.ENG.</td><td>SPEC.ENG.</td></tr> <tr> <td></td><td></td><td></td><td></td><td></td><td></td><td></td></tr> </table>	V	NOV.'08	ASD	AS BUILT UP TO NOV.'08	01.08.005	OSO/22N	SK	U	APR.'05		AS BUILT FOR PROJ.'5X'	02.001		BW	T	JAN.'05		AS-BUILT FOR PROJ. '3Y/X4'	00.394/95.052		BW	S	DEC'04		AS BUILT FOR PROJ. '5V'	01.116	OSE/24N		R	DEC'04		AS BUILT FOR PROJ. '5V'	IN.02.002	TTP/57		Q	MAR'02		AS BUILT FOR PROJECT '4P'	00.802	OME/41	JAMAL	P	FEB'02		AS BUILT FOR PROJECT '3R'	00.818	OME/26		N	JUN'01		AS BUILT FOR PROJ.'2W'	99.614	ONE/22		L	MAR'00		AS BUILT FOR PROJ.'3F/3G/1S'	97.009	ONE/22		REV	DATE	APPROVED BY	DESCRIPTION	WBS No - No	PROJ.ENG.	SPEC.ENG.								<table border="1"> <tr> <td>REV</td><td>DATE</td><td>DRAWN BY</td><td>TEAM L</td><td>J.ENG.</td><td>DESCRIPTION</td><td>WBS No &#x2D; No</td><td>PROJ. ENG.</td><td>SIGNATURE</td></tr> <tr> <td></td><td></td><td></td><td>CHECKED</td><td></td><td></td><td></td><td></td><td></td></tr> </table>	REV	DATE	DRAWN BY	TEAM L	J.ENG.	DESCRIPTION	WBS No - No	PROJ. ENG.	SIGNATURE				CHECKED					
V	NOV.'08	ASD	AS BUILT UP TO NOV.'08	01.08.005	OSO/22N	SK																																																																																										
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<p>PROJECT DRAWING REVISION</p> <p>IN CASE OF DEVIATIONS A MARKED UP PRINT SHALL BE SENT TO THE PROJECT ENGINEER</p>							<p>SCALE : 0 1 2 3 4 5 6 7</p> <p>CAD DRAWING</p>																																																																																									
<p>AREA : NIMR</p>							<p>NO. 05</p>																																																																																									
<p>SUB AREA : PRODUCTION STATION</p>							<p>شركة تنمية نفط عمان Petroleum Development Oman</p>																																																																																									
<p>DRWG TYPE : SGS FUNCTIONAL LOGIC DIAGRAM</p>							<p>DRWG AREA ENG SERIAL SHEET PROJ DWG REV. CODE CODE SECT NUMBER CODE SIZE</p>																																																																																									
<p>DESCRIPTION : REVISION / INDEX SHEET</p>							<p>NO NIM 5 5588 002 DQ 3 A</p>																																																																																									

NOTES/REFERENCE DRAWINGS MASTER DRAWING REVISION
IN CASE OF DEVIATIONS MARKED UP PRINT SHALL BE SENT TO COASTAL DESIGN OFFICE

SHEET NO.	DESCRIPTION	REV.0	REV.G	REV.L	V.P	REV.T	REV.U	REV.D	SHEET NO.	DESCRIPTION	REV.0	REV.G	REV.N	REV.T	REV.U	REV.D	REV.A
071	48-UZ-150 : FREE WATER KO TANK T-4802	JULY.97	DEC. 98						106	48-UZ-320 : OIL EMULSION PUMP P-4802	JULY.97	DEC. 98	JUN'01		APR'05		
072	SPARE								107	48-UZ-320 : OIL EMULSION PUMP P-4802							
073									108	48-UZ-320 : OIL EMULSION PUMP P-4802							
074	48-UZ-160 : CONCENTRIC WASH TANK T-4803	JULY.97	DEC. 98	MAR'00					109	48-UZ-320 : OIL EMULSION PUMP P-4802							
075	48-UZ-160 : CONCENTRIC WASH TANK T-4803						APR'05		110	48-UZ-320 : OIL EMULSION PUMP P-4802							
076	SPARE								111	SPARE							
077	48-UZ-170 : CONCENTRIC WASH TANK T-4804	JULY.97	DEC. 98	MAR'00					112								
078	48-UZ-170 : CONCENTRIC WASH TANK T-4804					JAN.05			113	48-UZ-330 : OIL EMULSION PUMP P-4803	JULY.97	DEC. 98					
079	48-UZ-170 : CONCENTRIC WASH TANK T-4804						APR'05		114	48-UZ-330 : OIL EMULSION PUMP P-4803							
080	48-UZ-180 : NIMR/NIMR WEST GAS SUPPLY	JULY.97	DEC. 98						115	48-UZ-330 : OIL EMULSION PUMP P-4803							
081	SPARE								116	48-UZ-330 : OIL EMULSION PUMP P-4803							
082									117	SPARE							
083	48-UZ-190 : KARIM WEST GAS SUPPLY	JULY.97	DEC. 98	SHEET CANCELLED UNDER REV. 'M'					118								
084	SPARE								119								
085									120	48-UZ-340 : WASHED OIL PUMP P-4804	JULY.97	DEC. 98		JAN.05			
086									121	48-UZ-340 : WASHED OIL PUMP P-4804							
087	48-UZ-300 ESD LOGIC 4th TRAIN	JULY.97	DEC. 98		FEB'02				122	48-UZ-340 : WASHED OIL PUMP P-4804							
088	48-UZ-300 ESD LOGIC 4th TRAIN					JAN.05			123	48-UZ-340 : WASHED OIL PUMP P-4804							
089	SPARE								124	SPARE							
090									125								
091									126	48-UZ-350 : WASHED OIL PUMP P-4805	JULY.97	DEC. 98		JAN.05			
092	48-UZ-310 : OIL EMULSION PUMP P-4801	JULY.97	DEC. 98	MAR'00				APR'05	127	48-UZ-350 : WASHED OIL PUMP P-4805							
093	48-UZ-310 : OIL EMULSION PUMP P-4801								128	48-UZ-350 : WASHED OIL PUMP P-4805							
094	48-UZ-310 : OIL EMULSION PUMP P-4801								129	48-UZ-350 : WASHED OIL PUMP P-4805							
095	48-UZ-310 : OIL EMULSION PUMP P-4801								130	SPARE							
096	48-UZ-310 : OIL EMULSION PUMP P-4801								131								
097	SPARE								132	48-UZ-360 : WASHED OIL PUMP P-4806	JULY.97	DEC. 98		JAN.05			
098									133	48-UZ-360 : WASHED OIL PUMP P-4806							
099	48-UZ-315 : OIL EMULSION PUMP P-4861	JULY.97	DEC. 98						134	48-UZ-360 : WASHED OIL PUMP P-4806							
100	48-UZ-315 : OIL EMULSION PUMP P-4861								135	48-UZ-360 : WASHED OIL PUMP P-4806							
101	48-UZ-315 : OIL EMULSION PUMP P-4861								136	SPARE							
102	48-UZ-315 : OIL EMULSION PUMP P-4861								137								
103	SPARE								138	48-UZ-370 : INTERFACE LAYER PUMP P-4828	JULY.97	DEC. 98		JAN.05			
104									139	48-UZ-370 : INTERFACE LAYER PUMP P-4828							
105									140	48-UZ-370 : INTERFACE LAYER PUMP P-4828							

REV	DATE	APPROVED BY	DESCRIPTION	B.I.NO.	PROJ.ENG.	SPEC.ENG.	PDO APPROVAL
V	NOV.'08	ASD	AS BUILT UP TO NOV.'08	OT.08.005	OSO/22N	SK	
U	APR.'05		AS BUILT FOR PROJ.'5X'	02.001		BW	
T	JAN.'05		AS BUILT FOR PROJECT '3Y & X4'	00.394/05.052		BW	
P	FEB'02		AS BUILT FOR PROJECT '3R'	00.818	OME/26		
N	JUN'01		AS BUILT FOR PROJ.'2W'	99.614	ONE/22		
L	MAR'00		AS BUILT FOR PROJ.'3F/3G/15'	97.009	ONE/22		

NOTES/REFERENCE DRAWINGS MASTER DRAWING REVISION
IN CASE OF DEVIATIONS MARKED UP PRINT SHALL BE SENT TO COASTAL DESIGN OFFICE

REV	DATE	DRAWN BY	TEAM L	J.ENG.	DESCRIPTION	B.I. NO	PROJ. ENG.	SIGNATURE
			CHECKED					P D O APPROVAL

PROJECT DRAWING REVISION
IN CASE OF DEVIATIONS A MARKED UP PRINT SHALL BE SENT TO THE PROJECT ENGINEER


AREA	: NIMR	SCALE : 0 1 2 3 4 5 6 7	CAD DRAWING
SUB AREA	: PRODUCTION STATION	NO. 05	شركة تنمية نفط عمان Petrochem Development Oman
DRWG TYPE	: SGS FUNCTIONAL LOGIC DIAGRAM	DRWG	AREA CODE
DESCRIPTION	: REVISION / INDEX SHEET	ENG SECT	SERIAL NUMBER
		SHEET	PROJ CODE
		DWG SIZE	REV.
		NO	NIM 5 5588 003 DQ 3 A

SHEET NO.	DESCRIPTION	REV.O	REV.G	REV.M	V.N	REV.U	REV.O	REV.A	SHEET NO.	DESCRIPTION	REV.O	REV.B	REV.G	REV.H	REV.N	REV.U	REV.V
211	SPARE								246	SPARE							
212	↓								247	↓							
213	↓								248	48-UZ-503 : WET CRUDE TRANSFER PUMP P-4869	JULY.97		DEC. 98				
214	48-UZ-490 : WATER DISPOSAL PUMP P-4815	JULY.97	DEC. 98	JULY'00					249	48-UZ-503 : WET CRUDE TRANSFER PUMP P-4869							
215	48-UZ-490 : WATER DISPOSAL PUMP P-4815								250	48-UZ-503 : WET CRUDE TRANSFER PUMP P-4869							
216	48-UZ-490 : WATER DISPOSAL PUMP P-4815			JULY'00					251	48-UZ-503 : WET CRUDE TRANSFER PUMP P-4869		APR.98			JUN'01	APR'05	
217	48-UZ-490 : WATER DISPOSAL PUMP P-4815								252	48-UZ-503 : WET CRUDE TRANSFER PUMP P-4869		APR.98					
218	48-UZ-490 : WATER DISPOSAL PUMP P-4815								253	48-UZ-503 : WET CRUDE TRANSFER PUMP P-4869		APR.98			JUN'01		
219	SPARE								254	48-UZ-503 : WET CRUDE TRANSFER PUMP P-4869				DEC. 98			
220	↓								255	SPARE							
221	↓								256	↓							
222	48-UZ-500 : ESD LOGIC	JULY.97	DEC. 98		JUN'01	APR'05	JAN.'11	SEPT.'11	257								
223	48-UZ-500 : ESD LOGIC			JULY'00					258								
224	48-UZ-500 : MAINTANANCE OVERRIDE T-4817				JUN'01				259								
225	SPARE								260	48-UZ-504 : WET CRUDE TRANSFER PUMP P-4870	JULY.97		DEC. 98				
226	48-UZ-501 : FREE WATER KO TANK T-4817	JULY.97	DEC. 98	JULY'00					261	48-UZ-504 : WET CRUDE TRANSFER PUMP P-4870							
227	48-UZ-501 : FREE WATER KO TANK T-4817				JUN'01	APR'05			262	48-UZ-504 : WET CRUDE TRANSFER PUMP P-4870							
228	48-UZ-501 : FREE WATER KO TANK T-4817								263	48-UZ-504 : WET CRUDE TRANSFER PUMP P-4870		APR.98			JUN'01	APR'05	
229	48-UZ-501 : FREE WATER KO TANK T-4817			JULY'00					264	48-UZ-504 : WET CRUDE TRANSFER PUMP P-4870		APR.98					
230	SPARE				JUN'01	DELETED			265	48-UZ-504 : WET CRUDE TRANSFER PUMP P-4870		APR.98			JUN'01		
231	↓								266	48-UZ-504 : WET CRUDE TRANSFER PUMP P-4870				DEC. 98			
232	↓								267	SPARE							
233	↓								268	↓							
234	↓								269	↓							
235	↓								270	↓							
236	48-UZ-502 : WET CRUDE TRANSFER PUMP P-4868	JULY.97	DEC. 98						271	↓							
237	48-UZ-502 : WET CRUDE TRANSFER PUMP P-4868								272		JULY.97		DEC. 98			DELETED	
238	48-UZ-502 : WET CRUDE TRANSFER PUMP P-4868								273								
239	48-UZ-502 : WET CRUDE TRANSFER PUMP P-4868				JUN'01	APR'05			274								
240	48-UZ-502 : WET CRUDE TRANSFER PUMP P-4868								275			APR.98			JUN'01		
241	48-UZ-502 : WET CRUDE TRANSFER PUMP P-4868				JUN'01				276			APR.98					
242	48-UZ-502 : WET CRUDE TRANSFER PUMP P-4868								277			APR.98			JUN'01		
243	SPARE								278					DEC. 98			
244	↓								279								
245	↓								280	↓		APR.98	DEC. 98			DELETED	

V	NOV.'08	ASD	AS BUILT UP TO NOV.'08	02.08.005	OSO/22N	SK
U	APR.'05		AS BUILT FOR PROJ.'5X'	02.001		BW
N	JUN'01		AS BUILT FOR PROJ.'2W'	99.614	ONE/22	
M	JULY'00		AS BUILT FOR PROJ.'7G,2Y,2Z	00.826	ONE/23	
G	DEC.98		AS BUILT UP TO DEC.98	98.061	ONE/24	
F	DEC.98		AS BUILT FOR PROJECT R9	92.640	ONE/24	
D	SEP.98		AS BUILT FOR PROJECT V2	92.640	ONE/24	
REV	DATE	APPROVED BY	DESCRIPTION	B.I.NO.	PROJ.ENG.	SPEC.ENG.
					PDO APPROVAL	

NOTES/REFERENCE DRAWINGS
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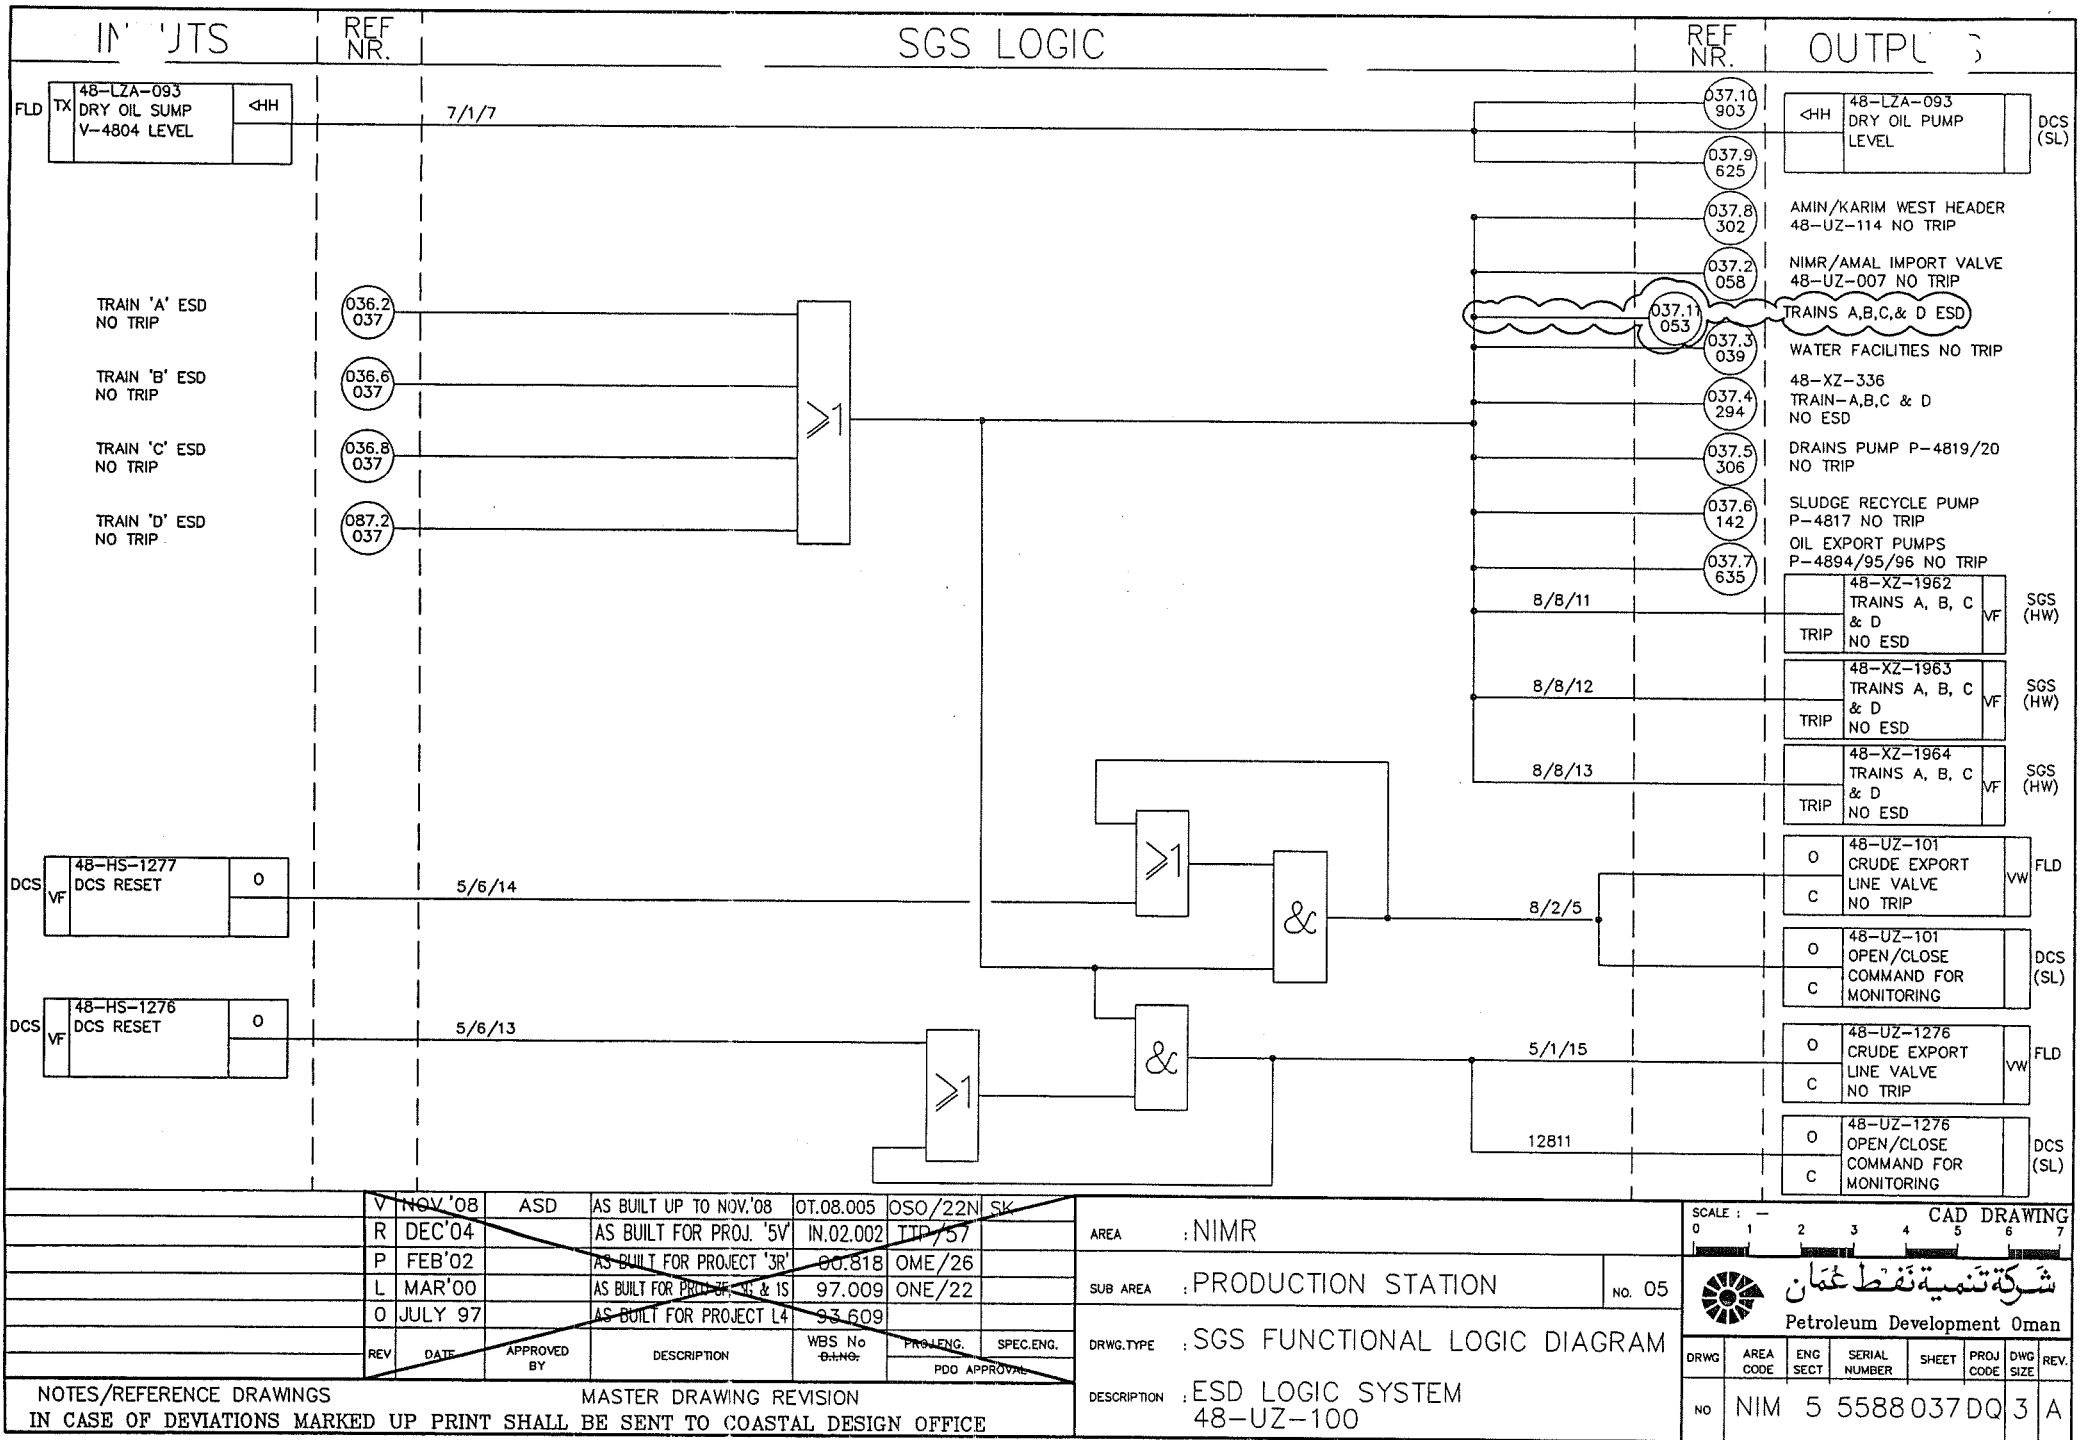
MASTER DRAWING REVISION


REV	DATE	DRAWN BY	TEAM L	J.ENG.	DESCRIPTION	B.I. NO	PROJ. ENG.	SIGNATURE
			CHECKED				P D O APPROVAL	
PROJECT DRAWING REVISION								
IN CASE OF DEVIATIONS A MARKED UP PRINT SHALL BE SENT TO THE PROJECT ENGINEER								
AREA : NIMR		SUB AREA : PRODUCTION STATION		NO. 05		SCALE : 0 1 2 3 4 5 6 7 CAD DRAWING  شركة تنمية نفط عمان Petroleum Development Oman		
DRWG. TYPE : SGS FUNCTIONAL LOGIC DIAGRAM		DESCRIPTION : REVISION / INDEX SHEET		NO		NIM 5 5588 005 DQ 3 A		

IN	JTS	REF NR.	SGS LOGIC	REF NR.	OUTPL
OC	MOS-1000 VF MOS FOR TRAIN 1 48-UZ-001		1/5/10	NOTE 1	2/5/16
					⊗ NOTE 2
OC	MOS-2000 VF MOS FOR TRAIN 2 48-UZ-002		3/4/9	NOTE 1	3/6/1
					⊗ NOTE 2
OC	MOS-3000 VF MOS FOR TRAIN 3 48-UZ-003		4/5/7	NOTE 1	5/1/13
					⊗ NOTE 2
OC	MOS-4000 VF MOS FOR TRAIN 4 48-UZ-004		5/5/9	NOTE 1	6/1/12
					⊗ NOTE 2
OC	MOS-5000 VF MOS FOR DEGASSING TRAIN / MISC. EQPMT. 48-UZ-005		6/4/1	NOTE 1	6/8/5
					⊗ NOTE 2
OC	MOS-6000 VF MOS FOR HEATERS/ HTG. MED. CIRC. PUMP 48-UZ-006		7/6/4	NOTE 1	8/6/10
					⊗ NOTE 2
OC	MOS-7000 VF MOS FOR CPI SEPRS./ WATER DISP. PUMPS 48-UZ-007		9/6/15	NOTE 1	10/1/1
					⊗ NOTE 2
<p>NOTES :-</p> <p>1. SIGNAL FROM EACH MOS KEYSWITCH (IN ESD PANEL) TO BE MULTIPLIED IN SGS AND COMBINED WITH INDIVIDUAL MOS SIGNALS (GENERATED FROM DCS) FOR EACH TAG AS DETAILED IN INDIVIDUAL SHEETS.</p> <p>2. FEEDBACK SIGNAL FROM SGS LOGIC FOR EACH MOS KEYSWITCH ACTUATION TO BE HARDWIRED TO ASSOCIATED LAMP IN ESD PANEL.</p>					
<div style="border: 1px solid black; padding: 5px; display: inline-block;"> FOR INFORMATION </div>					

S	DEC'04	AS BUILT FOR PROJ. '5R'	01.116	05E/24N	AREA : NIMR
R	DEC'04	AS BUILT FOR PROJ. '5V'	IN.02.002	TTP/57	SUB AREA : PRODUCTION STATION
G	DEC.98	AS BUILT UP TO DEC.98	98.061	ONE/24	
O	JULY 97	AS BUILT FOR PROJECT L4	93.609		NO.
REV	DATE	APPROVED BY	DESCRIPTION	WBS No Bt.Ng.	PROJ.ENG. PDD APPROVAL
<div style="display: flex; justify-content: space-between;"> <div> <p>NOTES/REFERENCE DRAWINGS</p> <p>IN CASE OF DEVIATIONS MARKED UP PRINT SHALL BE SENT TO COASTAL DESIGN OFFICE</p> </div> <div> <p>MASTER DRAWING REVISION</p> </div> </div>					

SCALE : 0 1 2 3 4 5 6 7					CAD DRAWING	
شركة تنمية نفط عُمان Petroleum Development Oman					DRWG. TYPE : FUNCTIONAL LOGIC DIAGRAM DESCRIPTION : MOS WIRING (TYPICAL)	
DRWG	AREA CODE	ENG SECT	SERIAL NUMBER	SHEET	PROJ CODE	DWG SIZE
NO	NIM 5 5588 018 DQ				3	A



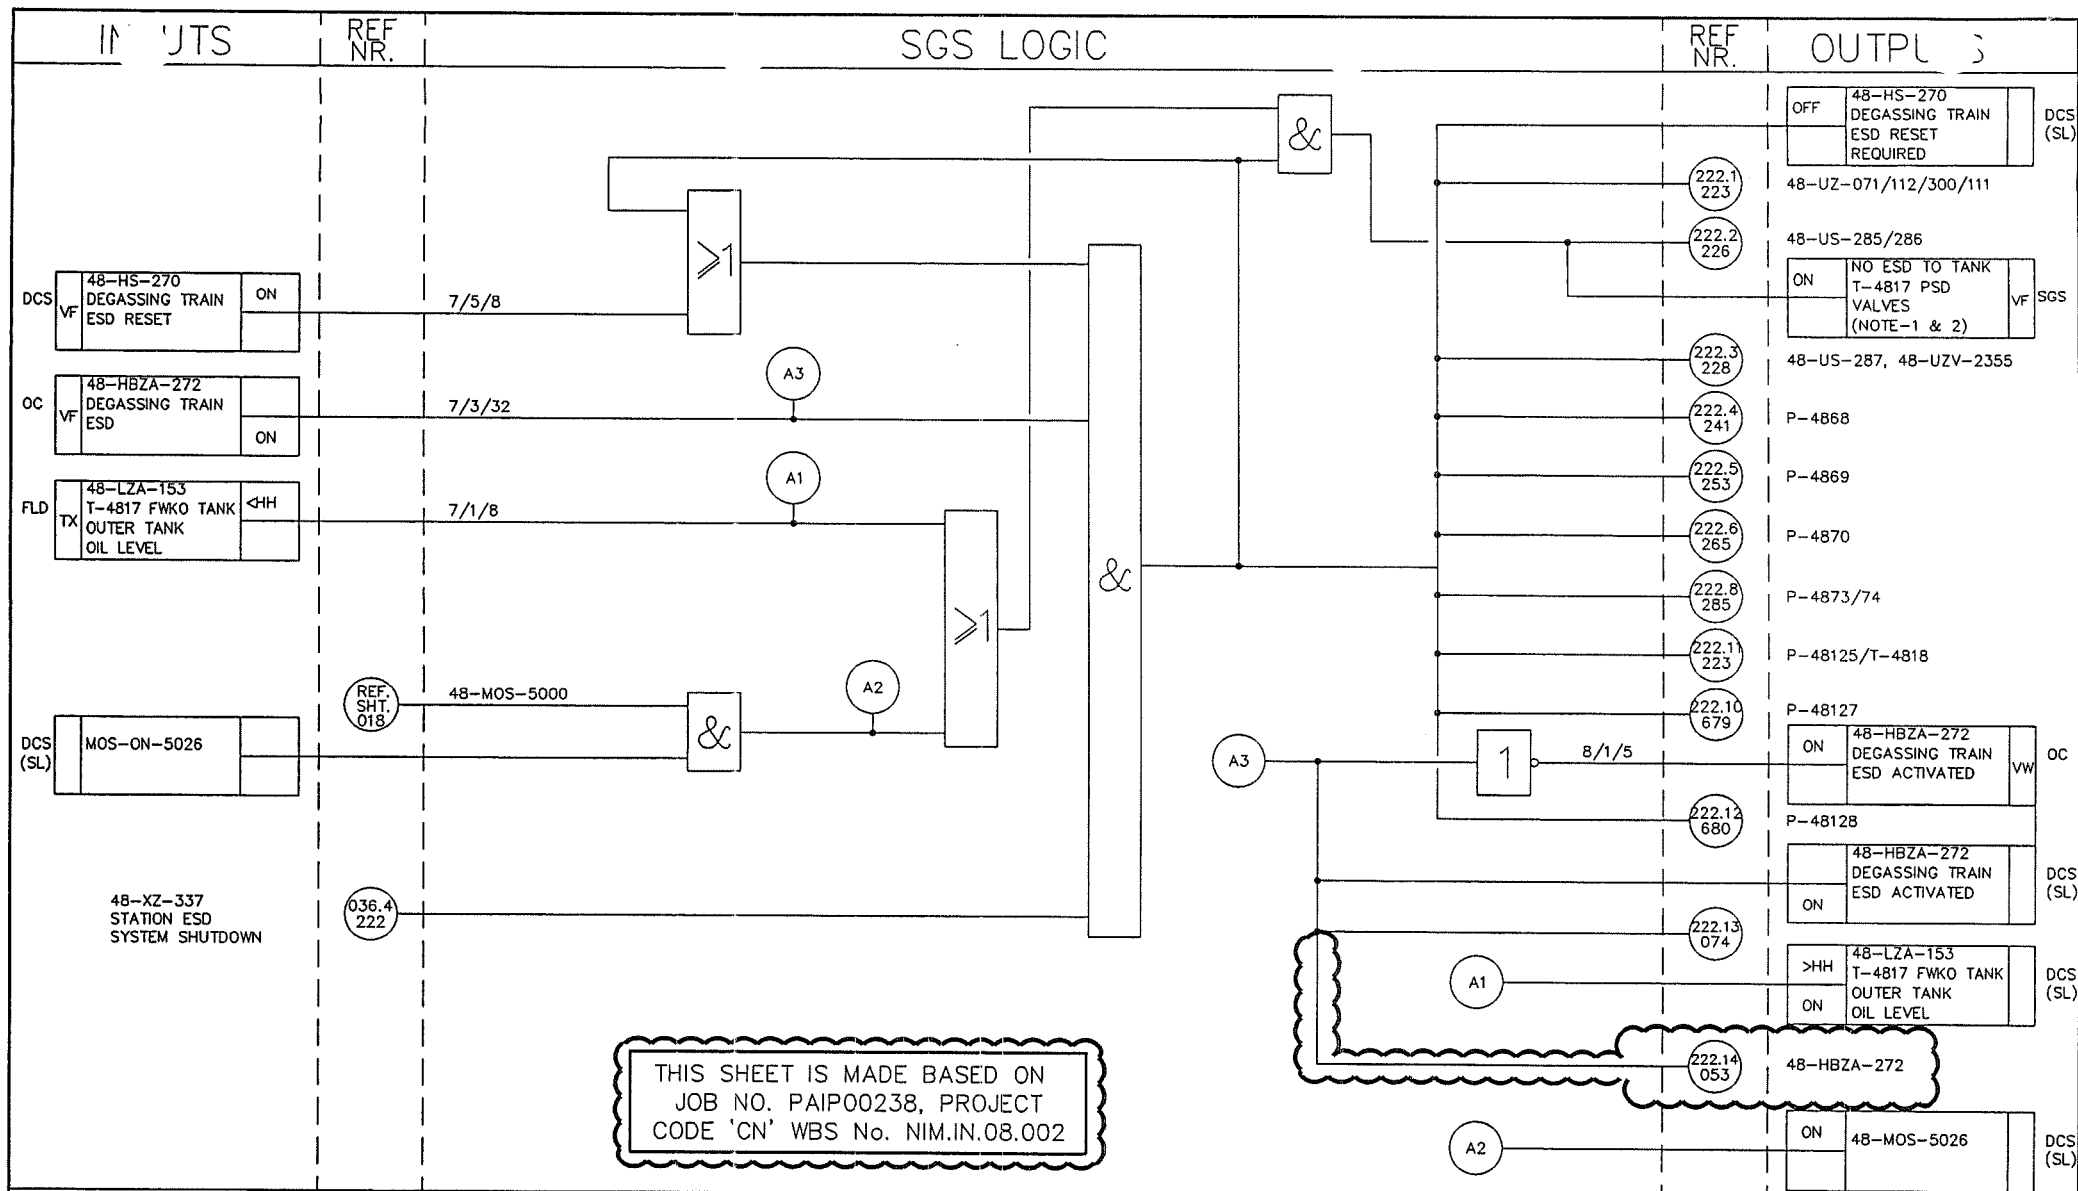

2) HARDWIRED SIGNAL FROM PDO USGR TO PDO T5.	U APR.05	AS BUILT FOR PROJ.'5X'	02.001	DW	AREA : NIMR	SCALE : 0 1 2 3 4 5 6 7	CAD DRAWING
1) REFER SGS FLD NIM-5-6080-308-CN	N JUN'01	AS BUILT FOR PROJ.2W	99.614	ONE/22	SUB AREA : PRODUCTION STATION	شركة تنمية نفط عمان Petroleum Development Oman	
	G DEC.98	AS BUILT FOR PROJ.2W	98.061	ONE/24	DRWG. TYPE : SGS FUNCTIONAL LOGIC DIAGRAM	DRWG AREA ENCT SERIAL SHEET PROJ DWG REV.	
	C SEP.98	AS BUILT FOR PROJECT V2	92.640		DESCRIPTION : ESD LOGIC-DEGASSING TRAIN 48-UZ-500	NO NIM 5 5588 222 DQ 3 A	
	O JULY 97	AS BUILT FOR PROJECT L4	93.609				
NOTES/REFERENCE DRAWINGS IN CASE OF DEVIATIONS MARKED UP PRINT SHALL BE SENT TO COASTAL DESIGN OFFICE	REV	DATE	APPROVED BY	DESCRIPTION	B.I.NO.	PROJ.ENG.	SPEC.ENG.
				PDO APPROVAL			
				MASTER DRAWING REVISION			

INSTRUMENT LOOP DIAGRAMS

NIMR SLUDGE PIT FACILITY

THIS COMPLETE DRAWING IS NEW AND
FORMS PART OF SCOPE OF PROJECT 'DQ'
WBS No. **NIM.IN.09.011**

**APPROVED FOR
CONSTRUCTION**

A	SEPT.'11	SUAD		APPROVED FOR CONSTRUCTION	IN.09.011	OSE/23N
0	MAY.'11	NS		ISSUED FOR COMMENTS	IN.09.011	OSE/23N
REV	DATE	DRAWN BY	TEAML	J.ENG.	DESCRIPTION	B.I. NO
			CHECKED			PROJ. ENG. SIGNATURE
						P D O APPROVAL

PROJECT DRAWING REVISION


IN CASE OF DEVIATIONS A MARKED UP PRINT SHALL BE SENT TO THE PROJECT ENGINEER

AREA : NIMR	SCALE : 0 1 2 3 4 5 6 7	CAD DRAWING
SUB AREA : NIMR SLUDGE PIT	no. 05	 شركة تنمية نفط عُمان Petroleum Development Oman
DRWG. TYPE : INSTRUMENT LOOP DIAGRAMS	DRWG	AREA CODE
DESCRIPTION : COVER SHEET	ENG SECT	SERIAL NUMBER
	SHEET	PROJ CODE
	DWG SIZE	REV.
	NO	NIM 5 4745 001DQ 3 A


REV	DATE	APPROVED BY	DESCRIPTION	B.I.NO.	PROJ.ENG.	SPEC.ENG.


NOTES/REFERENCE DRAWINGS MASTER DRAWING REVISION
IN CASE OF DEVIATIONS MARKED UP PRINT SHALL BE SENT TO COASTAL DESIGN OFFICE

DESCRIPTION	SHEET	REV O	REV A	REV B	REV C	REV D	REV E	DESCRIPTION	SHEET	REV O	REV A	REV B	REV C	REV D	REV E
COVER SHEET	001	MAY '11	SEPT.'11						035						
REVISION/INDEX SHEET	002	MAY '11	SEPT.'11						036						
SPARE	003							48LICA-1449	037	MAY '11	SEPT.'11				
SPARE	004							48LIZA-1450	038	MAY '11	SEPT.'11				
SPARE	005							48PIZA-1518	039	MAY '11	SEPT.'11				
48LIA-1447	006	MAY '11	SEPT.'11					48PIZA-1519	040	MAY '11	SEPT.'11				
48LIZA-1448	007	MAY '11	SEPT.'11					48PI-1522	041	MAY '11	SEPT.'11				
48TIA-1468	008	MAY '11	SEPT.'11					48FI-1415	042	MAY '11	SEPT.'11				
48FI-1414	009	MAY '11	SEPT.'11						043						
SPARE	010								044						
SPARE	011							CONNECTION BETWEEN CI SKID & RTU	045	MAY '11	SEPT.'11				
48LIZA-1451	012	MAY '11	SEPT.'11						046						
48LIA-1452	013	MAY '11	SEPT.'11						047						
48PIZA-1516	014	MAY '11	SEPT.'11						048						
48PDIA-1520	015	MAY '11	SEPT.'11						049						
48PDIA-1521	016	MAY '11	SEPT.'11					48HS-2664A/B START/STOP	050	MAY '11	SEPT.'11				
SPARE	017							48HS-2663A/B START/STOP	051	MAY '11	SEPT.'11				
SPARE	018							48HS-2660A/B START/STOP	052	MAY '11	SEPT.'11				
SPARE	019							48HS-2658A/B START/STOP	053	MAY '11	SEPT.'11				
48XZA-2342	020	MAY '11	SEPT.'11						054						
48XZA-2343	021	MAY '11	SEPT.'11						055						
48HS-2219A/B	022	MAY '11	SEPT.'11					48GB-2656 RUNNING INDICATION	056	MAY '11	SEPT.'11				
48HS-2658	023	MAY '11	SEPT.'11					48GB-2657 RUNNING INDICATION	057	MAY '11	SEPT.'11				
48HS-2220A/B	024	MAY '11	SEPT.'11					48GB-2658 RUNNING INDICATION	058	MAY '11	SEPT.'11				
48HS-2660	025	MAY '11	SEPT.'11					48GB-2659 RUNNING INDICATION	059	MAY '11	SEPT.'11				
SPARE	026								060						
SPARE	027								061						
48XA-4106	028	MAY '11	SEPT.'11						062						
SPARE	029								063						
48HS-2661A/B	030	MAY '11	SEPT.'11						064						
48HS-2662A/B	031	MAY '11	SEPT.'11						065						
48HS-2663	032	MAY '11	SEPT.'11						066						
48HS-2664	033	MAY '11	SEPT.'11						067						
SPARE	034								068						

REV	DATE	DRAWN BY	TEAM	J.ENG.	DESCRIPTION					B.I. NO	PROJ. ENG.	SIGNATURE			
			CHECKED												
PROJECT DRAWING REVISION															
IN CASE OF DEVIATIONS A MARKED UP PRINT SHALL BE SENT TO THE PROJECT ENGINEER															
AREA : NIMR										SCALE : 1 2 3 4 5 6 7					
SUB AREA : NIMR SLUDGE PIT										No. 05					
DRWG. TYPE : INSTRUMENT LOOP DIAGRAMS										 شركة تنمية نفط عمان Petroleum Development Oman					
DESCRIPTION : REVISION/INDEX SHEET										DRWG AREA ENG SERIAL SHEET PROJ DWG REV CODE SECT NUMBER CODE CODE SIZE NO NIM 5 4745 002DQ 3 A					

NOTES/REFERENCE DRAWINGS	MASTER DRAWING REVISION
IN CASE OF DEVIATIONS MARKED UP PRINT SHALL BE SENT TO COASTAL DESIGN OFFICE	

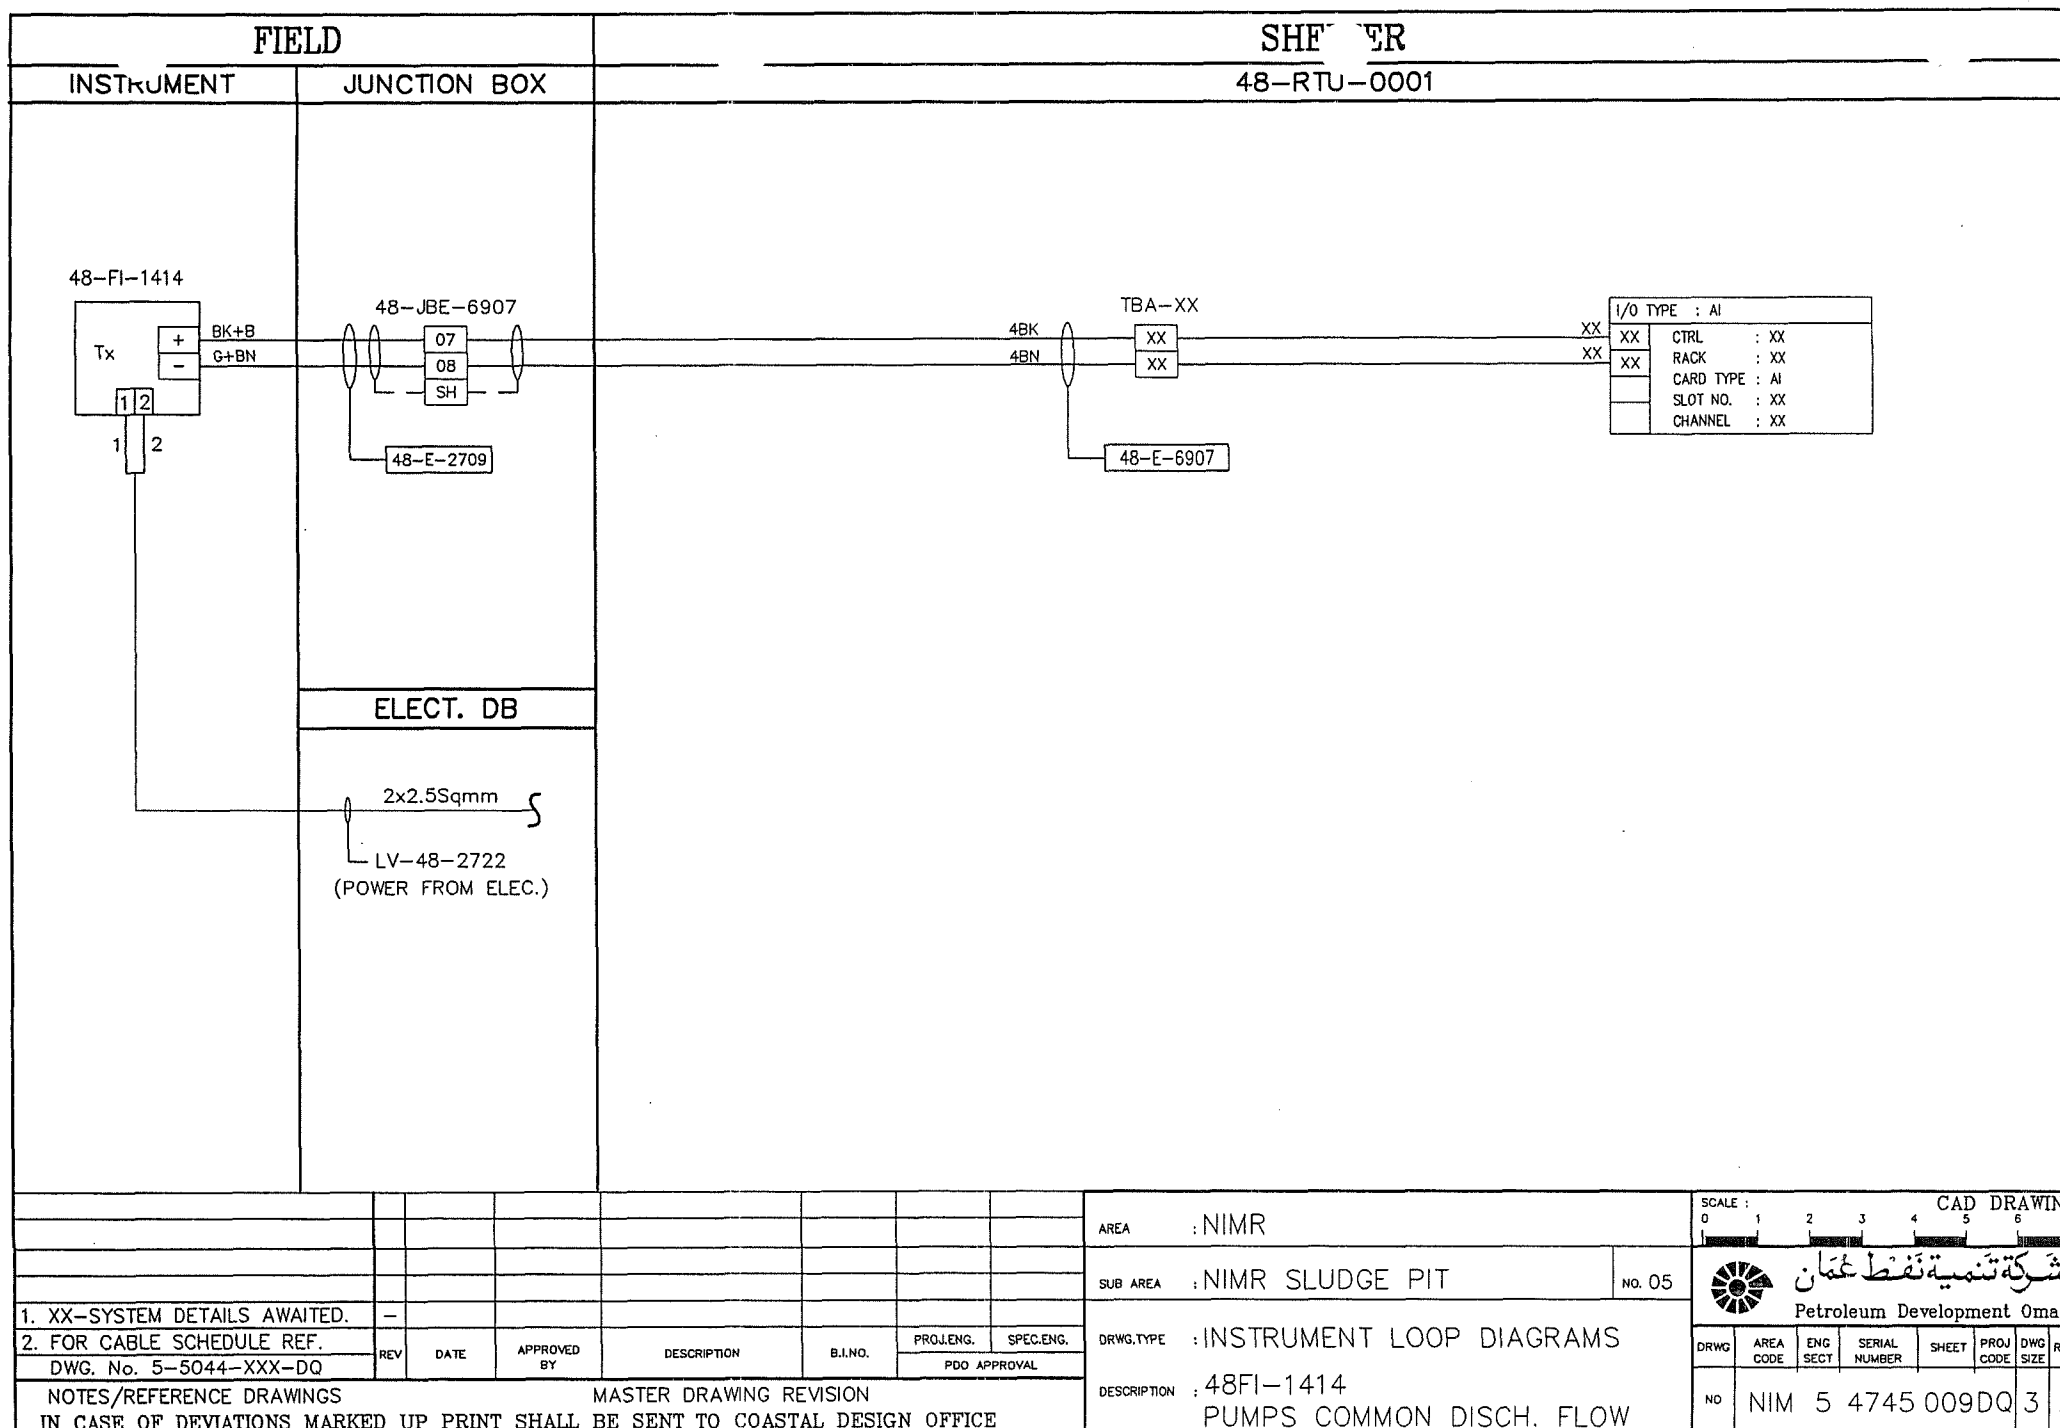

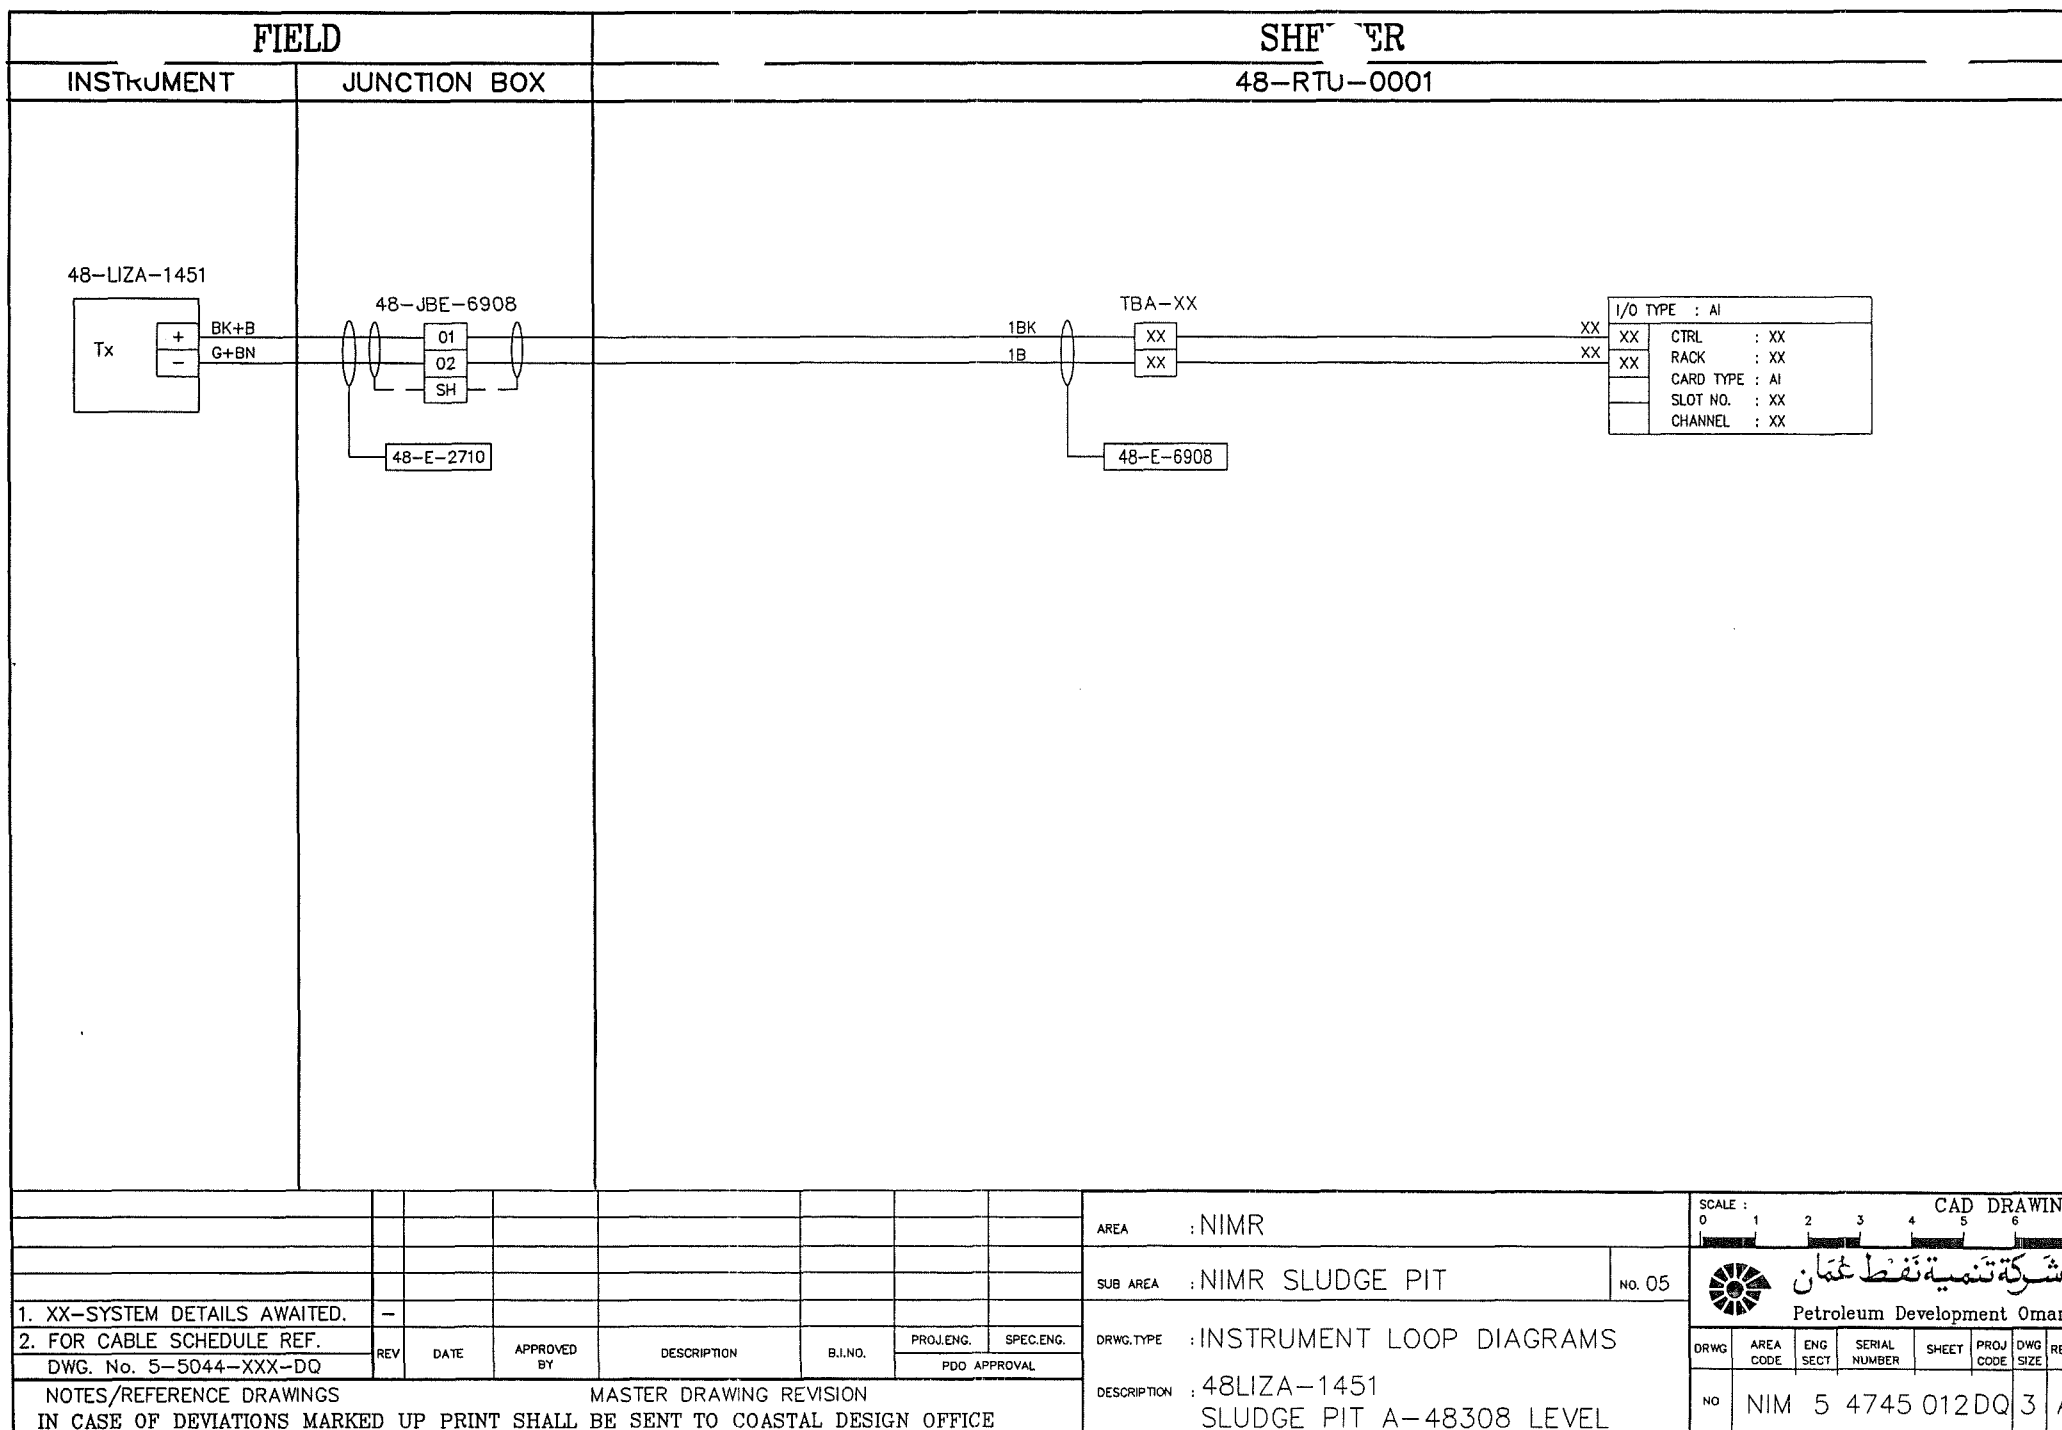

REV	DATE	APPROVED BY	DESCRIPTION	B.I.NO.	PROJ.ENG.	SPEC.ENG.
1.			XX-SYSTEM DETAILS AWAITED.			
2.			FOR CABLE SCHEDULE REF.			

DWG. No. 5-5044-XXX-DQ

NOTES/REFERENCE DRAWINGS

MASTER DRAWING REVISION

IN CASE OF DEVIATIONS MARKED UP PRINT SHALL BE SENT TO COASTAL DESIGN OFFICE

AREA : NIMR

SUB AREA : NIMR SLUDGE PIT

DRWG. TYPE : INSTRUMENT LOOP DIAGRAMS


DESCRIPTION : 48LIZA-1451
SLUDGE PIT A-48308 LEVEL

SCALE : 0 1 2 3 4 5 6 7 CAD DRAWING

شركة تنمية نفط عُمان


Petroleum Development Oman


DRWG	AREA CODE	ENG SECT	SERIAL NUMBER	SHEET	PROJ CODE	DWG SIZE	REV.
NO	NIM	5	4745	012DQ	3	A	

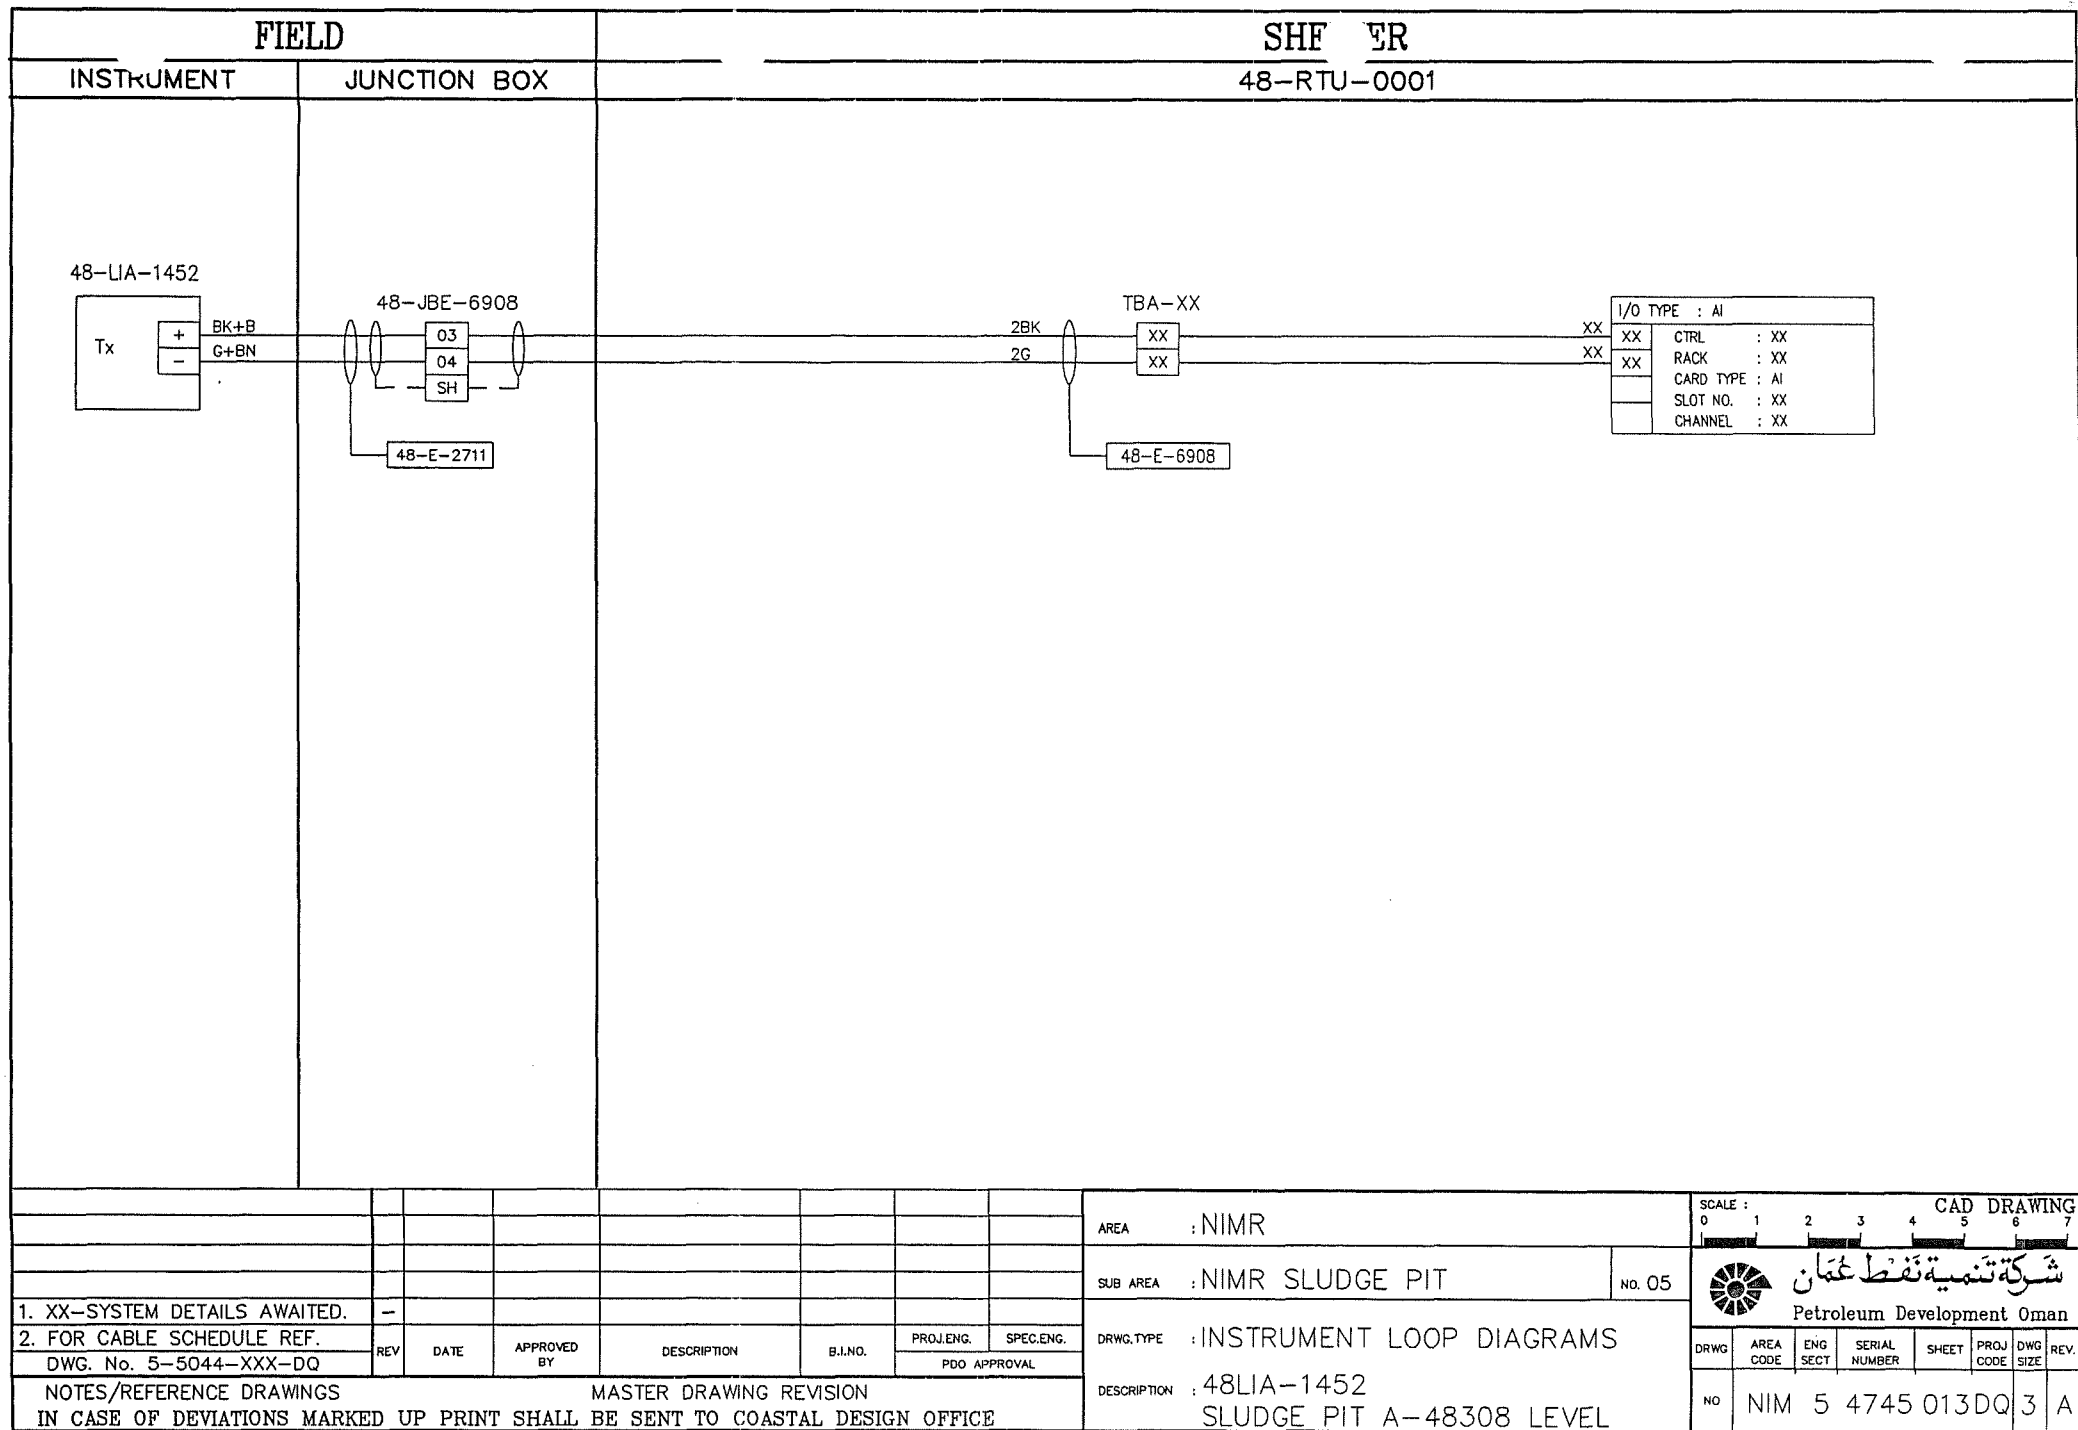


FIELD		SHEET																
INSTRUMENT	JUNCTION BOX	48-RTU-0001																
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XX	RACK	: XX																
	CARD TYPE	: AI																
	SLOT NO.	: XX																
	CHANNEL	: XX																
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<div style="display: flex; justify-content: space-between;"> <div>NOTES/REFERENCE DRAWINGS</div> <div>MASTER DRAWING REVISION</div> </div>		<div style="display: flex; justify-content: space-between;"> <div>DESCRIPTION : 48PIZA-1516 PIPELINE PRESSURE</div> <div>AREA : NIMR SUB AREA : NIMR SLUDGE PIT No. 05</div> </div>																
<div style="display: flex; justify-content: space-between;"> <div>IN CASE OF DEVIATIONS MARKED UP PRINT SHALL BE SENT TO COASTAL DESIGN OFFICE</div> <div>SCALE : 0 1 2 3 4 5 6 7</div> </div>		<div style="display: flex; justify-content: space-between;"> <div>DRWG</div> <div>AREA CODE</div> <div>ENG SECT</div> <div>SERIAL NUMBER</div> <div>SHEET</div> <div>PROJ CODE</div> <div>DWG SIZE</div> <div>REV.</div> </div>																
<div style="display: flex; justify-content: space-between;"> <div>NO</div> <div>NIM 5 4745 014 DQ 3 A</div> </div>		<div style="display: flex; justify-content: space-between;"> <div> <p style="font-size: 0.8em;">شركة تنمية نفط عمان Petroleum Development Oman</p> </div> <div> <p style="font-size: 0.8em;">CAD DRAWING</p> </div> </div>																




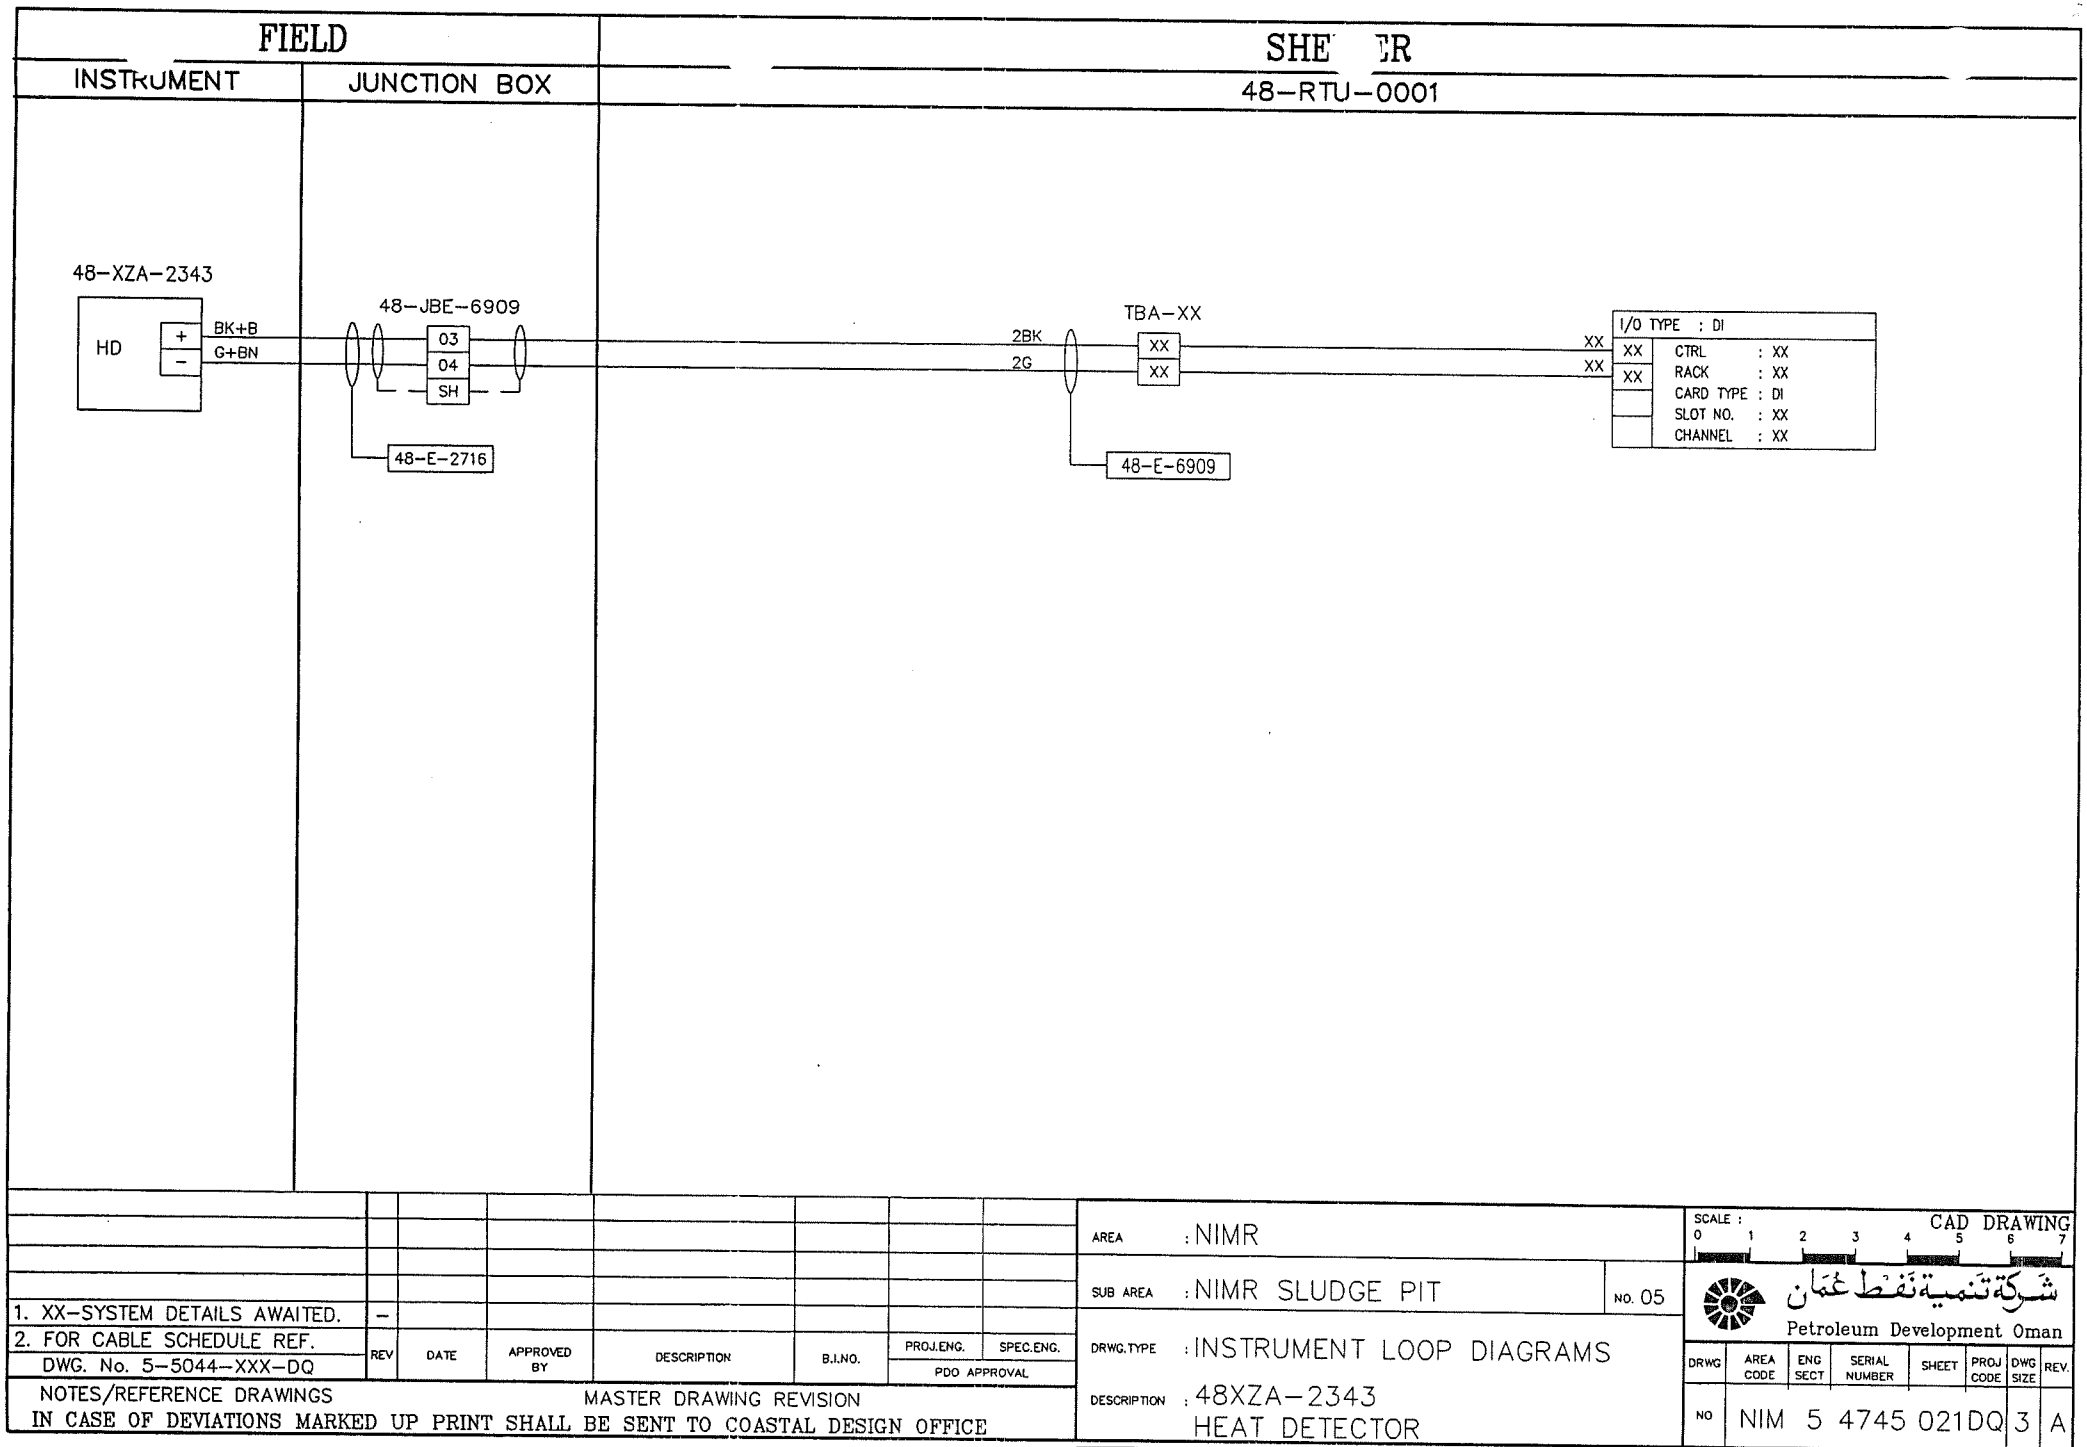

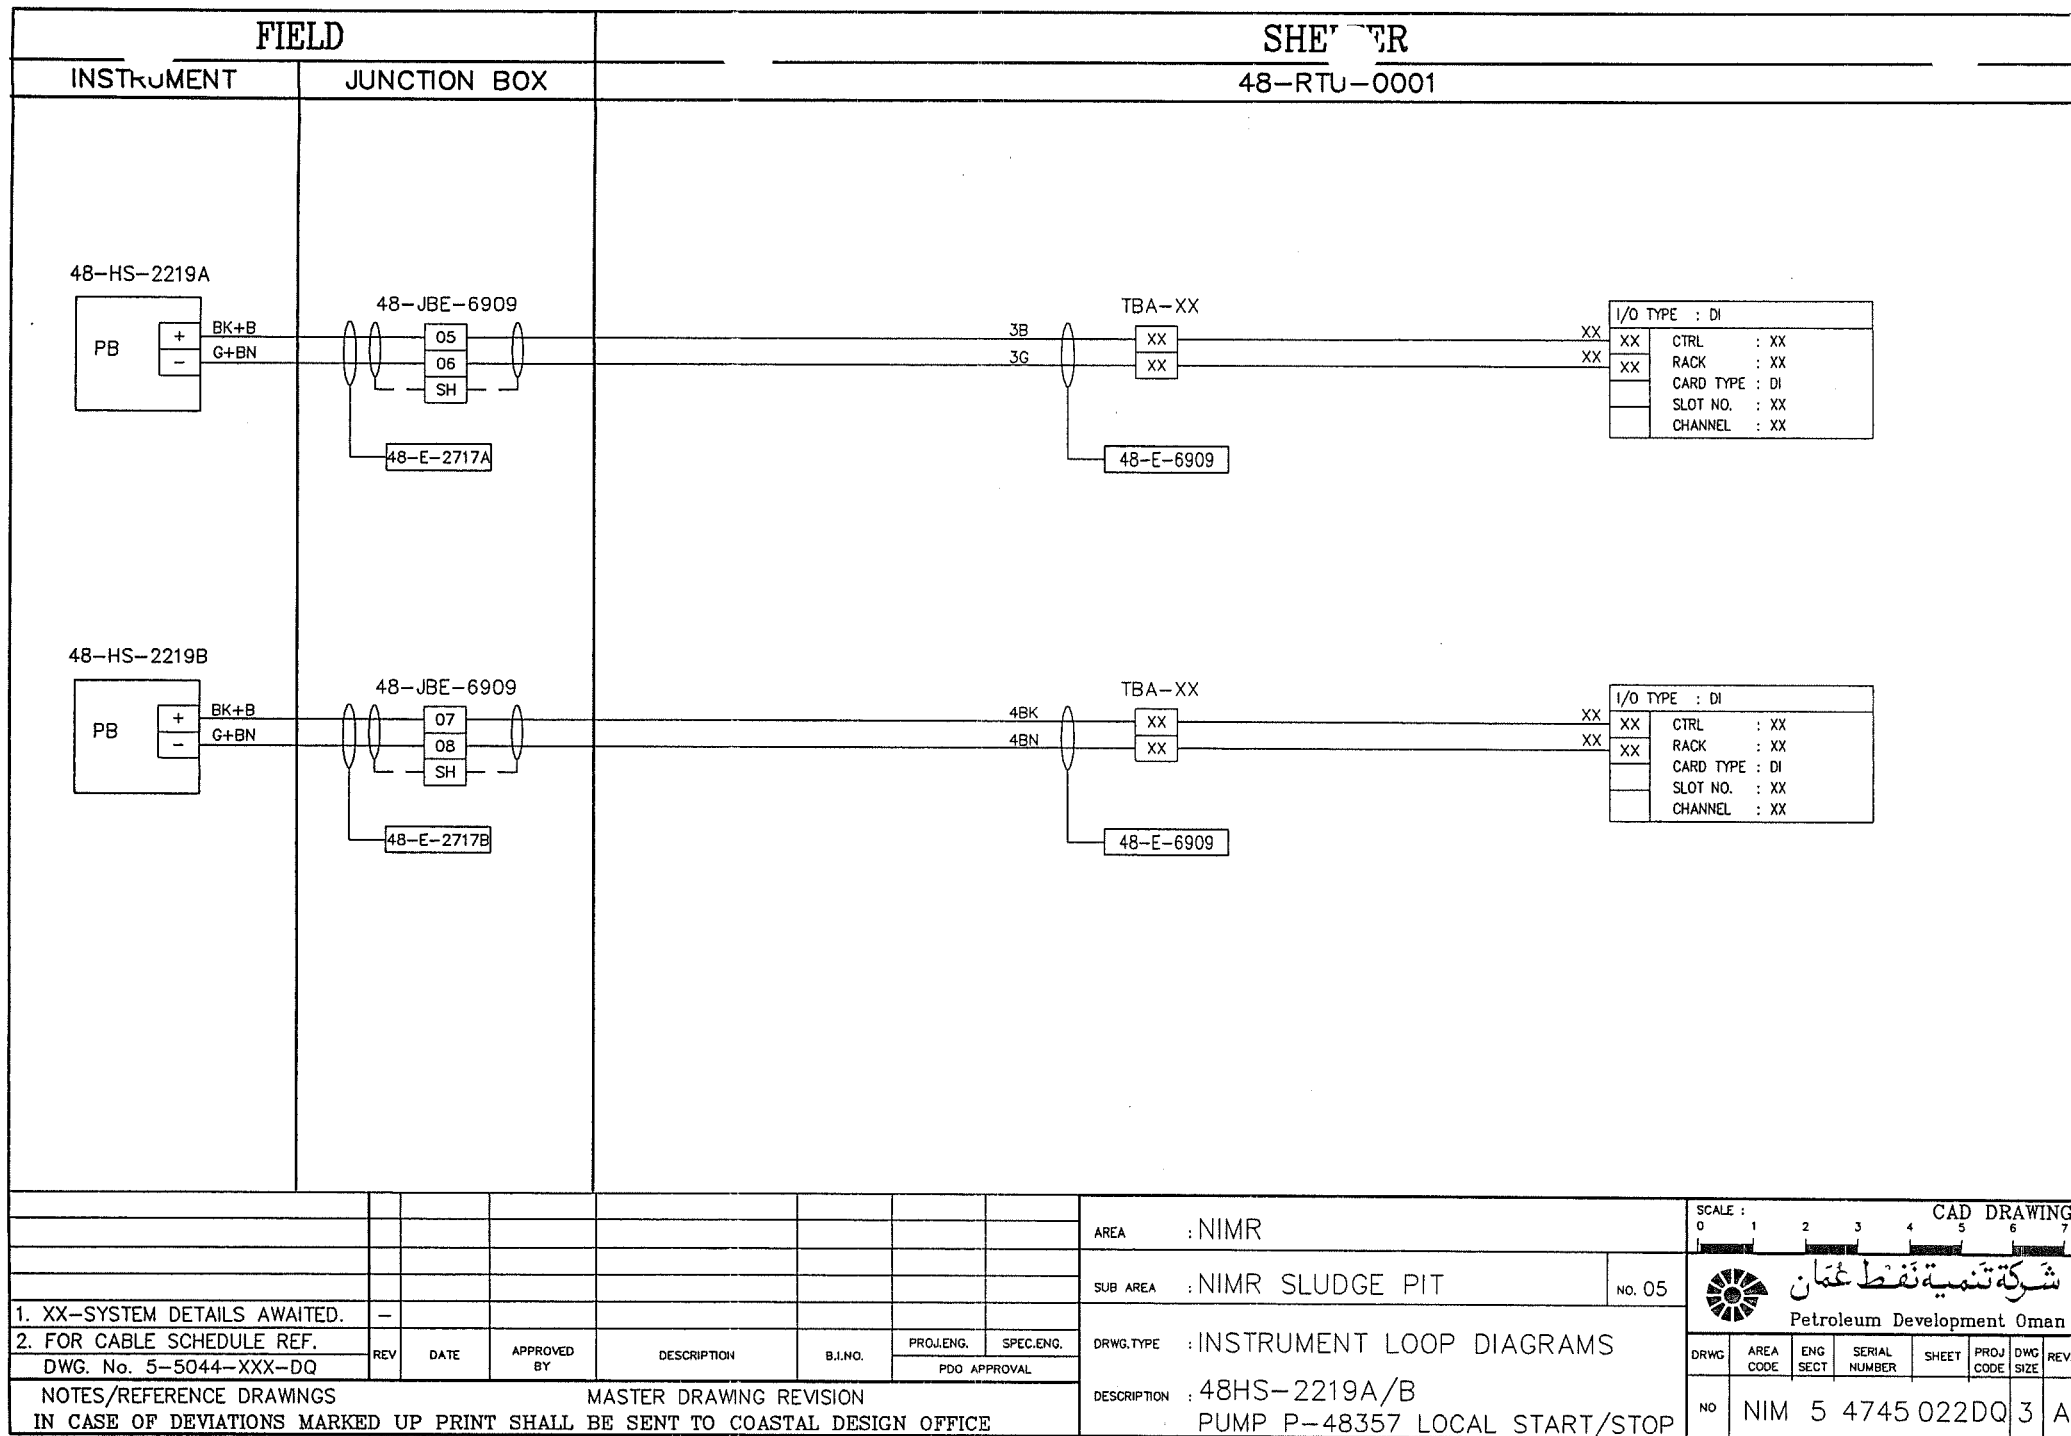

FIELD INSTRUMENT	SHEET 48-RTU-0001																														
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<div style="display: flex; justify-content: space-between;"> <div> 1. XX-SYSTEM DETAILS AWAITED. 2. FOR CABLE SCHEDULE REF. DWG. No. 5-5044-XXX-DQ </div> <table border="1" style="width: 100%; border-collapse: collapse; font-size: 8px;"> <thead> <tr> <th>REV</th> <th>DATE</th> <th>APPROVED BY</th> <th>DESCRIPTION</th> <th>B.I.NO.</th> <th>PROJ.ENG.</th> <th>SPEC.ENG.</th> </tr> </thead> <tbody> <tr> <td> </td> <td> </td> <td> </td> <td> </td> <td> </td> <td> </td> <td> </td> </tr> </tbody> </table> </div>	REV	DATE	APPROVED BY	DESCRIPTION	B.I.NO.	PROJ.ENG.	SPEC.ENG.								<div style="display: flex; justify-content: space-between;"> <div> AREA : NIMR SUB AREA : NIMR SLUDGE PIT DRWG. TYPE : INST.LOOP DIAGRAMS DESCRIPTION : 48XA-4106 AUDIBLE ALARM </div> <div style="text-align: right;"> SCALE : CAD DRAWING شركة تنمية نفط عمان Petroleum Development Oman </div> </div> <table border="1" style="width: 100%; border-collapse: collapse; font-size: 8px;"> <thead> <tr> <th>DRWG</th> <th>AREA CODE</th> <th>ENG SECT</th> <th>SERIAL NUMBER</th> <th>SHEET</th> <th>PROJ CODE</th> <th>DWG SIZE</th> <th>REV.</th> </tr> </thead> <tbody> <tr> <td>NO</td> <td>NIM</td> <td>5</td> <td>4745</td> <td>028DQ</td> <td>3</td> <td>A</td> <td> </td> </tr> </tbody> </table>	DRWG	AREA CODE	ENG SECT	SERIAL NUMBER	SHEET	PROJ CODE	DWG SIZE	REV.	NO	NIM	5	4745	028DQ	3	A	
REV	DATE	APPROVED BY	DESCRIPTION	B.I.NO.	PROJ.ENG.	SPEC.ENG.																									
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FIELD		SHEET																															
INSTRUMENT	JUNCTION BOX	48-RTU-0001																															
<div style="display: flex; justify-content: space-between; align-items: flex-start;"> <div style="width: 15%;"> <p>48-HS-2663</p> <div style="border: 1px solid black; padding: 5px; width: 50px; margin: 10px auto;"> PB <div style="display: flex; justify-content: space-between; font-size: 0.8em;"> +BK+B -G+BN </div> </div> </div> <div style="width: 15%;"> <p>48-JBE-6910</p> <div style="display: flex; justify-content: space-around; align-items: center;"> <div style="border: 1px solid black; padding: 2px; text-align: center;">09</div> <div style="border: 1px solid black; padding: 2px; text-align: center;">10</div> <div style="border: 1px solid black; padding: 2px; text-align: center;">SH</div> </div> <div style="margin-top: 10px;"> <div style="display: flex; justify-content: space-between; font-size: 0.7em;"> VENDORINST. CONTRACTOR </div> <div style="border: 1px solid black; padding: 2px; width: 50px; margin: 5px auto;">48-E-2725</div> </div> </div> <div style="width: 60%; text-align: center;"> <p>5B 5BN</p> <p>TBA-XX</p> <div style="display: flex; justify-content: center; align-items: center; gap: 10px;"> <div style="border: 1px solid black; padding: 2px;">XX</div> <div style="border: 1px solid black; padding: 2px;">XX</div> </div> <div style="margin-top: 10px;"> <div style="border: 1px solid black; padding: 2px; width: 50px; margin: 0 auto;">48-E-6910</div> </div> </div> <div style="width: 15%; text-align: right;"> <p>I/O TYPE : DI</p> <table border="1" style="font-size: 0.7em; border-collapse: collapse;"> <tr><td>XX</td><td>CTRL</td><td>: XX</td></tr> <tr><td>XX</td><td>RACK</td><td>: XX</td></tr> <tr><td>XX</td><td>CARD TYPE</td><td>: DI</td></tr> <tr><td></td><td>SLOT NO.</td><td>: XX</td></tr> <tr><td></td><td>CHANNEL</td><td>: XX</td></tr> </table> </div> </div>				XX	CTRL	: XX	XX	RACK	: XX	XX	CARD TYPE	: DI		SLOT NO.	: XX		CHANNEL	: XX															
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REV	DATE	APPROVED BY	DESCRIPTION	B.I.NO.	PROJ.ENG.	SPEC.ENG.																											
PDO APPROVAL																																	
DRWG	AREA CODE	ENG SECT	SERIAL NUMBER	SHEET	PROJ CODE	DWG SIZE	REV.																										
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NOTES/REFERENCE DRAWINGS MASTER DRAWING REVISION

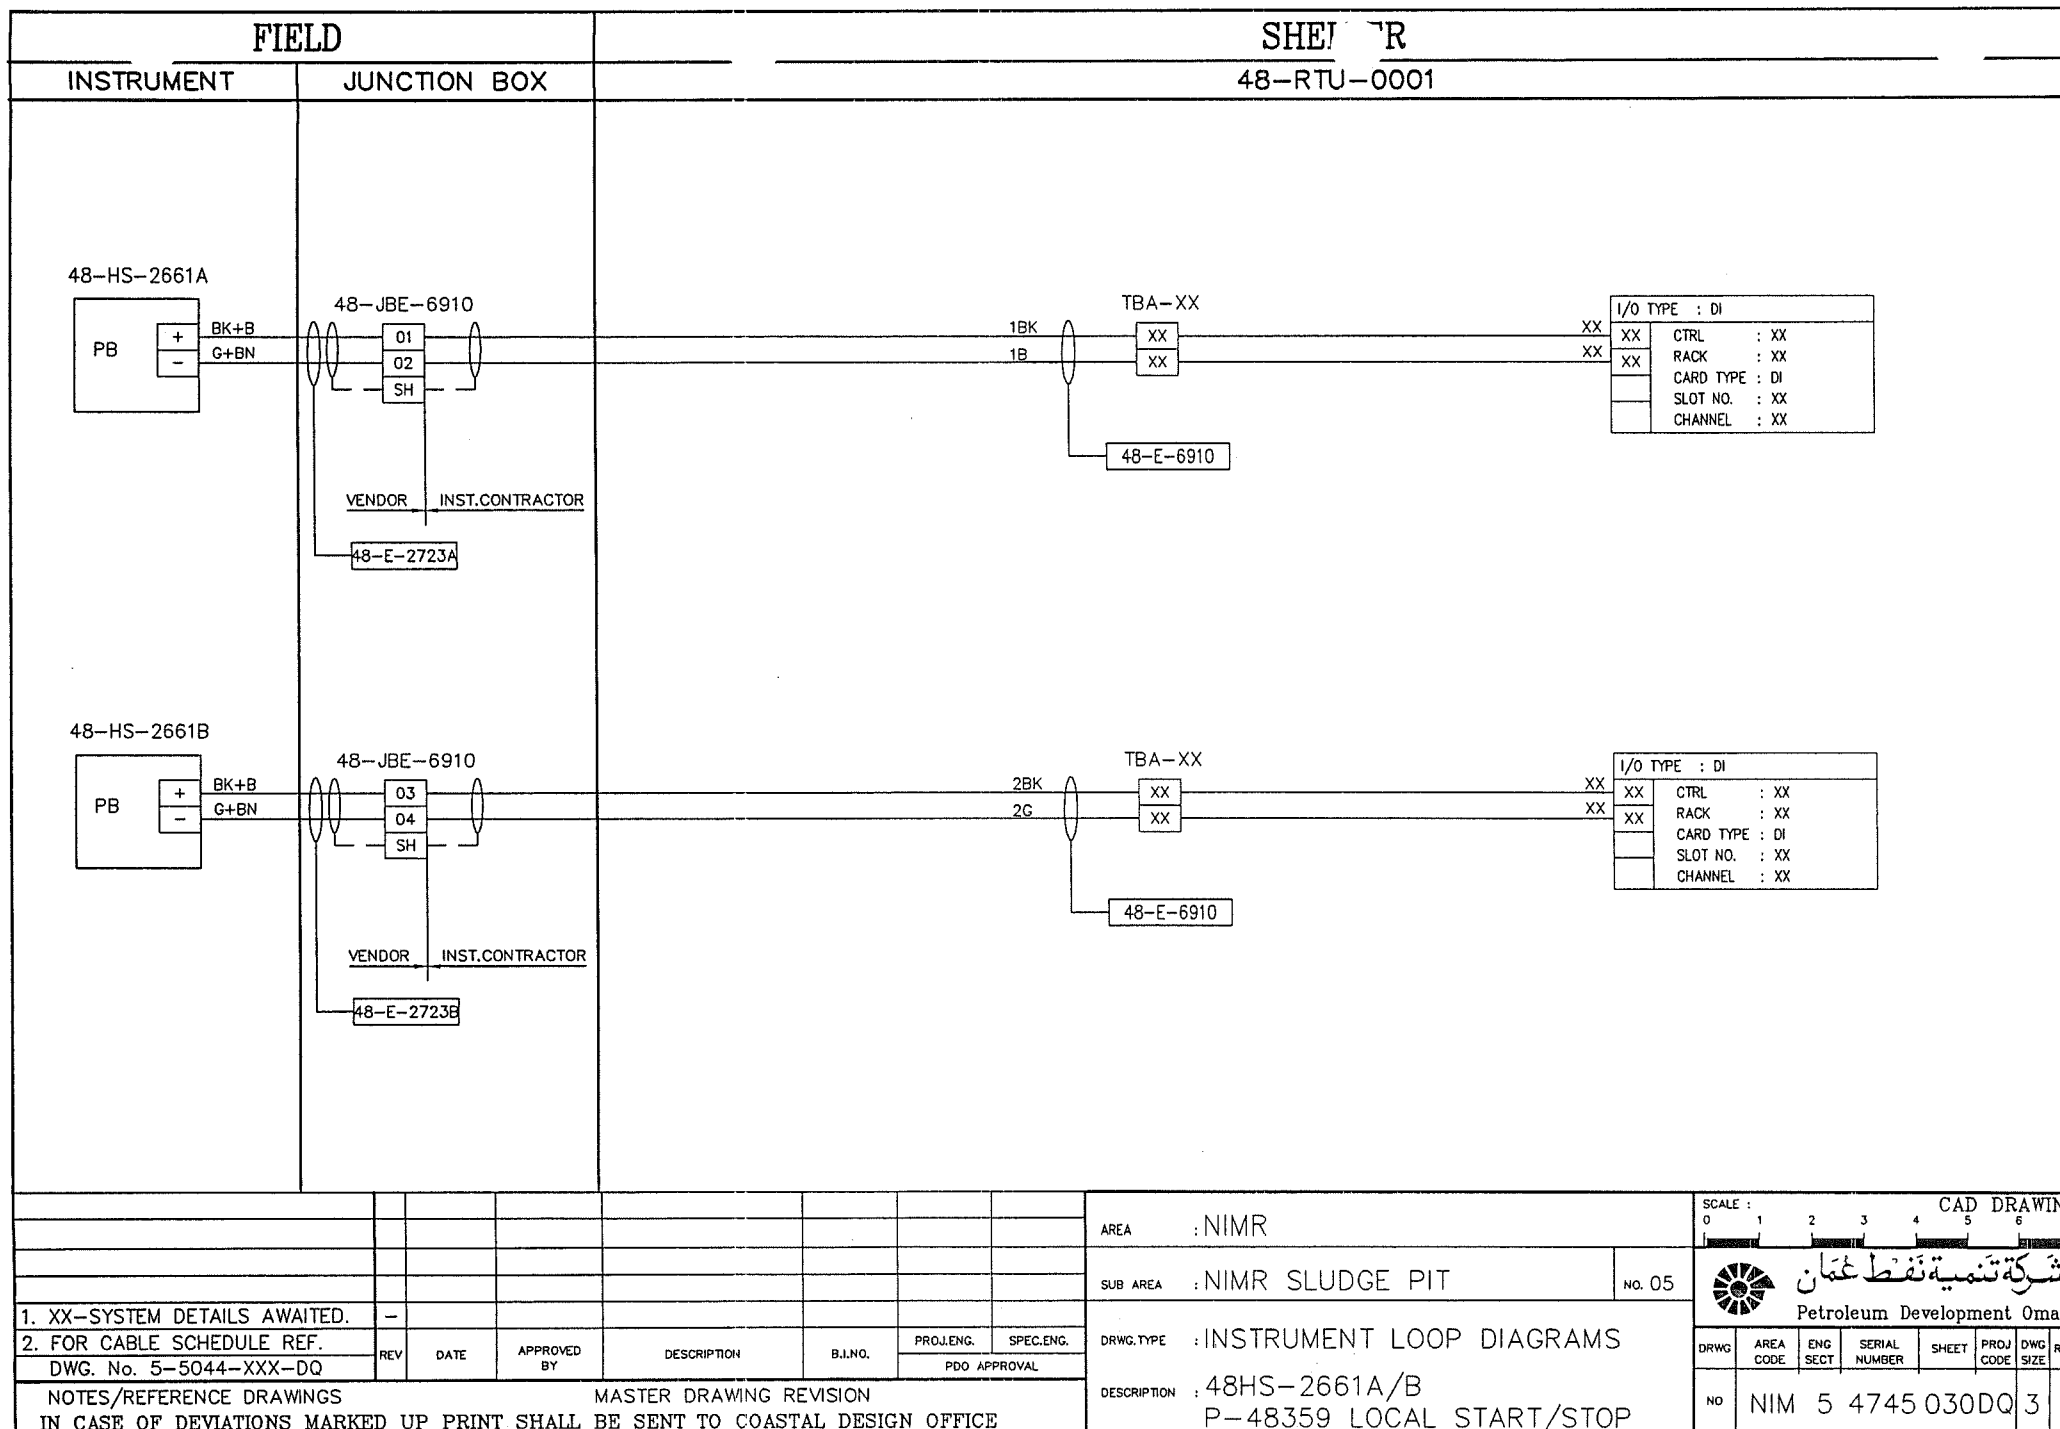IN CASE OF DEVIATIONS MARKED UP PRINT SHALL BE SENT TO COASTAL DESIGN OFFICE

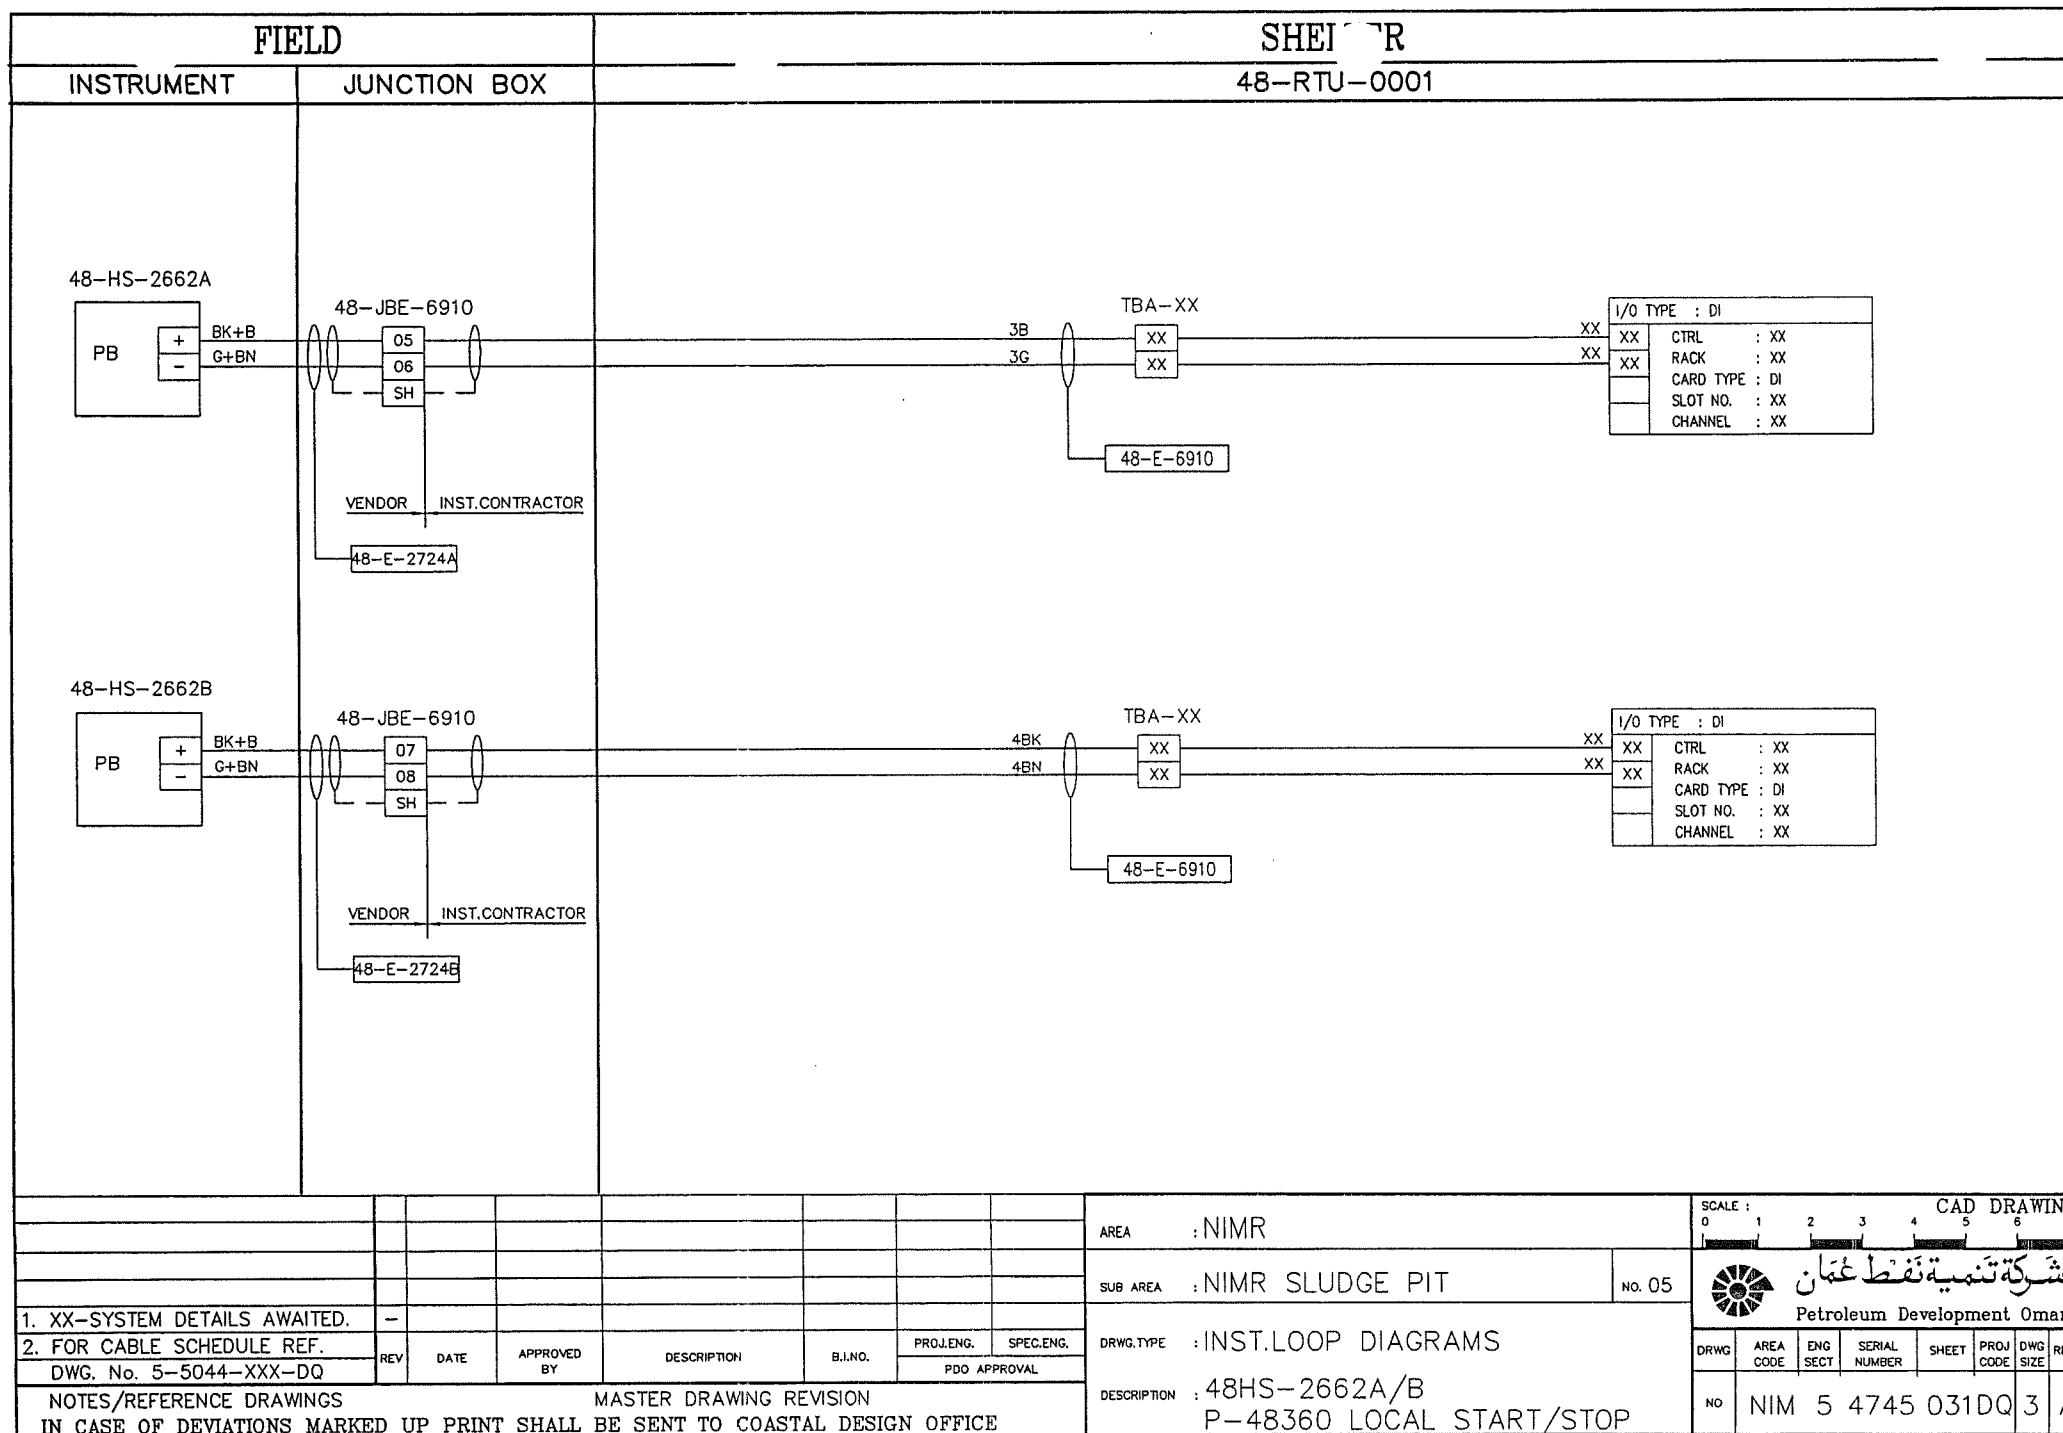

FIELD		SHEET																	
INSTRUMENT	JUNCTION BOX	48-RTU-0001																	
<div style="display: flex; justify-content: space-between; align-items: flex-start;"> <div style="width: 15%;"> <p>48-LIA-1449</p> <div style="border: 1px solid black; padding: 5px; width: 50px; margin: 10px auto;">Tx</div> <div style="display: flex; justify-content: space-around; margin-top: 5px;"> +BK+B -G+BN </div> </div> <div style="width: 15%;"> <p>48-JBE-6911</p> <div style="display: flex; justify-content: space-around; margin-top: 10px;"> <div style="border: 1px solid black; padding: 2px; text-align: center;">01</div> <div style="border: 1px solid black; padding: 2px; text-align: center;">02</div> <div style="border: 1px solid black; padding: 2px; text-align: center;">SH</div> </div> <div style="margin-top: 10px;"> <p>VENDOR _____</p> <p>INST.CONTRACTOR _____</p> </div> <div style="border: 1px solid black; padding: 2px; margin-top: 10px; width: 50px; text-align: center;">48-E-2727</div> </div> <div style="width: 60%; text-align: center;"> <p>1BK 1B</p> <p>TBA-XX</p> <div style="display: flex; justify-content: space-around; margin-top: 10px;"> <div style="border: 1px solid black; padding: 2px; text-align: center;">XX</div> <div style="border: 1px solid black; padding: 2px; text-align: center;">XX</div> </div> <div style="border: 1px solid black; padding: 2px; margin-top: 10px; width: 50px; text-align: center;">48-E-6911</div> </div> <div style="width: 10%; text-align: right;"> <p>XX XX</p> </div> </div> <div style="margin-top: 20px; text-align: right;"> <table border="1" style="border-collapse: collapse; font-size: 8px;"> <tr><td colspan="2">I/O TYPE : AI</td></tr> <tr><td>XX</td><td>CTRL : XX</td></tr> <tr><td>XX</td><td>RACK : XX</td></tr> <tr><td></td><td>CARD TYPE : AI</td></tr> <tr><td></td><td>SLOT NO. : XX</td></tr> <tr><td></td><td>CHANNEL : XX</td></tr> </table> </div>				I/O TYPE : AI		XX	CTRL : XX	XX	RACK : XX		CARD TYPE : AI		SLOT NO. : XX		CHANNEL : XX				
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	SLOT NO. : XX																		
	CHANNEL : XX																		
<div style="display: flex; justify-content: space-between;"> <div style="width: 15%;"> <p>1. XX-SYSTEM DETAILS AWAITED.</p> <p>2. FOR CABLE SCHEDULE REF.</p> <p>DWG. No. 5-5044-XXX-DQ</p> </div> <div style="width: 15%;"> <p>REV</p> </div> <div style="width: 15%;"> <p>DATE</p> </div> <div style="width: 15%;"> <p>APPROVED BY</p> </div> <div style="width: 15%;"> <p>DESCRIPTION</p> </div> <div style="width: 15%;"> <p>B.I.NO.</p> </div> <div style="width: 15%;"> <p>PROJ.ENG.</p> <p>SPEC.ENG.</p> <p>PDO APPROVAL</p> </div> </div>		<div style="display: flex; justify-content: space-between;"> <div style="width: 45%;"> <p>AREA : NIMR</p> <p>SUB AREA : NIMR SLUDGE PIT</p> <p>DRWG. TYPE : INSTRUMENT LOOP DIAGRAMS</p> <p>DESCRIPTION : 48LIA-1449</p> <p style="text-align: center;">OXYGEN SCAVENGER DOSING TANK LEVEL</p> </div> <div style="width: 10%; text-align: center;"> <p>No. 05</p> </div> <div style="width: 45%;"> <p>SCALE : 0 1 2 3 4 5 6 7</p> <p style="text-align: center;">CAD DRAWING</p> <div style="display: flex; align-items: center; justify-content: center;"> <div style="margin-left: 10px;"> <p style="font-size: 12px; font-weight: bold;">شركة تنمية نفط عمان</p> <p style="font-size: 10px;">Petroleum Development Oman</p> </div> </div> <table border="1" style="border-collapse: collapse; font-size: 8px; width: 100%;"> <tr> <th>DRWG</th> <th>AREA CODE</th> <th>ENG SECT</th> <th>SERIAL NUMBER</th> <th>SHEET</th> <th>PROJ CODE</th> <th>DWG SIZE</th> <th>REV.</th> </tr> <tr> <td>NIM</td> <td>5</td> <td>4745</td> <td>037DQ</td> <td>3</td> <td></td> <td></td> <td>A</td> </tr> </table> </div> </div>		DRWG	AREA CODE	ENG SECT	SERIAL NUMBER	SHEET	PROJ CODE	DWG SIZE	REV.	NIM	5	4745	037DQ	3			A
DRWG	AREA CODE	ENG SECT	SERIAL NUMBER	SHEET	PROJ CODE	DWG SIZE	REV.												
NIM	5	4745	037DQ	3			A												

FIELD		SHF ER	
INSTRUMENT	JUNCTION BOX	48-RTU-0001	
<div style="display: flex; justify-content: space-between;"> <div style="width: 25%;"> <p>48-PIZA-1519</p> <div style="border: 1px solid black; padding: 5px; width: 60px; margin: 10px auto;"> Tx <div style="display: flex; justify-content: space-between; width: 100%;"> + BK+B </div> <div style="display: flex; justify-content: space-between; width: 100%;"> - G+BN </div> </div> </div> <div style="width: 25%;"> <p>48-JBE-6911</p> <div style="display: flex; justify-content: space-between; width: 60px; margin: 10px auto;"> <div style="border: 1px solid black; padding: 2px;">07</div> <div style="border: 1px solid black; padding: 2px;">08</div> <div style="border: 1px solid black; padding: 2px;">SH</div> </div> <div style="display: flex; justify-content: space-between; width: 100%; margin-top: 10px;"> VENDOR INST.CONTRACTOR </div> <div style="border: 1px solid black; padding: 2px; width: 60px; margin: 10px auto;">48-E-2730</div> </div> <div style="width: 50%; text-align: center;"> <p>4BK 4BN</p> <p>TBA-XX</p> <div style="display: flex; justify-content: space-around; width: 100%;"> <div style="border: 1px solid black; padding: 2px;">XX</div> <div style="border: 1px solid black; padding: 2px;">XX</div> </div> <div style="border: 1px solid black; padding: 2px; width: 60px; margin: 10px auto;">48-E-6911</div> </div> </div> <div style="border: 1px solid black; padding: 5px; width: 150px; float: right; margin-top: 20px;"> I/O TYPE : AI XX CTRL : XX XX RACK : XX XX CARD TYPE : AI SLOT NO. : XX CHANNEL : XX </div>			

AREA : NIMR

SUB AREA : NIMR SLUDGE PIT

DRWG. TYPE : INST.LOOP DIAGRAMS

DESCRIPTION : 48PIZA-1519
P-48360 DIAPHRAGM FAILED


SCALE :
0 1 2 3 4 5 6 7

CAD DRAWING

شركة تنمية نفط عمان
Petroleum Development Oman

DRWG	AREA CODE	ENG SECT	SERIAL NUMBER	SHEET	PROJ CODE	DWG SIZE	REV.
NO	NIM	5	4745	040DQ	3	A	



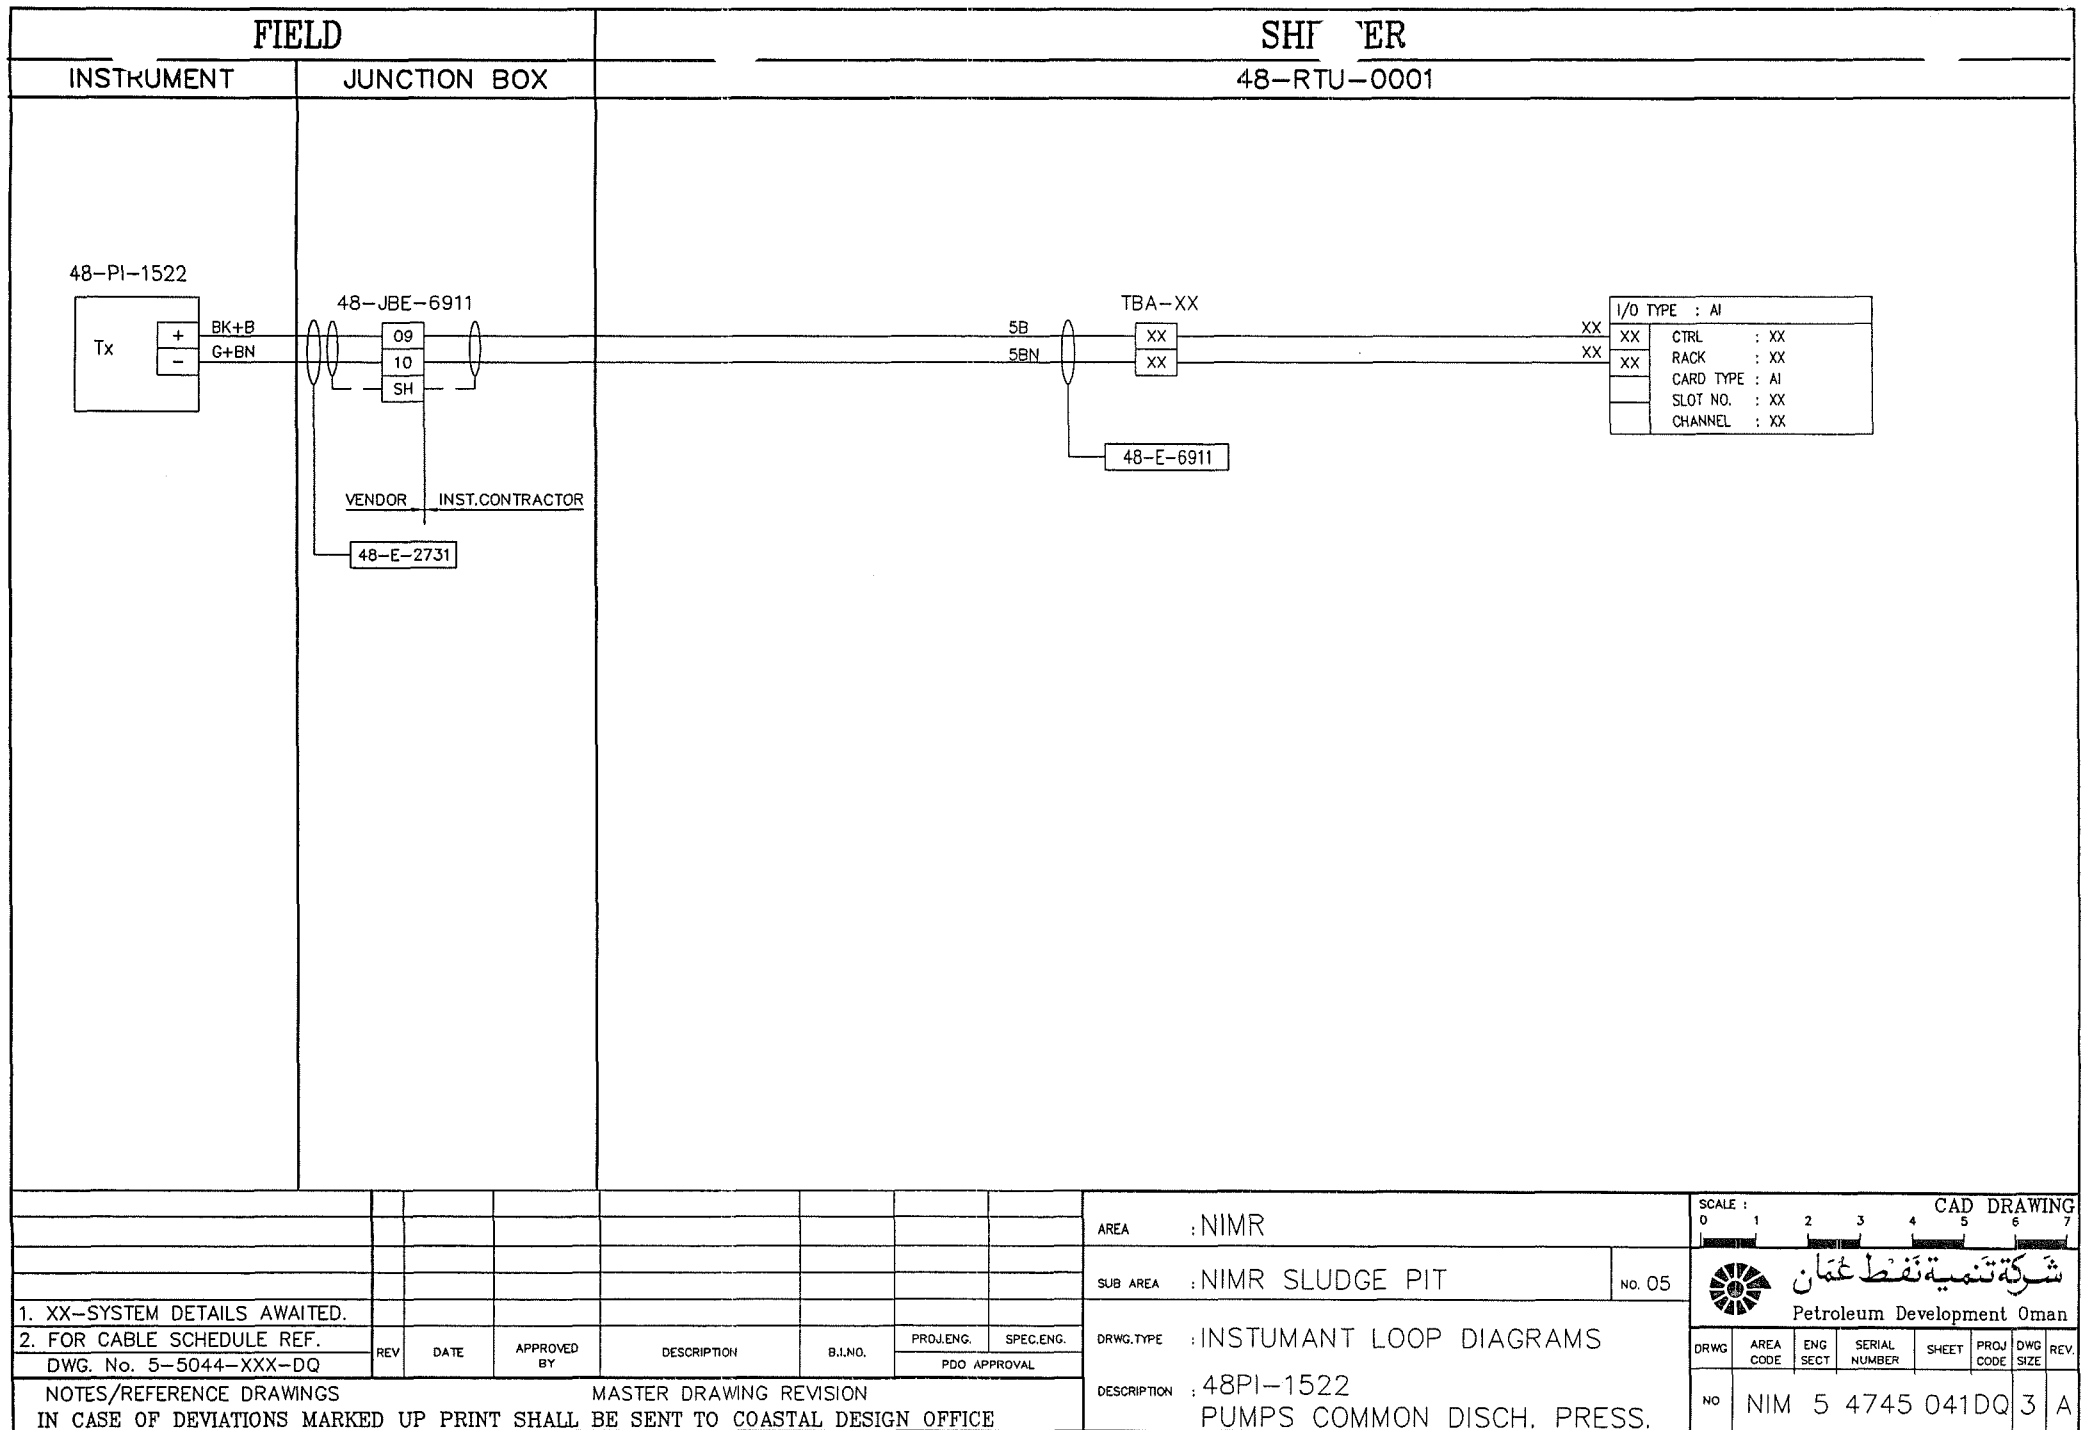

FIELD		SHF TER	
INSTRUMENT	JUNCTION BOX	48-RTU-0001	
<div style="border: 1px solid black; padding: 5px; margin-bottom: 10px;"> 48-FI-1415 Tx <div style="display: flex; justify-content: space-between; align-items: center;"> <div style="border: 1px solid black; padding: 2px;">+</div> <div>BK+B</div> </div> <div style="display: flex; justify-content: space-between; align-items: center;"> <div style="border: 1px solid black; padding: 2px;">-</div> <div>G+BN</div> </div> </div>	<div style="display: flex; align-items: center;"> <div style="border: 1px solid black; padding: 5px; margin-right: 10px;"> 48-JBE-6911 <div style="display: flex; justify-content: space-between;"> <div>11</div> <div>12</div> </div> <div style="border: 1px solid black; padding: 2px; margin-top: 5px;">SH</div> </div> <div style="margin-left: 10px;"> VENDOR INST.CONTRACTOR </div> </div> <div style="border: 1px solid black; padding: 2px; margin-top: 10px; width: fit-content;"> 48-E-2732 </div>		<div style="display: flex; align-items: center; justify-content: space-around;"> <div style="text-align: center;"> 6G 6BN </div> <div style="border: 1px solid black; padding: 5px;"> TBA-XX <div style="display: flex; justify-content: space-between;"> <div style="border: 1px solid black; padding: 2px;">XX</div> <div style="border: 1px solid black; padding: 2px;">XX</div> </div> </div> <div style="text-align: center;"> 48-E-6911 </div> </div>
		<div style="border: 1px solid black; padding: 5px; display: inline-block;"> I/O TYPE : AI <div style="display: flex; justify-content: space-between;"> <div style="border: 1px solid black; padding: 2px;">XX</div> <div>CTRL : XX</div> </div> <div style="display: flex; justify-content: space-between;"> <div style="border: 1px solid black; padding: 2px;">XX</div> <div>RACK : XX</div> </div> <div style="display: flex; justify-content: space-between;"> <div style="border: 1px solid black; padding: 2px;"></div> <div>CARD TYPE : AI</div> </div> <div style="display: flex; justify-content: space-between;"> <div style="border: 1px solid black; padding: 2px;"></div> <div>SLOT NO. : XX</div> </div> <div style="display: flex; justify-content: space-between;"> <div style="border: 1px solid black; padding: 2px;"></div> <div>CHANNEL : XX</div> </div> </div>	

<div style="display: flex; justify-content: space-between;"> <div> 1. XX-SYSTEM DETAILS AWAITED. 2. FOR CABLE SCHEDULE REF. DWG. No. 5-5044-XXX-DQ </div> <div style="border: 1px solid black; padding: 5px;"> <table style="width:100%; border-collapse: collapse;"> <tr> <th>REV</th> <th>DATE</th> <th>APPROVED BY</th> <th>DESCRIPTION</th> <th>S.I.NO.</th> <th>PROJ.ENG.</th> <th>SPEC.ENG.</th> </tr> <tr> <td colspan="7" style="text-align: center;">PDD APPROVAL</td> </tr> </table> </div> </div>	REV	DATE	APPROVED BY	DESCRIPTION	S.I.NO.	PROJ.ENG.	SPEC.ENG.	PDD APPROVAL							<div style="display: flex; justify-content: space-between;"> <div> AREA : NIMR SUB AREA : NIMR SLUDGE PIT DRWG. TYPE : INST.LOOP DIAGRAMS DESCRIPTION : 48FI-1415 PUMPS COMMON DISCH. FLOW </div> <div style="border: 1px solid black; padding: 5px; text-align: center;"> NO. 05 </div> </div>
REV	DATE	APPROVED BY	DESCRIPTION	S.I.NO.	PROJ.ENG.	SPEC.ENG.									
PDD APPROVAL															


NOTES/REFERENCE DRAWINGS IN CASE OF DEVIATIONS MARKED UP PRINT SHALL BE SENT TO COASTAL DESIGN OFFICE		MASTER DRAWING REVISION	
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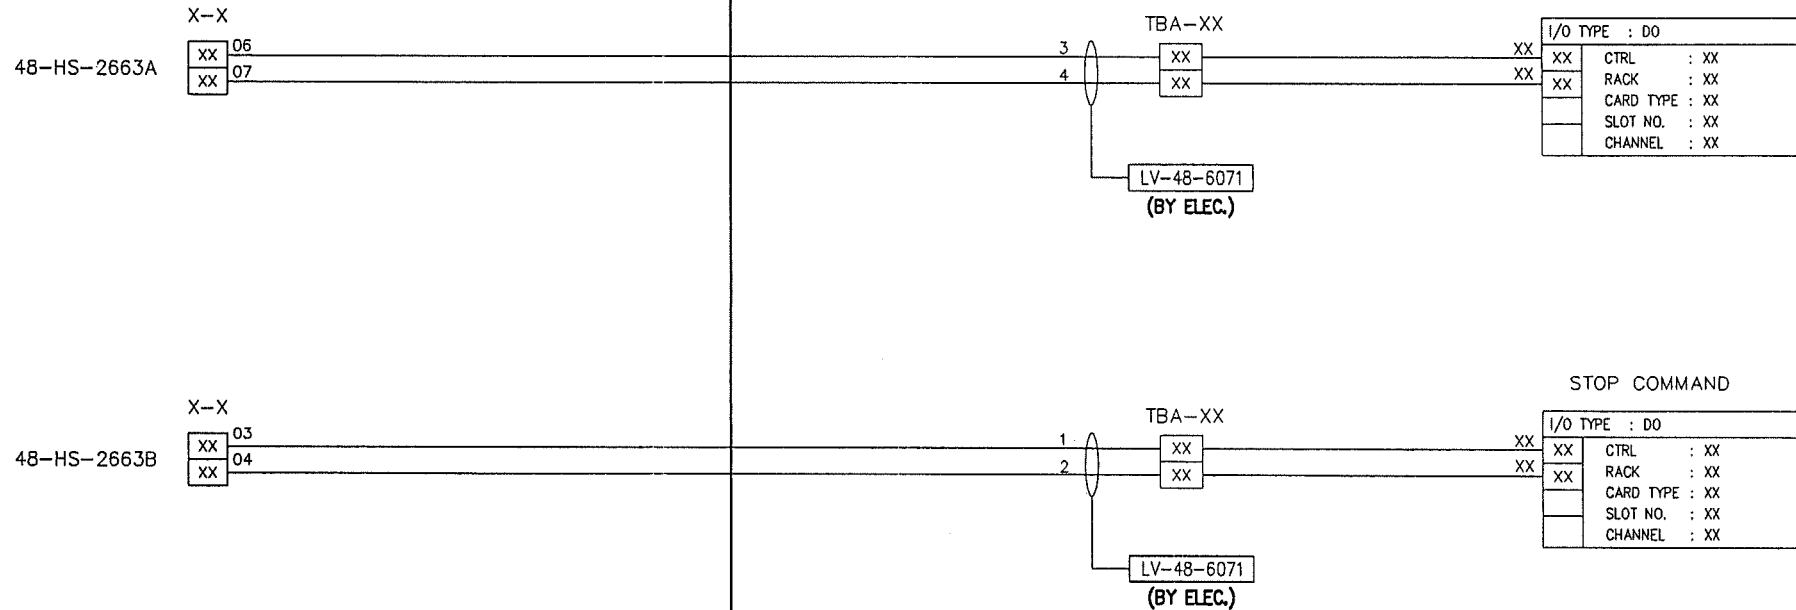
1. XX-SYSTEM DETAILS AWAITED.		2. FOR CABLE SCHEDULE REF.		DWG. No. 5-5044-XXX-DQ		REV	DATE	APPROVED BY	DESCRIPTION	B.I.NO.	PROJ.ENG.	SPEC.ENG.	PDO APPROVAL	AREA : NIMR	SUB AREA : NIMR SLUDGE PIT	NO. 05	SCALE : 0 1 2 3 4 5 6 7	CAD DRAWING				
NOTES/REFERENCE DRAWINGS IN CASE OF DEVIATIONS MARKED UP PRINT SHALL BE SENT TO COASTAL DESIGN OFFICE														MASTER DRAWING REVISION					DRWG TYPE : INSTRUMENT LOOP DIAGRAMS DESCRIPTION : 48-HS-2664A/B P-48360 PUMP STOP/START		DRWG : AREA CODE ENG SECT SERIAL NUMBER SHEET PROJ CODE DWG SIZE REV NO : NIM 5 4745 050DQ 3 A	




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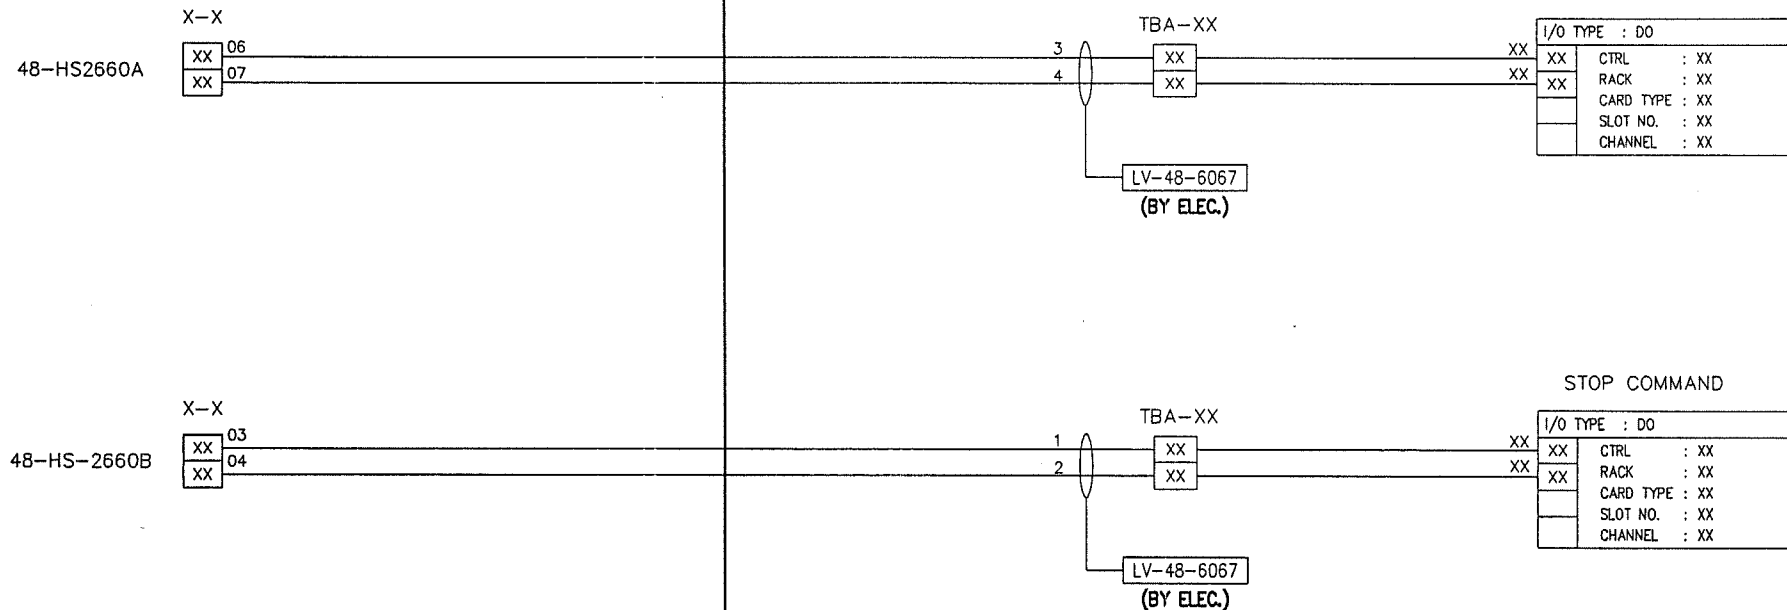


1. XX-SYSTEM DETAILS AWAITED.		-								AREA : NIMR		SCALE : 0 1 2 3 4 5 6 7		CAD DRAWING						
2. FOR CABLE SCHEDULE REF.										SUB AREA : NIMR SLUDGE PIT		NO. 05		 شركة تنمية نفط عمان Petroleum Development Oman						
DWG. No. 5-5044-XXX-DQ		REV	DATE	APPROVED BY	DESCRIPTION	B.I.NO.	PROJ.ENG.	SPEC.ENG.	DRWG. TYPE : INSTRUMENT LOOP DIAGRAMS		DESCRIPTION : 48-HS-2663A/B P-48359 PUMP STOP/START		DRWG	AREA CODE	ENG SECT	SERIAL NUMBER	SHEET	PROJ CODE	DWG SIZE	REV.
NOTES/REFERENCE DRAWINGS										MASTER DRAWING REVISION										
IN CASE OF DEVIATIONS MARKED UP PRINT SHALL BE SENT TO COASTAL DESIGN OFFICE																				
										NO NIM 5 4745 051DQ 3 A										

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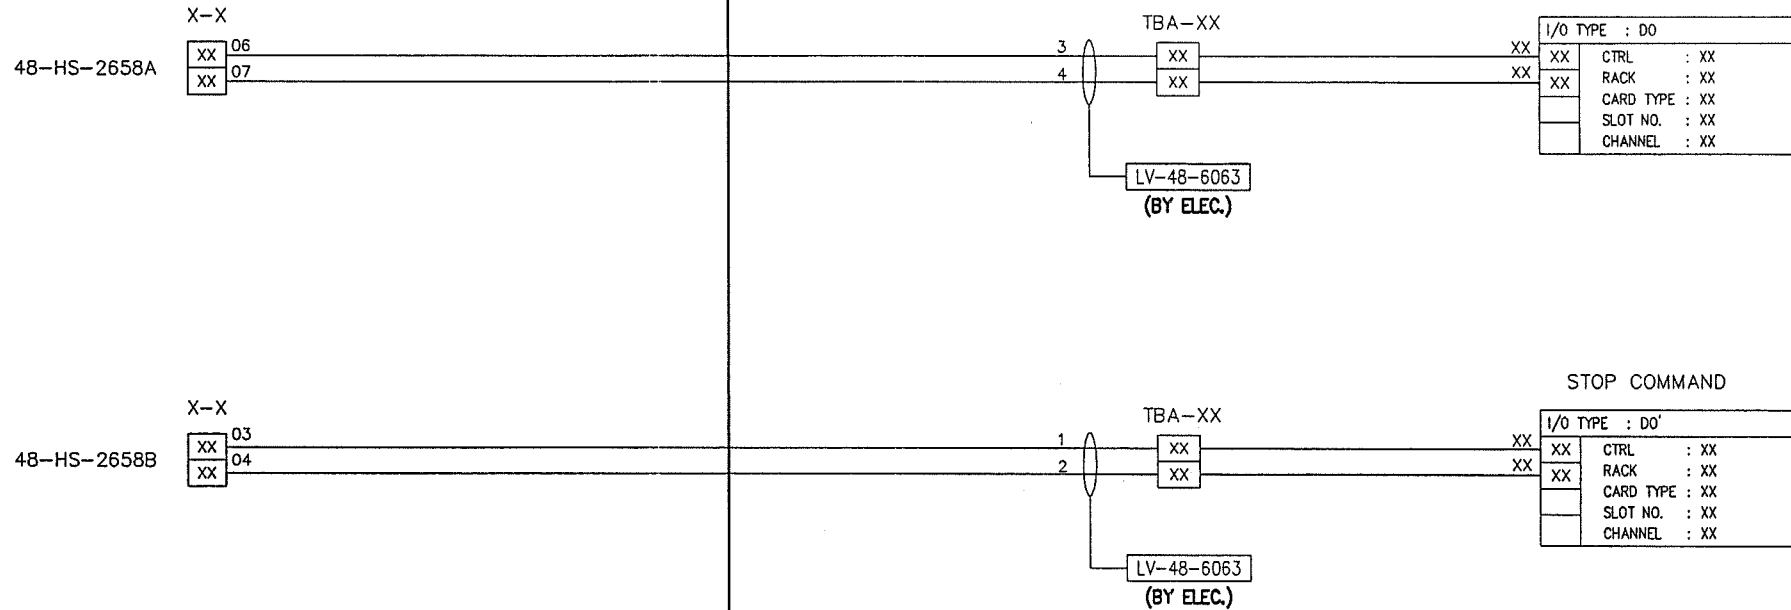
1. XX-SYSTEM DETAILS AWAITED.		2. FOR CABLE SCHEDULE REF.		DWG. No. 5-5044-XXX-DQ		REV	DATE	APPROVED BY	DESCRIPTION	B.I.NO.	PROJ.ENG.	SPEC.ENG.	PDO APPROVAL																
<p>NOTES/REFERENCE DRAWINGS</p> <p>MASTER DRAWING REVISION</p> <p>IN CASE OF DEVIATIONS MARKED UP PRINT SHALL BE SENT TO COASTAL DESIGN OFFICE</p>																													
AREA : NIMR		SUB AREA : NIMR SLUDGE PIT		No. 05		SCALE : 0 1 2 3 4 5 6 7		CAD DRAWING		<p>شركة تنمية نفط عمان</p> <p>Petroleum Development Oman</p>		<table border="1"> <tr> <th>DRWG</th> <th>AREA CODE</th> <th>ENG SECT</th> <th>SERIAL NUMBER</th> <th>SHEET</th> <th>PROJ CODE</th> <th>DWG SIZE</th> <th>REV.</th> </tr> <tr> <td>NO</td> <td>NIM</td> <td>5</td> <td>4745</td> <td>052DQ</td> <td>3</td> <td>A</td> <td></td> </tr> </table>		DRWG	AREA CODE	ENG SECT	SERIAL NUMBER	SHEET	PROJ CODE	DWG SIZE	REV.	NO	NIM	5	4745	052DQ	3	A	
DRWG	AREA CODE	ENG SECT	SERIAL NUMBER	SHEET	PROJ CODE	DWG SIZE	REV.																						
NO	NIM	5	4745	052DQ	3	A																							
DRWG. TYPE : INSTRUMENT LOOP DIAGRAMS		DESCRIPTION : 48-HS-2660A/B		P-48358 PUMP STOP/START																									

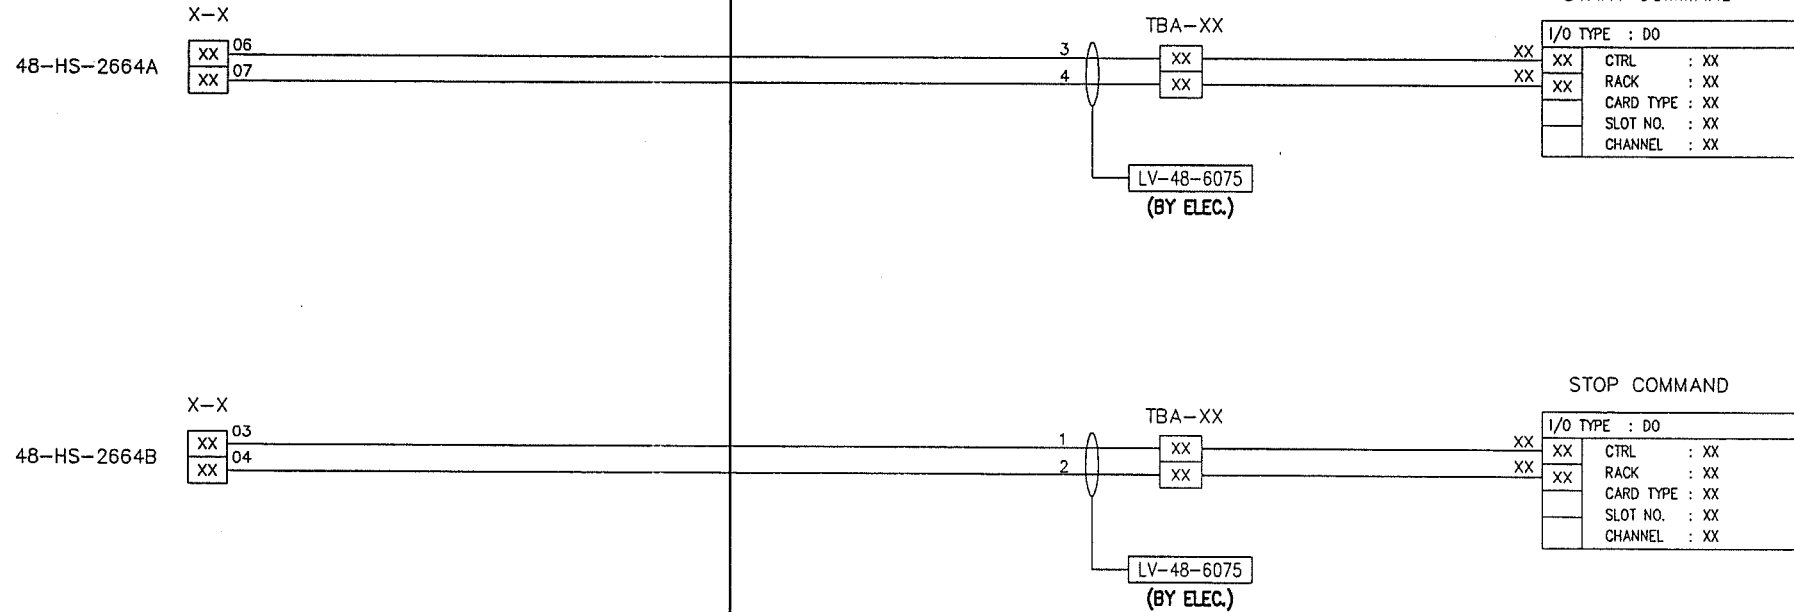


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1. XX-SYSTEM DETAILS AWAITED.		-								AREA : NIMR		SCALE : 0 1 2 3 4 5 6 7		CAD DRAWING					
2. FOR CABLE SCHEDULE REF.										SUB AREA : NIMR SLUDGE PIT		No. 05		 شركة تنمية نفط عُمان Petroleum Development Oman					
DWG. No. 5-5044-XXX-DQ		REV	DATE	APPROVED BY	DESCRIPTION	B.I.NO.	PROJ.ENG.	SPEC.ENG.	DRWG. TYPE : INSTRUMENT LOOP DIAGRAMS		DRWG		AREA CODE	ENG SECT	SERIAL NUMBER	SHEET	PROJ CODE	DWG SIZE	REV.
NOTES/REFERENCE DRAWINGS										DESCRIPTION : 48-HS-2658A/B P-48357 PUMP STOP/START		NO		NIM 5 4745 053DQ		3		A	
IN CASE OF DEVIATIONS MARKED UP PRINT SHALL BE SENT TO COASTAL DESIGN OFFICE																			



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48-RTU-0001

48-GB-2656

X-X

XX

10

XX

11

TBA-XX

XX

XX

LV-48-6064

(BY ELEC.)

RUNNING INDICATION

I/O TYPE : DI		
XX	CTRL	: XX
XX	RACK	: XX
	CARD TYPE	: XX
	SLOT NO.	: XX
	CHANNEL	: XX

48-RTU-0001

48-GB-2656

XX	10
XX	11

TBA-XX

$$\frac{1}{2}$$

XX
XX

LV-48-6064
(BY ELEC.)

RUNNING INDICATION

I/O TYPE : DI

XX	XX	CTRL	: XX
XX	XX	RACK	: XX
		CARD TYPE	: XX
		SLOT NO.	: XX
		CHANNEL	: XX


NO	NIM	5 4745 056DQ	3	A
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IN CASE OF DEVIATIONS MARKED UP PRINT SHALL BE SENT TO COASTAL DESIGN OFFICE

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48-RTU-0001



1. XX-SYSTEM DETAILS AWAITED.

2. FOR CABLE SCHEDULE REF.

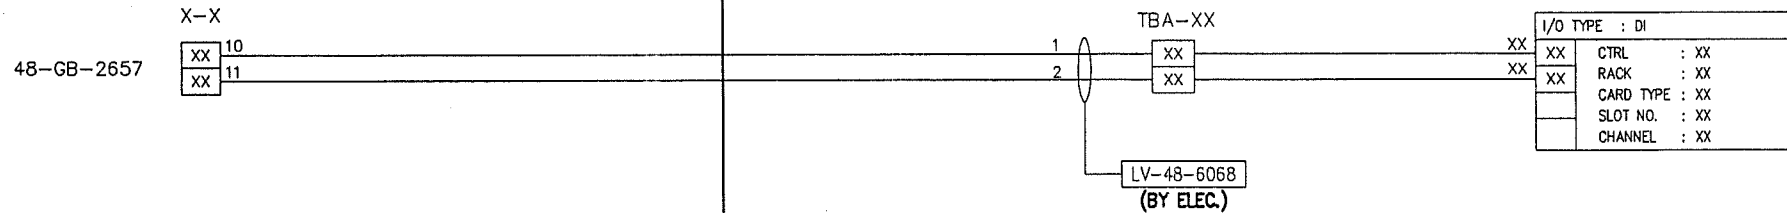DWG. No. 5-5044-XXX-DQ

REV

DATE

APPROVED
BY

DESCRIPTION

B.I.NO.

PROJ.ENG.

SPEC.ENG.

PDO APPROVAL

NOTES/REFERENCE DRAWINGS

MASTER DRAWING REVISION

IN CASE OF DEVIATIONS MARKED UP PRINT SHALL BE SENT TO COASTAL DESIGN OFFICE

AREA : NIMR

SUB AREA : NIMR SLUDGE PIT

NO. 05

DRWG. TYPE : INSTRUMENT LOOP DIAGRAMS

DESCRIPTION : 48-GB-2657

P-48358 RUNNING INDICATION

SCALE : 0 1 2 3 4 5 6 7 CAD DRAWING



شركة تنمية نفط عُمان

Petroleum Development Oman

DRWG	AREA CODE	ENG SECT	SERIAL NUMBER	SHEET	PROJ CODE	DWG SIZE	REV.
NO	NIM	5	4745	057DQ	3	A	





WorleyParsons-Arabian Industries (JV) Contract No.: C31/0606 Job No.: PAIP00405

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48-RTU-0001



										AREA : NIMR		SCALE : 0 1 2 3 4 5 6 7		CAD DRAWING					
										SUB AREA : NIMR SLUDGE PIT		NO. 05		 شركة تنمية نفط عمان Petroleum Development Oman					
1. XX-SYSTEM DETAILS AWAITED.		-								DRWG TYPE : INSTRUMENT LOOP DIAGRAMS									
2. FOR CABLE SCHEDULE REF.										DESCRIPTION : 48-GB-2658									
DWG. No. 5-5044-XXX-DQ		REV	DATE	APPROVED BY	DESCRIPTION	B.I.NO.	PROJ.ENG.	SPEC.ENG.	PDO APPROVAL	DESCRIPTION : P-48359 RUNNING INDICATION									
NOTES/REFERENCE DRAWINGS										MASTER DRAWING REVISION									
IN CASE OF DEVIATIONS MARKED UP PRINT SHALL BE SENT TO COASTAL DESIGN OFFICE																			

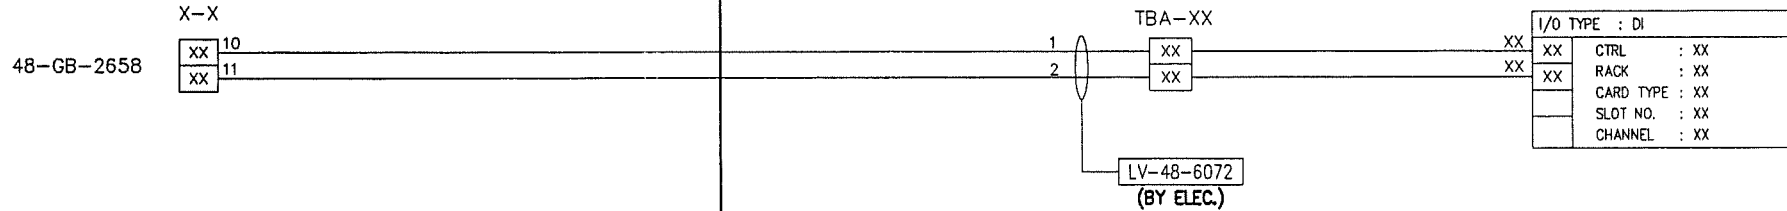

SUMMARY OF INSTRUMENT INSTALLATION MATERIALS

**APPROVED FOR
CONSTRUCTION**

REV	DATE	DRAWN BY	TEAM L.	J. ENG.	DESCRIPTION	WBS NO.	PROJ. ENG.	SIGNATURE
A	MAR.'11	KK			APPROVED FOR CONSTRUCTION	IN.09.011	OSE/23N	
O	DEC.'10	Mrp	PT	KDA	ISSUED FOR COMMENTS	IN.09.011	OSE/23N	
			CHECKED				P D O APPROVAL	


PROJECT DRAWING REVISION

IN CASE OF DEVIATIONS A MARKED UP PRINT SHALL BE SENT TO THE PROJECT ENGINEER

AREA : NIMR	SCALE : — 0 1 2 3 4 5 6 7 																
SUB AREA : NIMR SLUDGE PIT	CAD DRAWING شركة تنمية نفط عُمان Petroleum Development Oman																
DRWG. TYPE : INSTRUMENT INSTALLATION MATERIALS	<table border="1" style="width: 100%; border-collapse: collapse;"> <tr> <th>DRWG</th> <th>AREA CODE</th> <th>ENG SECT</th> <th>SERIAL NUMBER</th> <th>SHEET</th> <th>PROJ CODE</th> <th>DWG SIZE</th> <th>REV.</th> </tr> <tr> <td>NO</td> <td>NIM</td> <td>5</td> <td>4737</td> <td>001DQ</td> <td>4</td> <td>A</td> <td></td> </tr> </table>	DRWG	AREA CODE	ENG SECT	SERIAL NUMBER	SHEET	PROJ CODE	DWG SIZE	REV.	NO	NIM	5	4737	001DQ	4	A	
DRWG	AREA CODE	ENG SECT	SERIAL NUMBER	SHEET	PROJ CODE	DWG SIZE	REV.										
NO	NIM	5	4737	001DQ	4	A											
DESCRIPTION : COVER SHEET																	



[illegible]

AREA : NIMR		SCALE : — 0 1 2 3 4 5 6 7		CAD DRAWING					
SUB AREA : NIMR SLUDGE PIT		NO. 05		 شركة تنمية نفط عُمان Petroleum Development Oman					
DRWG.TYPE : INSTRUMENT INSTALLATION MATERIALS		DRWG	AREA CODE	ENG SECT	SERIAL NUMBER	SHEET	PROJ CODE	DWG SIZE	REV.
L : REVISION/INDEX SHEET		NO	NIM	5	4737	002 DQ	4	A	

MINIMUM PERCENT										
1	302	1000049076	70.13.04.025.1		HEAVY GAUGE CONDUIT	GALV. STEEL	25mm Dia	Mtrs	15.00	
2	L	1000047736	XX.XX.XX.XXX.X		CABLE XLPEI-MS-SWA-PVCS, BLACK		2 x2.5 mm2	Mtrs	250.00	
3	O	1000405299	XX.XX.XX.XXX.X		CABLE XLPEI-MS-SWA-PVCS, BLACK		2 x 2 x 1.13 mm	Mtrs	1000.00	
4	P	1000405297	XX.XX.XX.XXX.X	37.020	CBL ELEC ARM FIRE 24V 10PAIR 0.5MM2		10 x 2 x 0.8 mm	Mtrs	1300.00	BS5308, PART 1, TYPE2
5	R	-	XX.XX.XX.XXX.X		CABLE SHRINK ON SLEEVE (BLUE)	POLYOLEFIN	19 ~ 6 mm	-	NOTE-1	
6	X	1000048276	68.80.58.068.1		LOCK NUT	BRASS	M20	Pcs	30.00	
7	Y	1000048277	68.80.58.072.9	37.110	NUT LCK HEX BRASS MTR 25MM	BRASS	M25	Pcs	12.00	BS3643
8	AA	1000048319	68.80.58.730.1		CABLE GLAND 501/453-0	BRASS	M20	Pcs	53.00	
9	AB	1000048321	68.80.58.734.1	37.110	GLND CBL W/FLMPROF PVC SWA BS6121/25	BRASS	M25	Pcs	12.00	BS6121, TYPE E1 WF
10	AD	1000048327	68.80.58.802.9		GLND CBL ADPT 1/2"NPT 20MM	BRASS	1/2" NPTxM20	Pcs	8.00	
11	AP	1000211202	74.13.10.069.9		PIPE MET API 5L-B 40 DN50	CARBON STEEL	2"	Mtrs	17.00	
12	AQ	10000211233	74.13.12.103.9		PIPE MET API 5L-B 40 DN80	CARBON STEEL	3"	Pcs	3.00	
13	BP	1000106870	76.30.15.052.1		CAP PIPE BW WPB 80 DN50	CARBON STEEL	2"	Pcs	7.00	
14	BQ	1000053436	76.30.72.235.1		REC BW WPB 40 DN80X50	CARBON STEEL	3" x 2"	Pcs	3.00	
15	CC	1000055943	76.39.27.152.9	37.320	CONN TUBE CPT MAL 316 316 1/2X1/2"	AISI 316	1/2" NPT x 1/2" OD	Pcs	3.00	
16	CF	1000056003	76.39.67.040.1	37.320	PLUG TUB CPT 316 1/4IN	AISI 316	1/2" NPT	Pcs	22.00	
17	CJ	1000062573	78.39.02.121.1		FLAT BAR (6Mtrs LONG)	MILD STEEL	50 x 6 mm	Pcs	2.00	
18	CL	1000062605	78.43.30.108.1		STEEL PLATE (2000x1000x3)	MILD STEEL	3mm THICK	Pcs	1.00	
19	CM	1000062606	78.43.30.116.1		SHT PLT SLD MET 2000X1000 6MM	MILD STEEL	6 mm THK	Pcs	1.00	
20	CN	1000062608	78.43.30.124.1		SHT PLT SLD MET 2000X1000 10MM	MILD STEEL	10 mm THK	Pcs	1.00	
21	CQ	1000062629	78.47.01.352.1		ANGL MTL EQ STL 6M L50X50X6MM	MILD STEEL	50 x 50 x 6 mm	Pcs	3.00	
22	CR	1000051996	74.48.50.073.9	37.310	TUBE MET INSTR 1/2IN 18SWG 0.048IN	AISI 316	1/2" OD	Mtrs	5.00	
23	CY	1000062961	81.01.77.192.1		BLT HEX CL.8.8 COARSE 60MM M10	CARBON STEEL	M10 x 60 mm	Pcs	5.00	
24	DA	1000062977	81.26.25.133.1		BLT FND CL.4.6 MC 110MM M12	CARBON STEEL	M12 x 110 mm	Pcs	20.00	
25	DH	1000063819	81.41.77.018.1		NUT MTR CL.8 HEX ISO 724 M10	CARBON STEEL	M10	Pcs	5.00	
26	DU	1000062984	81.26.86.022.9		U-BOLT FOR 1/2" PIPE C/W NUTS & SPRING WASHER	AISI 316	M8	Pcs	16.00	
27	DV	1000062987	81.26.86.040.9		U-BOLT DN50	AISI 316	M10	Pcs	41.00	
28	EA	1000048204	68.80.50.942.9		CABLE TIES 12/BLACK		4x140 mm	-	NOTE-1	
29	EB	1000048103	68.79.02.004.9		CARRIER STRIP BLACK 7 DIGITS			-	NOTE-1	
30	EC	1000048115	68.79.02.004.9		CABLE MARKER TYPE KS		80	-	NOTE-1	
31	ED	1000062537	68.79.02.018.1		PLAIN STRIP		250x19x1.6 mm	-	NOTE-1	
32	EE	1000048112	68.79.02.018.1		CORE MARKER MODLE ZS-5		D=1.5-2.0 mm	-	NOTE-1	
33	EK	1000047959	68.76.54.004.9		CABLE CHANNEL 2M LONG	GI	100 mm WIDE	Mtrs	100.00	BS2989, GROUP2, CLASS-E
34	EO	1000047964	68.76.54.052.9		CABLE CHANNEL BEND 90 DEG.	GI	100 mm WIDE	Pcs	50.00	BS2989, GROUP2, CLASS-E
35	ES	1000047982	68.76.81.024.9		CABLE TILE		1000x244x6 mm	Pcs	250.00	
36					NAME PLATE (AS PER NAME PLATE DETAILS)		(TYPE A & B)	Pcs	NOTE-2	
37					PRESSURE TRANSMITTER	NOTE-3	-	Pcs	1.00	
38					PRESSURE GAUGE	NOTE-3	-	Pcs	9.00	
39					DIFFERENTIAL PRESSURE TRANSMITTER	NOTE-3	-	Pcs	3.00	
40					RADR LEVEL TRANSMITTER	NOTE-3	-	Pcs	4.00	
41					TEMPERATURE TRANSMITTER	NOTE-3	-	Pcs	1.00	
42					ULTRASONC FLOW METER (STRAP-ON TYPE)	NOTE-3	-	Pcs	1.00	
43					PNEUMATIC On-Off VALVE, RB, 6", 300#	NOTE-3	-	Pcs	1.00	
44		1000039291	60.04.69.302.9		PUSH BUTTON, EFS-110		-	Pcs	5.00	
45					HEAT DETECTOR	NOTE-3	-	Pcs	2.00	
46					LEVEL GAUGE	NOTE-3	-	Pcs	1.00	
47					HOOTER (AUDIBLE ALARM)	NOTE-3	-	Pcs	1.00	
48		1000047918	68.76.40.014.9		JUNCTION BOX EEx II T6		20 TERMINALS	Pcs	3.00	
50					RTU WITH RADIO MODULE	NOTE-4				
51					GATEWAY	NOTE-4				
NOTE -1 : QUANTITIES TO BE DETERMINED AND MATERIAL TO BE SUPPLIED BY CONSTRUCTION CONTRACTOR.										
NOTE -2 : REFER DRAWING No. NIM -5-4739-DQ-4										
NOTE -3 : AS PER SPECIFICATION PREPARED UNDER THIS PROJECT.										
NOTE -4 : FREE ISSUE BY PDO										

INSTRUMENT ENGINEERING DATA SHEETS


NIMR SLUDGE PIT AREA

Vendor details to be provided

15/4/2011

APPROVED FOR
CONSTRUCTION

THIS COMPLETE DRAWING IS NEW
AND FORMS PART OF SCOPE OF
PROJECT WBS. No. NIM.IN.09.011

A	MAR.'11	KK	PT	KDA	APPROVED FOR CONSTRUCTION	IN.09.011	OSE/23N	
0	DEC.'10	Hilal	PT	KDA	ISSUED FOR COMMENTS	IN.09.011	OSE/23N	IH
REV	DATE	DRAWN BY	TEAM LEAD	CHECKED	DESCRIPTION	B.I. NO	PROJ. ENG.	SIGNATURE
						P D O APPROVAL		
PROJECT DRAWING REVISION								
IN CASE OF DEVIATIONS A MARKED UP PRINT SHALL BE SENT TO THE PROJECT ENGINEER								
AREA : NIMR						SCALE : 0 1 2 3 4 5 6 7 CAD DRAWING		
SUB AREA : NIMR SLUDGE PIT						NO. 05		
DRWG TYPE : INSTR. ENGINEERING DATA SHEET						 شركة تنمية نفط عمان Petroleum Development Oman		
DESCRIPTION : COVER SHEET						DRWG AREA ENG SERIAL SHEET PROJ DWG REV. NO NIM 5 4743000DQ 3 A		

NOTES/REFERENCE DRAWINGS
IN CASE OF DEVIATIONS MARKED UP PRINT SHALL BE SENT TO COASTAL DESIGN OFFICE

MASTER DRAWING REVISION



Group 30								Group 31				Group 32				Group 33				Group 3				Group 35								roup 36	
General instrumentation								Analyser and sundry instruments				Flow elements 1)		Flow instruments		Level instruments		Pressure gauges		Pressure instruments		Multipoint temp.indicators		Temperature instruments		Local temp. indicators		Thermowells		Control valves			
Sheet	Revision	Sheet	Revision	Sheet	Revision	Sheet	Revision	Sheet	Revision	Sheet	Revision	Sheet	Revision	Sheet	Revision	Sheet	Revision	Sheet	Revision	Sheet	Revision	Sheet	Revision	Sheet	Revision	Sheet	Revision	Sheet	Revision	Sheet	Revision		
000	O A	050		100		150	O A	200		250		300		350	O A	400	O A	500	O A	550	O A	600		625	O A	650		675		700			
001	O A	051		101		151		201		251		301		351	O A	401		501	O A	551	O A	601		626	O A	651		676		701			
002		052		102		152		202		252		302		352		402		502		552		602		627		652		677		702			
003		053		103		153		203		253		303		353		403		503		553		603		628		653		678		703			
004		054		104		154		204		254		304		354		404		504		554		604		629		654		679		704			
005		055		105		155		205		255		305		355		405		505		555		605		630		655		680		705			
006		056		106		156		206		256		306		356		406		506		556		606		631		656		681		706			
007		057		107		157		207		257		307		357		407		507		557		607		632		657		682		707			
008		058		108		158		208		258		308		358		408		508		558		608		633		658		683		708			
009		059		109		159		209		259		309		359		409		509		559		609		634		659		684		709			
010	O A	060		110		160		210		260		310		360		410		510		560		610		635		660		685		710			
011		061		111		161		211		261		311		361		411		511		561		611		636		661		686		711			
012		062		112		162		212		262		312		362		412		512		562		612		637		662		687		712			
013		063		113		163		213		263		313		363		413		513		563		613		638		663		688		713			
014		064		114		164		214		264		314		364		414		514		564		614		639		664		689		714			
015		065		115		165		215		265		315		365		415		515		565		615		640		665		690		715			
016		066		116		166		216		266		316		366		416		516		566		616		641		666		691		716			
017		067		117		167		217		267		317		367		417		517		567		617		642		667		692		717			
018		068		118		168		218		268		318		368		418		518		568		618		643		668		693		718			
019		069		119		169		219		269		319		369		419		519		569		619		644		669		694		719			
020		070		120		170		220		270		320		370		420		520		570		620		645		670		695		720			
021		071		121		171		221		271		321		371		421		521		571		621		646		671		696		721			
022		072		122		172		222		272		322		372		422		522		572		622		647		672		697		722			
023		073		123		173		223		273		323		373		423		523		573		623		648		673		698		723			
024		074		124		174		224		274		324		374		424		524		574		624		649		674		699		724			
025		075		125		175		225		275		325		375		425		525		575													
026		076		126		176		226		276		326		376		426		526		576													
027		077		127		177		227		277		327		377		427		527		577													
028		078		128		178		228		278		328		378		428		528		578													
029		079		129		179		229		279		329		379		429		529		579													
030		080		130		180		230		280		330		380		430		530		580													
031		081		131		181		231		281		331		381		431		531		581													
032		082		132		182		232		282		332		382		432		532		582													
033		083		133		183		233		283		333		383		433		533		583													
034		084		134		184		234		284		334		384		434		534		584													
035		085		135		185		235		285		335		385		435		535		585													
036		086		136		186		236		286		336		386		436		536		586													
037		087		137		187		237		287		337		387		437		537		587													
038		088		138		188		238		288		338		388		438		538		588													
039		089		139		189		239		289		339		389		439		539		589													
040		090		140		190		240		290		340		390		440		540		590													
041		091		141		191		241		291		341		391		441		541		591													
042		092		142		192		242		292		342		392		442		542		592													
043		093		143		193		243		293		343		393		443		543		593													
044		094		144		194		244		294		344		394		444		544		594													
045		095		145		195		245		295		345		395		445		545		595													
046		096		146		196		246		296		346		396		446		546		596													
047		097		147		197		247		297		347		397		447		547		597													
048		098		148		198		248		298		348		398		448		548		598													
049		099		149		199		249		299		349		399		449		549		599													

Data sheet ' MISCELLANEOUS INSTRUMENTS							
Tag No.	Service	Miscellaneous instrument Description	Requisition Sub-gr Ser. No FP/	Manufacturer	Description Model Type	Board or Local	Notes
48-							Tag No. 48- PEFS No. NIM-1
HS-2219	PUMP P-48357	PUSH BUTTON	-	-	-	L	1)
	LOCAL START/STOP						HS-2219 2638-001-DQ
HS-2658	PUMP P-48357	RESET PUSH BUTTON	-	-	-	L	1)
	LOCAL RESET						HS-2658 2638-001-DQ
HS-2220	PUMP P-48358	PUSH BUTTON	-	-	-	L	1)
	LOCAL START/STOP						HS-2220 2638-001-DQ
HS-2660	PUMP P-48358	RESET PUSH BUTTON	-	-	-	L	1)
	LOCAL RESET						HS-2660 2638-001-DQ
HS-2661	PUMP P-48359	PUSH BUTTON	-	-	-	L	1)
	LOCAL START/STOP						HS-2661 2640-001-DQ
HS-2662	PUMP P-48360	PUSH BUTTON	-	-	-	L	1)
	LOCAL START/STOP						HS-2662 2640-001-DQ
HS-2663	PUMP P-48359	RESET PUSH BUTTON	-	-	-	L	1)
	LOCAL RESET						HS-2663 2640-001-DQ
HS-2664	PUMP P-48360	RESET PUSH BUTTON	-	-	-	L	1)
	LOCAL RESET						HS-2664 2640-001-DQ

1) PROCUREMENT NOT BY WPAI, HENCE VENDOR DETAILS NOT AVAILABLE.
2) BY CHEMICAL SKID VENDOR.

AREA : NIMR


SUB AREA : NIMR SLUDGE PIT

DRWG TYPE : INSTR. ENGINEERING DATA SHEET

DESCRIPTION : MISCELLANEOUS INSTRUMENTS

SCALE : 0 1 2 3 4 5 6 7

CAD DRAWING



شركة تنمية نفط عمان
Petroleum Development Oman

DRWG

AREA CODE

ENG SECT

SERIAL NUMBER

SHEET

PROJ CODE

DWG SIZE

REV.

NO

NIM

5

4743


010

DQ

3

A

NOTES/REFERENCE DRAWINGS
IN CASE OF DEVIATIONS MARKED UP PRINT SHALL BE SENT TO COASTAL DESIGN OFFICE

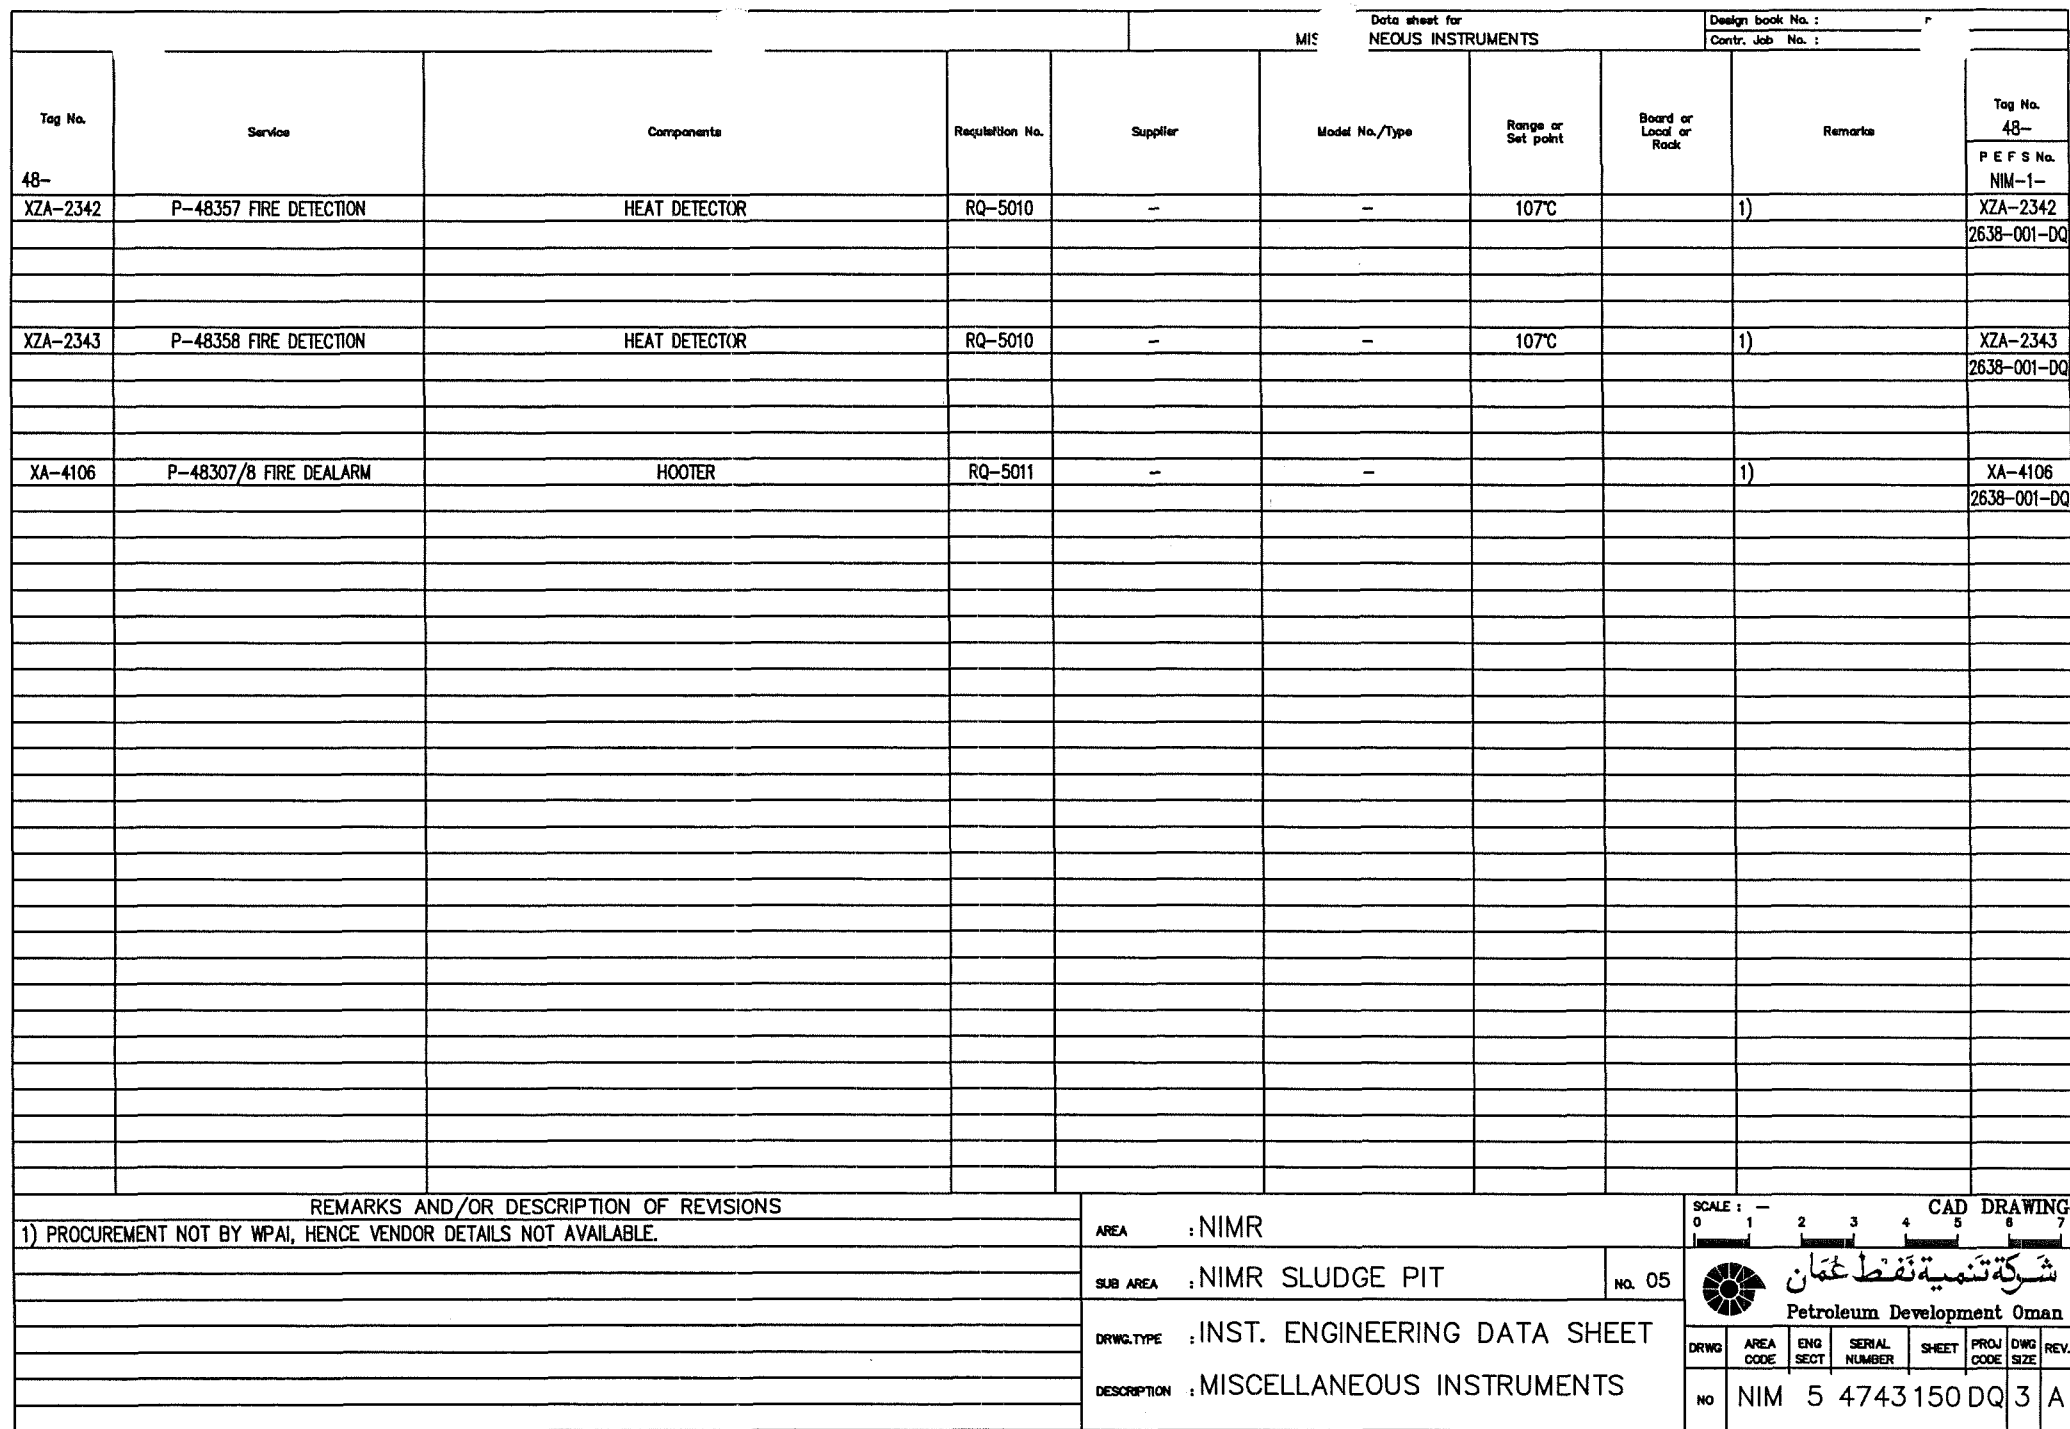

Data sheet for PRESSURE GAUGES												Design book No. : _____		Contr. Job No. : _____						
Tag No.	Service	Fluid	Gas or vapour MW Liquid sp. gr. at work temp.	Normal temp. °C	Operating Con.			Static pressure Kpa(a)	ΔP Kpa	Components e.g. Transmitter Rec. Controller etc.	Regulation sub-group serial numbers	Manufacturer	Description Type	Range Kpa(g) or ΔP kPa	Primary element		Control actions P.I.D	Board or local or Aux. room	Remarks	Tag No.
															Type protected non-protected	Material				
					Min.	Norm.	Max.													
48-																				48-
PG-1530	PUMP P-48357	SLUDGE OIL	913-	25-	0	3935	4500	GUAGE						0-6000	BOURDON			L	1)	PG-1530
	DISCHARGE PRESSURE		1000	50																2638-001
																				-DQ
PG-1531	PUMP P-48358	SLUDGE OIL	913-	25-	0	3935	4500	GUAGE						0-6000	BOURDON			L	1)	PG-1531
	DISCHARGE PRESSURE		1000	50																2638-001
																				-DQ
PG-1532	COMMON DISCHARGE	SLUDGE OIL	913-	25-	0	3935	4500	GUAGE						0-6000	BOURDON			L	1)	PG-1532
	LINE PRESSURE		1000	50																2639-001
																				-DQ
PG-1538	A-48305 PIG LAUNCHER	SLUDGE OIL	913-	25-	0	0	4500	GUAGE						0-6000	BOURDON			L	1)	PG-1538
	PRESSURE		1000	50																2639-001
																				-DQ
PG-1539	A-48305 PIG	SLUDGE OIL	913-	25-	0	0	4500	GUAGE						0-6000	BOURDON			L	1)	PG-1539
	LAUNCHER PRESS.		1000	50																2639-001
																				-DQ
PG-1534	OXYGEN SCAVENGER	OXYGEN						GUAGE							BOURDON			L	1), 2)	PG-1534
	PUMP P-48359 DISCH.	SCAVENGER																		2640-001
	PRESSURE																			-DQ
PG-1535	OXYGEN SCAVENGER	OXYGEN						GUAGE										L	1), 2)	PG-1535
	PUMP P-48360 DISCH.	SCAVENGER													BOURDON					2640-001
	PRESSURE																			-DQ



[illegible]

INSTRUMENT NAMEPLATES

NIMR WASTE MANAGEMENT COMPLEX

NIMR SLUDGE PIT

NOTES:

- 1) THE NAME PLATES TO BE SUPPLIED BY CONTRACTOR AS PER DETAILS PROVIDED & TO BE INSTALLED AT SITE.

APPROVED FOR
CONSTRUCTION

A	MAR.'11	KK			APPROVED FOR CONSTRUCTION	IN.09.011	OSE/23N	
O	DEC.'10	Mrp	PT	KDA	ISSUED FOR COMMENTS	IN.09.011	OSE/23N	IH
REV	DATE	DRAWN BY	TEAML.	J.ENG.	DESCRIPTION	B.I. NO	PROJ. ENG.	SIGNATURE
			CHECKED				P D O APPROVAL	


PROJECT DRAWING REVISION

IN CASE OF DEVIATIONS A MARKED UP PRINT SHALL BE SENT TO THE PROJECT ENGINEER

AREA : NIMR	SCALE : — 0 1 2 3 4 5 6 7
SUB AREA : NIMR SLUDGE PIT	 شركة تنمية نفط عُمان Petroleum Development Oman
DRWG. TYPE : INSTRUMENT NAME PLATES	
DESCRIPTION : COVER SHEET	


DRWG	AREA CODE	ENG SECT	SERIAL NUMBER	SHEET	PROJ CODE	DWG SIZE	REV.
NO	NIM 5 4739 001DQ			4	A		



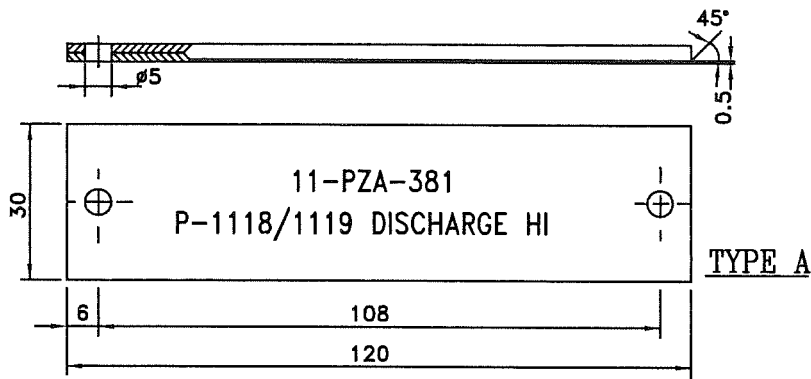

Engraving : Maximum 2 lines-25 characters per line letter height 5 mm.
First line to specify instrument tag number only.


Material : Laminated Plastic, approx. 3mm thick.

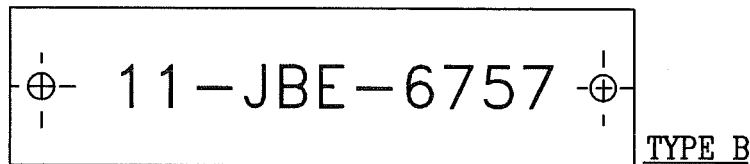

Engraving : Tag number only - 13 characters - letter height 10 mm.


Material : Laminated Plastic, approx. 3mm thick.

NOTE : Dimensions identical to type A

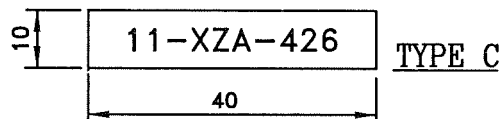


Engraving : Tag number only - 15 characters - letter height 3 mm.

Material : Laminated Plastic, approx. 2mm thick.

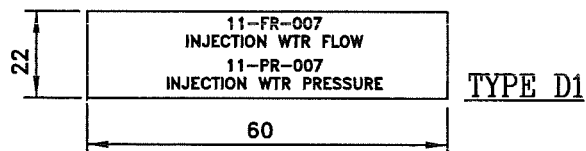


Engraving : Maximum 4 lines 22 characters per line letter height 3 mm.
First line to specify instrument tag number only.

Material : Laminated Plastic, approx. 2mm thick.

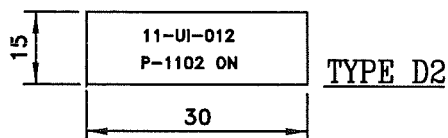

Engraving : Maximum 2 lines 10 characters per line letter height 3 mm.
First line to specify instrument tag number only.


Material : Laminated Plastic, approx. 2mm thick.

AREA : NIMR		SCALE : — 0 1 2 3 4 5 6 7		CAD DRAWING													
SUB AREA : NIMR SLUDGE PIT		No. 05		 شركة تنمية نفط عُمان Petroleum Development Oman													
DRWG.TYPE : INSTRUMENT NAME PLATES		DRWG		AREA CODE		ENG SECT		SERIAL NUMBER		SHEET		PROJ CODE		DWG SIZE		REV.	
DESCRIPTION : TYPES OF NAMEPLATES		NO		NIM		5		4739003DQ		4						A	



Issue	Qty	Text on nameplate																									Type A Colour Note 1			Notes
		1			5					10					15					20					25					
O	1									4	8	-	L	I	A	-	1	4	4	7							W	B	W	NOTE-1
		S	L	U	D	G	E			P	I	T			A	-	4	8	3	0	7					L				
O	1								4	8	-	L	I	Z	A	-	1	4	4	8							R	B	R	NOTE-3
		S	L	U	D	G	E			P	I	T			A	-	4	8	3	0	7					L				
O	1								4	8	-	L	I	Z	A	-	1	4	5	1							R	B	R	NOTE-3
		S	L	U	D	G	E			P	I	T			A	-	4	8	3	0	8					L				
O	1								4	8	-	L	I	A	-	1	4	5	2								W	B	W	NOTE-1
		S	L	U	D	G	E			P	I	T			A	-	4	8	3	0	8					L				
O	1								4	8	-	T	I	A	-	1	4	6	8								W	B	W	NOTE-1
			P	U	M	P	S			C	O	M	M	O	N			D	I	S	C	.	T	E	M	P				
O	1								4	8	-	P	I	Z	A	-	1	5	1	6							R	B	R	NOTE-3
		P	U	M	P	S			C	O	M	M	O	N			D	I	S	C	H	.	P	R	E	S				
O	1								4	8	-	F	I	-	1	4	1	4									W	B	W	NOTE-1
			P	U	M	P	S			C	O	M	M	O	N			D	I	S	C	.	F	L	O	W				
O	1								4	8	-	P	D	I	A	-	1	5	2	0							W	B	W	NOTE-1
		D	P		A	C	R	O	S	S			F	I	L	T	E	R		S	-	4	8	3	6	2				
O	1								4	8	-	P	D	I	A	-	1	5	2	1							W	B	W	NOTE-1
		D	P		A	C	R	O	S	S			F	I	L	T	E	R		S	-	4	8	3	6	3				
O	1								4	8	-	X	Z	A	-	2	3	4	2								R	B	R	NOTE-3
				H	E	A	T			D	E	T	E	C	T	O	R		P	-	4	8	3	5	7					
O	1								4	8	-	X	Z	A	-	2	3	4	3								R	B	R	NOTE-3
				H	E	A	T			D	E	T	E	C	T	O	R		P	-	4	8	3	5	8					
O	1								4	8	-	H	S	-	2	2	1	9	A								W	B	W	NOTE-1
					P	-	4	8	3	5	7			L	O	C	A	L		S	T	A	R	T						
O	1								4	8	-	H	S	-	2	2	1	9	B								W	B	W	NOTE-1
					P	-	4	8	3	5	7			L	O	C	A	L		S	T	O	P							
O	1								4	8	-	H	S	-	2	6	5	8									W	B	W	NOTE-1
					P	-	4	8	3	5	7			L	O	C	A	L		R	E	S	E	T						

NOTES: 1) Colour white/black/white unless otherwise indicated.
2) Colour red/white/red unless otherwise indicated.
3) Colour red/Black/red unless otherwise indicated.


AREA : NIMR		SCALE : — 0 1 2 3 4 5 6 7		CAD DRAWING	
SUB AREA : NIMR SLUDGE PIT		no. 05		 شركة تنمية نفط عمان Petroleum Development Oman	
DRWG. TYPE : INSTRUMENT NAME PLATES		DRWG		AREA CODE	
DESCRIPTION : ENGRAVING SCHEDULE (TYPE-A)		ENG SECT		SERIAL NUMBER	
		SHEET		PROJ CODE	
		DWG SIZE		REV.	
		NO		NIM 5 4739 004DQ 4 A	



Issue	Qty	Text on nameplate																									Type A Colour Note 1			Notes	
		1				5					10					15					20					25					
O	1									4	8	-	H	S	-	2	6	6	1	A								W	B	W	NOTE-1
						P	-	4	8	3	5	9		L	O	C	A	L		S	T	A	R	T							
O	1									4	8	-	H	S	-	2	6	6	1	B								W	B	W	NOTE-1
						P	-	4	8	3	5	9		L	O	C	A	L		S	T	O	P								
O	1									4	8	-	H	S	-	2	6	6	2	A								W	B	W	NOTE-1
						P	-	4	8	3	6	0		L	O	C	A	L		S	T	A	R	T							
O	1									4	8	-	H	S	-	2	6	6	2	B								W	B	W	NOTE-1
						P	-	4	8	3	6	0		L	O	C	A	L		S	T	O	P								
O	1									4	8	-	H	S	-	2	6	6	3									W	B	W	NOTE-1
						P	-	4	8	3	5	9		L	O	C	A	L		R	E	S	E	T							
O	1									4	8	-	H	S	-	2	6	6	4									W	B	W	NOTE-1
						P	-	4	8	3	6	0		L	O	C	A	L		R	E	S	E	T							
O	1									4	8	-	L	I	Z	A	-	1	4	5	0							R	B	R	NOTE-3
		O	X	Y	.	S	C	A	V	.	D	O	S	I	N	G		T	A	N	K		L	V	L	.					
O	1									4	8	-	L	I	A	-	1	4	4	9								W	B	W	NOTE-1
		O	X	Y	.	S	C	A	V	.	D	O	S	I	N	G		T	A	N	K		L	V	L	.					
O	1									4	8	-	P	I	Z	A	-	1	5	1	8							R	B	R	NOTE-3
		O	X	Y	.	S	C	A	V	.	P	4	8	3	5	9		D	I	P	H	.	F	A	I	L					
O	1									4	8	-	P	I	Z	A	-	1	5	1	9							R	B	R	NOTE-3
		O	X	Y	.	S	C	A	V	.	P	4	8	3	6	0		D	I	P	H	.	F	A	I	L					
O	1									4	8	-	P	I	-	1	5	2	2									W	B	W	NOTE-1
		O	X	Y	.	S	C	A	V	.	P	U	M	P		D	I	S	C	.	P	R	E	S	S	.					
O	1									4	8	-	F	I	-	1	4	1	5									W	B	W	NOTE-1
			O	X	Y	.	S	C	A	V	.	P	U	M	P		D	I	S	C	.	F	L	O	W						

NOTES: 1) Colour white/black/white unless otherwise indicated.
2) Colour red/white/red unless otherwise indicated.
3) Colour red/black/red unless otherwise indicated.


A-48309 (VENDOR PACKAGE)

AREA : NIMR		SCALE : — 0 1 2 3 4 5 6 7		CAD DRAWING					
SUB AREA : NIMR SLUDGE PIT		No. 05		 شركة تنمية نفط عُمان Petroleum Development Oman					
DRWG.TYPE : INSTRUMENT NAME PLATES									
DESCRIPTION : ENGRAVING SCHEDULE (TYPE-A)		DRWG	AREA CODE	ENG SECT	SERIAL NUMBER	SHEET	PROJ CODE	DWG SIZE	REV.
		NO	NIM	5	4739	006DQ	4	A	



Issue	Qty	Text on nameplate																									Type A Colour Note 1			Notes	
		1				5					10					15					20					25					
O	1									4	8	-	P	G	-	1	5	3	0									W	B	W	NOTE-1
		P	U	M	P		P	-	4	8	3	5	7		D	I	S	C	.	P	R	E	S	S	.						
O	1									4	8	-	P	G	-	1	5	3	1									W	B	W	NOTE-1
		P	U	M	P		P	-	4	8	3	5	8		D	I	S	C	.	P	R	E	S	S	.						
O	1									4	8	-	P	G	-	1	5	3	2									W	B	W	NOTE-1
		C	O	M	M	O	N		D	I	S	C	.	L	I	N	E		P	R	E	S	S	U	R	E					
O	1									4	8	-	P	G	-	1	5	3	3									W	B	W	NOTE-1
		P	R	E	S	S	U	R	E		A	T		P	I	G		R	E	C	E	I	V	E	R						
O	1									4	8	-	P	G	-	1	5	3	4									W	B	W	NOTE-1
		P	U	M	P		P	-	4	8	3	5	9		D	I	S	C	.	P	R	E	S	S	.						
O	1									4	8	-	P	G	-	1	5	3	5									W	B	W	NOTE-1
		P	U	M	P		P	-	4	8	3	6	0		D	I	S	C	.	P	R	E	S	S	.						
O	1									4	8	-	P	G	-	1	5	3	8									W	B	W	NOTE-1
		A	-	4	8	3	0	5		P	I	G		L	A	U	N	C	H	E	R		P	R	E	S					
O	1									4	8	-	P	G	-	1	5	3	9									W	B	W	NOTE-1
		A	-	4	8	3	0	5		P	I	G		L	A	U	N	C	H	E	R		P	R	E	S					
O	1									4	8	-	P	G	-	1	5	4	0									W	B	W	NOTE-1
		A	-	4	8	3	0	6		P	I	G		R	E	C	E	I	V	E	R		P	R	E	S					
O	1									4	8	-	P	G	-	1	5	4	1									W	B	W	NOTE-1
		A	-	4	8	3	0	6		P	I	G		R	E	C	E	I	V	E	R		P	R	E	S					
O	1									4	8	-	P	G	-	1	5	4	2									W	B	W	NOTE-1
		T	-	4	8	0	7		I	N	L	E	T		L	I	N	E		P	R	E	S	S	.						
O	1									4	8	-	P	G	-	1	5	4	5									W	B	W	NOTE-1
		T	-	4	8	0	7		B	Y	P	A	S	S		L	I	N	E		P	R	E	S	S	.					

NOTES: 1) Colour white/black/white unless otherwise indicated.
2) Colour red/white/red unless otherwise indicated.
3) Colour red/black/red unless otherwise indicated.

AREA : NIMR		SCALE : — 0 1 2 3 4 5 6 7		CAD DRAWING	
SUB AREA : NIMR SLUDGE PIT		NO. 05		 شركة تنمية نفط عُمان Petroleum Development Oman	
DRWG. TYPE : INSTRUMENT NAME PLATES		DRWG		AREA CODE	
DESCRIPTION : ENGRAVING SCHEDULE (TYPE-A)		ENG SECT		SERIAL NUMBER	
		SHEET		PROJ CODE	
		DWG SIZE		REV.	
		NO		NIM 5 4739 007DQ 4 A	



[illegible]

NOTES: 1) Colour white/black/white unless otherwise indicated.
2) Colour red/black/red.

SCALE : — CAD DRAWING



I.C.T.D
JUNCTION BOXES
NIMR SLUDGE PIT

THIS COMPLETE DRAWING IS NEW AND
FORMS PART OF SCOPE OF PROJECT 'DQ'
WBS No. NIM.IN.09.011

APPROVED FOR
CONSTRUCTION

A	MAR.'11	KK			APPROVED FOR CONSTRUCTION	IN.09.011	OSE/23N	
O	DEC.'10	Mrp	PT	KDA	ISSUED FOR COMMENTS	IN.09.011	OSE/23N	IH
REV	DATE	DRAWN BY	TEAML	J.ENG.	DESCRIPTION	WBS No.	PROJ. ENG.	SIGNATURE
			CHECKED				P D O APPROVAL	


PROJECT DRAWING REVISION

IN CASE OF DEVIATIONS A MARKED UP PRINT SHALL BE SENT TO THE PROJECT ENGINEER

AREA : NIMR	SCALE : — 																
SUB AREA : NIMR SLUDGE PIT	CAD DRAWING شركة تنمية نفط عمان Petroleum Development Oman																
DRWG. TYPE : CABLE TERMINATION DETAILS	<table border="1" style="width: 100%; border-collapse: collapse;"> <tr> <th>DRWG</th><th>AREA CODE</th><th>ENG SECT</th><th>SERIAL NUMBER</th><th>SHEET</th><th>PROJ CODE</th><th>DWG SIZE</th><th>REV.</th></tr> <tr> <td>NO</td><td>NIM</td><td>5</td><td>4742</td><td>001</td><td>DQ</td><td>4</td><td>A</td></tr> </table>	DRWG	AREA CODE	ENG SECT	SERIAL NUMBER	SHEET	PROJ CODE	DWG SIZE	REV.	NO	NIM	5	4742	001	DQ	4	A
DRWG	AREA CODE	ENG SECT	SERIAL NUMBER	SHEET	PROJ CODE	DWG SIZE	REV.										
NO	NIM	5	4742	001	DQ	4	A										
DESCRIPTION : COVER SHEET																	



DESCRIPTION	SHEET	REV. 0	REV. G	REV. H	REV. I	REV. O	REV. A
COVER SHEET	001	DEC.'10	MAR.'11				
REVISION/INDEX SHEET	002	DEC.'10	MAR.'11				
SPARE	003						
48-JBE-6907	004	DEC.'10	MAR.'11				
48-JBE-6908	005	DEC.'10	MAR.'11				
48-JBE-6909	006	DEC.'10	MAR.'11				
48-JBE-6910	007	DEC.'10	MAR.'11				
48-JBE-6911	008	DEC.'10	MAR.'11				
	009						
	010						
	011						
	012						
	013						
	014						
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	036						


AREA : NIMR		SCALE : — 0 1 2 3 4 5 6 7		CAD DRAWING																	
SUB AREA : NIMR SLUDGE PIT		NO. 05		 شركة تنمية نفط عُمان Petroleum Development Oman																	
DRWG. TYPE : CABLE TERMINATION DETAILS		<table border="1"> <tr> <th>DRWG</th> <th>AREA CODE</th> <th>ENG SECT</th> <th>SERIAL NUMBER</th> <th>SHEET</th> <th>PROJ CODE</th> <th>DWG SIZE</th> <th>REV.</th> </tr> <tr> <td>NO</td> <td>NIM</td> <td>5</td> <td>4742</td> <td>002</td> <td>DQ</td> <td>4</td> <td>A</td> </tr> </table>				DRWG	AREA CODE	ENG SECT	SERIAL NUMBER	SHEET	PROJ CODE	DWG SIZE	REV.	NO	NIM	5	4742	002	DQ	4	A
DRWG	AREA CODE	ENG SECT	SERIAL NUMBER	SHEET	PROJ CODE	DWG SIZE	REV.														
NO	NIM	5	4742	002	DQ	4	A														
DESCRIPTION : REVISION/INDEX SHEET																					



TAG. No. UNIT:48	EQUIPMENT CONNECTION	EXTN. CABLE No.		J.B. TERM'L	MULTICORE CABLE No.	
		SIZE: TYPE:	CORE		TYPE, SIZE AND CONNECTED TO	CORE
LIA-1447	+	E-2706	2x2x1.13mm XLPEI-MS-SWA-PVCS	BK+B	48-E-6907 XLPEI-MS-SWA-PVCS 10x2x0.8MM 48-RTU-0001	1BK
				G+BN		1B
LIZA-1448	+	E-2707	2x2x1.13mm XLPEI-MS-SWA-PVCS	BK+B		2BK
				G+BN		2G
TIA-1468	+	E-2708	2x2x1.13mm XLPEI-MS-SWA-PVCS	BK+B		3B
				G+BN		3G
FI-1414	+	E-2709	2x2x1.13mm XLPEI-MS-SWA-PVCS	BK+B		4BK
				G+BN		4BN
SPARE						5B
						5BN
						6G
						6BN
						7BK
						7W
						8B
						8W
						9G
						9W
						10BN
						10W

NOTE:

1. SCREENS TO BE CONNECTED TO AN ISOLATED EARTH BAR


AREA : NIMR		SCALE : — 0 1 2 3 4 5 6 7		CAD DRAWING	
SUB AREA : NIMR SLUDGE PIT		NO. 05		 شركة تنمية نفط عُمان Petroleum Development Oman	
DRWG. TYPE : CABLE TERMINATION DETAILS					
DESCRIPTION : 48-JBE-6907					
DRWG	AREA CODE	ENG SECT	SERIAL NUMBER	SHEET	PROJ CODE
NO	NIM	5	4742004	DQ	4
					REV.
					A



TAG. No. UNIT:48	EQUIPMENT CONNECTION	EXTN. CABLE No.		J.B. TERM'L	MULTICORE CABLE No.	
		SIZE: TYPE:	CORE		TYPE, SIZE AND CONNECTED TO	CORE
LIA-1451	+	E-2710	2x2x1.13mm XLPEI-MS-SWA-PVCS	BK+B	48-E-6908 XLPEI-MS-SWA-PVCS 10x2x0.8MM 48-RTU-0001	1BK
				G+BN		1B
LIA-1452	+	E-2711	2x2x1.13mm XLPEI-MS-SWA-PVCS	BK+B		2BK
				G+BN		2G
PIZA-1516	+	E-2712	2x2x1.13mm XLPEI-MS-SWA-PVCS	BK+B		3B
				G+BN		3G
PDIA-1520	+	E-2713	2x2x1.13mm XLPEI-MS-SWA-PVCS	BK+B		4BK
				G+BN		4BN
PDIA-1521	+	E-2714	2x2x1.13mm XLPEI-MS-SWA-PVCS	BK+B		5B
				G+BN		5BN
SPARE						6G
						6BN
						7BK
						7W
						8B
						8W
						9G
						9W
						10BN
						10W

NOTE:

1. SCREENS TO BE CONNECTED TO AN ISOLATED EARTH BAR


AREA : NIMR		SCALE : — 0 1 2 3 4 5 6 7		CAD DRAWING							
SUB AREA : NIMR SLUDGE PIT		NO. 05		 شركة تنمية نفط عُمان Petroleum Development Oman							
DRWG. TYPE : CABLE TERMINATION DETAILS				DRWG	AREA CODE	ENG SECT	SERIAL NUMBER	SHEET	PROJ CODE	DWG SIZE	REV.
DESCRIPTION : 48-JBE-6908				NO	NIM	5	4742	005	DQ	4	A



TAG. No. UNIT:48	EQUIPMENT CONNECTION	EXTN. CABLE No.		J.B. TERM'L	MULTICORE CABLE No.	
		SIZE: TYPE:	CORE		TYPE, SIZE AND CONNECTED TO	CORE
Y7A-2342	+	E-2715 2x2x1.13mm XLPEI-MS-SWA-PVCS	BK+B G+BN	1	48-E-6909 XLPEI-MS-SWA-PVCS 10x2x0.8MM 48-RTU-0001	1BK
				2		1B
XZA-2343	+	E-2716 2x2x1.13mm XLPEI-MS-SWA-PVCS	BK+B G+BN	3		2BK
				4		2G
HS-2219A	+	E-2717A 2x2x1.13mm XLPEI-MS-SWA-PVCS	BK+B G+BN	5		3B
				6		3G
HS-2219B	+	E-2717B 2x2x1.13mm XLPEI-MS-SWA-PVCS	BK+B G+BN	7		4BK
				8		4BN
HS-2658	+	E-2718 2x2x1.13mm XLPEI-MS-SWA-PVCS	BK+B G+BN	9		5B
				10		5BN
HS-2220A	+	E-2719A 2x2x1.13mm XLPEI-MS-SWA-PVCS	BK+B G+BN	11		6G
				12		6BN
HS-2220B	+	E-2719B 2x2x1.13mm XLPEI-MS-SWA-PVCS	BK+B G+BN	13		7BK
				14		7W
HS-2660	+	E-2720 2x2x1.13mm XLPEI-MS-SWA-PVCS	BK+B G+BN	15		8B
				16		8W
CPARE				17		9G
				18		9W
				19		10BN
				20		10W

NOTE:

1. SCREENS TO BE CONNECTED TO AN ISOLATED EARTH BAR


AREA : NIMR		SCALE : — 0 1 2 3 4 5 6 7		CAD DRAWING							
SUB AREA : NIMR SLUDGE PIT		NO. 05		 شركة تنمية نفط عُمان Petroleum Development Oman							
DRWG. TYPE : CABLE TERMINATION DETAILS		DESCRIPTION : 48-JBE-6909		DRWG	AREA CODE	ENG SECT	SERIAL NUMBER	SHEET	PROJ CODE	DWG SIZE	REV.
				NO	NIM 5 4742 006 DQ				4	A	



TAG. No. UNIT:48	EQUIPMENT CONNECTION	EXTN. CABLE No.		J.B. TERM'L	MULTICORE CABLE No.	
		SIZE: TYPE:	CORE		TYPE, SIZE AND CONNECTED TO	CORE
HS-2661A	+	E-2723A 2x2x1.13mm XLPEI-MS-SWA-PVCS	BK+B G+BN	1	48-E-6910 XLPEI-MS-SWA-PVCS 10x2x0.8MM 48-RTU-0001	1BK
				2		1B
HS-2661B	+	E-2723B 2x2x1.13mm XLPEI-MS-SWA-PVCS	BK+B G+BN	3		2BK
				4		2G
HS-2662A	+	E-2724A 2x2x1.13mm XLPEI-MS-SWA-PVCS	BK+B G+BN	5		3B
				6		3G
HS-2662B	+	E-2724B 2x2x1.13mm XLPEI-MS-SWA-PVCS	BK+B G+BN	7		4BK
				8		4BN
HS-2663	+	E-2725 2x2x1.13mm XLPEI-MS-SWA-PVCS	BK+B G+BN	9		5B
				10		5BN
HS-2664	+	E-2726 2x2x1.13mm XLPEI-MS-SWA-PVCS	BK+B G+BN	11		6G
				12		6BN
SPARE				13		7BK
				14		7W
				15		8B
				16		8W
				17		9G
				18		9W
				19		10BN
				20		10W

NOTE:

1. SCREENS TO BE CONNECTED TO AN ISOLATED EARTH BAR


AREA : NIMR		SCALE : — 0 1 2 3 4 5 6 7		CAD DRAWING							
SUB AREA : NIMR SLUDGE PIT		NO. 05		 شركة تنمية نفط عُمان Petroleum Development Oman							
DRWG. TYPE : CABLE TERMINATION DETAILS		DESCRIPTION : 48-JBE-6910 (VENDOR JB)		DRWG	AREA CODE	ENG SECT	SERIAL NUMBER	SHEET	PROJ CODE	DWG SIZE	REV.
				NO	NIM	5	4742007DQ	4			A



TAG. No. UNIT:48	EQUIPMENT CONNECTION	EXTN. CABLE No.		J.B. TERM'L	MULTICORE CABLE No.	
		SIZE: TYPE:	CORE		TYPE, SIZE AND CONNECTED TO	CORE
JA-1449	+	E-2727	2x2x1.13mm	BK+B	48-E-6911	1BK
	-		XLPEI-MS-SWA-PVCS	G+BN	XLPEI-MS-SWA-PVCS	1B
LIZA-1450	+	E-2728	2x2x1.13mm	BK+B	10x2x0.8MM	2BK
	-		XLPEI-MS-SWA-PVCS	G+BN	48-RTU-0001	2G
PIZA-1518	+	E-2729	2x2x1.13mm	BK+B		3B
	-		XLPEI-MS-SWA-PVCS	G+BN		3G
PIZA-1519	+	E-2730	2x2x1.13mm	BK+B		4BK
	-		XLPEI-MS-SWA-PVCS	G+BN		4BN
PI-1522	+	E-2731	2x2x1.13mm	BK+B		5B
	-		XLPEI-MS-SWA-PVCS	G+BN		5BN
FI-1415	+	E-2732	2x2x1.13mm	BK+B		6G
	-		XLPEI-MS-SWA-PVCS	G+BN		6BN
SPARE						7BK
						7W
						8B
						8W
						9G
						9W
						10BN
						10W

NOTE:

1. SCREENS TO BE CONNECTED TO AN ISOLATED EARTH BAR

AREA : NIMR		SCALE : —		CAD DRAWING																			
SUB AREA : NIMR SLUDGE PIT		NO. 05		 شركة تنمية نفط عُمان Petroleum Development Oman																			
DRWG. TYPE : CABLE TERMINATION DETAILS		<table border="1"> <tr> <th>DRWG</th> <th>AREA CODE</th> <th>ENG SECT</th> <th>SERIAL NUMBER</th> <th>SHEET</th> <th>PROJ CODE</th> <th>DWG SIZE</th> <th>REV.</th> </tr> <tr> <td>NO</td> <td>NIM</td> <td>5</td> <td>4742</td> <td>008</td> <td>DQ</td> <td>4</td> <td>0</td> </tr> </table>						DRWG	AREA CODE	ENG SECT	SERIAL NUMBER	SHEET	PROJ CODE	DWG SIZE	REV.	NO	NIM	5	4742	008	DQ	4	0
DRWG	AREA CODE	ENG SECT	SERIAL NUMBER	SHEET	PROJ CODE	DWG SIZE	REV.																
NO	NIM	5	4742	008	DQ	4	0																
DESCRIPTION : 48-JBE-6911 (VENDOR JB)																							



INST. IMPULSE LINES / ELECTRO PNEUMATIC HOOK-UPS

FOR REVISION / INDEX SHEET REFFER SHEETS 002 ~ 004
FOR GENERAL NOTES REFFER SHEET 008
FOR BULK SUMMARY REFFER SHEETS 010 THRU 016

**APPROVED FOR
CONSTRUCTION**

A	MAR.'11	KK			APPROVED FOR CONSTRUCTION	IN.09.011	OSE/23N	
0	DEC.'10	Mrp	PT	KDA	ISSUED FOR COMMENTS	IN.09.011	OSE/23N	IHN
REV	DATE	DRAWN BY	TEAML.	J.ENG.	DESCRIPTION	WBS NO.:	REF. IND.	SIGNATURE
			CHECKED					P D O APPROVAL


PROJECT DRAWING REVISION

IN CASE OF DEVIATIONS A MARKED UP PRINT SHALL BE SENT TO THE PROJECT ENGINEER

AREA : NIMR SUB AREA : NIMR SLUDGE PIT DRWG. TYPE : INST. IMPULSE LINES/ELECTRO PNEU. HOOK-UPS DESCRIPTION : COVER SHEET	SCALE : — 0 1 2 3 4 5 6 7 شركة تنمية نفط عمان Petroleum Development Oman <table border="1" style="width: 100%; border-collapse: collapse;"> <tr> <th>DRWG</th> <th>AREA CODE</th> <th>ENG SECT</th> <th>SERIAL NUMBER</th> <th>SHEET</th> <th>PROJ CODE</th> <th>DWG SIZE</th> <th>REV.</th> </tr> <tr> <td>No</td> <td>NIM</td> <td>5</td> <td>4738</td> <td>001</td> <td>DQ</td> <td>4</td> <td>A</td> </tr> </table>	DRWG	AREA CODE	ENG SECT	SERIAL NUMBER	SHEET	PROJ CODE	DWG SIZE	REV.	No	NIM	5	4738	001	DQ	4	A
DRWG	AREA CODE	ENG SECT	SERIAL NUMBER	SHEET	PROJ CODE	DWG SIZE	REV.										
No	NIM	5	4738	001	DQ	4	A										




DESCRIPTION	SHEET	REV. 0	REV. A	REV. B	REV. C	REV. D	REV. E
COVER SHEET	001	DEC.'10	MAR.'11				
REVISION/INDEX SHEET	002	DEC.'10	MAR.'11				
REVISION/INDEX SHEET	003	DEC.'10	MAR.'11				
REVISION/INDEX SHEET	004	DEC.'10	MAR.'11				
	005						
	006						
	007						
GENERAL NOTES	008	DEC.'10	MAR.'11				
	009						
BULK MATERIAL SUMMARY	010	DEC.'10	MAR.'11				
BULK MATERIAL SUMMARY	011	DEC.'10	MAR.'11				
BULK MATERIAL SUMMARY	012	DEC.'10	MAR.'11				
BULK MATERIAL SUMMARY	013	DEC.'10	MAR.'11				
BULK MATERIAL SUMMARY	014	DEC.'10	MAR.'11				
BULK MATERIAL SUMMARY	015	DEC.'10	MAR.'11				
BULK MATERIAL SUMMARY	016	DEC.'10	MAR.'11				
	017						
	018						
RTD/TEMP. TRANSMITTER MOUNTING & CONNECTION DET.	019	DEC.'10	MAR.'11				
	020						
DIRECTED MOUNTED MOUDLER PRESSURE GAUGE	021	DEC.'10	MAR.'11				
REMOTE SEAL DIAPHRAGM TYPE PRESS. INSTRUMENT	022	DEC.'10	MAR.'11				
REMOTE SEAL DIAPHRAGM TYPE DIFF.PRES. INSTRUMENT	023	DEC.'10	MAR.'11				
	024						
	025						
	026						
	027						
	028						
INSTRUMENT CABLE TRENCHING DETAILS	029	DEC.'10	MAR.'11				
INSTR. CABLE CORE MARKERS/LOOMING/SLEEVING	030	DEC.'10	MAR.'11				
INSTRUMENT EARTHING DETAILS	031	DEC.'10	MAR.'11				
	032						
PNEUMATIC CONNECTION FOR ESD VALVES	033	DEC.'10	MAR.'11				
AIR SUPPLY DETAILS AS-2 IPF VALVES	034	DEC.'10	MAR.'11				
	035						

AREA : NIMR		SCALE : — 0 1 2 3 4 5 6 7		CAD DRAWING	
SUB AREA : NIMR SLUDGE PIT		No. 05		 شركة تنمية نفط عُمان Petroleum Development Oman	
DRWG. TYPE : INST. IMPULSE LINES/ELECTRO PNEU. HOOK-UPS		DRWG		AREA CODE	
DESCRIPTION : REVISION/INDEX SHEET		ENG SECT		SERIAL NUMBER	
		SHEET		PROJ CODE	
		DWG SIZE		REV.	
		NO		NIM 5 4738 002 DQ 4 A	




DESCRIPTION	SHEET	REV. 0	REV. A	REV. B	REV. C	REV. D	REV. E
	036						
	037						
	038						
	039						
	040						
HOOK-UP DETAILS - SOLENOID VALVE	041	DEC.'10	MAR.'11				
HOOK-UP DETAILS - TRANSMITTERS	042	DEC.'10	MAR.'11				
HOOK-UP DETAILS TYPICAL - SWITCHES/PUSH BUTTONS	043	DEC.'10	MAR.'11				
	044						
HOOK-UP DETAILS - HEAT DETECTOR	045	DEC.'10	MAR.'11				
HOOK-UP DETAILS - HOOTER	046	DEC.'10	MAR.'11				
HOOK-UP DETAILS - ULTRASONIC FLOW METER	047	DEC.'10	MAR.'11				
HOOK-UP DETAILS - JUNCTION BOX	048	DEC.'10	MAR.'11				
	049						
	050						
	051						
	052						
	053						
	054						
	055						
	056						
	057						
	058						
	059						
	060						
	061						
	062						
	063						
	064						
	065						
	066						
	067						
	068						
	069						
	070						

AREA : NIMR		SCALE : — 0 1 2 3 4 5 6 7		CAD DRAWING	
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DRWG. TYPE : INST. IMPULSE LINES/ELECTRO PNEU. HOOK-UPS		DRWG		AREA CODE	ENG SECT
DESCRIPTION : REVISION/INDEX SHEET		SERIAL NUMBER		SHEET	PROJ CODE
		NO		DWG SIZE	REV.
		NIM 5 4738 003 DQ		A 4	A



DESCRIPTION	SHEET	REV. 0	REV. A	REV. B	REV. C	REV. D	REV. E
TYPICAL ARAG. OF BEAM PUMP MONITORING EQUIPMENT	071						
CLINOMETER & VIBRATION SW. ON BEAM BUMP	072						
LIST OF INST. TAGS-CLINOMETER	073						
LIST OF INST. TAGS-VIBRATION SWITCH	074						
LOAD CELL ON BEAM PUMP	075						
LIST OF INST. TAGS-LOAD CELL	076						
	077						
	078						
	079						
JB SUPPORT FOR BEAM PUMP	080						
	081						
	082						
	083						
	084						
ELECTRICAL HOOK-UP LOAD CELL	085						
ELECTRICAL HOOK-UP POSITION SENSOR	086						
ELECTRICAL HOOK-UP PRESS./TEMP./VIBRATION	087						
MCC / RPC / POWER DISTRIBUTION BOARD	088						
RPC TERMINATION DETAILS	089						
	090						
TAG PLATE (1/2" PROCESS CONNECTION)	091	DEC.'10	MAR.'11				
TAG PLATE (2" INST. PIPE SUPPORT)	092	DEC.'10	MAR.'11				
	093						
	094						
	095						
	096						
	097						
	098						
	099						
INSTRUMENT SUPPORT FOR HEAT DETECTOR	100	DEC.'10	MAR.'11				
	101						
INSTR. MOUNTING SUPPORT TYPE-S3 UNPAVED AREA	102	DEC.'10	MAR.'11				
JUNCTION BOX MOUNTING SUPPORT UNPAVED AREA	103	DEC.'10	MAR.'11				
	104						
	105						

AREA : NIMR		SCALE : — 0 1 2 3 4 5 6 7		CAD DRAWING	
SUB AREA : NIMR SLUDGE PIT		NO. 05		 شركة تنمية نفط عُمان Petroleum Development Oman	
DRWG. TYPE : INST. IMPULSE LINES/ELECTRO PNEU. HOOK-UPS		DRWG		AREA CODE	ENG SECT
DESCRIPTION : REVISION/INDEX SHEET		NO		SERIAL NUMBER	SHEET
		NIM 5 4738 004 DQ		PROJ CODE	DWG SIZE
		4 A		REV.	



DOCUMENTS TO BE REFERRED:INSTRUMENT IMPULSE LINES

GENERAL NOTES: STD-5-0811-005-00-4
 -006-00-4
 -007-00-4

ELECTRO-PNEUMATIC HOOK-UPS

SYMBOLS & LEGEND SHEET: STD-5-0803-003-00-4

INSTRUMENT CABLE & PIPING INSTALLATION

GENERAL NOTES: STD-5-0801-003-00-4
 -004-00-4
 -005-00-4
 -006-00-4

TYPICAL INSTALLATION DETAILS STD-5-0801-009-00-4
 -010-00-4

INST. EARTHING PHILOSOPHY STD-5-0801-013-00-4

INST. CABLE IDENTIFICATION STD-5-0801-014-00-4

INST. CABLE CORE MARKERS/
 LOOMING/SLEEVING STD-5-0801-015-00-4

INST. CABLE FASTENING/CHANNELS STD-5-0801-016-00-4

INST. CABLE TRENCH DETAILS STD-5-0801-017-00-4

INST. CABLE ROUTE MARKER STD-5-0801-019-00-4


CONCRETE BLOCK FOR SUPPORTS
 IN UNPAVED AREA STD-5-0801-031-00-4

TAG PLATE (1/2" PROCESS CONN.) STD-5-0811-091-00-4

TAG PLATE (2" INST. SUPPORT PIPE) STD-5-0811-092-00-4


NOTE:

- 1) ALL OTHER NECESSARY MATERIAL AND ACCESSORIES WHICH ARE NOT LISTED IN THIS MTO AND NOT LIMITED TO GENERAL ITEMS, SUCH AS CABLE MARKERS, FERRULES, CABLE TIES, MOUNTING SUPPORTS, FIXING BRACKETS, SCREWS, NUTS, WASHERS, STUDS, TRAYS, SPLICE PLATES, TEES, ELBOWS, CHECKNUTS, BRASS OR GALVANISED STEEL END CAPS, CONDUIT, DUCTS, PVC/BRACE MOUTH FOR WATER/FIRE PROOF SEALING, PULL BOXES, SADDLES, SPACERS AND ANY OTHER CONSUMABLES REQUIRED FOR COMPLETION OF INSTALLATION WORK SHALL BE DETAILED/FURNISHED AND PROCURED BY THE CONSTRUCTION CONTRACTOR.
- 2) HOOK-UP SHOWN ON THIS DWG. IS DIAGRAMATIC ONLY. EXACT ORIENTAION, TAPPING POINT ETC.... SHALL BE AS PER PIPING G.A & ISOMETRIC.

AREA : NIMR		SCALE : — 0 1 2 3 4 5 6 7		CAD DRAWING							
SUB AREA : NIMR SLUGDE PIT		no. 05		 شركة تنمية نفط عُمان Petroleum Development Oman							
DRWG. TYPE : INST. IMPULSE LINES/ELECTRO PNEU. HOOK-UPS				DRWG	AREA CODE	ENG SECT	SERIAL NUMBER	SHEET	PROJ CODE	DWG SIZE	REV.
DESCRIPTION : GENERAL NOTES				NO	NIM 5 4738 008 DQ			A 4	A		




QTY	ITEM	SIZE	DESCRIPTION	MATERIAL	M.E.S.C.
-	018	-	BAKER CAC 8700 RPC	-	60.64.89.200.9
-	019	-	LOAD CELL	-	60.64.89.200.X
-	020	-	CLINOMETER	-	60.64.89.200.X
-	021	-	ANTENNA	-	60.64.89.200.X
-	041	-	DOUBLE ISOLATE/VENT ANTI-CONTAMINATION-TYPE 'B'	AISI 316	60.98.56.217.9
-	048	-	DOUBLE ISOLATE/EQUALIZE/VENT BLOCK-TYPE 'A'	AISI 316	60.98.56.207.9
-	054	-	ISOLATE/VENT GAUGE BLOCK-TYPE 'F'	AISI 316	60.98.56.315.9
-	064	-	ANTI TAMPER KEY	AISI 316	60.98.56.905.1
-	076	3/8"	SEAL POT WITH VENT VALVE	CS/AISI 316	60.98.70.610.1
-	301	M20	CONDUIT	GALV. STEEL	XX.XX.XX.XXX.X
13.5m	302	25mm DIA	HEAVY GAUGE CONDUIT	GALV. STEEL	70.13.04.025.1
-	303	M32	CONDUIT	GALV. STEEL	XX.XX.XX.XXX.X
-	311	m25	PVC CONDUIT	PVC	XX.XX.XX.XXX.X
-	313	m50	PVC CONDUIT	PVC	XX.XX.XX.XXX.X
-	419	3/8" OD	TUBING - WALL THICKNESS 0.065"	AISI 316	74.48.50.055.1
15m	420	-	CAPILLARY TUBE (BY VENDOR)	SS	XX.XX.XX.XXX.X
-	527	1/4" NPT	NEEDLE VALVE - SCREWED	AISI 316	77.34.08.001.1
-	528	1/2" NPT	NEEDLE VALVE - SCREWED	AISI 316	77.34.08.003.1
-	651	1/4" NPT x 35 mm	HEX PIPE NIPPLE - SCREWED	AISI 316	76.09.56.001.1
-	652	1/2" NPT x 45 mm	HEX PIPE NIPPLE - SCREWED	AISI 316	76.09.56.031.1
-	743	3/8" x 1/4" NPT	MALE CONNECTOR COMPRESSION TYPE	AISI 316	76.39.27.063.1
-	744	3/8" x 1/2" NPT	MALE CONNECTOR COMPRESSION TYPE	AISI 316	76.39.27.065.1
-	750	3/8"	UNION ELBOW COMPRESSION TYPE	AISI 316	76.39.44.065.1
-	756	3/8"	PLUG COMPRESSION TYPE	AISI 316	76.39.67.060.1
-	766	3/8"	UNION TEE COMPRESSION TYPE	AISI 316	76.39.85.063.1
-	772	3/8"	UNION COMPRESSION TYPE	AISI 316	76.39.91.063.1
-	780	3/8" x 1/2" NPT (F)	BULK HEAD FEMALE CONNECTOR	AISI 316	76.39.27.105.9
-	626	1/2"NPT x 51 mm	PIPE NIPPLE, SCREWED	CS	76.05.56.482.1
-	630	1/2"NPT	PLUG, SCREWED, HEX. HEAD	CS	76.05.66.008.1
-	635	1/2"NPT	TEE, SCREWED, 3000 # SEAMLESS	CS	76.05.84.108.1
-	727	3/8" x DN15	LAP JOINT COMPRESSION	SS	76.39.05.106.1
-	920	M4x40x40	BOLT HEX. HD	GALV	XX.XX.XX.XXX.X
-	921	M4	NUT HEX. HD	GALV	XX.XX.XX.XXX.X
-	922	M4	WASHER FLAT	GALV	XX.XX.XX.XXX.X

AREA : NIMR		SCALE : — 0 1 2 3 4 5 6 7		CAD DRAWING						
SUB AREA : NIMR SLUDGE PIT		No. 05		 شركة تنمية نفط عُمان Petroleum Development Oman						
DRWG. TYPE : INSTR. IMPULSE LINES & ELECTRO PNEU. HOOK-UPS		DRWG		AREA CODE	ENG SECT	SERIAL NUMBER	SHEET	PROJ CODE	DWG SIZE	REV.
DESCRIPTION : BULK MATERIAL SUMMARY		NO		NIM 5 4738 010 DQ			4	A		




ITEM	QTY	SIZE	DESCRIPTION	MATERIAL	M.E.S.C.
A	—	1/4"NPT	FILTER REGULATOR RANGE 35–275kPa	AISI 316 BRASS ALUMINIUM CARBON STEEL AISI 316	60.98.34.612.9
B	—	1/4"NPT	FILTER REGULATOR RANGE 0–400kPa		60.98.34.616.9
C	—	1/4"NPT	FILTER REGULATOR RANGE 35–700kPa		60.98.34.700.9
D	—	1/2"NPT	FILTER REGULATOR RANGE 40–1000kPa		60.98.34.XXX.X
E	—	1/2"NPT Mx1/2"NPT F	SYPHON(DAMPENER)		60.98.55.XXX.X
F	—	3/8"NPT	PORT PROTECTOR		60.98.90.XXX.1
G	—				
H	—	3/8" NPT	QUICK EXHAUST VALVE		60.XX.XX.XXX.1
I	—	1/2" NPT	DRAIN POT AS PER STD–5–0802–11		60.XX.XX.XXX.X
J	—	1/2" NPT M	BLEEDER VALVE		60.XX.XX.XXX.X
K	—				
L	140m	2x2.5SQ.mm	CABLE XLPEI–SWA–PES: BLACK		XX.XX.XX.XXX.X
M	200m	3x2.5SQ.mm	CABLE XLPEI–SWA–PES: BLACK		68.44.14.303.1
N	—	21x2.5SQ.mm	CABLE XLPEI–SWA–PES: BLACK		68.44.14.953.9
O	780m	2x2x1.13mm	CABLE XLPEI–MS–SWA–PVCS: BLACK		XX.XX.XX.XXX.X
P	800m	10x2x0.8mm	CABLE XLPEI–MS–SWA–PVCS: GREEN		XX.XX.XX.XXX.X
Q	—	20x2x0.8mm	CABLE XLPEI–MS–SWA–PVCS: GREEN		XX.XX.XX.XXX.X
R	—	19 ~ 6mm	CABLE SHRINK ON SLEEVE (BLUE)	POLYOLEFIN	XX.XX.XX.XXX.X
S	—	38 ~ 19mm	CABLE SHRINK ON SLEEVE (BLUE)	POLYOLEFIN	XX.XX.XX.XXX.X
T	—	1x2x0.8mm	CABLE PEI–MS–SWA–PVC : BLACK	—	XX.XX.XX.XXX.X
T1	—	4x0.8mm	SPECIAL CABLE (BY VENDOR)	—	XX.XX.XX.XXX.X
T2	—	3x0.8mm	SPECIAL CABLE (BY VENDOR)	—	XX.XX.XX.XXX.X
T3	—	—	CABLE GLAND (BY VENDOR)	—	XX.XX.XX.XXX.X
U	—	2x2x0.8mm	CABLE PEI–MS–SWA–PVC : BLACK	—	XX.XX.XX.XXX.X
V	—	M20	JUNCTION BOX	MILD STEEL	68.76.27.XXX.9
W	—	50mm	PERFORATED CABLE TRAY	CARBON STEEL	68.76.54.XXX.1
X	25pcs	M20	LOCKNUT	BRASS	68.80.58.068.1
Y	10pcs	M25	LOCKNUT	BRASS	68.80.58.072.1
Z	—	M32	LOCKNUT	BRASS	68.80.58.076.1

AREA : NIMR		SCALE : — 0 1 2 3 4 5 6 7		CAD DRAWING	
SUB AREA : NIMR SLUDGE PIT		NO. 05		 شركة تنمية نفط عُمان Petroleum Development Oman	
DRWG. TYPE : INSTR. IMPULSE LINES & ELECTRO PNEU. HOOK-UPS		DRWG		AREA CODE	ENG SECT
DESCRIPTION : BULK MATERIAL SUMMARY		SERIAL NUMBER		SHEET	PROJ CODE
		NO		DWG SIZE	REV.
		NIM 5 4738 011 DQ		4	A




ITEM	QTY	SIZE	DESCRIPTION	MATERIAL	M.E.S.C.
AA	44pcs	M20	CABLE GLAND TYPE-O	BRASS	68.80.58.730.1
AB	10pcs	M25	CABLE GLAND TYPE-B	BRASS	68.80.58.734.1
AC	—	M32	CABLE GLAND TYPE-C	BRASS	68.80.58.736.1
AD	6pcs	1/2"NPTxM20	ADAPTER FOR CABLE GLAND	BRASS	68.80.58.802.9
AE	—	3/4"NPTxM20	ADAPTER FOR CABLE GLAND	BRASS	68.80.58.804.9
AF	—	M32xM25	REDUCER FOR CABLE GLAND	BRASS	68.80.58.820.9
AG	—	1/2"NPT	BLIND PLUG	BRASS	68.80.58.XXX.X
AH	—	3/4"NPT	BLIND PLUG	BRASS	68.80.58.XXX.X
AI	—	M20	BLIND PLUG	BRASS	68.80.58.XXX.X
AJ	—	M20	INSULATED ADAPTOR	BRASS	68.80.58.XXX.X
AK	—	3/8"NPT	SOLENOID VALVE 3 WAY Ex(d)	AISI 316	68.98.58.XXX.9
AL	—	M20	CABLE GLAND TYPE-A	BRASS	68.80.58.732.1
AM	—				
AN	—	1/2"	LINE PIPE SCHEDULE-40	GALV.ST.	74.13.08.016.1
AO	—	1"	LINE PIPE SCHEDULE-40	GALV.ST.	74.13.08.026.1
AP	19.6m	2"	LINE PIPE SCHEDULE-40	CARBON STEEL	74.13.10.069.1
AQ	2pcs	3"	LINE PIPE SCHEDULE-40	CARBON STEEL	74.13.10.103.1
AR	—	2"	LINE PIPE SCHEDULE-80	CARBON STEEL	74.13.12.071.1
AS	—	1/4"NPT	BALL VALVE SCREWED-800#	CARBON STEEL	77.01.00.001.1
AT	—	1/2"NPT	BALL VALVE SCREWED-800#	CARBON STEEL	77.01.00.003.1
AU	—	1/2"NPT	GATE VALVE SCREWED-800#	CARBON STEEL	77.21.01.003.1
AV	—				
AW	—	1"x1/2"NPT	BUSHING SCREWED-3000#	GALV.ST.	76.06.14.162.1
AX	—				
AY	—	1/2"NPT	ELBOW 90 DEG. SCREWED-3000#	GALV.ST.	76.06.39.008.1
AZ	—	1"NPT	ELBOW 90 DEG. SCREWED-3000#	GALV.ST.	76.06.39.016.1

AREA : NIMR		SCALE : — 0 1 2 3 4 5 6 7		CAD DRAWING					
SUB AREA : NIMR SLUDGE PIT		No. 05		 شركة تنمية نفط عُمان Petroleum Development Oman					
DRWG. TYPE : INSTR. IMPULSE LINES & ELECTRO PNEU. HOOK-UPS									
DESCRIPTION : BULK MATERIAL SUMMARY		DRWG	AREA CODE	ENG SECT	SERIAL NUMBER	SHEET	PROJ CODE	DWG SIZE	REV.
		NO	NIM	5	4738	012	DQ	4	A




ITEM	QTY	SIZE	DESCRIPTION	MATERIAL	M.E.S.C.
BA	—	1/4"NPTx40mm	NIPPLE SCREWED SCHED 40	GALV.ST.	76.06.56.041.1
BB	—	1/2"NPTx50mm	NIPPLE SCREWED SCHED 80	GALV.ST.	76.06.56.092.1
BC	—	1"NPTx50mm	NIPPLE SCREWED SCHED 80	GALV.ST.	76.06.56.172.1
BD	—				
BE	—	1/2"NPT	PLUG SCREWED 3000#	GALV.ST.	76.06.66.008.1
BF	—	1"NPT	PLUG SCREWED 3000#	GALV.ST.	76.06.66.016.1
BG	—	1/2"NPTx1/4"NPT	RED.COUPLING 3000#	GALV.ST.	76.06.70.081.1
BH	—				
BI	—	1/2"NPT	TEE SCREWED 3000#	GALV.ST.	76.06.84.008.1
BJ	—	1"NPT	TEE SCREWED 3000#	GALV.ST.	76.06.84.016.1
BK	—				
BL	—				
BM	—	1/2"NPT	UNION SCREWED 3000#	GALV.ST.	76.06.91.008.1
BN	—	1"NPT	UNION SCREWED 3000#	GALV.ST.	76.06.91.016.1
BO	—				
BP	9pcs	2"	CAP BUTT WELDING SCHEDULE 80	CARBON STEEL	76.30.18.608.1
BQ	2pcs	3"x2"	REDUCER CON.BUTT WELDING TYPE	CARBON STEEL	76.30.72.235.1
BR	—				
BS	—				
BT	—				
BU	—				
BV	—				
BW	—	3/8"NPTx1/4"OD	MALE CONNECTOR COMPR.TYPE	AISI 316	76.39.27.045.9
BX	—	1/2"NPTx1/4"OD	MALE CONNECTOR COMPR.TYPE	AISI 316	76.39.27.047.9
BY	—	3/8"ODx3/8"NPT	MALE CONNECTOR COMPR.TYPE	AISI 316	76.39.27.063.9
BZ	—	1/4"NPTx1/4"OD	FEMALE CONNECTOR COMPR.TYPE	AISI 316	76.39.27.243.1

AREA : NIMR		SCALE : — 0 1 2 3 4 5 6 7		CAD DRAWING	
SUB AREA : NIMR SLUDGE PIT		NO. 05		 شركة تنمية نفط عُمان Petroleum Development Oman	
DRWG. TYPE : INSTR. IMPULSE LINES & ELECTRO PNEU. HOOK-UPS		DRWG		AREA CODE	ENG SECT
DESCRIPTION : BULK MATERIAL SUMMARY		NO		SERIAL NUMBER	SHEET
		NIM 5 4738 013 DQ		PROJ CODE	DWG SIZE
		4		REV.	A




ITEM	QTY	SIZE	DESCRIPTION	MATERIAL	M.E.S.C.
CA	—	1/4"NPTx3/8"OD	FEMALE CONNECTOR COMPR.TYPE	AISI 316	76.39.27.261.1
CB	—	1/2"NPTx3/8"OD	FEMALE CONNECTOR COMPR.TYPE	AISI 316	76.39.27.265.1
CC	2pcs	1/2"NPTx1/2"OD	MALE CONNECTOR COMPR.TYPE	AISI 316	76.39.27.XXX.X
CD	—	3/8"OD	INSULATING UNION COMPR.TYPE	AISI 316	76.39.91.108.9
CE	—				
CF	18pcs	1/4"NPT	PLUG SCREWED	AISI 316	76.39.67.040.1
CG	—	1/4"NPT	FUSIBLE PLUG	—	—
CH	—	1/2"NPT(F)	NEEDLE VALVE	AISI 316	77.34.XX.XXX.X
CI	—	5mm THICK	ALUMINIUM PLATE	ALUMINIUM	78.01.30.162.1
CJ	6.19m	50x6mm THICK	FLAT BAR	MILD STEEL	78.39.02.121.1
CK	—	10mm THICK	STEEL PLATE (500x50x10mm)	MILD STEEL	
CL	0.455Sq.m	3mm THICK	STEEL PLATE	MILD STEEL	78.43.30.108.1
CM	0.245Sq.m	6mm THICK	STEEL PLATE	MILD STEEL	78.43.30.116.1
CN	0.64Sq.m	10mm THICK	STEEL PLATE (50x50x10mm)	MILD STEEL	78.43.30.124.1
CO	—	75x40x6x8mm	U-CHANNEL	MILD STEEL	78.47.31.XXX.1
CP	—	35x35x4mm	ANGLE IRON	MILD STEEL	78.47.01.336.1
CQ	4.14m	50x50x6mm	ANGLE IRON	MILD STEEL	78.47.01.352.1
CR	4m	1/2"OD	TUBING WALL THICKNESS 0.048"	AISI 316	74.48.50.073.9
CS	—				
CT	—				
CU	—	1/4"OD	TUBING WALL THICKNESS 0.036"	AISI 316	74.48.50.033.1
CV	—	M6x30 MM	BOLT HEXAGONAL HEAD	CARBON STEEL	81.01.77.116.1
CW	—	M8x40 MM	BOLT HEXAGONAL HEAD	CARBON STEEL	81.01.77.153.1
CX	—	M10x40 MM	BOLT HEXAGONAL HEAD	CARBON STEEL	81.01.77.188.1
CY	4pcs	M10x60 MM	BOLT HEXAGONAL HEAD	CARBON STEEL	81.01.77.192.1
CZ	—	M12x60 MM	BOLT HEXAGONAL HEAD	CARBON STEEL	81.01.77.232.1

AREA : NIMR		SCALE : — 0 1 2 3 4 5 6 7 CAD DRAWING						
SUB AREA : NIMR SLUDGE PIT		NO. 05	 شركة تنمية نفط عُمان Petroleum Development Oman					
DRWG TYPE : INSTR. IMPULSE LINES & ELECTRO PNEU. HOOK-UPS			DRWG	AREA CODE	ENG SECT	SERIAL NUMBER	SHEET	PROJ CODE
DESCRIPTION : BULK MATERIAL SUMMARY			NO	NIM 5 4738 014 DQ				REV.
							4	A




ITEM	QTY	SIZE	DESCRIPTION	MATERIAL	M.E.S.C.
DA	16pcs	M12x110mm	FOUNDATION BOLT WITH NUT & WASHER	CARBON STEEL	81.26.25.133.1
DB	—	M6x60mm	'J'BOLT HOOK C/W NUT & WASHER	CARBON STEEL	81.26.33.124.1
DC	—				
DD	—	3/8"	'U'BOLT C/W 4HEX.NUTS	CARBON STEEL	81.26.86.040.9
DE	—				
DF	—	M6	NUT HEXAGONAL HEAD	CARBON STEEL	81.41.77.014.1
DG	—	M8	NUT HEXAGONAL HEAD	CARBON STEEL	81.41.77.016.1
DH	4pcs	M10	NUT HEXAGONAL HEAD	CARBON STEEL	81.41.77.018.1
DI	—	M12	NUT HEXAGONAL HEAD	CARBON STEEL	81.41.77.020.1
DJ	—				
DK	—	M6x12.5DIAx1.6	FLAT WASHER ROUND	MILD STEEL	81.78.50.714.1
DL	—	M8x17DIAx1.6	FLAT WASHER ROUND	MILD STEEL	81.78.50.716.1
DM	—	M10x21DIAx2	FLAT WASHER ROUND	MILD STEEL	81.78.50.718.1
DN	—	M12x24DIAx2.5	FLAT WASHER ROUND	MILD STEEL	81.78.50.720.1
DO	—				
DP	—	1/4"	METERING VALVE	AISI 316.	HOKE 1335 G4Y
DQ	—	1/4"	NEEDLE VALVE	AISI 316.	HOKE 3712 G4Y
DR	—	1/4"NPT	BALL VALVE	AISI 316.	HOKE 7115 F4Y
DS	—	m25	U-BOLTS C/W HEX. NUTS AND WASHERS	AISI 316.	
DT	—	m50	U-BOLTS C/W HEX. NUTS AND WASHERS	AISI 316.	
DU	13pcs	M8	U-BOLT FOR 1/2" PIPE C/W NUTS & SPRING WASHER	AISI 316.	81.26.86.022.9
DV	34pcs	M10	U-BOLT FOR 2" PIPE C/W NUTS & SPRING WASHER	AISI 316.	81.26.86.040.9
DW	—	1/2"NPT	GAUGE ADAPTOR – MALE TO FEMALE	AISI 316.	76.09.02.102.9
DX	—	1/2"NPT	GAUGE ADAPTOR – MALE TO MALE	AISI 316.	76.09.02.112.9
DY	—	1-1/16"	BULKHEAD RETAINER	AISI 316.	76.39.95.102.9
DZ	—				

AREA : NIMR		SCALE : — 0 1 2 3 4 5 6 7		CAD DRAWING							
SUB AREA : NIMR SLUDGE PIT		No. 05		 شركة تنمية نفط عُمان Petroleum Development Oman							
DRWG.TYPE : INSTR. IMPULSE LINES & ELECTRO PNEU. HOOK-UPS				DRWG	AREA CODE	ENG SECT	SERIAL NUMBER	SHEET	PROJ CODE	DWG SIZE	REV.
DESCRIPTION : BULK MATERIAL SUMMARY				NO	NIM 5 4738 015 DQ				4	A	



ITEM	QTY	SIZE	DESCRIPTION	MATERIAL	M.E.S.C.
EA	—	4x140mm	CABLE TIES 12/BLACK	NYLON	68.80.50.942.9
EB	—	—	CARRIER STRIP BLACK 7 DIGITS	PVC	68.79.02.004.9
EC	—	65	CABLE MARKER TYPE KS	NYLON	68.79.02.826.9
ED	—	250x19x1.6mm	PLAIN STRIP	LEAD	68.79.02.018.1
EE	—	D=1.5 - 2.0mm	CORE MARKER MODEL ZS-5		68.79.02.802.9
EF	—	D=2.0 - 3.2mm	CORE MARKER MODEL ZS-7		68.79.02.803.9
EG	—	D=2.5 - 4.0mm	CORE MARKER MODEL ZS-9		68.79.02.804.9
EH	—	ID=2mm	SLEEVEING, GREEN	PVC	68.85.10.504.1
EI	—	8x375mm	CABLE TIES 12/BLACK	NYLON	68.80.50.944.9
EJ	—	8x240mm	CABLE TIES 12/BLACK	NYLON	68.80.50.946.9
EK	100m	100mm WIDE	CABLE CHANNEL	GALV.	68.76.54.824.9
EL	—	150mm WIDE	CABLE CHANNEL		68.76.54.826.9
EM	—	200mm WIDE	CABLE CHANNEL (NOTE-2)		68.76.54.828.9
EN	—	300mm WIDE	CABLE CHANNEL (NOTE-2)		68.76.54.832.9
EO	50pcs	100mm WIDE	CABLE CHANNEL BEND (90° FLAT)		68.76.54.052.9
EP	—	150mm WIDE	CABLE CHANNEL BEND (90° FLAT)		68.76.54.054.9
EQ	—	200mm WIDE	CABLE CHANNEL BEND (90° FLAT)		68.76.54.056.9
ER	—	300mm WIDE	CABLE CHANNEL BEND (90° FLAT)		68.76.54.058.9
ES	200pcs	1000x244x6mm	CABLE TILE		68.76.81.024.9
ET	—	—	TYPE-A NAME PLATE	PLASTIC	68.76.81.XXX.X
EU	—				
EV					
EW					
EX					
EY					
EZ					
KJ	100pcs	1/4"x40mm	BOLTS & NUTS	GALV.	XX.XX.XX.XXX.X
XX	15pcs	2" (M50)	EYE BOLT	CS	XX.XX.XX.XXX.X
—	50m	—	ANTENNA CABLE (BY VENDOR)	—	XX.XX.XX.XXX.X


AREA : NIMR		SCALE : — 0 1 2 3 4 5 6 7		CAD DRAWING							
SUB AREA : NIMR SLUDGE PIT		No. 05		 شركة تنمية نفط عُمان Petroleum Development Oman							
DRWG.TYPE : INST. IMPULSE LINES/ELECTRO PNEU. HOOK-UPS				DRWG	AREA CODE	ENG SECT	SERIAL NUMBER	SHEET	PROJ CODE	DWG SIZE	REV.
DESCRIPTION : BULK MATERIAL SUMMARY				NO	NIM	5	4738	016	DQ	4	A




RTD TYPICAL CONNECTION DETAILS

TAG No.

48-TIA-1468

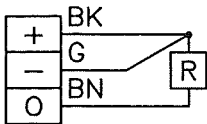


HOOK-UP DETAILS FOR REMOTE MOUNTED TEMPERATURE TRANSMITTER

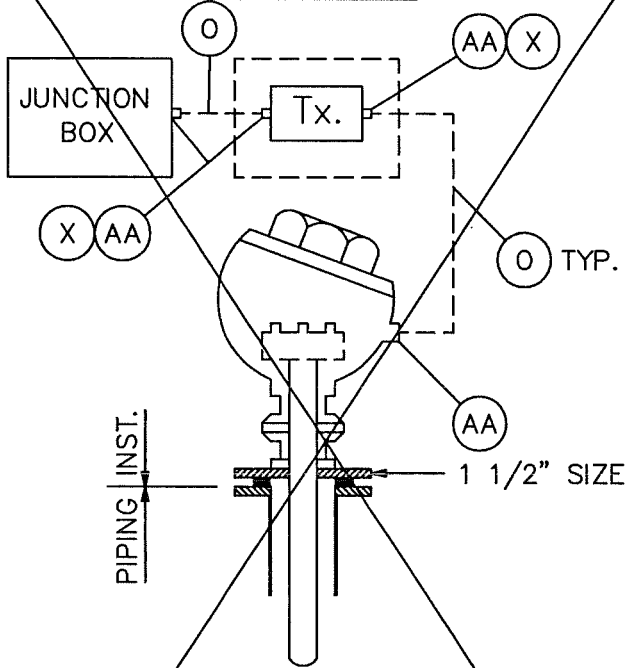

NOTES:

- 1) WHEREVER HIGH VIBRATIONS ARE EXPECTED THE TEMPERATURE Tx. SHALL BE REMOTE MOUNTED.
- 2) THE FLANGE RATING SHALL BE AS PER PIPING CLASS.
- 3) * FIELDBUS CONNECTION
- 4) ** VENDOR SCOPE

HOOK-UP DETAILS FOR HEAD MOUNTED TEMPERATURE TRANSMITTER

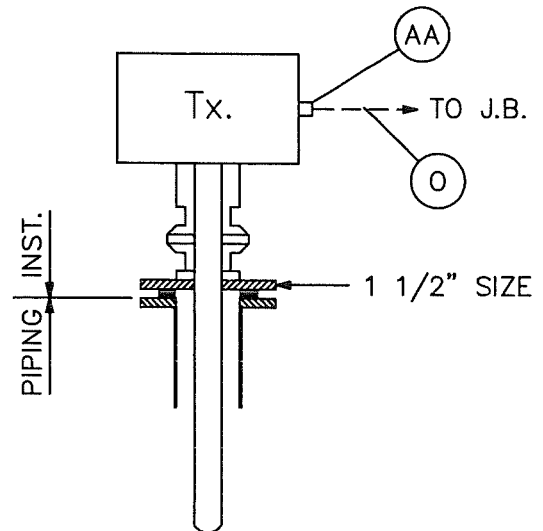

NOTES:


- 1) THE FLANGE RATING SHALL BE AS PER PIPING CLASS.
- 2) FOR THERMOWELL LENGTH REF. DWG. NO. S38.100-D

QTY. REQD.-
01 No.


ITEM	QTY	SIZE OR CONNECTION	DESCRIPTION	MATL.	M.E.S.C.
O	SEE CAB. SCH.	2x2x1.13mm	CABLE: XLPEI-MS-SWA-PVCS	-	XX.XX.XX.XXX.X
X	-	M20	LOCK NUT	BRASS	68.80.58.068.1
AA	2	M20	CABLE GLAND	BRASS	68.80.58.730.1


AREA : NIMR	SCALE : — 0 1 2 3 4 5 6 7	CAD DRAWING
SUB AREA : NIMR SLUDGE PIT	NO. 05	شركة تنمية نفط عمان Petroleum Development Oman
DRWG. TYPE : INST. CABLE & PIPING INSTALLATION DETAILS	DRWG	AREA CODE
DESCRIPTION : RTD/TEMP. TRANSMITTER MOUNTING & CONNECTION DETAILS	ENG SECT	SERIAL NUMBER
	NO	SHEET
	NIM 5 4738 019 DQ	PROJ CODE
	4	DWG SIZE
	A	REV.



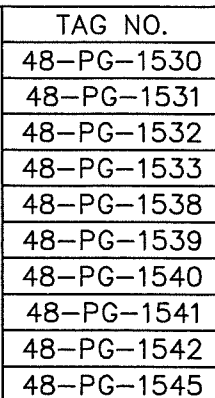

- QTY. REQD.—
10 Nos.

AREA : NIMR		SCALE : — 0 1 2 3 4 5 6 7		CAD DRAWING						
SUB AREA : NIMR SLUGDE PIT		NO. 05		 شركة تنمية نفط عُمان Petroleum Development Oman						
DRWG.TYPE : INSTRUMENT IMPULSE LINES		DRWG		AREA CODE	ENG SECT	SERIAL NUMBER	SHEET	PROJ CODE	DWG SIZE	REV
DESCRIPTION : DIRECT MOUNTED WITH MOUDLAR SBB PRESSURE GAUGE		NO		NIM	5	4738	021	DQ	4	A

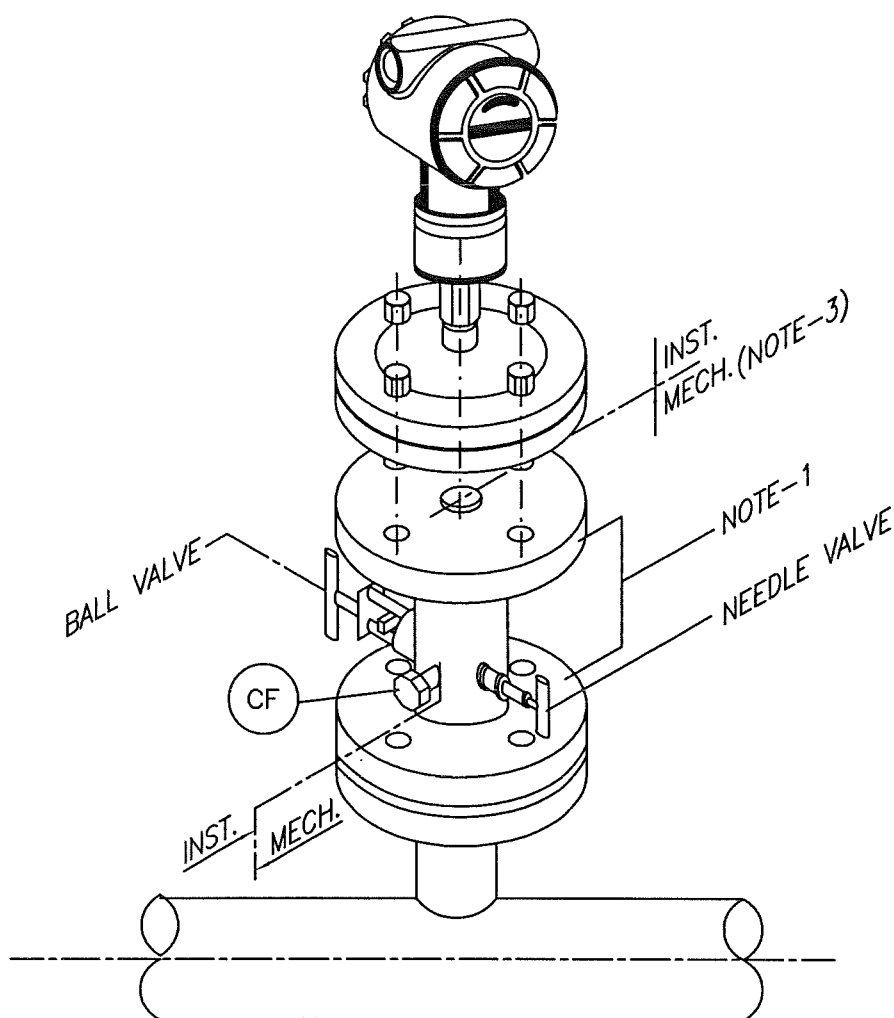


NOTES:

- 1) 2" 300# RF SBB VALVE TO BE PROVIDED BY MECHANICAL.
- 2) FOR TAG PLATE & FIXING BRACKET, REFER TO SHEET 109 (SUPPLIED BY INSTRUMENTS)
- 3) ALL GASKET, NUT-STUD SHALL BE PROVIDED BY MECHANICAL.

TAG No.
48-PIZA-1516


QTY. REQD.-
1 No.

ITEM	QTY	SIZE OR CONNECTION	DESCRIPTION	MATL.	M.E.S.C.
420	3M		CAPILLARY TUBE (BY VENDOR)	SS	XX.XX.XX.XXX.X
CF	1	1/4" NPT	PLUG SCREWED	AISI 316	76.39.67.040.1

AREA : NIMR		SCALE : 0 1 2 3 4 5 6 7		CAD DRAWING		
SUB AREA : NIMR SLUDGE PIT		NO. 05		 شركة تنمية نفط عُمان Petroleum Development Oman		
DRWG. TYPE : INST. IMPULSE LINES/ELECTRO PNEU. HOOK-UPS		DESCRIPTION : REMOTE SEAL DIAPHRAGM TYPE PRESSURE INSTRUMENT		DRWG	AREA CODE	ENG SECT
				SERIAL NUMBER	SHEET	PROJ CODE
				DWG SIZE	REV.	
				NO	NIM 5 4738 022 DQ	A 4 A



TAG NO.
48-PDIA-1520
48-PDIA-1521
48-PDIZA-1523

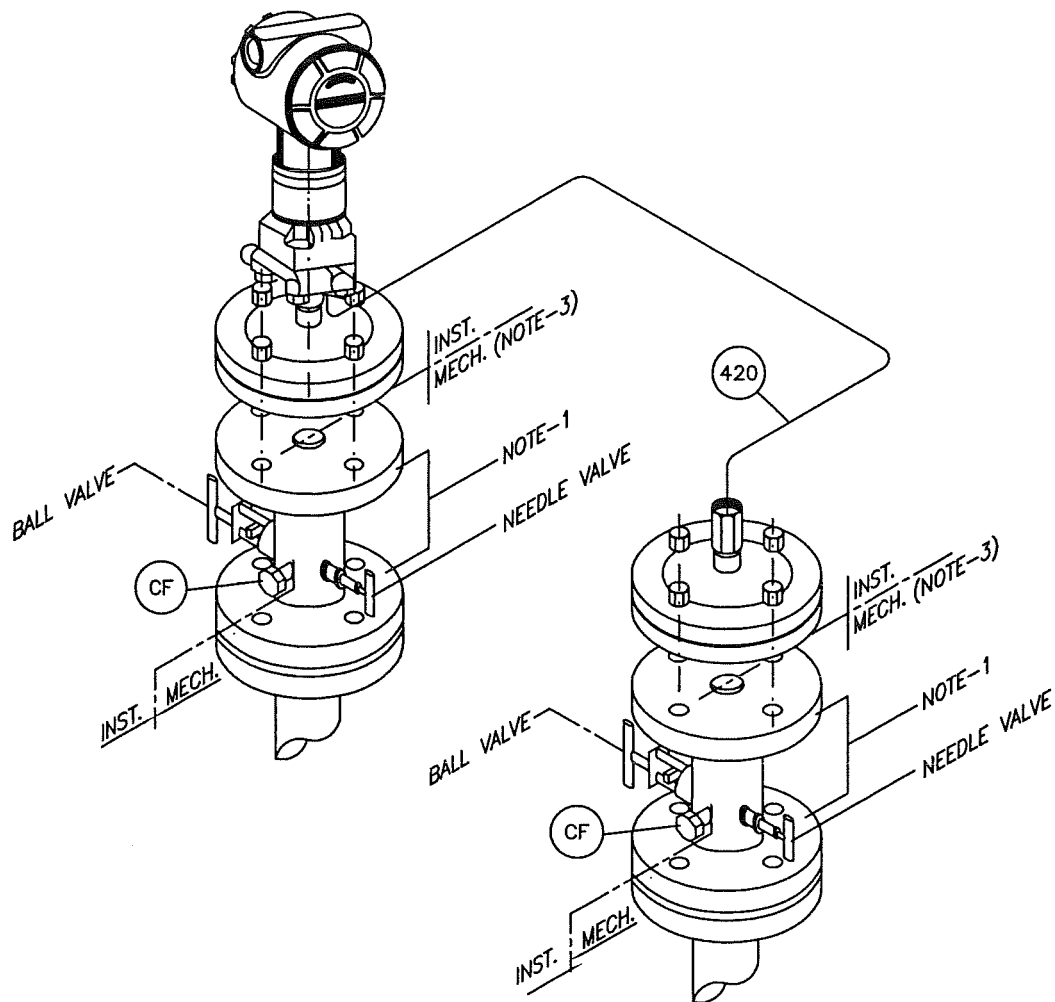


NOTES:


- 1) 2" 300# RF SBB VALVE TO BE PROVIDED BY MECHANICAL.
- 2) FOR TAG PLATE & FIXING BRACKET, REFER TO SHEET 109 (SUPPLIED BY INSTRUMENTS)
- 3) ALL GASKET, NUT-STUD SHALL BE PROVIDED BY MECHANICAL

QTY. REQD.-
03 Nos.

ITEM	QTY	SIZE OR CONNECTION	DESCRIPTION	MATL.	M.E.S.C.
420	5M	—	CAPILLARY TUBE (BY VENDOR)	SS	XX.XX.XX.XXX.X
CF	2	1/4" NPT	PLUG SCREWED	AISI 316	76.39.67.040.1

AREA : NIMR		SCALE : — 0 1 2 3 4 5 6 7		CAD DRAWING	
SUB AREA : NIMR SLUDGE PIT		NO. 05		 شركة تنمية نفط عُمان Petroleum Development Oman	
DRWG. TYPE : INSTRUMENT IMPULSE LINES		DRWG		AREA CODE	ENG SECT
DESCRIPTION : REMOTE SEAL DIAPHRAGM TYPE DIFF. PRESSURE INSTRUMENT		NO		SERIAL NUMBER	SHEET
				PROJ CODE	DWG SIZE
				REV.	
				4	A



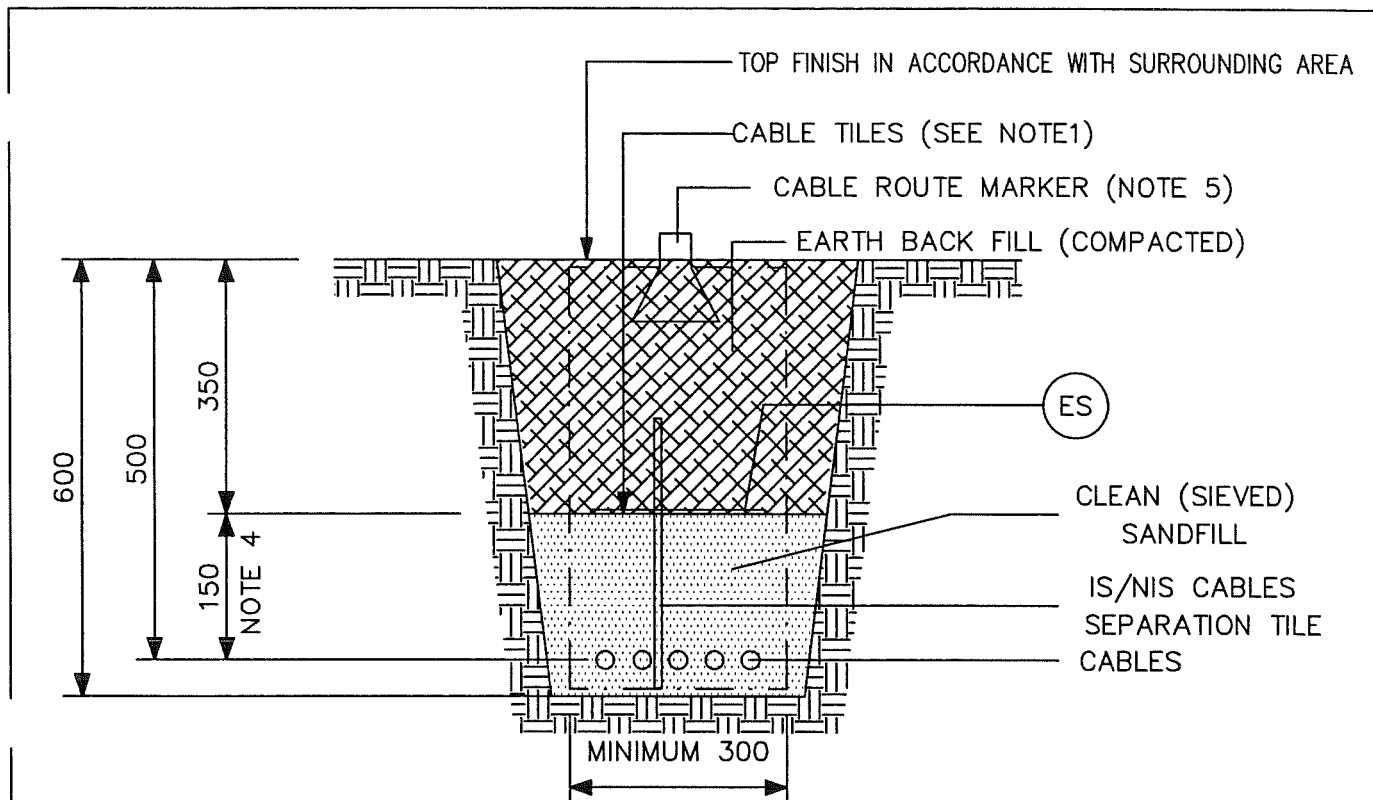


CABLE ROUTING IN UNPAVED AREAS


ITEM	QTY.	SIZE	DESCRIPTION	MATERIAL	M.E.S.C. NO.
ES	200 PCE	1000x244x6mm	CABLE TILE	—	68.76.81.024.9

NOTES

1. RECYCLED POLYETHYLENE CABLE TILE. BLACK ON ONE SIDE , OTHER SIDE RED WITH 150mm GREEN TAPE WITH PRINTING "CAUTION INSTRUMENT CABLE BELOW".
DRILLED WITH 2No. 15mm DIA HOLES SUPPLIED WITH 2 PCS JOINTING PEGS PER TILE.
2. SEPARATE I.S. AND N.I.S. CABLES IN CABLE TRENCHES. USING CABLE TILE ON EDGE AS PARTITION.
3. CABLE TRENCHING IN PAVED AREAS:
FOR CABLE TRENCHING IN CONCRETE, BRICK PAVED OR TILED AREAS AND FOR ROAD CROSSING DETAILS SEE STANDARD DRAWINGS S 19.001 AND S 19.002.
4. 250mm IN CASE OF IS/NIS CABLE SEPARATION WITH CABLE TILE.
5. REFER STD-5-0801-019

AREA : NIMR		SCALE : 0 1 2 3 4 5 6 7		CAD DRAWING					
SUB AREA : NIMR SLUDGE PIT		No. 05		<div></div> <div>شركة تنمية نفط عُمان</div> <div>Petroleum Development Oman</div>					
DRWG. TYPE : INST. IMPULSE LINES/ELECTRO PNEU. HOOK-UPS									
DESCRIPTION : INST. CABLE TRENCHING DETAILS		DRWG	AREA CODE	ENG SECT	SERIAL NUMBER	SHEET	PROJ CODE	DWG SIZE	REV.
		NO	NIM	5	4738	029	DQ	4	A

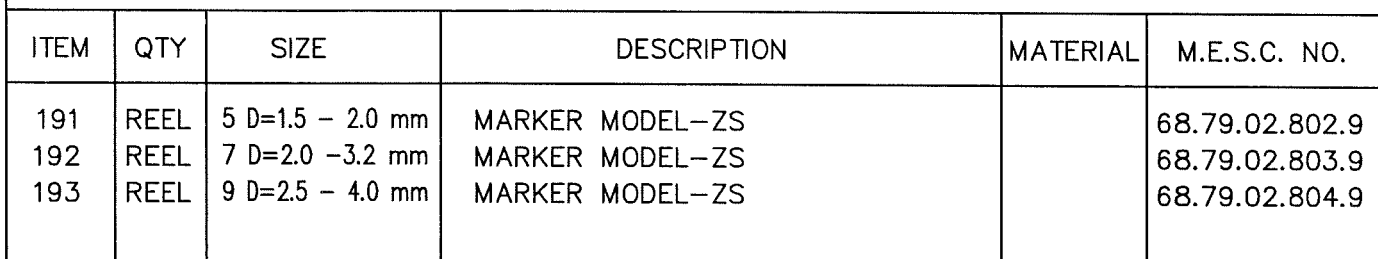


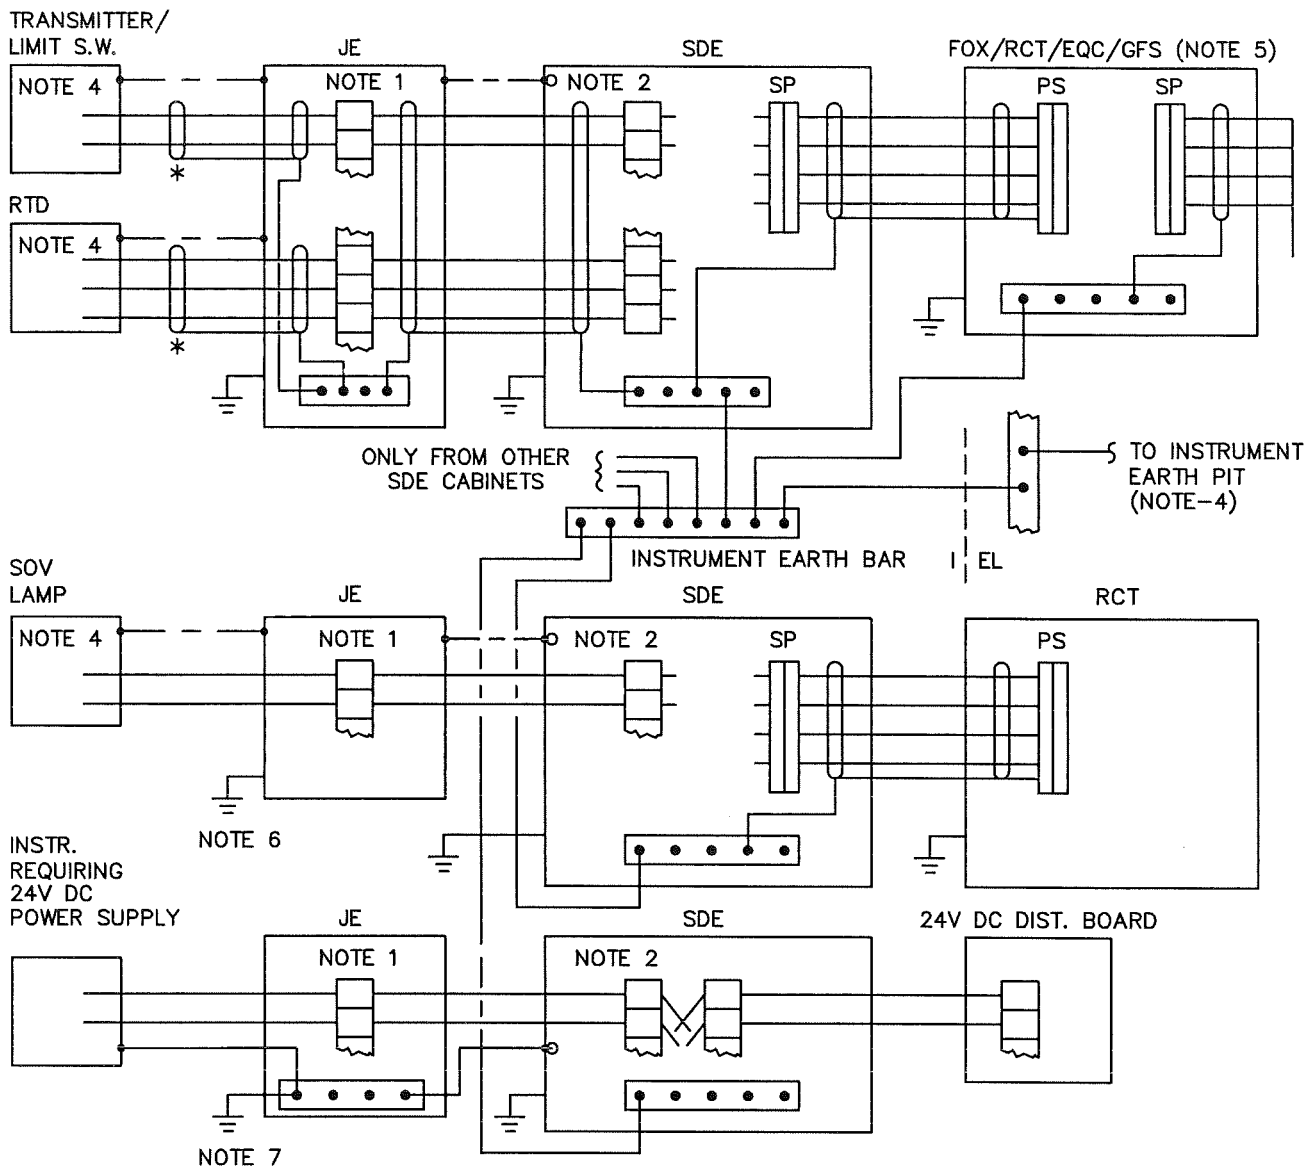


CABLE TYPE	M.E.S.C. NO.	D (average)	SIZE
2 x 2 x 1.13	68.51.35.013.9	2.13 mm	7
10 x 2 x 0.8	68.51.35.031.9	1.80 mm	5
20 x 2 x 0.8	68.51.35.051.9	1.80 mm	5
2 x 2.5	68.44.14.203.9	3.50 mm	9
21 x 2.5	68.44.14.953.9	3.20 mm	9
CONN. WIRE	68.18.11.XXX.X	1.65 mm	5



ITEM	QTY	SIZE	DESCRIPTION	MATERIAL	M.E.S.C. NO.
169	PACK	4 x 140 mm	CABLE TIES, 12/BLACK	NYLON	68.80.50.942.9
188	m	ID = 2mm	SLEEVING, GREEN	PVC	68.85.10.504.1

AREA : NIMR		SCALE : — 0 1 2 3 4 5 6 7		CAD DRAWING				
SUB AREA : NIMR SLUDGE PIT		No. 05		 شركة تنمية نفط عُمان Petroleum Development Oman				
DRWG.TYPE : INST. CABLE & PIPING INSTALLATION DETAILS		DRWG AREA ENG SERIAL SHEET PROJ DWG REV. CODE SECT NUMBER SIZE CODE SIZE		NO NIM 5 4738 030 DQ 4 A				
DESCRIPTION : INST. CABLE CORE MARKERS/LOOMING/SLEEVING								



NOTES

1. CABLE GLAND GRIPPING ON ARMOURING; CONTINUITY BY GLAND PLATE.
2. POHL SCHELLEN GRIPPING ON ARMOURING. POHL SCHELLEN CONNECTED TO FRAME.
3. SAFETY EARTH IN CONTROL BUILDING SHALL BE A RING SYSTEM.
4. INSTRUMENT HOUSINGS EARTHED VIA MOUNTING HARDWARE
5. BETWEEN THESE CABINETS CONNECT SCREEN OF CABLE ON ONE SIDE TO ISOLATED INSTRUMENT EARTH BAR ONLY.
6. METAL J.B. ENCLOSURES EARTHED VIA SUPPORTS.
7. GLAND CONTINUITY PLATE OF GRP ENCLOSURES TO BE CONNECTED TO SUPPORT USING A THREADED SOCKET IN JB.

AREA : NIMR

SUB AREA : NIMR SLUDGE PIT

NO. 05

DRWG. TYPE : INST. CABLE & PIPING INSTALLATION DETAILS

DESCRIPTION : INST. EARTHING DETAILS

SCALE : — CAD DRAWING




شركة تنمية نفط عُمان

Petroleum Development Oman


DRWG	AREA CODE	ENG SECT	SERIAL NUMBER	SHEET	PROJ CODE	DWG SIZE	REV.
NO	NIM	5	4738	031 DQ	4	A	



WorleyParsons-Arabian Industries (JV) Contract No.: C31/0606 Job No.: PAIP00405

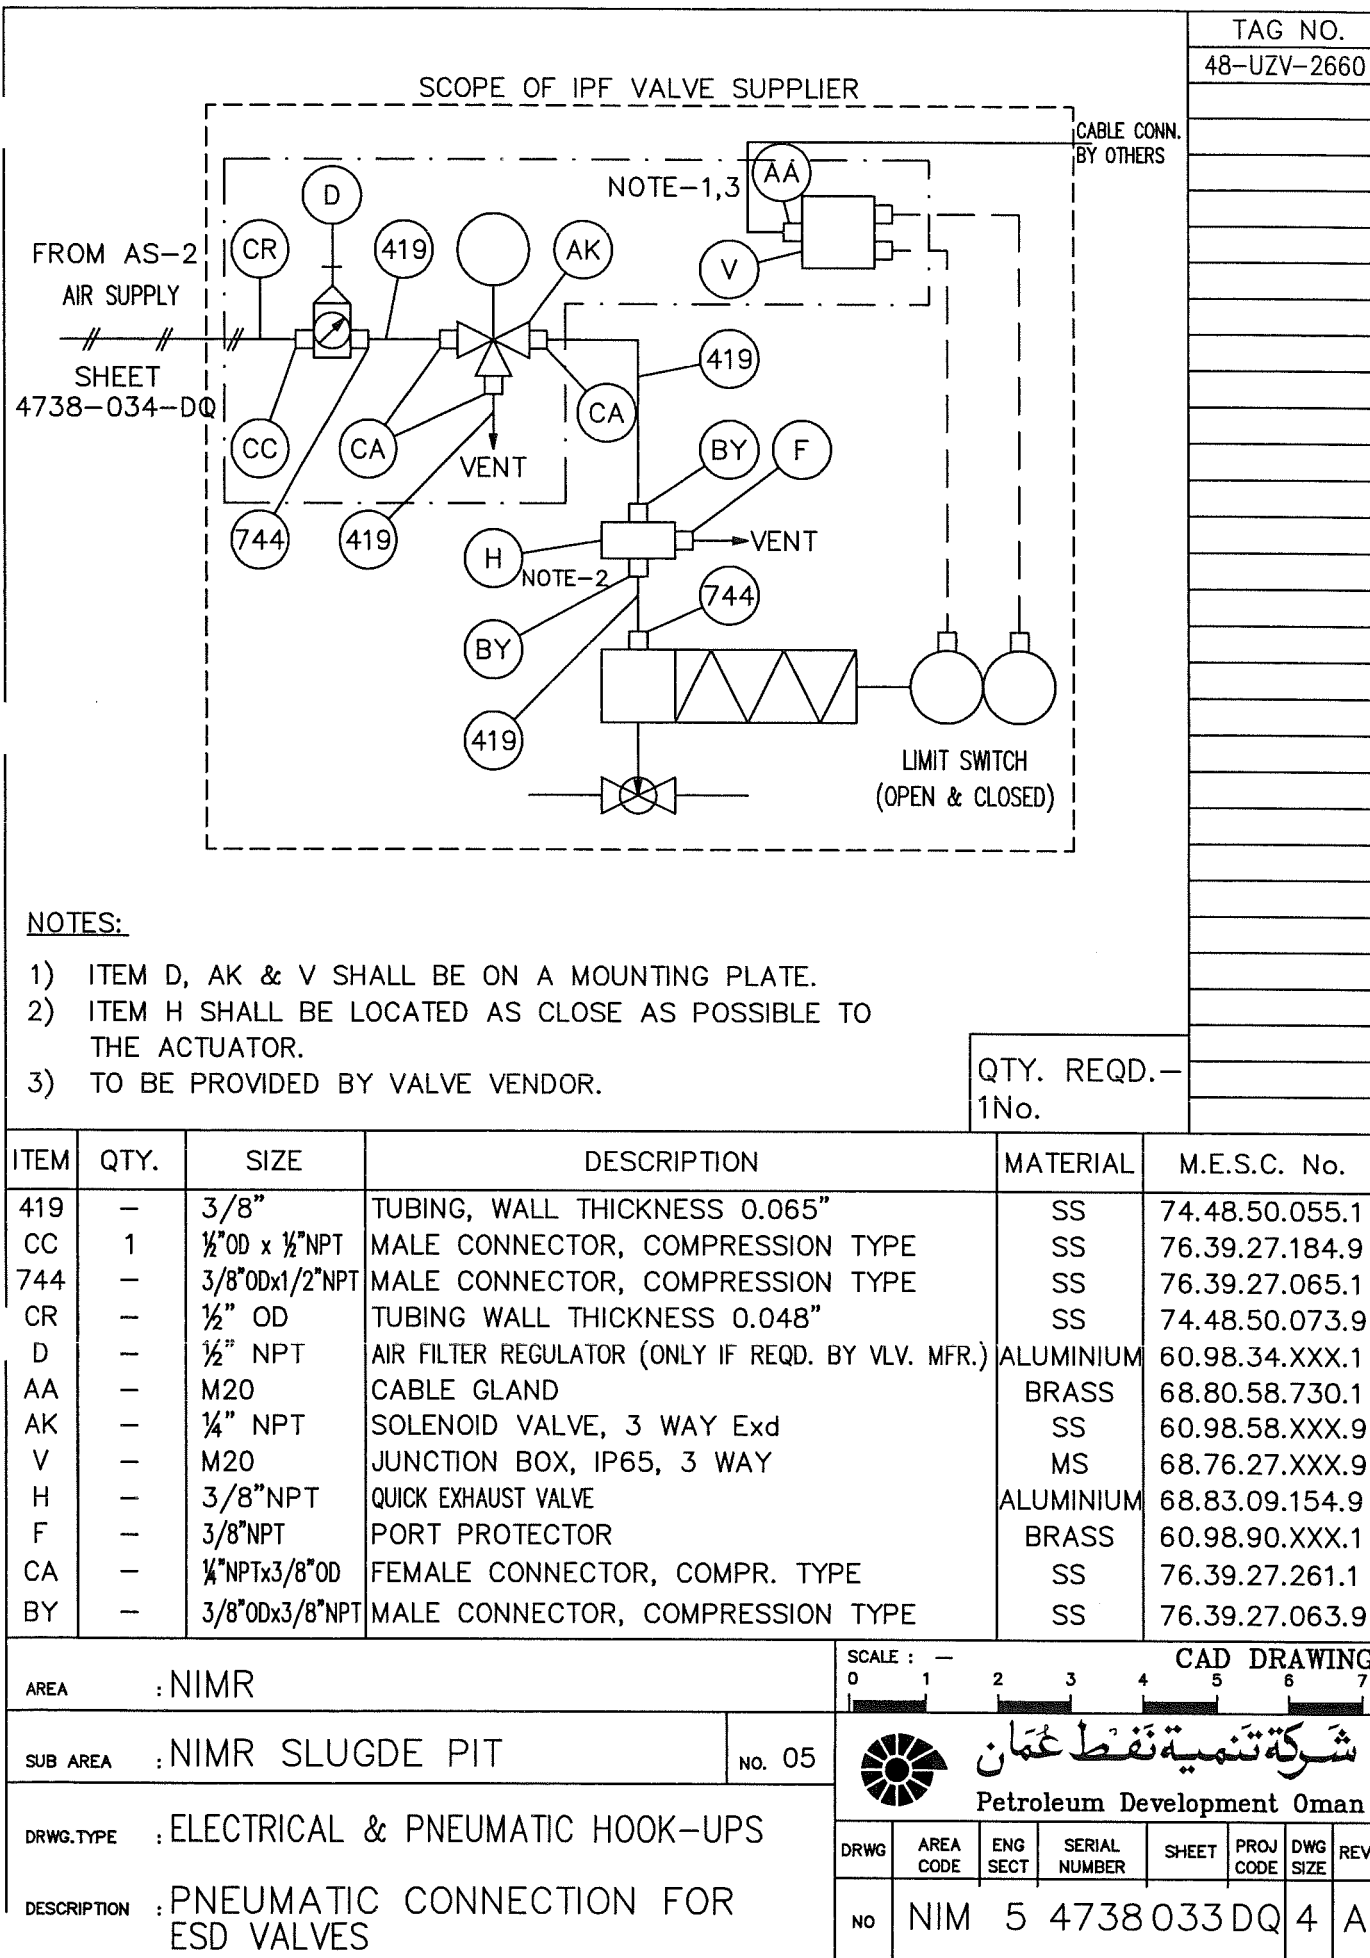

TAG NO.
48-UZV-2660

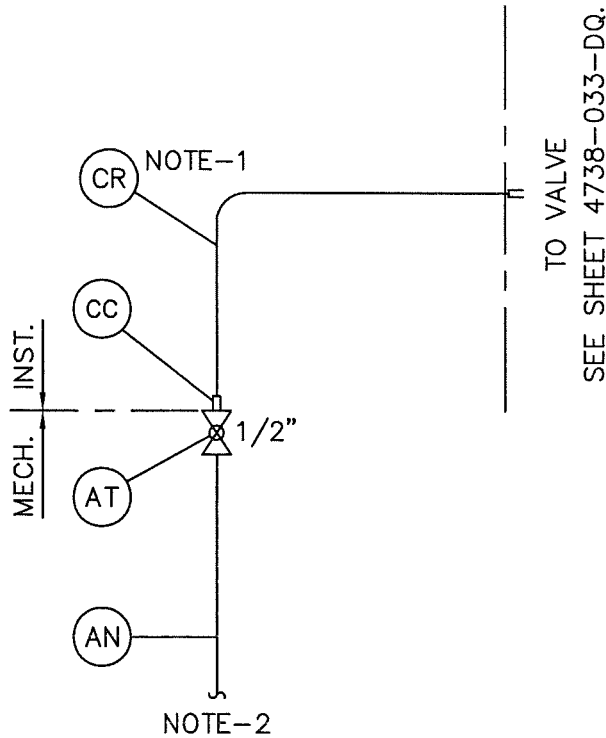

TO VALVE
SEE SHEET 4738-033-DQ.


NOTES:

- 1) TO BE KEPT AS SHORT AS POSSIBLE.
- 2) CONNECTED TO INSTRUMENT AIR SUB HEADER.
- 3) FOR IPF VALVES FILTER/REGULATOR
OR FILTER NOT REQUIRED (SCOPE OF IPF VALVE MFR.)
- 4) BY MECHANICAL.

QTY. REQD.-
1 No.


ITEM	QTY	SIZE	DESCRIPTION	MATERIAL	M.E.S.C.
AN		1/2" (NOTE-4)	LINE PIPE SCH.40	GALV.ST.	74.13.08.016.1
CR	4M	1/2" OD	TUBING WALL THICKNESS 0.048"	S.S.	74.48.50.073.1
AT	1	1/2" NPT(NOTE-4)	BALL VALVE SCREWED 800#	C.S.	77.01.00.003.1
CC	1	1/2" NPT x 1/2" OD	MALE CONNECTOR COMPRESSION TYPE	S.S.	76.39.27.152.9

FOR ITEM CODES REFER STD-5-0811-010/015

AREA : NIMR	SCALE : — 0 1 2 3 4 5 6 7	CAD DRAWING
SUB AREA : NIMR SLUDGE PIT	NO. 05	 شركة تنمية نفط عُمان Petroleum Development Oman
DRWG. TYPE : ELECTRICAL & PNEUMATIC HOOK-UPS	DRWG	AREA CODE
DESCRIPTION : AIR SUPPLY DETAIL AS-2 IPF VALVES (40-1000 kPa)	ENG SECT	SERIAL NUMBER
	NO	SHEET
	NIM 5 4738034DQ	PROJ CODE
		DWG SIZE
		REV.
		4 A



TAG NO.
48-UZV-2660

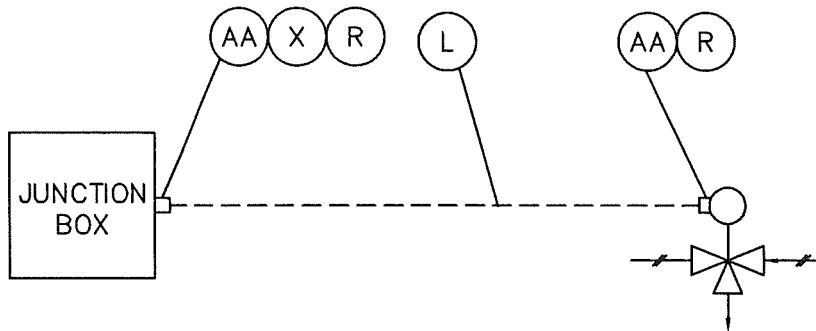


NOTES:

- 1) MATERIALS TO BE PROCURED AS REQUIRED BY SITE CONTRACTOR.
- 2) FOR CABLE QUANTITY REFER CABLE SCHEDULE, DWG. No. NIM-5-5044-DQ

QTY. REQD.-
1 No.

ITEM	QTY	SIZE	DESCRIPTION	MATERIAL	M.E.S.C.
L	NOTE-2	2 x 2.5Sq.mm	CABLE, XLPEI-SWA-PVCS: BLACK	-	XX.XX.XX.XXX.X
R	NOTE-1	19 ~ 6 mm	CABLE SHRINK ON SLEEVE (BLACK)	POLYOLEFIN	XX.XX.XX.XXX.X
X	1	M20	LOCK NUT	BRASS	68.80.58.068.9
AA	2	M20	CABLE GLAND	BRASS	68.80.58.730.1

AREA : NIM		SCALE : — 0 1 2 3 4 5 6 7								CAD DRAWING									
SUB AREA : NIMR SLUDGE PIT		no. 05		 شركة تنمية نفط عُمان Petroleum Development Oman															
DRWG. TYPE : ELECTRICAL & PNEUMATIC HOOK—UPS				DRWG		AREA CODE		ENG SECT		SERIAL NUMBER		SHEET		PROJ CODE		DWG SIZE		REV.	
DESCRIPTION : HOOK—UP DETAILS SOLENOID VALVE				NO		NIM		5		4738		041 DQ		4		A			



TAG NO.

48-LIZA-1448

48-LIA-1447

48-LIZA-1451


48-LIA-1452

48-PIZA-1516

48-PDIA-1520

48-PDIA-1521

48-PDIZA-1523

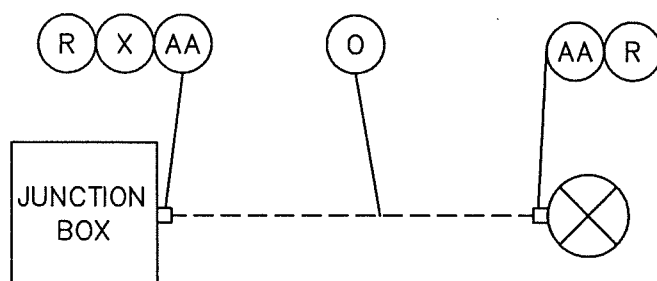NOTES:

- 1) MATERIALS TO BE PROCURED AS REQUIRED BY SITE CONTRACTOR.
- 2) FOR CABLE QUANTITY REFER CABLE SCHEDULE, DWG. No. NIM-5-5044-DQ

QTY. REQD.:
8 Nos.

ITEM	QTY	SIZE OR CONNECTION	DESCRIPTION	MATERIAL	M.E.S.C.
O	NOTE-2	2 x 2 x 1.13mm	CABLE, XLPEI-MS-SWA-PVCS: BLACK	—	XX.XX.XX.XXX.X
R	NOTE-1	19 ~ 6 mm	CABLE SHRINK ON SLEEVE (BLACK)	POLYOLEFIN	XX.XX.XX.XXX.X
X	1	M20	LOCK NUT	BRASS	68.80.58.068.9
AA	2	M20	CABLE GLAND	BRASS	68.80.58.730.1

AREA : NIMR

SCALE : —
0 1 2 3 4 5 6 7 CAD DRAWING

SUB AREA : NIMR SLUDGE PIT

NO. 05




شركة تنمية نفط عُمان
Petroleum Development Oman

DRWG. TYPE : ELECTRICAL & PNEUMATIC HOOK-UPS

DRWG	AREA CODE	ENG SECT	SERIAL NUMBER	SHEET	PROJ CODE	DWG SIZE	REV.
NO	NIM	5	4738	042	DQ	4	A

DESCRIPTION : HOOK-UP DETAILS
TRANSMITTERS

WorleyParsons-Arabian Industries (JV) Contract No.: C31/0606 Job No.: PAIP00405

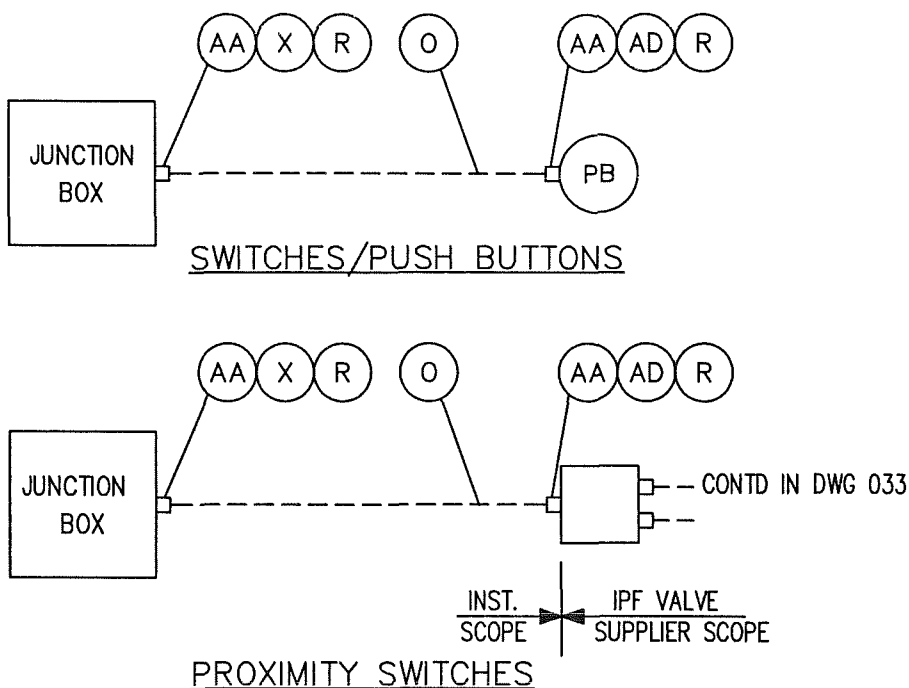

NOTES:

- 1) MATERIALS TO BE PROCURED AS REQUIRED BY SITE CONTRACTOR
- 2) FOR CABLE QUANTITY REFER CABLE SCHEDULE, DWG. No. NIM-5-5044-DQ.

TAG NO.
48-HS-2219
48-HS-2658
48-HS-2220
48-HS-2660
48-GBS-2660
48-HS-2230

QTY. REQD.-
6 Nos.

ITEM	QTY	SIZE	DESCRIPTION	MATERIAL	M.E.S.C.
O	NOTE-2	2 x 2 x 1.13mm	CABLE, XLPEI-MS-SWA-PVCS; BLACK	-	XX.XX.XX.XXX.X
R	NOTE-1	19 ~ 6mm	CABLE SHRINK ON SLEEVE (BLACK)	POLYOLEFIN	XX.XX.XX.XXX.X
X	1	M20	LOCK NUT	BRASS	68.80.58.068.1
AA	2	M20	CABLE GLAND	BRASS	68.80.58.730.1
AD	1	M20	ADAPTER FOR CABLE GLAND	BRASS	68.80.58.802.9


AREA : NIMR	SCALE : — 0 1 2 3 4 5 6 7	CAD DRAWING
SUB AREA : NIMR SLUDGE PIT	NO. 05	شركة تنمية نفط عُمان Petroleum Development Oman
DRWG. TYPE : ELECTRICAL & PNEUMATIC HOOK-UPS	DRWG	AREA CODE
DESCRIPTION : HOOK-UP DETAILS TYPICAL (SWITCHES)	ENG SECT	SERIAL NUMBER
	NO	SHEET
	NIM 5 4738 043 DQ	PROJ CODE
		DWG SIZE
		REV.
		4 A



TAG NO.

48-XZA-2342


48-XZA-2343

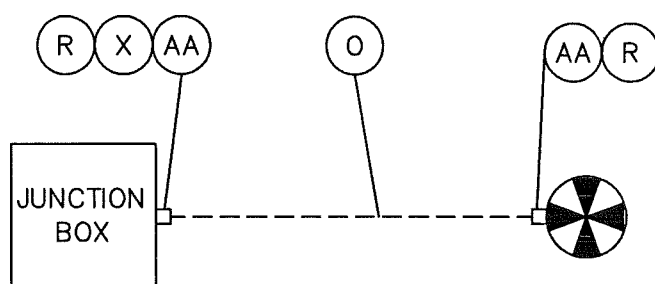**NOTES:**


- 1) MATERIALS TO BE PROCURED AS REQUIRED BY SITE CONTRACTOR.
- 2) FOR CABLE QUANTITY REFER CABLE SCHEDULE, DWG. No. NIM-5-5044-DQ.

QTY. REQD.-
2 Nos.



ITEM	QTY	SIZE OR CONNECTION	DESCRIPTION	MATERIAL	M.E.S.C.
O	NOTE-2	2 x 2 x 1.13mm	CABLE, XLPEI-MS-SWA-PVCS; BLACK	-	XX.XX.XX.XXX.X
R	NOTE-1	19 ~ 6 mm	CABLE SHRINK ON SLEEVE (BLACK)	POLYOLEFIN	XX.XX.XX.XXX.X
X	1	M20	LOCK NUT	BRASS	68.80.58.068.9
AA	2	M20	CABLE GLAND	BRASS	68.80.58.730.1


AREA : NIMR		SCALE : — 0 1 2 3 4 5 6 7		CAD DRAWING					
SUB AREA : NIMR SLUDGE PIT		NO. 05		 شركة تنمية نفط عُمان Petroleum Development Oman					
DRWG. TYPE : ELECTRICAL & PNEUMATIC HOOK-UPS		DRWG	AREA CODE	ENG SECT	SERIAL NUMBER	SHEET	PROJ CODE	DWG SIZE	REV.
DESCRIPTION : HOOK-UP DETAILS HEAT DETECTOR		NO	NIM	5	4738045	DQ	4	A	

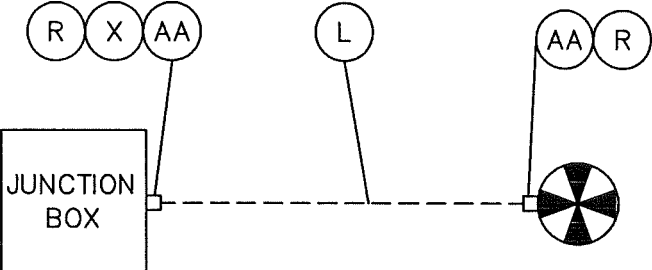

	TAG NO.	
	48-XA-4106	
	<p>NOTES:</p> <p>1) MATERIALS TO BE PROCURED AS REQUIRED BY SITE CONTRACTOR.</p> <p>2) FOR CABLE QUANTITY REFER CABLE SCHEDULE, DWG. No. NIM-5-5044-DQ.</p>	QTY. REQD. - 1 No.


ITEM	QTY	SIZE OR CONNECTION	DESCRIPTION	MATERIAL	M.E.S.C.
L	NOTE-2	2 x 2.5 Sq.mm	CABLE, XLPEI-PVCS; BLACK	—	XX.XX.XX.XXX.X
R	NOTE-1	19 ~ 6 mm	CABLE SHRINK ON SLEEVE (BLACK)	POLYOLEFIN	XX.XX.XX.XXX.X
X	1	M20	LOCK NUT	BRASS	68.80.58.068.9
AA	2	M20	CABLE GLAND	BRASS	68.80.58.730.1


AREA : NIMR		SCALE : — 																	
SUB AREA : NIMR SLUDGE PIT		CAD DRAWING  شركة تنمية نفط عُمان Petroleum Development Oman																	
DRWG. TYPE : ELECTRICAL & PNEUMATIC HOOK-UPS		<table border="1" style="width: 100%; border-collapse: collapse;"> <tr> <th>DRWG</th><th>AREA CODE</th><th>ENG SECT</th><th>SERIAL NUMBER</th><th>SHEET</th><th>PROJ CODE</th><th>DWG SIZE</th><th>REV.</th></tr> <tr> <td>NO</td><td>NIM</td><td>5</td><td>4738</td><td>046</td><td>DQ</td><td>4</td><td>A</td></tr> </table>		DRWG	AREA CODE	ENG SECT	SERIAL NUMBER	SHEET	PROJ CODE	DWG SIZE	REV.	NO	NIM	5	4738	046	DQ	4	A
DRWG	AREA CODE	ENG SECT	SERIAL NUMBER	SHEET	PROJ CODE	DWG SIZE	REV.												
NO	NIM	5	4738	046	DQ	4	A												
DESCRIPTION : HOOK-UP DETAILS HOOTER																			

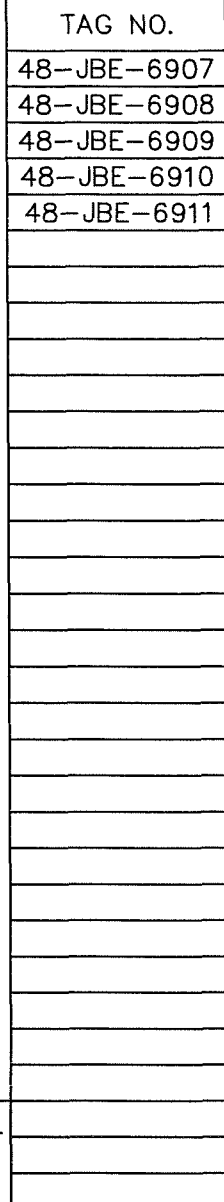

QTY. REQD.—
5 Nos.

ITEM	QTY	SIZE	DESCRIPTION	MATERIAL	M.E.S.C.
AB	2	M25	CABLE GLAND	BRASS	68.80.58.734.1
Y	2	M25	LOCK NUT	BRASS	68.80.58.072.1
P	NOTE-1	10x2x0.8mm	CABLE XLPEI-MS-SWA-PVCS; BLACK	—	XX.XX.XX.XXX.X

AREA : NIMR		SCALE : — 0 1 2 3 4 5 6 7		CAD DRAWING																				
SUB AREA : NIMR SLUGDE PIT		No. 05		 شَرِكَةُ تَمْدِيةِ نَفْطِ عُومَانِ Petroleum Development Oman																				
DRWG. TYPE : ELECTRICAL & PNEUMATIC HOOK-UPS		<table border="1"> <tr> <th>DRWG</th> <th>AREA CODE</th> <th>ENG SECT</th> <th>SERIAL NUMBER</th> <th>SHEET</th> <th>PROJ CODE</th> <th>DRWG SIZE</th> <th>REV.</th> </tr> <tr> <td>NO</td> <td>NIM</td> <td>5</td> <td>4738048</td> <td>DQ</td> <td>4</td> <td>A</td> <td></td> </tr> </table>							DRWG	AREA CODE	ENG SECT	SERIAL NUMBER	SHEET	PROJ CODE	DRWG SIZE	REV.	NO	NIM	5	4738048	DQ	4	A	
DRWG	AREA CODE	ENG SECT	SERIAL NUMBER	SHEET	PROJ CODE	DRWG SIZE	REV.																	
NO	NIM	5	4738048	DQ	4	A																		
DESCRIPTION : HOOK-UP DETAILS TYPICAL JUNCTION BOX																								

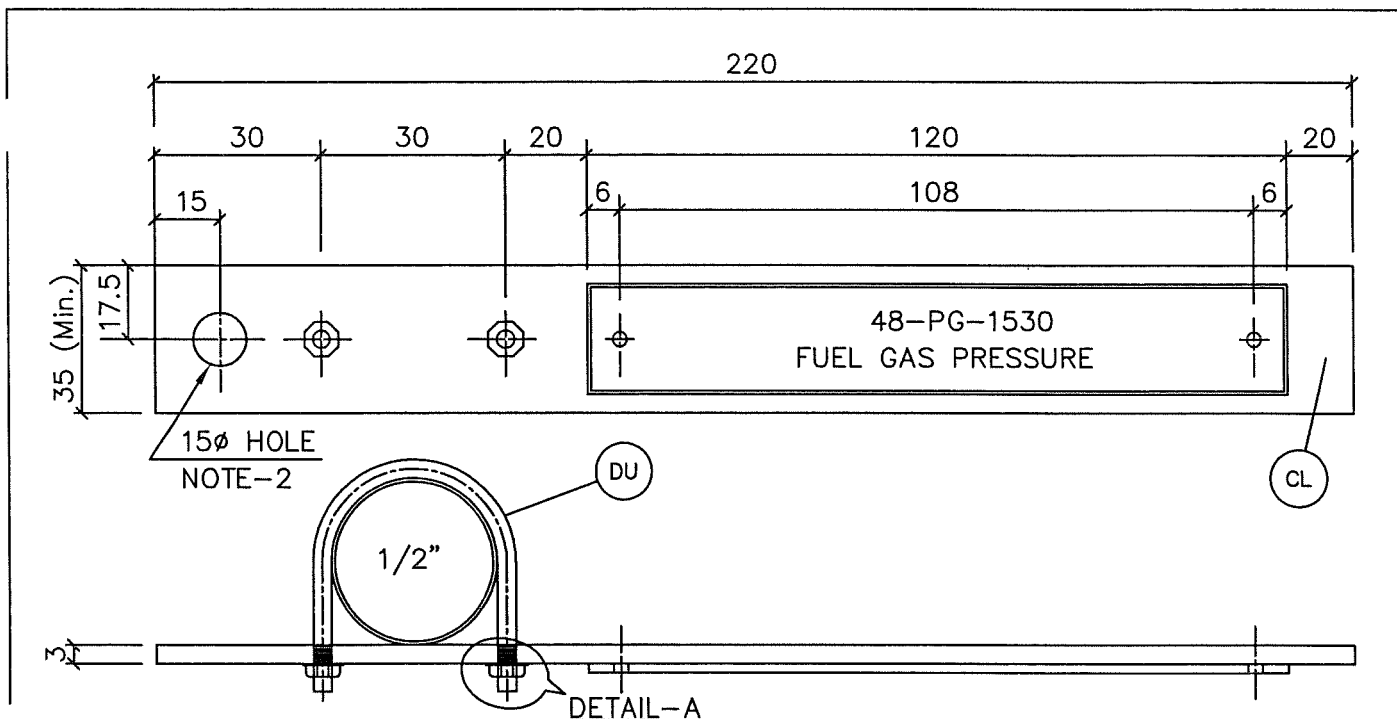

MATERIAL : LAMINATED PLASTIC WHITE/BLACK/WHITE
OF NAMEPLATE 3mm THICK

ENGRAVING : REFER TO STANDARD DWG S37.601 TYPE 1

FIXING : NAMEPLATES TO BE FIXED TO TAILOR-MADE BRACKET ON
1/2" PIPING NOZZLE WITH BRASS SCREWS, FLAT ENDED,
RECESSED PAN HEAD, WITH WASHER & NUTS.


PAINTING : PAINTING & COATING SHALL BE DONE AS PER ERD-48-01

QTY. REQD.-
13 Nos.


ITEM	QTY	SIZE OR CONNECTION	DESCRIPTION	MATL.	M.E.S.C.
DU	1	M8	U-BOLT COMBINED WITH NUTS & SPRING WASHER	AISI 316	81.26.86.022.9
CL	0.0008	200x35x3mm THK	STEEL PLATE	MS	78.43.30.108.1

NOTES

1. ALL DIMENSIONS ARE IN MM
2. USED ONLY FOR INLINE INSTRUMENTS WITHOUT CABLE CONDUIT

AREA : NIMR		SCALE : 0 1 2 3 4 5 6 7		CAD DRAWING	
SUB AREA : NIMR SLUDGE PIT		NO. 05		 شركة تنمية نفط عُمان Petroleum Development Oman	
DRWG. TYPE : INSTRUMENT IMPULSE LINE		DESCRIPTION : TAG PLATE (1/2" PROCESS CONNECTION)		DRWG NO	AREA CODE NIM
				ENG SECT 5	SERIAL NUMBER 4738
				SHEET 091DQ	PROJ CODE 4
				DWG SIZE A	REV.



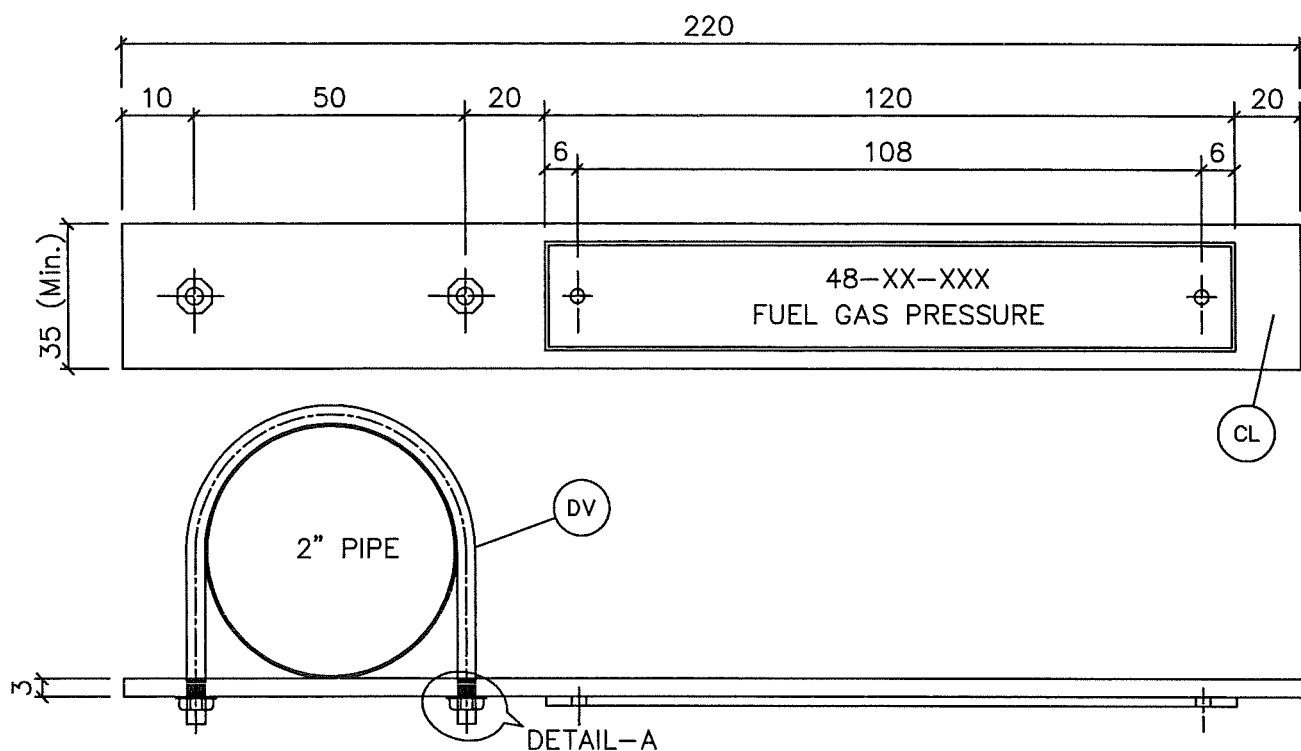


MATERIAL : LAMINATED PLASTIC WHITE/BLACK/WHITE
OF NAMEPLATE 3mm THICK

ENGRAVING : REFER TO S37.601 TYPE 1

FIXING : NAMEPLATES TO BE FIXED TO TAILOR-MADE BRACKET ON
2" INST. SUPPORT PIPE WITH BRASS SCREWS, FLAT ENDED,
RECESSED PAN HEAD, WITH WASHER & NUTS.

PAINTING : PAINTING & COATING SHALL BE DONE AS PER ERD PDO-48-01

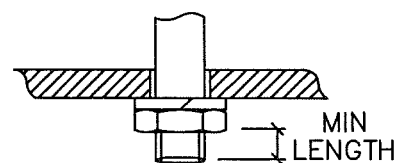


DETAIL-A



ITEM	QTY	SIZE OR CONNECTION	DESCRIPTION	MATL.	QTY. REQD.- 30 Nos.
DV	1	M10	U-BOLT COMBINED WITH NUTS & SPRING WASHER	AISI 316	81.26.86.040.9
CL	0.008 SQ.M	220x35x3mm THK	STEEL PLATE	MS	78.43.30.108.1


ALL DIMENSIONS ARE IN MM

AREA : NIMR	SCALE : — 0 1 2 3 4 5 6 7	CAD DRAWING
SUB AREA : NIMR SLUDGE PIT	NO. 05	شركة تنمية نفط عُمان Petroleum Development Oman
DRWG. TYPE : INST. IMPULSE LINES/ELECTRO PNEU. HOOK-UPS	DRWG	AREA CODE
DESCRIPTION : TAG PLATE 2" INSTR. PIPE SUPPORT	ENG SECT	SERIAL NUMBER
	NO	SHEET
	NIM	PROJ CODE
	5	DWG SIZE
	4738	REV.
	092DQ	4
		A

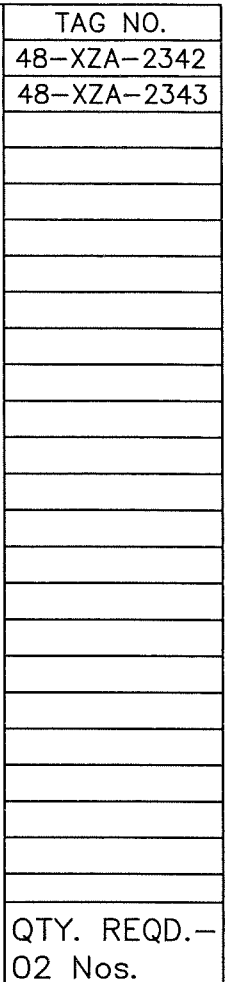




AREA : NIMR		SCALE : —		CAD DRAWING	
SUB AREA : NIMR SLUDGE PIT		NO. 05			
DRWG. TYPE : INST. CABLE & PIPING INSTALLATION DETAILS		 شركة تنمية نفط عُمان Petroleum Development Oman		DRWG AREA ENG SERIAL SHEET PROJ DWG REV. CODE CODE SECT NUMBER SIZE CODE SIZE	
DESCRIPTION : INSTRUMENT SUPPORT FOR HEAT DETECTOR				NO NIM 5 4738 100 DQ 4 A	

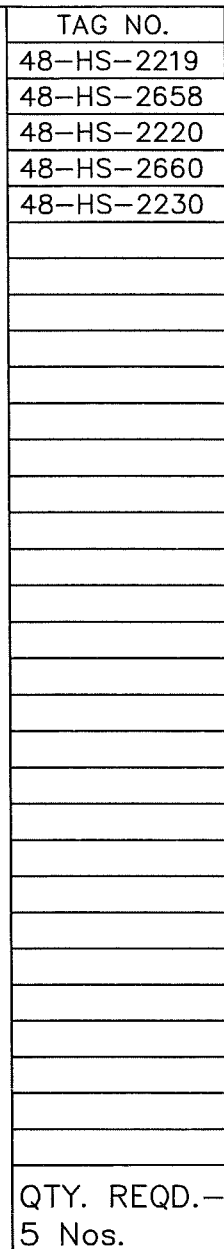

ITEM	QTY.	SIZE	DESCRIPTION	MATERIAL	M.E.S.C. NO.
AP	1.9 m	2"	LINE PIPE SCH. 40	CS	
BP	1	2"	CAP BUTT WELDING	CS	70.30.18.608.1
CJ	0.225 m	50x6mm THICK	FLAT BAR	MS	78.39.02.121.1
302	1.5 m	25mm DIA	HEAVY GAUGE CONDUIT	GALV. STEEL	70.13.04.025.1
CL	0.040SQ.m	3mm THICK	STEEL PLATE (200x200mm)	MS	78.43.30.108.1

AREA : NIMR		SCALE : — 0 1 2 3 4 5 6 7		CAD DRAWING					
SUB AREA : NIMR SLUDGE PIT		NO. 05		 شركة تنمية نفط عُمان Petroleum Development Oman					
DRWG. TYPE : INST. CABLE & PIPING INSTALLATION DETAILS		DRWG	AREA CODE	ENG SECT	SERIAL NUMBER	SHEET	PROJ CODE	DWG SIZE	REV
DESCRIPTION : MOUNTING SUPPORT TYPE—S3 FOR UNPAVED AREA (RESET SWITCH)		NO	NIM	5	4738	102	DQ	4	A



I.C.T.D.

JUNCTION BOXES

SCOPE OF 'DQ' PROJECT
WBS NO.: NIM.IN.09.011

APPROVED FOR
CONSTRUCTION

A	MAR.'11	KK			APPROVED FOR CONSTRUCTION	IN.09.011	OSE/23N	
0	DEC.'10	NS	PT	KDA	ISSUED FOR COMMENTS	IN.09.011	OSE/23N	IN
REV	DATE	DRAWN BY	TEAML	J.ENG.	DESCRIPTION	WBS No.	PROJ. ENG.	SIGNATURE
			CHECKED				P D O APPROVAL	

PROJECT DRAWING REVISION

IN CASE OF DEVIATIONS A MARKED UP PRINT SHALL BE SENT TO THE PROJECT ENGINEER

M	NOV.'08	ASD			AS BUILT UP TO NOV.'08	0T.08.005	OSO/22N	SK
L	APR.05	DOI			AS BUILT FOR PROJECT '5X'	02.001		BW
K	JAN.05	DOI			AS BUILT FOR PROJECT '3Y & X4'	00.394/95.052		BW
J	DEC.04				AS BUILT FOR PROJECT '5R'	01.116	OSE/24N	
H	DEC.04	DOI			AS BUILT FOR PROJECT '5V'	02.002		BW
G	JUNE.02	MAX			AS BUILT FOR PROJECT 7G		OME/13	
O	10/85	GT			ORIGINAL ISSUE	-	-	
REV	DATE	DRAWN BY	TEAML	J.ENG.	DESCRIPTION	B.I. NO	PROJ. ENG.	SIGNATURE
			CHECKED				P D O APPROVAL	


MASTER DRAWING REVISION

IN CASE OF DEVIATIONS A MARKED UP PRINT SHALL BE SENT TO COASTAL DESIGN OFFICE

AREA	: NIMR	SCALE : —	CAD DRAWING
SUB AREA	: PRODUCTION STION	0 1 2 3 4 5 6 7	
DRWG. TYPE	: I.C.T.D.		شركة تنمية نفط عُمان Petroleum Development Oman
DESCRIPTION	: JUNCTION BOXES FRONT SHEET	DRWG	AREA CODE
		ENG SECT	SERIAL NUMBER
		SHEET	PROJ CODE
		DWG SIZE	REV.
		NO	NIM 5 5043 001 DQ 4 A




SHEET NO.	JUNCTION BOX DESCRIPTION	DATE OF ISSUE / REVISION LETTER															
		O	Z	A	B	C	H	J	K	L	M	O	A	B	C		
001	FRONT SHEET	10/85	03/00	03/00	06/00	09/00	DEC.04	DEC.04	JAN.05	APR.05	NOV.'08	DEC.'10	MAR.'11				
002	INDEX/ REV SHT	10/85	03/00	03/00	06/00	09/00	DEC.04	DEC.04	JAN.05	APR.05	NOV.'08	DEC.'10	MAR.'11				
003	INDEX/ REV SHT	10/85				09/00			JAN.05			DEC.'10	MAR.'11				
004	INDEX/ REV SHT	10/85	03/00	03/00					JAN.05								
005	INDEX/ REV SHT	10/95			06/00	09/00			JAN.05	APR.05							
006	INDEX/ REV SHT	05/86	03/00	03/00	06/00	09/00	DEC.04		JAN.05	APR.05	NOV.'08						
007	INDEX/ REV SHT									APR.05							
008	INDEX/ REV SHT					09/00				APR.05							
009	INDEX/ REV SHT							DEC.04			NOV.'08						
010	INDEX/ REV SHT				06/00		DEC.04		JAN.05	APR.05	NOV.'08						
10A	INDEX/ REV SHT	08/00					DELETED										
011	48-JBE-11	10/85															
012	48-JBE-12	10/85															
013	48-JBE-13	10/85															
014	48-JBE-14	10/85															
015	48-JBE-15	10/85															
016	48-JBE-16	10/85															
017	48-JBE-17	10/85															
018	48-JBE-18	10/85															
019	48-JBE-19	10/85															
020	48-JBE-20	10/85															
021	48-JBE-21	10/85															
022	48-JBE-22	10/85															
023	48-JBE-23	10/85															
024	48-JBE-24	10/85															
025	48-JBE-25	10/85															
026	48-JBE-26	10/85															
027	48-JBE-27	10/85				09/00			JAN.05								
028	48-JBE-28 (SPARE)	10/85															
029	48-JBE-29	10/85															
030	48-JBE-30	10/85															
031	48-JBE-31	10/85															
032	48-JBE-32	10/85															
33	48-JBE-33	10/85							JAN.05								
034	48-JBE-34	10/85										DEC.'10	MAR.'11				
035	48-JBE-35	10/85							JAN.05								
036	48-JBE-36	10/85							JAN.05								
037	48-JBE-37	10/85							JAN.05								
038	48-JBE-38	10/85															
039	48-JBE-39	10/85															
040	48-JBE-40	10/85															

AREA : NIMR		SCALE : — 0 1 2 3 4 5 6 7		CAD DRAWING																	
SUB AREA : PRODUCTION STATION		No. 05		 شركة تنمية نفط عمان Petroleum Development Oman																	
DRWG. TYPE : I.C.T.D.				<table> <tr> <th>DRWG</th> <th>AREA CODE</th> <th>ENG SECT</th> <th>SERIAL NUMBER</th> <th>SHEET</th> <th>PROJ CODE</th> <th>DWG SIZE</th> <th>REV.</th> </tr> <tr> <td>NO</td> <td>NIM</td> <td>5</td> <td>5043002</td> <td>DQ</td> <td>4</td> <td>A</td> <td></td> </tr> </table>		DRWG	AREA CODE	ENG SECT	SERIAL NUMBER	SHEET	PROJ CODE	DWG SIZE	REV.	NO	NIM	5	5043002	DQ	4	A	
DRWG	AREA CODE	ENG SECT	SERIAL NUMBER	SHEET	PROJ CODE	DWG SIZE	REV.														
NO	NIM	5	5043002	DQ	4	A															
DESCRIPTION : JUNCTION BOX INDEX AND REVISION SHEET																					

SHEET NO.	JUNCTION BOX DESCRIPTION	DATE OF ISSUE / REVISION LETTER													
		O	C	D	E	F	G	H*	R	S	T	O	A	B	C
041	48-JBE-41 (VENDOR)	10/85													
042	48-JBE-42 (VENDOR)	10/85													
043	48-JBE-43 (VENDOR)	10/85													
044	SPARE														
045	48-JBE-45	10/85										DEC.'10	MAR.'11		
046	48-JBE-46	10/85						12/04							
047	48-JBE-47	10/85						12/04							
048	48-JBE-48	10/85						12/04		10/97					
049	SPARE	10/85													
050	48-JBE-50	10/85													
051	48-JBE-51	10/85													
052	48-JBE-52	10/85										DEC.'10	MAR.'11		
053	48-JBE-53	10/85													
054	48-JBE-54	10/85													
055	48-JBE-55	10/85													
056	48-JBE-56	10/85													
057	48-JBE-57	10/85													
058	48-JBE-58	10/85	10/00												
059	48-JBE-59	10/85													
060	48-JBE-60	10/85													
061	48-JBE-61	10/85								10/97					
062	48-JBE-62	10/85													
063	48-JBE-63	10/85													
064	48-JBE-64	10/85													
065	48-JBE-65	10/85													
066	48-JBE-66	10/85													
067	48-JBE-67	10/85													
068	48-JBE-68	10/85									10/97				
069	48-JBE-69	10/85									10/97				
070	48-JBE-70	10/85													
071	48-JBE-71	10/85	10/00												
072	48-BSP-001 (VENDOR)	10/85													
073	48-BSP-002 (VENDOR)	10/85													
074	48-BSP-003 (VENDOR)	10/85													
075	SPARE														
076	SPARE														
077	SPARE														
078	SPARE														
079	SPARE														
080	48-JBE-80	10/85													


* LATEST REVISION IS 'H' DEC. 04

AREA : NIMR		SCALE : — 0 1 2 3 4 5 6 7		CAD DRAWING	
SUB AREA : PRODUCTION STATION		NO. 05		 شركة تنمية نفط عُمان Petroleum Development Oman	
DRWG. TYPE : I.C.T.D.				DRWG AREA ENG SERIAL SHEET PROJ DWG REV. CODE SECT NUMBER CODE SIZE	
DESCRIPTION : JUNCTION BOX INDEX AND REVISION SHEET				NO NIM 5 5043 003 DQ 4 A	



TAG NUMBER	EQUIPMENT CONNECTION	EXT. CABLE No.&SIZE	CORE	TERMINAL	MULTICORE CABLE No.	CORE
		TYPE			TYPE	
					SIZE	
					CONNECTED TO	
48--						
PDZA-212	P 4817	48-E-412, 1x4x1.2	R & B W & O	1 2	48-E-124 PVC1-MS-SWA-PVCS 5x4x0.8 SDE-002 STRIP A181-200	1 R 1 B
HS-028		48-E-413, 1x4x1.2	R & B W & O	3 4		1 W 1 ø
PZA-106		48-E-414, 1x4x1.2	R & B W & O	5 6		2 R 2 B
PZA-105		48-E-415, 1x4x1.2	R & B W & O	7 8		2 W 2 ø
PZA-107		48-E-416, 1x4x1.2	R & B W & O	9 10		3 R 3 B
SPARE				11 12		3 W 3 ø
PDIZA-1523	+ -	E-2736 2x2x1.13mm XLPE1-MS-SWA-PVCS	BK+B G+BN	13 14		4 R 4 B
SPARE				15 16		4 W 4 ø
				17 18		5 R 5 B
				19 20		5 W 5 ø


NOTE: SCREENS CONNECTED TO AN ISOLATED EARTH BAR

AREA : NIMR		SCALE : 0 1 2 3 4 5 6 7		CAD DRAWING	
SUB AREA : PRODUCTION STATION		NO. 05		 شركة تنمية نفط عُمان Petroleum Development Oman	
DRWG. TYPE : INST. CABLE TERMINATION DETAILS		DRWG		AREA CODE	ENG SECT
DESCRIPTION : 48-JBE-34		SERIAL NUMBER		SHEET	PROJ CODE
		NO		DWG SIZE	REV.
		NIM 5 5043034 DQ		4	A



TAG NUMBER	EQUIPMENT CONNECTION	EXT. CABLE No.&SIZE	CORE	TERMINAL	MULTICORE CABLE No.	
		TYPE			TYPE	CORE
					SIZE	
					CONNECTED TO	
GBS-791(O)	F-4803	48-E-519, 1x4x1.2	R	1	48-E-135 PVC I-MS-SWA-PVCS 10x4x0.8 SDE-002 STRIP A 001-040	1 R
			B	2		1 B
GBS-791(C)	F-4803	48-E-519, 1x4x1.2	W	3		1 W
			ø	4		1 ø
GBS-792(O)	F-4803	48-E-520, 1x4x1.2	R	5		2 R
			B	6		2 B
GBS-792(C)	F-4803	48-E-520, 1x4x1.2	W	7		2 W
			ø	8		2 ø
PZA-084	F-4803	48-E-505, 1x4x1.2	R & B	9		3 R
			W & ø	10		3 B
PZA-086	F-4803	48-E-506, 1x4x1.2	R & B	11		3 W
			W & ø	12		3 ø
SPARE	F-4803			13		4 R
				14		4 B
SPARE	F-4803			15		4 W
				16		4 ø
SPARE	F-4803			17		5 R
				18		5 B
SPARE	F-4803			19		5 W
				20		5 ø
PZA-072	F-4803	48-E-516, 1x4x1.2	R & B	21		6 R
			W & ø	22		6 B
GBS-794(O)	F-4803	48-E-514, 1x4x1.2	R	23		6 W
			B	24		6 ø
GBS-794(C)	F-4803	48-E-514, 1x4x1.2	W	25		7 R
			ø	26		7 B
GBS-793(O)	F-4803	48-E-515, 1x4x1.2	R	27		7 W
			B	28		7 ø
GBS-793(C)	F-4803	48-E-515, 1x4x1.2	W	29		8 R
			ø	30		8 B
SPARE				31		8 W
				32		8 ø
GBS-2660 (O)	T-4807	48-E-2737 2x2x1.13mm XLPEI-MS-SWA-PVCS	BK	33		9 R
			G	34		9 B
GBS-2660 (C)			B	35		9 W
			BN	36		9 ø
HS-2230	T-4807	48-E-2738 2x2x1.13mm XLPEI-MS-SWA-PVCS	BK+B	37		10 R
			G+BN	38		10 B
SPARE				39		10 W
				40		10 ø


NOTE: SCREENS CONNECTED TO AN ISOLATED EARTH BAR

AREA : NIMR		SCALE : —		CAD DRAWING							
SUB AREA : PRODUCTION STATION		No. 05		 شركة تنمية نفط عُمان Petroleum Development Oman							
DRWG. TYPE : INST. CABLE TERMINATION DETAILS				DRWG	AREA CODE	ENG SECT	SERIAL NUMBER	SHEET	PROJ CODE	DWG SIZE	REV.
DESCRIPTION : 48-JBE-45				NO	NIM 5 5043 045 DQ				4	A	



TAG NUMBER	EQUIPMENT CONNECTION	EXT. CABLE No.&SIZE	CORE	TERMINAL	MULTICORE CABLE No.	CORE
					TYPE	
		TYPE			SIZE	
					CONNECTED TO	
UZ-794	F 4803	48-E-556, 2x2.5	1BK 2B	1 2	48-E-142 PVC I-SWA-PVCS 21x2.5 SDE-002 STRIP-A-381-100	1 2
UZ-793	F 4803	48-E-557, 2x2.5	1BK 2B	3 4		3 4
UZ-792	F 4803	48-E-558, 2x2.5	1BK 2B	5 6		5 6
UZ-791	F 4803	48-E-559, 2x2.5	1BK 2B	7 8		7 8
UZ-797	F 4803	48-E-529, 2x2.5	1BK 2B	9 10		9 10
PICA-083 (SOV)	F 4803	48-E-561, 2x2.5	1BK 2B	11 12		11 12
SPARE				13 14		13 14
UZV-2660	T-4807	48-E-2735 2x2.5Sq.mm XLPEI-SWA-PVCS	1 2	15 16		15 16
SPARE				17 18		17 18
SPARE				19 20		19 20

NOTE: SCREENS CONNECTED TO AN ISOLATED EARTH BAR

AREA : NIMR		SCALE : — 0 1 2 3 4 5 6 7		CAD DRAWING							
SUB AREA : PRODUCTION STATION		NO. 05		 شركة تنمية نفط عُمان Petroleum Development Oman							
DRWG. TYPE : INST. CABLE TERMINATION DETAILS				DRWG	AREA CODE	ENG SECT	SERIAL NUMBER	SHEET	PROJ CODE	DWG SIZE	REV.
DESCRIPTION : 48-JBE-52				NO	NIM 5 5043 052 DQ			4	A		



LIST OF ALARM AND TRIP SETTINGS

1. ALL SET POINTS ARE CONVERTED INTO COUNTS IN TRICONEX PLC SYSTEM.
FOR ANALOG INPUT 0-20mA = 0-4095 COUNTS (4mA = 819 COUNTS).
THIS APPLIES TO DIRECT AND REVERSE SIGNALS.
2. ALL RTD INPUTS ARE 0-600 DEG.C RANGE. 1 DEG.C = 6.825 COUNTS.

SCOPE OF 'DQ' PROJECT
WBS NO.: NIM.IN.09.011

**APPROVED FOR
CONSTRUCTION**

A	MAR.'11	KK			APPROVED FOR CONSTRUCTION	IN.09.011	OSE/23N	
0	DEC'10	Mrp	PT	KDA	ISSUED FOR COMMENTS	IN.09.011	OSE/23N	
REV	DATE	DRAWN BY	TEAML.	J.ENG.	DESCRIPTION	WBS No.	PROJ. ENG.	SIGNATURE
			CHECKED				P D O APPROVAL	

PROJECT DRAWING REVISION
IN CASE OF DEVIATIONS A MARKED UP PRINT SHALL BE SENT TO THE PROJECT ENGINEER

	G	NOV.'08	ASD	AS BUILT UP TO NOV.'08	0T.08.005	OSO/22N	SK
	F	APR'05		AS BUILT FOR PROJ '5X'	02.001		BW
	E	JAN.05		AS BUILT FOR PROJ. '3Y'	0.394		BW
	D	NOV'04		AS-BUILT FOR PROJ.'5R'	01.116	OSE/24N	
	C	MAR'02		AS BUILT FOR PROJECT '4P'	00.802	OME/41	JAMAL
	A	JUN'01		AS BUILT FOR PROJECT '2W'	99.614	ONE/22	
	Z	JULY'00		AS BUILT FOR PROJECT 2V, 2Y & 2Z	00.826	ONE/23	
	Q	23.1.86		ORIGINAL ISSUE / ISSUE FOR CONSTRUCTION			

REFERENCE TO EQUIPMENT/TAG NUMBERS ARE TO BE PREFIXED BY AREA CODE	REV	DATE	APPROVED BY	DESCRIPTION	B.I.NO.	PROJ.ENG.	SPEC.ENG.
						P D O APPROVAL	

NOTES/REFERENCE DRAWINGS **MASTER DRAWING REVISION**
IN CASE OF DEVIATIONS MARKED UP PRINT SHALL BE SENT TO COASTAL DESIGN OFFICE

AREA : NIMR	SCALE : — 0 1 2 3 4 5 6 7																
SUB AREA : PRODUCTION STATION	 شركة تنمية نفط عُمان Petroleum Development Oman																
DRWG. TYPE : LIST OF ALARM AND TRIP SETTINGS																	
DESCRIPTION : COVER SHEET																	
	<table style="width: 100%; text-align: center;"> <tr> <th>DRWG</th><th>AREA CODE</th><th>ENG SECT</th><th>SERIAL NUMBER</th><th>SHEET</th><th>PROJ CODE</th><th>DWG SIZE</th><th>REV.</th></tr> <tr> <td>NO</td><td>NIM</td><td>5</td><td>5065</td><td>001</td><td>DQ</td><td>4</td><td>A</td></tr> </table>	DRWG	AREA CODE	ENG SECT	SERIAL NUMBER	SHEET	PROJ CODE	DWG SIZE	REV.	NO	NIM	5	5065	001	DQ	4	A
DRWG	AREA CODE	ENG SECT	SERIAL NUMBER	SHEET	PROJ CODE	DWG SIZE	REV.										
NO	NIM	5	5065	001	DQ	4	A										




DESCRIPTION	SHEET	REV D	REV E	REV F	REV G	REV O	REV A	REV B	REV C
COVER SHEET	001	DEC.'04	JAN.'05	APR.'05	NOV.'08	DEC.'10	MAR.'11		
REVISION / INDEX SHEET	002				NOV.'08	DEC.'10	MAR.'11		
REVISION / INDEX SHEET	003				NOV.'08				
REVISION / INDEX SHEET	004					DEC.'10	MAR.'11		
SPARE	005								
MISCELLANEOUS	006								
MISCELLANEOUS	007								
SPARE	008								
SPARE	009								
MISCELLANEOUS	010								
	011								
	012								
	013								
	014								
	015								
	016								
	017			APR.'05					
	018								
	019								
	020			APR.'05					
MISCELLANEOUS	021		JAN.'05		NOV.'08				
SPARE	022								
SPARE	023			APR.'05					
SPARE	024								
ANALYTICAL	025								
	026								
SPARE	027								
SPARE	028								
SPARE	029								
SPARE	030								
SPARE	031								
FLOW	032		JAN.'05						

	G	NOV.'08	ASD	AS BUILT UP TO NOV.'08	0T.08.005	OSO/22N	SK
	F	APR.'05		AS BUILT FOR PROJECT '5X'	02.001		BW
	E	JAN.'05		AS BUILT FOR PROJECT '3Y'	0.394		BW
	D	NOV.'04		AS BUILT FOR PROJECT '5R'	01.116	OSE/24N	
	O	JAN.'87		ORIGINAL ISSUE			

REFERENCE TO EQUIPMENT/TAG NUMBERS ARE TO BE PREFIXED BY AREA CODE	REV	DATE	APPROVED BY	DESCRIPTION	B.I.NO.	PROJ.ENG.	SPEC.ENG.
							PDO APPROVAL

NOTES/REFERENCE DRAWINGS MASTER DRAWING REVISION
IN CASE OF DEVIATIONS MARKED UP PRINT SHALL BE SENT TO COASTAL DESIGN OFFICE

AREA : NIMR	SCALE : — 0 1 2 3 4 5 6 7	CAD DRAWING
SUB AREA : PRODUCTION STATION	No. 05	 شركة تنمية نفط عُمان Petroleum Development Oman
DRWG. TYPE : LIST OF ALARM AND TRIP SETTINGS	DRWG	AREA CODE
DESCRIPTION : REVISION / INDEX SHEET	ENG SECT	SERIAL NUMBER
	SHEET	PROJ CODE
	DWG SIZE	REV.
	NO	NIM 5 5065 002 DQ 4 A




DESCRIPTION	SHEET	REV.C	REV.D	REV.E	REV.F	REV.G	REV.O	REV.A	REV.B
PRESSURE	065								
PRESSURE	066	MAR.'02	NOV.'04		APR.'05				
PRESSURE	067		CANCELLED	JAN.'05.			DEC.'10	MAR.'11	
PRESSURE	068				APR.'05				
TEMPERATURE	069			JAN.'05.					
	070								
	071								
	072								
	073								
	074								
	075								
	076								
	077								
	078								
	079								
	080								
	081								
	082	MAR.'02	NOV.'04						
	083				APR.'05				
	084								
	085								
	086								
	087								
	088								
	089								
	090								
	091								
	092								
	093								
	094								
	095								
	096								

	F	APR.'05		AS BUILT FOR PROJ. '5X'	02.001		BW
	E	JAN.'05		AS BUILT FOR PROJ. '3Y'	0.394		BW
	B	FEB'02		AS BUILT FOR PROJECT '3R'	00.818	OME/26	
	A	JUN'01		AS BUILT FOR PROJ.2W	99.614	ONE/22	
REFERENCE TO EQUIPMENT/TAG NUMBERS ARE TO BE PREFIXED BY AREA CODE	REV	DATE	APPROVED BY	DESCRIPTION	B.I.NO.	PROJ.ENG.	SPEC.ENG.
PDO APPROVAL							



NOTES/REFERENCE DRAWINGS

MASTER DRAWING REVISION

IN CASE OF DEVIATIONS MARKED UP PRINT SHALL BE SENT TO COASTAL DESIGN OFFICE

AREA : NIMR		SCALE : — 0 1 2 3 4 5 6 7		CAD DRAWING																	
SUB AREA : PRODUCTION STATION		No. 05		 شركة تنمية نفط عُمان Petroleum Development Oman																	
DRWG. TYPE : LIST OF ALARM AND TRIP SETTINGS		DESCRIPTION : REVISION / INDEX SHEET		<table> <tr> <th>DRWG</th><th>AREA CODE</th><th>ENG SECT</th><th>SERIAL NUMBER</th><th>SHEET</th><th>PROJ CODE</th><th>DWG SIZE</th><th>REV.</th></tr> <tr> <td>NO</td><td>NIM</td><td>5</td><td>5065004</td><td>DQ</td><td>4</td><td>A</td><td></td></tr> </table>		DRWG	AREA CODE	ENG SECT	SERIAL NUMBER	SHEET	PROJ CODE	DWG SIZE	REV.	NO	NIM	5	5065004	DQ	4	A	
DRWG	AREA CODE	ENG SECT	SERIAL NUMBER	SHEET	PROJ CODE	DWG SIZE	REV.														
NO	NIM	5	5065004	DQ	4	A															



TAG NO. UNIT: 48-	SERVICE	TRANSMITTER RANGE PROCESS UNIT	SWITCH SETTING		ADJ. H/L/ HH/LL
			PROCESS UNITS	TRANSMISSION SYSTEM UNITS	
PSA-1445	P-48145 SEAL SYSTEM PRESSURE	0-1000 kPag	600 kPag 400 kPag		H L
PSA-1445	P-48145 SEAL SYSTEM PRESSURE	0-1000 kPag	300 kPag		LL
PSA-1446	P-48146 SEAL SYSTEM PRESSURE	0-1000 kPag	600 kPag 400 kPag		H L
PSA-1446	P-48146 SEAL SYSTEM PRESSURE	0-1000 kPag	300 kPag		LL
PSA-1447	P-48147 SEAL SYSTEM PRESSURE	0-1000 kPag	600 kPag 400 kPag		H L
PSA-1447	P-48147 SEAL SYSTEM PRESSURE	0-1000 kPag	300 kPag		LL
PSA-1448	P-48148 SEAL SYSTEM PRESSURE	0-1000 kPag	600 kPag 400 kPag		H L
PSA-1448	P-48148 SEAL SYSTEM PRESSURE	0-1000 kPag	300 kPag		LL
PDSA-1492	DP.ACROSS ESDV 48-UZV-2626A	0-2500 kPa	400 kPa	6.56 mA	H
PDSA-1493	DP.ACROSS ESDV 48-UZV-2627A	0-2500 kPa	400 kPa	6.56 mA	H
PDSA-1494	DP.ACROSS ESDV 48-UZV-2628A	0-2500 kPa	400 kPa	6.56 mA	H
PDSA-1495	DP.ACROSS ESDV 48-UZV-2626C	0-2500 kPa	400 kPa	6.56 mA	H
PDSA-1496	DP.ACROSS ESDV 48-UZV-2627C	0-2500 kPa	400 kPa	6.56 mA	H
PDSA-1497	DP.ACROSS ESDV 48-UZV-2628C	0-2500 kPa	400 kPa	6.56 mA	H
PDIZA-1523	DP.ACROSS ESDV 48-UZV-2660	0-600 kPa	400 kPa	14.6 mA	H
AREA : NIMR			SCALE :  CAD DRAWING		
SUB AREA : PRODUCTION STATION		NO. 05	 شركة تنمية نفط عُمان Petroleum Development Oman		
DRWG. TYPE : LIST OF ALARM & TRIP SETTINGS			DRWG	AREA CODE	ENG SECT
DESCRIPTION : PRESSURE INSTRUMENTS			SERIAL NUMBER	SHEET	PROJ CODE
			DWG SIZE	REV.	
			NO	NIM 5 5065 067 DQ 4	A



INSTRUMENT ENGINEERING

DATA SHEETS

Vendor details to be provided

SCOPE OF 'DQ' PROJECT
WBS NO.: NIM.IN.09.011

15/4/2011

THIS COMPLETE DWG. IS BASED ON 'CN' PROJECT
WBS NO. NIM.IN.08.002, REV.A AFC.

APPROVED FOR
CONSTRUCTION

A	MAR'11	KK	APPROVED FOR CONSTRUCTION	IN.09.011	OSE/23N
0	DEC'10	Mrp	ISSUED FOR COMMENTS	IN.09.011	OSE/23N
REV	DATE	DRAWN BY	DESCRIPTION	BL. NO	SIGNATURE
		TEAM	LENG		P D O APPROVAL

PROJECT DRAWING REVISION
IN CASE OF DEVIATIONS A MARKED UP PRINT SHALL BE SENT TO THE PROJECT ENGINEER

SCALE: 1:1000

AREA: NIMR

SUB AREA: PRODUCTION STATION

DRWG TYPE: INST. ENGINEERING DATA SHEET

DESCRIPTION: COVER SHEET

NO: NIM 5 5271000 DQ 3 A

PROJ. DWG. REV.

SHEET CODE

NO. 5

PROJ. DWG. REV.

NO. 5

NOTES/REFERENCE DRAWINGS
IN CASE OF DEVIATIONS MARKED UP PRINT SHALL BE SENT TO COASTAL DESIGN OFFICE

MASTER DRAWING REVISION

DESCRIPTION

BL. NO.

PROJ. APPROVAL



WorleyParsons-Arabian Industries (JV) Contract No.: C31/0606 Job No.: PAIP00405

Group 30										Group 31										Group 32										Group 33																			
General Instrumentation										Analyzer and sundry instrs.										Flow elements										Flow Instrument										Level Instrument									
Sheet	Revision	Sheet	Revision	Sheet	Revision	Sheet	Revision	Sheet	Revision	Sheet	Revision	Sheet	Revision	Sheet	Revision	Sheet	Revision	Sheet	Revision	Sheet	Revision	Sheet	Revision	Sheet	Revision	Sheet	Revision	Sheet	Revision	Sheet	Revision	Sheet	Revision	Sheet	Revision	Sheet	Revision												
000	0	055	110C	110C	154	200	0	248	D	N	250	0	300	0	350	0	400	0	450	0	450	0	450	0	450	0	450	0	450	0	450	0	450	0	450	0	450	0											
001	0	056	110D	110D	155	201	0	248A	N	R	251	0	301	0	351	0	401	0	451	0	451	0	451	0	451	0	451	0	451	0	451	0	451	0	451	0	451	0											
002	0	057	110E	110E	156	202	0	248B	N	R	252	0	302	0	352	0	402	0	452	0	452	0	452	0	452	0	452	0	452	0	452	0	452	0	452	0	452	0											
003	0	058	110F	110F	157	203	0	248C	N	R	253	0	303	0	353	0	403	0	453	0	453	0	453	0	453	0	453	0	453	0	453	0	453	0	453	0	453	0											
004	0	059	110G	110G	158	204	0	248D	N	R	254	0	304	0	354	0	404	0	454	0	454	0	454	0	454	0	454	0	454	0	454	0	454	0	454	0	454	0											
005	0	060	110H	110H	159	205	0	248E	N	R	255	0	305	0	355	0	405	0	455	0	455	0	455	0	455	0	455	0	455	0	455	0	455	0	455	0	455	0											
006	0	061	110J	110J	160	206	0	248F	R	T	256	0	306	0	356	0	406	0	456	0	456	0	456	0	456	0	456	0	456	0	456	0	456	0	456	0	456	0											
007	0	062	110K	110K	161	207	0	248G	R	T	257	0	307	0	357	0	407	0	457	0	457	0	457	0	457	0	457	0	457	0	457	0	457	0	457	0	457	0											
008	0	063	110L	110L	162	208	0	248H	T	258	0	308	0	358	0	408	0	458	0	458	0	458	0	458	0	458	0	458	0	458	0	458	0	458	0	458	0	458	0										
009	0	064	110M	110M	163	209	0	249	L	N	259	0	309	0	359	0	409	0	459	0	459	0	459	0	459	0	459	0	459	0	459	0	459	0	459	0	459	0											
010	0	065	110N	110N	164	210	0	249	L	N	260	0	310	0	360	0	410	0	460	0	460	0	460	0	460	0	460	0	460	0	460	0	460	0	460	0	460	0											
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013	0	068	110R	110R	167	213	0	249	L	N	263	0	313	0	363	0	413	0	463	0	463	0	463	0	463	0	463	0	463	0	463	0	463	0	463	0	463	0											
014	0	069	110S	110S	168	214	0	249	L	N	264	0	314	0	364	0	414	0	464	0	464	0	464	0	464	0	464	0	464	0	464	0	464	0	464	0	464	0											
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017	0	072	110V	110V	171	217	0	249	L	N	267	0	317	0	367	0	417	0	467	0	467	0	467	0	467	0	467	0	467	0	467	0	467	0	467	0	467	0											
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020	0	075	110Y	110Y	174	220	0	249	L	N	270	0	320	0	370	0	420	0	470	0	470	0	470	0	470	0	470	0	470	0	470	0	470	0	470	0	470	0											
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026	0	081	110E	110E	180	226	0	249	L	N	276	0	326	0	376	0	426	0	476	0	476	0	476	0	476	0	476	0	476	0	476	0	476	0	476	0	476	0											
027	0	082	110F	110F	181	227	0	249	L	N	277	0	327	0	377	0	427	0	477	0	477	0	477	0	477	0	477	0	477	0	477	0	477	0	477	0	477	0											
028	0	083	110G	110G	182	228	0	249	L	N	278	0	328	0	378	0	428	0	478	0	478	0	478	0	478	0	478	0	478	0	478	0	478	0	478	0	478	0											
029	0	084	110H	110H	183	229	0	249	L	N	279	0	329	0	379	0	429	0	479	0	479	0	479	0	479	0	479	0	479	0	479	0	479	0	479	0	479	0											
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031	0	086	110J	110J	185	231	0	249	L	N	281	0	331	0	381	0	431	0	481	0	481	0	481	0	481	0	481	0	481	0	481	0	481	0	481	0	481	0											
032	0	087	110K	110K	186	232	0	249	L	N	282	0	332	0	382	0	432	0	482	0	482	0	482	0	482	0	482	0	482	0	482	0	482	0	482	0	482	0											
033	0	088	110L	110L	187	233	0	249	L	N	283	0	333	0	383	0	433	0	483	0	483	0	483	0	483	0	483	0	483	0	483	0	483	0	483	0	483	0											
034	0	089	110M	110M	188	234	0	249	L	N	284	0	334	0	384	0	434	0	484	0	484	0	484	0	484	0	484	0	484	0	484	0	484	0	484	0	484	0											
035	0	090	110N	110N	189	235	0	249	L	N	285	0	335	0	385	0	435	0	485	0	485	0	485																										

Tag No.	Service	FUNCTION DESCRIPTION	Requisition No.	MANUFACTURER	Model No./Type	Range or Load or Rock	P E F S Na. Remarks
48-							
(G8S-2626A(0/C))	OPEN/CLOSE LIMIT SWITCH	48-UZV-2626A OPEN/CLOSE	RQ-5001	WESTLOCK	MAGNUM XT90	L	(1) G8S-2626A(0/C) 3637-001
(G8S-2626B(0/C))	OPEN/CLOSE LIMIT SWITCH	48-UZV-2626B OPEN/CLOSE	RQ-5001	WESTLOCK	MAGNUM XT90	L	(1) G8S-2626B(0/C) 3637-001
(G8S-2626C(0/C))	OPEN/CLOSE LIMIT SWITCH	48-UZV-2626C OPEN/CLOSE	RQ-5001	WESTLOCK	MAGNUM XT90	L	(1) G8S-2626C(0/C) 3637-001
(G8S-2660(0/C))	OPEN/CLOSE LIMIT SWITCH	ESD VALVE 48-UZV-2660 OPEN/CLOSE	RQ-5001				(1) G8S-2660(0/C) 2639-001-DQ

REMARKS AND/OR DESCRIPTION OF REVISIONS

(1) SUPPLIED WITH VALVE.

(2) PROCUREMENT NOT BY WPAI, HENCE VENDOR INFORMATION NOT AVAILABLE.

AREA : NIMR

SUB AREA : PRODUCTION STATION

NO. 05

DRWG. TYPE : INST. ENGINEERING DATA SHEET

DESCRIPTION : MISCELLANEOUS INSTRUMENTS

NO. 3 A

CAD DRAWING

SCALE : -

Petroleum Development Oman

Tag No.	48-	P E F S No.	NIM-1-	Remarks
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Tag No.	48-	Service	Components	Registration No.	Supplier	Model No./Type	Range or Set point	Board or Rack
HS-2510		MANUAL SELECTOR 48-LC-111B/ 48-LRCA-156A & 48-LRCA-655	SELECTOR SWITCH(DCS SOFTKEY)		FOXBORO		B	
HS-2511		K-4805 AIR BLOWER START	PUSH-BUTTON(DCS SOFTKEY)		FOXBORO		B	
			DIGITAL OUTPUT		FOXBORO		R	(1)
HS-2512		K-4805 AIR BLOWER STOP	PUSH-BUTTON(DCS SOFTKEY)		FOXBORO		B	
			DIGITAL OUTPUT		FOXBORO		R	(1)
HS-2646		FIELD RESET FOR ESD VALVE	FIELD RESET PUSH BUTTON	RQ-5135	STAHL	EF5-1104	L	
			48-UZY-2626A/B/C			8040/1180-001/010		
HS-2647		FIELD RESET FOR ESD VALVE	FIELD RESET PUSH BUTTON	RQ-5135	STAHL	EF5-1104	L	
			48-UZY-2627A/B/C			8040/1180-001/010		
HS-2648		FIELD RESET FOR ESD VALVE	FIELD RESET PUSH BUTTON	RQ-5135	STAHL	EF5-1104	L	
			48-UZY-2628A/B/C			8040/1180-001/010		
HS-2230		FIELD RESET FOR ESD VALVE	FIELD RESET PUSH BUTTON				2)	
			48-UZY-2660					

REMARKS AND/OR DESCRIPTION OF REVISIONS		AREA : NIMR		SUB AREA : PRODUCTION STATION		NO. 05		DESCRIPTION : INST. ENGINEERING DATA SHEET		NO. NIM 5 5271166KDQ 3 A	
1) HARDWIRED SIGNAL TO IEB SGS (TRICONEX)										Petroleum Development Oman	
2) PROCUREMENT NOT BY WPAI, HENCE VENDOR INFORMATION NOT AVAILABLE.										A	




GENERAL										OPERATING CONDITIONS										INSTRUMENT																	
Tag No.		Service		Fluid		Gas or vapour MW		Liquid sp. gravity		Normal temp. °C		Min. Normal		Max.		ΔP TRANSMITTER		Range (Kpa(g) or Lp)		Type		Description		Model		Manufacturer		Regulation numbers		Components e.g. Transmitter Rec. Controller etc.		Normalisation		Tag No.		Remarks	
48-1523		DP ACROSS ESD VALVE		SLUDGE OIL		0.93-1.0		25-50		0		10		20		ΔP TRANSMITTER		0-600		dp CELL		Material		Control or Board		P E F S No.		NIM-1		PDZA-1523		2639-001-DQ		1)		PDZA-1523	
48-1523		NIM-1		P E F S No.		48-		Tag No.		Remarks		1)		PDZA-1523		2639-001-DQ		48-1523		NIM-1		P E F S No.		48-		Tag No.		Remarks		1)		PDZA-1523		2639-001-DQ			

Data sheet for ESD VALVES										Design book No. : PAIP00238										
GENERAL		OPERATIONS				INSTRUMENT										Tag No. 48-				
Tag No. 48-	Service	Fluid	Gas or vapour MW	Normal temp. °C	Normal pressure (upstream) kPa(g)	Pressure drop at normal cond. kPa	Flow GAS : Sm ³ /d LIQUID : m ³ /d		Regulation sub-group serial numbers	Supplier	Type	Line size	Body Size connections Material	Inner valve Type Size Material	Spring action open or close	Fine yes or no	Hand wheel yes or no	Valve position yes or no	Remarks	Tag No. 48- P E F S No. NIM-1-
			Liquid sp. gr. at work temp.				Norm.	Max.												
UZV-2626A	ESD VALVE ON TANK T-4817 INLET	WET CRUDE	0.927 (0/C) 1.006 (WATER)	30~40	120				RQ-5001	BALL VALVE -VIRGO PNEUMATIC ACTIVATOR-BIFFI	ALGAS 185- 9800-935-CL	40" 300 #	40" FLANGED	BALL 36"	CLOSE	NO	NO	NO		UZV-2626A 3637-001
UZV-2626B	EQUALISING VALVE ACROSS 48-UZV-2626A/C	WET CRUDE	0.927 (0/C) 1.006 (WATER)	30~40	120				RQ-5001	BALL VALVE -VIRGO PNEUMATIC ACTIVATOR-BIFFI	RPS 120- S2-C2-CL	6" 300#	6" FLANGED	BALL 4"	CLOSE	NO	NO	NO		UZV-2626B 3637-001
UZV-2626C	ESD VALVE ON TANK T-4817 INLET	WET CRUDE	0.927 (0/C) 1.006 (WATER)	30~40	120				RQ-5001	BALL VALVE -VIRGO PNEUMATIC ACTIVATOR-BIFFI	ALGAS 185- 9800-935-CL	40" 300 #	40" FLANGED	BALL 36"	CLOSE	NO	NO	NO		UZV-2626C 3637-001
UZV-2627A	ESD VALVE ON TANK T-4818 INLET	WET CRUDE	0.927 (0/C) 1.006 (WATER)	30~40	120				RQ-5001	BALL VALVE -VIRGO PNEUMATIC ACTIVATOR-BIFFI	ALGAS 185- 9800-935-CL	40" 300 #	40" FLANGED	BALL 36"	CLOSE	NO	NO	NO		UZV-2627A 3637-001
UZV-2627B	EQUALISING VALVE ACROSS 48-UZV-2627A/C	WET CRUDE	0.927 (0/C) 1.006 (WATER)	30~40	120				RQ-5001	BALL VALVE -VIRGO PNEUMATIC ACTIVATOR-BIFFI	RPS 120- S2-C2-CL	6" 300#	6" FLANGED	BALL 4"	CLOSE	NO	NO	NO		UZV-2627B 3637-001
UZV-2627C	ESD VALVE ON TANK T-4818 INLET	WET CRUDE	0.927 (0/C) 1.006 (WATER)	30~40	120				RQ-5001	BALL VALVE -VIRGO PNEUMATIC ACTIVATOR-BIFFI	ALGAS 185- 9800-935-CL	40" 300 #	40" FLANGED	BALL 36"	CLOSE	NO	NO	NO		UZV-2627C 3637-001
UZV-2660	SLUDGE TANK T-4807 INLET ESD	SLUDGE OIL	0.93~1.0	25~50					RQ-5001			6" 300#	6" FLANGED		CLOSE				1)	UZV-2660 2639-001

REMARKS AND/OR DESCRIPTION OF REVISIONS
1) PROCUREMENT NOT BY WPAI, HENCE VENDOR INFORMATION NOT AVAILABLE.

AREA : NIMR
SUB AREA : PRODUCTION STATION
DRWG TYPE : INST. ENGINEERING DATA SHEET
DESCRIPTION : ESD VALVES

SCALE : 1 : 1
0 1 2 3 4 5 6 7

شركة تنمية نفط عمان
Petroleum Development Oman
DRWG AREA ENG SERIAL SHEET PROJ DWG REV.
CODE CODE SECT NUMBER CODE SIZE
NO NIM 5 5271 900 DQ 3 A

LIST OF ALARM AND TRIP SETTINGS

THIS COMPLETE DRAWING IS NEW
AND FORMS PART OF SCOPE OF
PROJECT 'DQ' WBS No.NIM.IN.09.011

**APPROVED FOR
CONSTRUCTION**


A	MAR.'11	KK			APPROVED FOR CONSTRUCTION	IN.09.011	OSE/23N	
O	DEC.'10	Mrp	PT	KDA	ISSUED FOR COMMENTS	IN.09.011	OSE/23N	IH
REV	DATE	DRAWN BY	TEAML	J.ENG.	DESCRIPTION	WBS No.	PROJ. ENG.	SIGNATURE
			CHECKED				P D O APPROVAL	

PROJECT DRAWING REVISION
IN CASE OF DEVIATIONS A MARKED UP PRINT SHALL BE SENT TO THE PROJECT ENGINEER

AREA : NIMR	SCALE : — 0 1 2 3 4 5 6 7																
SUB AREA : NIMR SLUDGE PIT	 شركة تنمية نفط عُمان Petroleum Development Oman																
DRWG. TYPE : LIST OF ALARM & TRIP SETTINGS																	
DESCRIPTION : COVER SHEET																	
	<table border="1" style="width: 100%; border-collapse: collapse;"> <tr> <td>DRWG</td> <td>AREA CODE</td> <td>ENG SECT</td> <td>SERIAL NUMBER</td> <td>SHEET</td> <td>PROJ CODE</td> <td>DWG SIZE</td> <td>REV.</td> </tr> <tr> <td>NO</td> <td>NIM</td> <td>5</td> <td>4744</td> <td>001 DQ</td> <td>4</td> <td>A</td> <td></td> </tr> </table>	DRWG	AREA CODE	ENG SECT	SERIAL NUMBER	SHEET	PROJ CODE	DWG SIZE	REV.	NO	NIM	5	4744	001 DQ	4	A	
DRWG	AREA CODE	ENG SECT	SERIAL NUMBER	SHEET	PROJ CODE	DWG SIZE	REV.										
NO	NIM	5	4744	001 DQ	4	A											




DESCRIPTION	SHEET	REV 0	REV A	REV B	REV C	REV D	REV E	REV F	REV G
COVER SHEET	001	DEC.'10	MAR.'11						
REVISION / INDEX SHEET	002	DEC.'10	MAR.'11						
SPARE	003								
SPARE	004								
PRESSURE INSTRUMENTS	005	DEC.'10	MAR.'11						
SPARE	006								
SPARE	007								
LEVEL INSTRUMENTS	008	DEC.'10	MAR.'11						
SPARE	009								
SPARE	010								
TEMPERATURE INSTRUMENTS	011	DEC.'10	MAR.'11						
SPARE	012								
SPARE	013								
SPARE	014								
MISCELLANEOUS	015	DEC.'10	MAR.'11						
	016								
	017								
	018								
	019								
	020								
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	031								
	032								
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	034								
	035								
	036								
	037								
	038								
	039								
	040								

AREA : NIMR		SCALE : — 0 1 2 3 4 5 6 7		CAD DRAWING																	
SUB AREA : NIMR SLUDGE PIT		NO. 05		 شركة تنمية نفط عُمان Petroleum Development Oman																	
DRWG. TYPE : LIST OF ALARM & TRIP SETTINGS		<table border="1"> <tr> <th>DRWG</th> <th>AREA CODE</th> <th>ENG SECT</th> <th>SERIAL NUMBER</th> <th>SHEET</th> <th>PROJ CODE</th> <th>DWG SIZE</th> <th>REV.</th> </tr> <tr> <td>NO</td> <td>NIM</td> <td>5</td> <td>4744</td> <td>002</td> <td>DQ</td> <td>4</td> <td>A</td> </tr> </table>				DRWG	AREA CODE	ENG SECT	SERIAL NUMBER	SHEET	PROJ CODE	DWG SIZE	REV.	NO	NIM	5	4744	002	DQ	4	A
DRWG	AREA CODE	ENG SECT	SERIAL NUMBER	SHEET	PROJ CODE	DWG SIZE	REV.														
NO	NIM	5	4744	002	DQ	4	A														
DESCRIPTION : REVISION / INDEX SHEET																					



[illegible]

NOTE:

AREA : NIMR		SCALE : — 0 1 2 3 4 5 6 7		CAD DRAWING						
SUB AREA : NIMR SLUDGE PIT		No. 05		 شركة تنمية نفط عُمان Petroleum Development Oman						
DRWG. TYPE : LIST OF ALARM & TRIP SETTINGS		DRWG		AREA CODE	ENG SECT	SERIAL NUMBER	SHEET	PROJ CODE	DWG SIZE	REV.
DESCRIPTION : MISCELLANEOUS INSTRUMENTS		NO		NIM 5 4744 015 DQ		4		A		

INSTRUMENT CABLE TERMINATION DETAILS FOR EQUIPMENT/SYSTEM CABLES COVER SHEET

NOTES: -

1. E-4001 TO E-4012, E-4016 TO E-4046, E-4050 TO E-4059, E-4062 TO E-4065, E-977, E-978 & E-987 SYSTEM CABLES ASSOCIATED WITH DCS SYSTEM ONLY.
2. E-4070 TO E-4085, E-4094 TO E-4098, E-986 SYSTEM CABLES BETWEEN DCS & SGS.
3. E-4101 TO E-4180, E-4191 TO E-4199, E-976, E-979 TO E-985 SYSTEM CABLES ASSOCIATED WITH SGS SYSTEM ONLY.
4. E-4013 TO E-4015, E-4047, E-4060, E-4187 TO E-4190, E-975 SYSTEM CABLES ASSOCIATED WITH GFS SYSTEM ONLY.
5. E-4351 TO E-4353, E-4355 TO E-4358 SYSTEM CABLES BETWEEN IFB & SDE-009.
6. E-4185, E-4186 SYSTEM CABLES BETWEEN GFS & SGS.
7. E-4090 TO E-4093 SYSTEM CABLES BETWEEN GFS & DCS.

Vendor details to be provided

SCOPE OF 'DQ' PROJECT
WBS NO.: NIM.IN.09.011

APPROVED FOR
CONSTRUCTION

A	MAR.'11	KK		APPROVED FOR CONSTRUCTION	IN.09.011	OSE/23N	
0	DEC.'10	Mrp	PT KDA	ISSUED FOR COMMENTS	IN.09.011	OSE/23N	IH
REV	DATE	DRAWN BY	TEAM L. J. ENG. CHECKED	DESCRIPTION	WBS No.	PROJ. ENG.	SIGNATURE
						P D O APPROVAL	

PROJECT DRAWING REVISION
IN CASE OF DEVIATIONS A MARKED UP PRINT SHALL BE SENT TO THE PROJECT ENGINEER

REFERENCE TO EQUIPMENT/TAG NUMBERS ARE TO BE PREFIXED BY AREA CODE								REV	DATE	APPROVED BY	DESCRIPTION	WBS No B.1: NO.	PROJ. ENG.	SPEC. ENG.
								T	JUN.'07	UMN/ASD	AS-BUILT FOR PROJECT '9W'	OT.06.001	OSE/23N	IH
								S	APR.'05		AS-BUILT FOR PROJECT 5X	02.001		BW
								R	JAN.'05		AS-BUILT FOR PROJ. 3Y&X4	00.394/95.052		BW
								Q	DEC.'04		AS-BUILT FOR PROJ. '5R'	01.116	OSE/24N	
								P	DEC.'04		AS-BUILT FOR PROJ. '5V'	IN.02.002	TTP/57	
								N	JUNE.'02		AS BUILT FOR PROJECT '7G'	W.B.S No. COLUMN 02.007.12100	OME/13	
								O	JUNE.'97		AS BUILT FOR PROJECT 'L4'	93.609		

NOTES/REFERENCE DRAWINGS

MASTER DRAWING REVISION

IN CASE OF DEVIATIONS MARKED UP PRINT SHALL BE SENT TO COASTAL DESIGN OFFICE

AREA : NIMR	SCALE : 0 1 2 3 4 5 6 7 CAD DRAWING																
SUB AREA : PRODUCTION STATION	 شركة تنمية نفط عمان Petroleum Development Oman																
DRWG. TYPE : I.C.T.D.																	
DESCRIPTION : COVER SHEET	<table border="1" style="width: 100%; border-collapse: collapse;"> <tr> <th>DRWG</th><th>AREA CODE</th><th>ENG SECT</th><th>SERIAL NUMBER</th><th>SHEET</th><th>PROJ CODE</th><th>DWG SIZE</th><th>REV.</th></tr> <tr> <td>NIM</td><td>5</td><td>5591</td><td>001</td><td>DQ</td><td>4</td><td>A</td><td></td></tr> </table>	DRWG	AREA CODE	ENG SECT	SERIAL NUMBER	SHEET	PROJ CODE	DWG SIZE	REV.	NIM	5	5591	001	DQ	4	A	
DRWG	AREA CODE	ENG SECT	SERIAL NUMBER	SHEET	PROJ CODE	DWG SIZE	REV.										
NIM	5	5591	001	DQ	4	A											




DESCRIPTION	SHEET	REV 0	REV 0	REV A	REV B	REV C	REV D	REV E
COVER SHEET	001	JUNE 97	DEC.'10	MAR.'11				
REVISION / INDEX SHEET (001 - 032)	002		DEC.'10	MAR.'11				
REVISION / INDEX SHEET (033 - 064)	003							
REVISION / INDEX SHEET (065 - 096)	004							
REVISION / INDEX SHEET (096 - 128)	005		DEC.'10	MAR.'11				
REVISION / INDEX SHEET (129 - 160)	006		DEC.'10	MAR.'11				
REVISION / INDEX SHEET (161 - 192)	007							
REVISION / INDEX SHEET (193 - 224)	008							
REVISION / INDEX SHEET (225 - 256)	009							
REVISION / INDEX SHEET (257 - 288)	010							
REVISION / INDEX SHEET (288 - 320)	011							
REVISION / INDEX SHEET (321 - 351)	012							
RADIATOR BOARD INTERCONN. DETAILS	013	JUNE 97						
LEGEND SHEET-1	014							
LEGEND SHEET-2	015							
E-4001	016							
E-4002	017							
E-4003	018							
E-4004	019							
E-4005	020							
E-4006	021							
SPARE	022							
SPARE	023							
E-4009	024	JUNE 97						
E-4010	025							
E-4011	026							
E-4012	027		DEC.'10	MAR.'11				
E-4013	028							
E-4014	029							
E-4015	030							
E-4016	031							
E-4017	032							

T	JUN.'07	UMN/ASD	AS-BUILT FOR PROJECT '9W'	OT.06.001	OSE/23N	HH
S	APR.'05		AS-BUILT FOR PROJECT 5X	02.001		BW
R	JAN.'05		AS-BUILT FOR PROJ 3Y&X4	00.394/95.052		BW
Q	DEC.04		AS-BUILT FOR PROJECT '5R'	01.116	OSE/24N	
P	DEC.04		AS-BUILT FOR PROJECT '5V'	IN.02.002	TTP/57	
O	JUNE'97		AS-BUILT FOR PROJECT 'L4'	93.609		

REFERENCE TO EQUIPMENT/TAG NUMBERS ARE TO BE PREFIXED BY AREA CODE	REV	DATE	APPROVED BY	DESCRIPTION	WBS No B.No.	PROJ.ENG.	SPEC.ENG.
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NOTES/REFERENCE DRAWINGS MASTER DRAWING REVISION
IN CASE OF DEVIATIONS MARKED UP PRINT SHALL BE SENT TO COASTAL DESIGN OFFICE


AREA : NIMR	SCALE : 0 1 2 3 4 5 6 7	CAD DRAWING																
SUB AREA : PRODUCTION STATION	No. 05	 شركة تنمية نفط عُمان Petroleum Development Oman																
DRWG. TYPE : I.C.T.D.		<table> <tr> <th>DRWG</th> <th>AREA CODE</th> <th>ENG SECT</th> <th>SERIAL NUMBER</th> <th>SHEET</th> <th>PROJ CODE</th> <th>DWG SIZE</th> <th>REV.</th> </tr> <tr> <td>NO</td> <td>NIM</td> <td>5</td> <td>5591</td> <td>002</td> <td>DQ</td> <td>4</td> <td>A</td> </tr> </table>	DRWG	AREA CODE	ENG SECT	SERIAL NUMBER	SHEET	PROJ CODE	DWG SIZE	REV.	NO	NIM	5	5591	002	DQ	4	A
DRWG	AREA CODE	ENG SECT	SERIAL NUMBER	SHEET	PROJ CODE	DWG SIZE	REV.											
NO	NIM	5	5591	002	DQ	4	A											
DESCRIPTION : REVISION/INDEX SHEET																		



DESCRIPTION	SHEET	REV O	REV M	REV P	REV Q	REV T	REV O	REV A
E-4082	097	JUNE 97						
E-4083	098							
E-4084	099							
E-4085	100							
SPARE	101							
SPARE	102							
SPARE	103							
SPARE	104							
E-4090 (CANCELLED UNDER PROJ. '5R')	105	JUNE 97			DEC.'04			
E-4091	106							
E-4092	107							
E-4093	108	SEP'00	MAR'02		DEC.'04			
E-4094	109	JUNE 97				JUN.'07		
E-4095	110							
E-4096	111							
E-4097	112							
E-4098	113							
SPARE	114							
SPARE	115							
E-4101	116	JUNE 97						
E-4102	117							
E-4103	118							
E-4104	119							
E-4105	120							
E-4106	121							
E-4107	122							
E-4108	123							
E-0986	124					JUN.'07		
SPARE	125							
SPARE	126							
SPARE	127							
E-4113	128	JUNE 97		DEC' 04			DEC.'10	MAR.'11

	T	JUN.'07	UMN/ASD	AS-BUILT FOR PROJECT '9W'	OT.06.001	OSE/23N	III
	Q	DEC'04		AS-BUILT FOR PROJECT '5R'	01.116	OSE/24N	
	P	DEC'04		AS BUILT FOR PROJ. '5V'	IN.02.002	TTP/57	
	M	MAR'02		AS BUILT FOR PROJ. 4P	00.802	OME/41	JAMAL
	O	JUNE'97		AS BUILT FOR PROJECT 'L4'	93.609		
REFERENCE TO EQUIPMENT/TAG NUMBERS ARE TO BE PREFIXED BY AREA CODE	REV	DATE	APPROVED BY	DESCRIPTION	B.I.NO.	PROJ.ENG.	SPEC.ENG.
PDO APPROVAL							

NOTES/REFERENCE DRAWINGS MASTER DRAWING REVISION
IN CASE OF DEVIATIONS MARKED UP PRINT SHALL BE SENT TO COASTAL DESIGN OFFICE


AREA : NIMR	SCALE : 0 1 2 3 4 5 6 7	CAD DRAWING																
SUB AREA : PRODUCTION STATION	No. 05	 شركة تنمية نفط عمان Petroleum Development Oman																
DRWG. TYPE : I.C.T.D.		<table> <tr> <th>DRWG</th> <th>AREA CODE</th> <th>ENG SECT</th> <th>SERIAL NUMBER</th> <th>SHEET</th> <th>PROJ CODE</th> <th>DWG SIZE</th> <th>REV.</th> </tr> <tr> <td>NO</td> <td>NIM</td> <td>5</td> <td>5591</td> <td>005</td> <td>DQ</td> <td>4</td> <td>A</td> </tr> </table>	DRWG	AREA CODE	ENG SECT	SERIAL NUMBER	SHEET	PROJ CODE	DWG SIZE	REV.	NO	NIM	5	5591	005	DQ	4	A
DRWG	AREA CODE	ENG SECT	SERIAL NUMBER	SHEET	PROJ CODE	DWG SIZE	REV.											
NO	NIM	5	5591	005	DQ	4	A											
DESCRIPTION : REVISION/INDEX SHEET																		



DESCRIPTION	SHEET	REV 0	REV H	REV J	REV P	REV O	REV A
E-4114	129	JUNE 97	JUNE 00	JULY'00			
E-4115	130						
E-4116	131	OCT'02			DEC'04		
E-4117	132	JUNE 97					
E-4118	133						
E-4119	134						
E-4120	135						
E-4121	136						
E-4122	137					DEC.'10	MAR.'11
E-4123	138						
SPARE	139						
SPARE	140						
SPARE	141						
SPARE	142						
E-4128	143	JUNE 97		JULY'00			
E-4129	144						
E-4130	145						
E-4131	146						
E-4132	147						
E-4133	148			JULY'00			
SPARE	149						
SPARE	150						
E-4136	151	JUNE 97		JULY'00			
E-4137	152						
E-4138	153						
E-4139	154						
E-4140	155			JULY'00			
E-4141	156						
SPARE	157						
SPARE	158						
E-4144	159	JUNE 97					
E-4145	160						

P	DEC'04			AS BUILT FOR PROJECT '5V'	IN.02.002	TTP /57	
J	JULY'00	DVd		AS BUILT FOR PROJ. 2Z,7G & UPTO JUL'00	00.826	ONE/23	
O	JUNE 97	AJAY		AS BUILT FOR PROJECT L4	93.609		
REV	DATE	DRAWN BY	CHECKED	DESCRIPTION	-B.I. NO- WBS No	SIGNATURE P D O APPROVAL	

MASTER DRAWING REVISION
IN CASE OF DEVIATIONS A MARKED UP PRINT SHALL BE SENT TO THE PROJECT ENGINEER


AREA : NIMR	SCALE : 0 1 2 3 4 5 6 7	CAD DRAWING					
SUB AREA : PRODUCTION STATION	No. 05	 شركة تنمية نفط عُمان Petroleum Development Oman					
DRWG. TYPE : ICTD							
DESCRIPTION : REVISION/INDEX SHEET							
DRWG	AREA CODE	ENG SECT	SERIAL NUMBER	SHEET	PROJ CODE	DWG SIZE	REV.
NO	NIM	5	5591	006	DQ	4	A



SYSTEM CABLE AND BOARD							CONNECTED TO
TAG NUMBER 48	NUMBER	SIZE	TML'S		FROM	TO	
GBS-791 O	E-4012	EM56/54	01	02	SDE-002	DCS-009	
GBS-791 C	E-4012	EM56/54	03	04	SDE-002	DCS-009	
GBS-792 O	E-4012	EM56/54	05	06	SDE-002	DCS-009	
GBS-792 C	E-4012	EM56/54	07	08	SDE-002	DCS-009	
GBS-793 O	E-4012	EM56/54	09	10	SDE-002	DCS-009	
GBS-793 C	E-4012	EM56/54	11	12	SDE-002	DCS-009	
GBS-794 O	E-4012	EM56/54	13	14	SDE-002	DCS-009	
GBS-794 C	E-4012	EM56/54	15	16	SDE-002	DCS-009	
SPARE			17	18			
GBS-2660(O)	E-4012	EM56/54	19	20	SDE-002	DCS-009	NOTE-1
GBS-2660(C)	E-4012	EM56/54	21	22	SDE-002	DCS-009	NOTE-1
SPARE			23	24			
SPARE			25	26			
SPARE			27	28			
SPARE			29	30			
SPARE			31	32			
SPARE			33	34			
SPARE			35	36			
SPARE			37	38			
SPARE			39	40			
SPARE			41	42			
SPARE			43	44			
SPARE			45	46			
SPARE			47	48			
SPARE			49	50			
SPARE			51	52			
SPARE			53	54			

NOTE-1 SYSTEM DETAILS AWAITED.


M3TYPE54

AREA : NIMR		SCALE : 0 1 2 3 4 5 6 7		CAD DRAWING	
SUB AREA : PRODUCTION STATION		no. 05		 شركة تنمية نفط عُمان Petroleum Development Oman	
DRWG. TYPE : ICTD		DRWG		AREA CODE	ENG SECT
DESCRIPTION : E-4012		SERIAL NUMBER		SHEET	PROJ CODE
		NO		DWG SIZE	REV.
		NIM 5 5591 027 DQ		4	A



SYSTEM CABLE AND BOARD							CONNECTED TO
TAG NUMBER 48	NUMBER	SIZE	TML'S		FROM	TO	
PZA-059	E-4113	EM56/54	01	02	SDE-002	SGS-004B	4B-7A, 5F+,5F-
PZA-060	E-4113	EM56/54	03	04	SDE-002	SGS-004B	4B-7A, 16F+,16F-
HS-472 RS	E-4113	EM56/54	05	06	SDE-002	SGS-004B	4B-6A, 22F+,22F-
HS-028 RS	E-4113	EM56/54	07	08	SDE-002	SGS-004B	4B-3A, 5F+,5F-
PZA-105	E-4113	EM56/54	09	10	SDE-002	SGS-004B	4B-7A, 8F+,8F-
PZA-106	E-4113	EM56/54	11	12	SDE-002	SGS-004B	4B-7A, 9F+,9F-
PZA-107	E-4113	EM56/54	13	14	SDE-002	SGS-004B	4B-7A, 10F+,10F-
PZA-122	E-4113	EM56/54	15	16	SDE-002	SGS-004B	4B-7A, 11F+,11F-
PZA-123	E-4113	EM56/54	17	18	SDE-002	SGS-004B	4B-1B, 19F+,19F-
P-4830/31	E-4113	EM56/54	19	20	SDE-002	SGS-004B	4B-1B, 18F+,18F-
PZA-072	E-4113	EM56/54	21	22	SDE-002	SGS-004B	E-4191-03,04
PZA-084	E-4113	EM56/54	23	24	SDE-002	SGS-004B	E-4191-05,06
PZA-086	E-4113	EM56/54	25	26	SDE-002	SGS-004B	E-4191-07,08
GBS-101 C	E-4113	EM56/54	27	28	SDE-002	SGS-004B	4B-1A, 7F+,7F-
PDZA-212	E-4113	EM56/54	29	30	SDE-002	SGS-004B	4B-7A, 3F+,3F-
HBS-129	E-4113	EM56/54	31	32	SDE-002	SGS-004B	4B-1B, 4F+4F-
US-2021 (O)	E-4113	EM56/54	33	34	SDE-002	SGS-004B	4B-2B, 1F+,1F-
US-2021 (C)	E-4113	EM56/54	35	36	SDE-002	SGS-004B	4B-10B, 10F+,10F-
SPARE			37	38			
PDIZA-1523	E-4113	EM56/54	39	40	SDE-002	SGS-004B	NOTE-1
HS-2230	E-4113	EM56/54	41	42	SDE-002	SGS-004B	NOTE-1
SPARE			43	44			
SPARE			45	46			
SPARE			47	48			
SPARE			49	50			
SPARE			51	52			
SPARE			53	54			

NOTE-1 SYSTEM DETAILS AWAITED.


AREA : NIMR		SCALE : 0 1 2 3 4 5 6 7		CAD DRAWING						
SUB AREA : PRODUCTION STATION		No. 05		 شركة تنمية نفط عُمان Petroleum Development Oman						
DRWG. TYPE : ICTD		DRWG		AREA CODE	ENG SECT	SERIAL NUMBER	SHEET	PROJ CODE	DWG SIZE	REV.
DESCRIPTION : E-4113		NO		NIM	5	5591	128	DQ	4	A



SYSTEM CABLE AND BOARD						CONNECTED TO
TAG NUMBER 48	NUMBER	SIZE	TML'S		FROM TO	
UZ-791	E-4122	EM30/28	01	02	SDE-002 SGS-001B	1B-3B, 8L+,8L-
UZ-792	E-4122	EM30/28	03	04	SDE-002 SGS-001B	1B-3B, 9L+,9L-
UZ-793	E-4122	EM30/28	05	06	SDE-002 SGS-001B	1B-3B, 10L+,10L-
UZ-794	E-4122	EM30/28	07	08	SDE-002 SGS-001B	1B-3B, 11L+,11L-
UZ-797	E-4122	EM30/28	09	10	SDE-002 SGS-001B	1B-3B, 13L+,13L-
PICA-083	E-4122	EM30/28	11	12	SDE-002 SGS-001B	1B-2B, 1L+,1L-
UZ-413	E-4122	EM30/28	13	14	SDE-002 SGS-001B	2B-8B, 3L+,3L-
UZ-412	E-4122	EM30/28	15	16	SDE-002 SGS-001B	2B-8B, 2L+,2L-
UZ-751	E-4122	EM30/28	17	18	SDE-002 SGS-001B	2B-8B, 10L+,10L-
UZ-433	E-4122	EM30/28	19	20	SDE-002 SGS-001B	2B-12B, 6L+,6L-
UZ-432	E-4122	EM30/28	21	22	SDE-002 SGS-001B	2B-9B, 5L+,5L-
UZ-761	E-4122	EM30/28	23	24	SDE-002 SGS-001B	2B-12B, 7L+,7L-
UZV-2660	E-4122	EM30/28	25	26	SDE-002 SGS-001B	NOTE-1
SPARE			27	28		

NOTE-1 SYSTEM DETAILS AWAITED.

M3TYPE28

AREA : NIMR		SCALE : 0 1 2 3 4 5 6 7		CAD DRAWING	
SUB AREA : PRODUCTION STATION		No. 05		 شركة تنمية نفط عُمان Petroleum Development Oman	
DRWG. TYPE : ICTD		DRWG		AREA CODE	ENG SECT
DESCRIPTION : E-4122		SERIAL NUMBER		SHEET	PROJ CODE
		NO		DWG SIZE	REV.
		NIM 5 5591 137 DQ		4	A



SGS INSTRUMENT LOOP DIAGRAMS

PART-II

Vendor details to be provided

REFERENCE DRAWINGS :

- DCS INST. LOOP DIAGRAMS : NIM-5-5594-001-3 & NIM-5-5907-001-3
- SGS INST. LOOP DIAGRAMS PART I : NIM-5-5595-001-3
(ALL TAGS EXCEPT 'X' & 'U').

SCOPE OF 'DQ' PROJECT
WBS NO.: NIM.IN.09.011

15/4/2011

APPROVED FOR
CONSTRUCTION

	M	APR.05	AS BUILT FOR PROJ. '5X'	02.001		BW
	L	JAN.05	AS BUILT FOR PROJ. '3Y'	00.394		BW
	K	DEC.04	AS BUILT FOR PROJ. '5X'	02.001		BW
	J	MAR'02	AS BUILT PROJ.4P	00.862	OME/41	JAMAL
	O	JULY 97	AS BUILT FOR PROJECT L4	93.609		
REV	DATE	APPROVED BY	DESCRIPTION	B.I.NO.	PROJ.ENG.	SPEC.ENG.
					PDO APPROVAL	

NOTES/REFERENCE DRAWINGS
IN CASE OF DEVIATIONS MARKED UP PRINT SHALL BE SENT TO COASTAL DESIGN OFFICE

MASTER DRAWING REVISION

A	MAR.'11	KK		APPROVED FOR CONSTRUCTION	IN.09.011	OSE/23N	
O	DEC.'10	Mrp	PT KDA	ISSUED FOR COMMENTS	IN.09.011	OSE/23N	IH
REV	DATE	DRAWN BY	TEAM LEAD	DESCRIPTION	B.I. NO	PROJ. ENG.	SIGNATURE
			CHECKED				P D O APPROVAL


PROJECT DRAWING REVISION
IN CASE OF DEVIATIONS A MARKED UP PRINT SHALL BE SENT TO THE PROJECT ENGINEER

AREA	: NIMR	SCALE :	0 1 2 3 4 5 6 7	CAD DRAWING
SUB AREA	: PRODUCTION STATION	NO. 05	شركة تنمية نفط عمان Petroleum Development Oman	
DRWG TYPE	: SGS INST. LOOP DIAGRAMS	DRWG	AREA CODE	ENG SECT
DESCRIPTION	: COVER SHEET	NO	SERIAL NUMBER	SHEET
			PROJ CODE	DWG SIZE
			REV.	

NIM 5 5596 001DQ 3 A



DESCRIPTION	SHEET	REV O	REV K	REV L	REV M	REV O	REV A	REV B	DESCRIPTION	SHEET	REV O	REV A	REV B	REV M	REV D	REV F	REV G
COVER SHEET	001	JULY.97	DEC.04	JAN.05	APR.05	DEC.'10	MAR.'11		US-1123	035	JULY.97						
REVISION/INDEX SHEET	002					DEC.'10	MAR.'11		US-285	036							
REVISION/INDEX SHEET	003								US-286	037							
REVISION/INDEX SHEET	004								US-287	038							
REVISION/INDEX SHEET	005				APR.05	DEC.'10	MAR.'11		US-288	039							
REVISION/INDEX SHEET	006			JAN.05					US-289	040							
REVISION/INDEX SHEET	007					DEC.'10	MAR.'11		US-291	041							
REVISION/INDEX SHEET	008		DEC.04			DEC.'10	MAR.'11		US-292	042							
REVISION/INDEX SHEET	009								US-294	043							
REVISION/INDEX SHEET	010								US-295	044							
SPARE	011								US-297	045				APR.05			
SPARE	012								US-298	046				DELETED			
REVISION/INDEX SHEET	013								SPARE	047							
SPARE	014								US-527	048							
SPARE	015								US-531	049							
SPARE	016								US-548	050							
SPARE	017								US-549	051							
SPARE	018								US-1552	052			APR.98				
SPARE	019								US-1553	053							
SPARE	020								US-1554	054							
SPARE	021								US-1555	055							
SPARE	022								US-1556	056							
SPARE	023								SPARE	057							
SPARE	024								SPARE	058							
LEGEND SHEET	025	JULY.97							SPARE	059							
SPARE	026								SPARE	060							
SPARE	027								SPARE	061							
SPARE	028								SPARE	062							
SPARE	029								SPARE	063							
SPARE	030								UZ-041	064	JULY.97						
SPARE	031								UZ-061	065							
SPARE	032								UZ-071	066							
SPARE	033								UZ-091	067							
US-1122	034	JULY.97							UZ-101	068							

REV	DATE	DRAWN BY	TEAM LEAD	LENGTH	DESCRIPTION	B.I. NO	PROJ. ENG.	SIGNATURE
			CHECKED				P D O APPROVAL	
PROJECT DRAWING REVISION								
IN CASE OF DEVIATIONS A MARKED UP PRINT SHALL BE SENT TO THE PROJECT ENGINEER								
AREA : NIMR						SCALE : 0 1 2 3 4 5 6 7		
SUB AREA : PRODUCTION STATION						No. 05		
DRWG. TYPE : SGS INST. LOOP DIAGRAMS						 شركة تنمية نفط عُمان Petroleum Development Oman		
DESCRIPTION : REVISION/INDEX SHEET						DRWG. AREA ENG SERIAL SHEET PROJ DWG REV. CODE SECT NUMBER CODE SIZE NO NIM 5 5596 002DQ 3 A		

M	APR.05		AS BUILT FOR PROJ. '5X'	02.001		BW
L	JAN.05		AS BUILT FOR PROJ. '3Y'	00.394		BW
K	DEC.04		AS BUILT FOR PROJ. '5X'	02.001		BW
J	MAR'02		AS BUILT PROJ. 4P	00.862	OME/41	JAMAL
O	JULY.97		AS BUILT FOR PROJECT L4	93.609		
REV	DATE	APPROVED BY	DESCRIPTION	B.I.NO.	PROJ.ENG.	SPEC.ENG.
					P D O APPROVAL	

NOTES/REFERENCE DRAWINGS MASTER DRAWING REVISION
IN CASE OF DEVIATIONS MARKED UP PRINT SHALL BE SENT TO COASTAL DESIGN OFFICE

DESCRIPTION	SHEET	REV O	REV H	REV B	REV E	REV M	REV O	REV A	DESCRIPTION	SHEET	REV O	REV A	REV B	REV C	REV D	REV F	REV G
UZ-1611	205								XA-273.1/273.2	239	JULY.97						
UZ-1621	206								SPARE	240							
UZ-1631	207								SPARE	241							
UZ-1632	208								SPARE	242							
UZ-1641	209								SPARE	243							
UZ-1642	210								SPARE	244							
UZ-1651	211								XB-707	245	JULY.97						
UZ-1652	212								XB-708	246							
UZ-1661	213								XB-709	247							
UZ-1662	214								XB-777	248							
UZ-1671	215								XB-778	249							
UZ-1672	216								XB-779	250							
UZ-113	217								XB-787	251							
UZ-1276	218	AUG.99			JUN.00				XB-788	252							
UZ-809	219	JUL'97							XB-789	253							
UZ-833	220	JUL'97							XB-797	254							
UZ-1501	221			APR.98					XB-798	255							
UZ-1502	222			APR.98					XB-799	256							
UZ-1503	223			APR.98					SPARE	257							
SPARE	224			APR.98		DELETED			SPARE	258							
UZ-1520	225			APR.98		APR.05			SPARE	259							
UZ-1521	226			APR.98					SPARE	260							
UZ-1522	227			APR.98					SPARE	261							
UZ-1523	228			APR.98					SPARE	262							
UZ-1561	229			APR.98					XS-1381/1382/GBS-312	263	JULY.97						
UZ-1562	230			APR.98					XS-1383/1384/GBS-322	264							
UZV-2660	231			APR.98		DELETED	DEC.'10	MAR.'11	XS-1385/1386/GBS-335	265							
XS-2091	232	JUN'00	FEB'02						XS-1387/1388/GBS-832	266							
UZ-2081	233								XS-1389/1390/GBS-807	267							
UZ-2091	234								XS-1391/1392/GBS-845	268							
XA-268.1/268.2	235	JULY.97							XS-1393/1394/GBS-336	269							
XA-270.1/270.2	236								XS-1395/1396/GBS-846	270							
XA-271	237								XS-1397/1398/GBS-343	271							
XA-272.1/272.2	238								XS-1399/1400/GBS-353	272							

REV	DATE	DRAWN BY	TEAM	LENG.	DESCRIPTION	B.I. NO	PROJ. ENG.	SIGNATURE
			CHECKED				P D O APPROVAL	

PROJECT DRAWING REVISION

IN CASE OF DEVIATIONS A MARKED UP PRINT SHALL BE SENT TO THE PROJECT ENGINEER

AREA	: NIMR	SCALE : 1 2 3 4 5 6 7	CAD DRAWING
SUB AREA	: PRODUCTION STATION	No. 05	شركة تنمية نفط عمان Petrolium Development Oman
DRWG TYPE	: SGS INST. LOOP DIAGRAMS	DRWG	AREA
DESCRIPTION	: REVISION/INDEX SHEET	ENG SECT	SERIAL
		SHEET	PROJ CODE
		DWG SIZE	REV.
		NO	NIM 5 5596 005DQ 3 A

NOTES/REFERENCE DRAWINGS

MASTER DRAWING REVISION

IN CASE OF DEVIATIONS MARKED UP PRINT SHALL BE SENT TO COASTAL DESIGN OFFICE




DESCRIPTION	SHEET	REV O	REV A	REV B	REV F	REV M	REV O	REV A	DESCRIPTION	SHEET	REV O	REV A	REV B	REV C	REV D	REV F	REV G
XS-361.1/362.2/GBS-530	341	JULY.97							XZA-265	375	JULY.97						
XS-423/424/GBS-422	342								XZA-404/405/406/407	376							
XS-701	343								XZA-1751	377				JULY.99			
XS-775	344								SPARE	378							
XS-785	345								SPARE	379							
XS-795	346								XS-433-1/2 PUMP-A/B	380	APR.'97			JULY.99			
XS-1818	347								XS-2111	381							JUN'01
XS-2031	348	SEP.99			SEP.00				XS-2112	382							
XS-2032	349								XS-2113	383							
SPARE	350								XS-2114	384							
XS-906-907-GBS-901	351		MAR.98						XS-2232	385							
XS-909-910-GBS-902	352								XS-2234	386							
SPARE	353								XS-2236	387							
HS-2230	354						DEC.'10	MAR.'11	XS-2238	388							
XS-863/864/GBS-1224	355			APR.98		APR.05			SPARE	389							
XS-865/866	356			APR.98					SPARE	390							
XS-867/868	357			APR.98					XZ-1962	391			NOV.98				
XS-869/870/GBS-1231	358			APR.98					XZ-1963	392							
XS-871/872	359			APR.98					XZ-1964	393							
XS-873/874	360			APR.98					SPARE	394							
									SPARE	395							
XS-1954.1/1954.2/GBS-1763	362								SPARE	396							
XS-1955.1/1955.2/GBS-1773	363								SPARE	397							
XS-1956.1/1956.2/GBS-1951	364								SPARE	398							
XS-1957.1/1957.2/GBS-1952	365								SPARE	399							
XS-1965	366								SPARE	400							
									XS-2095/2096	401							JUN'01
XS-1758/59	368								XS-2101/2102	402							
XZA-026/192/193/194	369	JULY.97							XS-2107/2108	403							
XZA-028/197/198/199	370								XS-2049/2050	404							
XZA-030/202/203/204	371								XS-2023	405						SEP 00	
XZA-263 (GFS INPUT)	372								XS-2024	406						SEP 00	
XZA-263 (SGS OUTPUT)	373								XS-2025.1/2025.2	407						SEP 00	
XZA-264.1 / 264.2	374								XS-2026.1/2026.2	408						SEP 00	

	M	APR.05		AS BUILT FOR PROJ. '5X'	02.001		DW
	G	JUN'01		AS BUILT FOR PROJ.2W	99.614	ONE/22	
	F	SEP.00		AS BUILT PROJ. 3G & 1S	95.052	ONE/22	
	D	JULY'99		AS BUILT FOR PROJ. T1 & M9	96.346	ONE/22	
	O	JULY'97		AS BUILT FOR PROJECT L4	93.609		
REV	DATE	APPROVED BY	DESCRIPTION	BLNO.	PROJ.ENG.	SPEC.ENG.	PDO APPROVAL

NOTES/REFERENCE DRAWINGS
IN CASE OF DEVIATIONS MARKED UP PRINT SHALL BE SENT TO COASTAL DESIGN OFFICE

MASTER DRAWING REVISION


REV	DATE	DRAWN BY	TEAM L	J.ENG.	DESCRIPTION	B.I. NO	PROJ. ENG.	SIGNATURE
			CHECKED				P D O APPROVAL	
PROJECT DRAWING REVISION								
IN CASE OF DEVIATIONS A MARKED UP PRINT SHALL BE SENT TO THE PROJECT ENGINEER								
AREA : NIMR						SCALE : 0 1 2 3 4 5 6 7		
SUB AREA : PRODUCTION STATION						No. 05		
DRWG. TYPE : SGS INST. LOOP DIAGRAMS						 شركة تنمية نفط عُمان Petroleum Development Oman		
DESCRIPTION : REVISION/INDEX SHEET						DRWG AREA ENG SERIAL SHEET PROJ DWG CODE SECT NUMBER CODE CODE SIZE REV.		
						NO NIM 5 5596 007DQ 3 A		



DESCRIPTION	SHEET	REV O	REV A	REV B	REV C	REV K	REV F	REV G	DESCRIPTION	SHEET	REV M	REV A	REV B	REV C	REV O	REV A	REV B
UZ-1711	409				NOV.98				XZ-2204 A/B	443	APR.05						
UZ-1712	410								XZ-2215	444							
UZ-1721	411								SPARE	445							
UZ-1722	412								SPARE	446							
UZ-1731	413								SPARE	447							
UZ-1732	414								SPARE	448							
UZ-1741	415								SPARE	449							
UZ-1742	416								PDIZA-1523	450					DEC.'10	MAR.'11	
UZ-1751	417								SPARE	451							
UZ-1752	418								SPARE	452							
UZ-1761	419								SPARE	453							
UZ-1762	420								SPARE	454							
UZ-1771	421								SPARE	455							
UZ-1772	422								SPARE	456							
SPARE	423								SPARE	457							
SPARE	424								SPARE	458							
SPARE	425								SPARE	459							
SPARE	426								SPARE	460							
SPARE	427								SPARE	461							
SPARE	428								SPARE	462							
SPARE	429								SPARE	463							
SPARE	430								SPARE	464							
XS-2033	431					DEC.04			SPARE	465							
XS-2034	432								SPARE	466							
XS-2035	433								SPARE	467							
XS-2036	434								SPARE	468							
XS-2215	435								SPARE	469							
XS-2216	436								SPARE	470							
XS-2037	437								SPARE	471							
XS-2038	438								SPARE	472							
XS-2039	439								SPARE	473							
XS-2040	440								SPARE	474							
XS-2251	441								SPARE	475							
XS-2252	442								SPARE	476							


REV	DATE	DRAWN BY	TEAM LEAD	ENG.	DESCRIPTION	B.I. NO	PROJ. ENG.	SIGNATURE
			CHECKED				P D O APPROVAL	

PROJECT DRAWING REVISION
IN CASE OF DEVIATIONS A MARKED UP PRINT SHALL BE SENT TO THE PROJECT ENGINEER

AREA	: NIMR	SCALE :	CAD DRAWING
SUB AREA	: PRODUCTION STATION	NO. 05	
DRWG. TYPE	: SGS INST. LOOP DIAGRAMS	 شركة تنمية نفط عمان Petroleum Development Oman	
DESCRIPTION	: REVISION/INDEX SHEET	DRWG	AREA
		CODE	SECT
		SERIAL	NUMBER
		SHEET	PROJ. CODE
		DWG. SIZE	REV.
		NO	NIM 5 5596 008DQ 3 A

REV	DATE	APPROVED BY	DESCRIPTION	B.I. NO.	PROJ. ENG.	SPEC. ENG.	P D O APPROVAL
M	APR.05		AS-BUILT FOR PROJ. '5X'	02.001		BW	
K	DEC.04		AS BUILT FOR PROJ. '5X'	02.001		BW	
C	NOV'98		AS-BUILT FOR PROJ. CODE '15'	97.009			

NOTES/REFERENCE DRAWINGS MASTER DRAWING REVISION
IN CASE OF DEVIATIONS MARKED UP PRINT SHALL BE SENT TO COASTAL DESIGN OFFICE

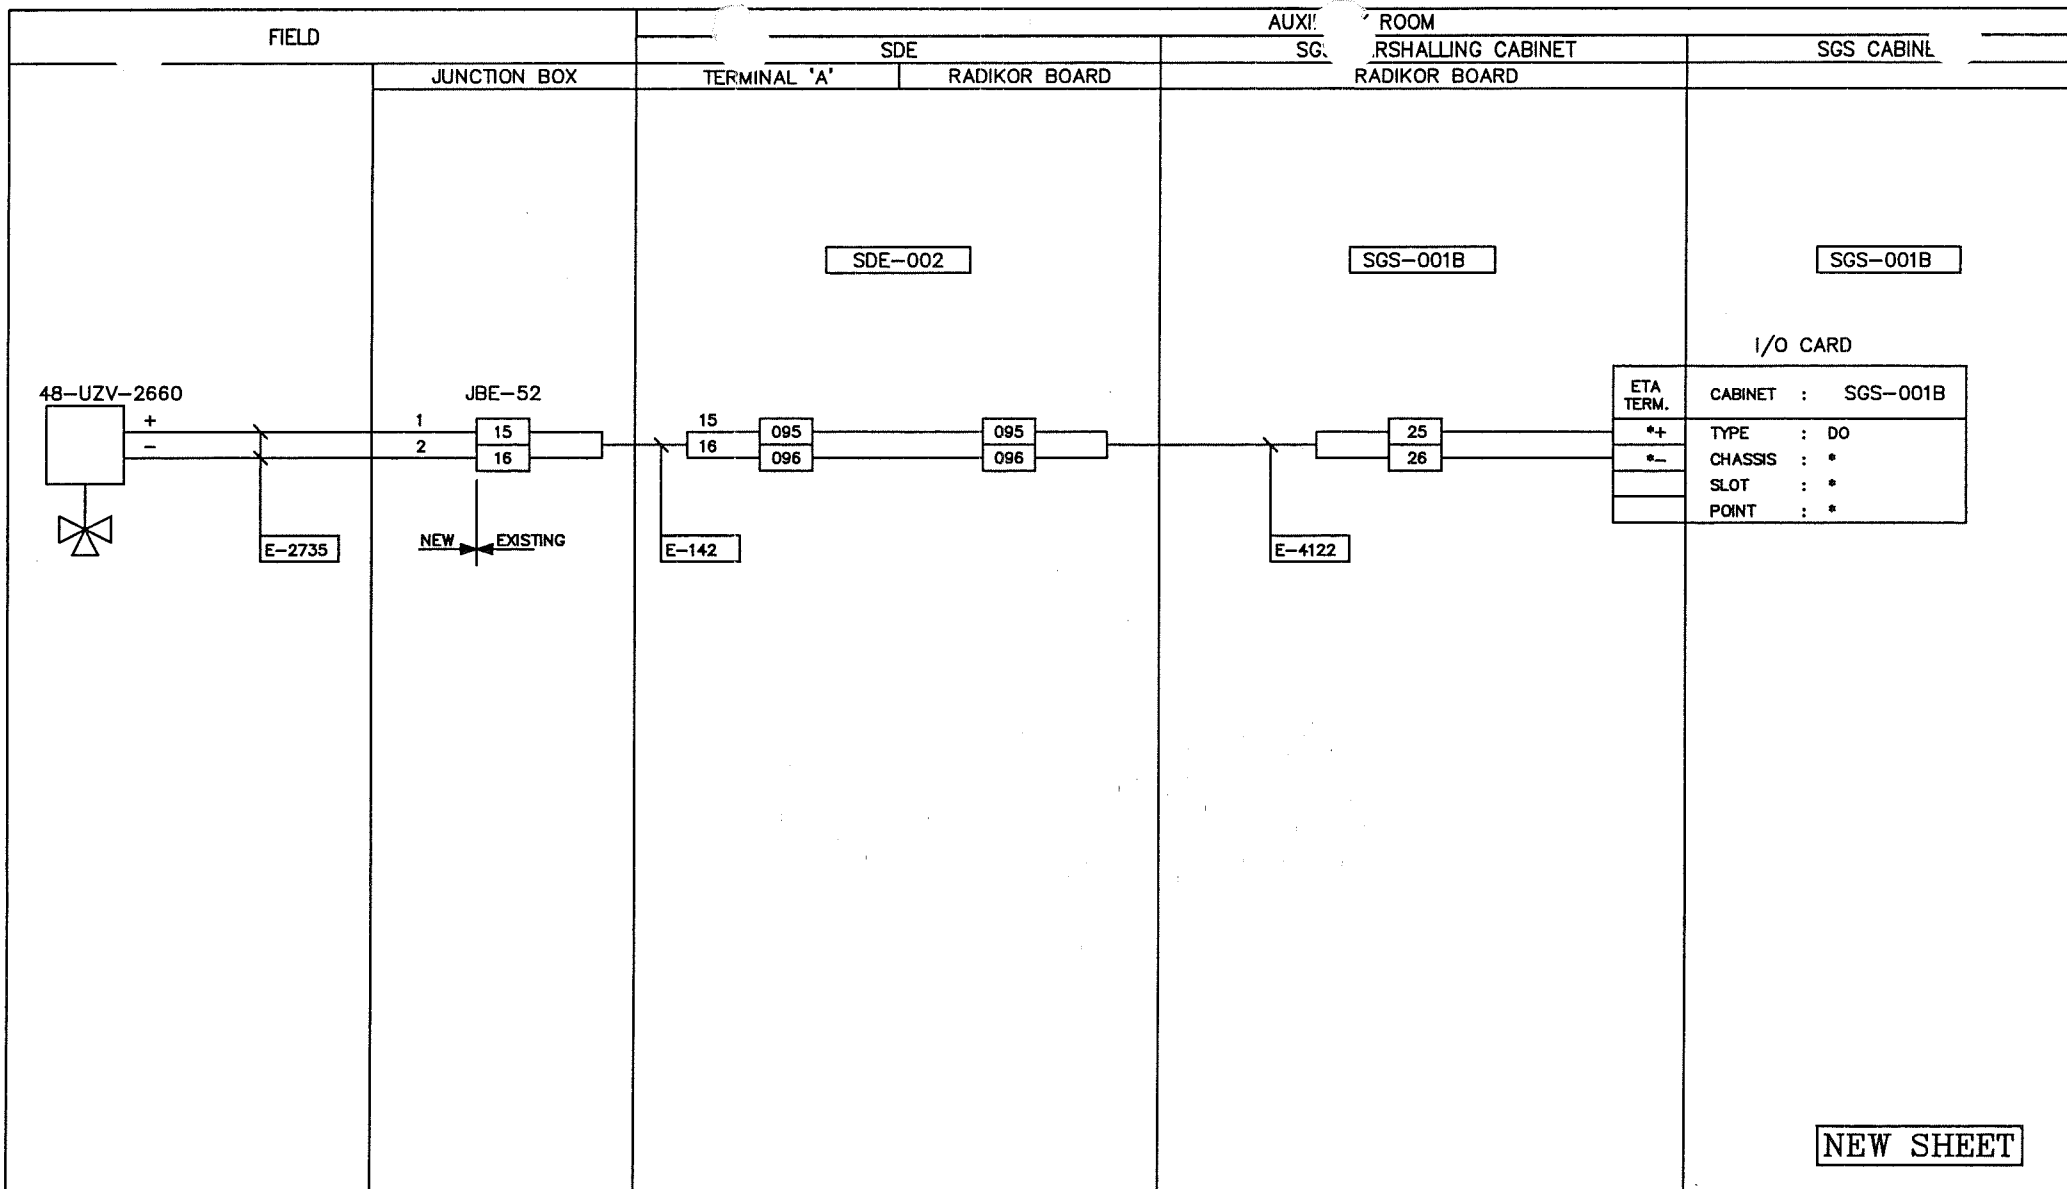


NEW SHEET

						SCALE : 0 1 2 3 4 5 6 7		CAD DRAWING																	
						AREA : NIMR		No. 05																	
						SUB AREA : PRODUCTION STATION		 شركة تنمية نفط عمان Petroleum Development Oman																	
						DRWG. TYPE : SGS INST. LOOP DIAGRAMS		<table border="1" style="font-size: 8px;"> <tr> <th>DRWG</th> <th>AREA CODE</th> <th>ENG SECT</th> <th>SERIAL NUMBER</th> <th>SHEET</th> <th>PROJ CODE</th> <th>DWG SIZE</th> <th>REV.</th> </tr> <tr> <td>NIM</td> <td>5</td> <td>5596</td> <td>231DQ</td> <td>3</td> <td></td> <td></td> <td>A</td> </tr> </table>		DRWG	AREA CODE	ENG SECT	SERIAL NUMBER	SHEET	PROJ CODE	DWG SIZE	REV.	NIM	5	5596	231DQ	3			A
DRWG	AREA CODE	ENG SECT	SERIAL NUMBER	SHEET	PROJ CODE	DWG SIZE	REV.																		
NIM	5	5596	231DQ	3			A																		
						DESCRIPTION : 48UZV-2660 T-4807 INLET ESDV																			

REV	DATE	APPROVED BY	DESCRIPTION	BJ.NO.	PROJ.ENG.	SPEC.ENG.	PDO APPROVAL

* SYSTEM DETAILS AWAITED.

NOTES/REFERENCE DRAWINGS MASTER DRAWING REVISION
IN CASE OF DEVIATIONS MARKED UP PRINT SHALL BE SENT TO COASTAL DESIGN OFFICE

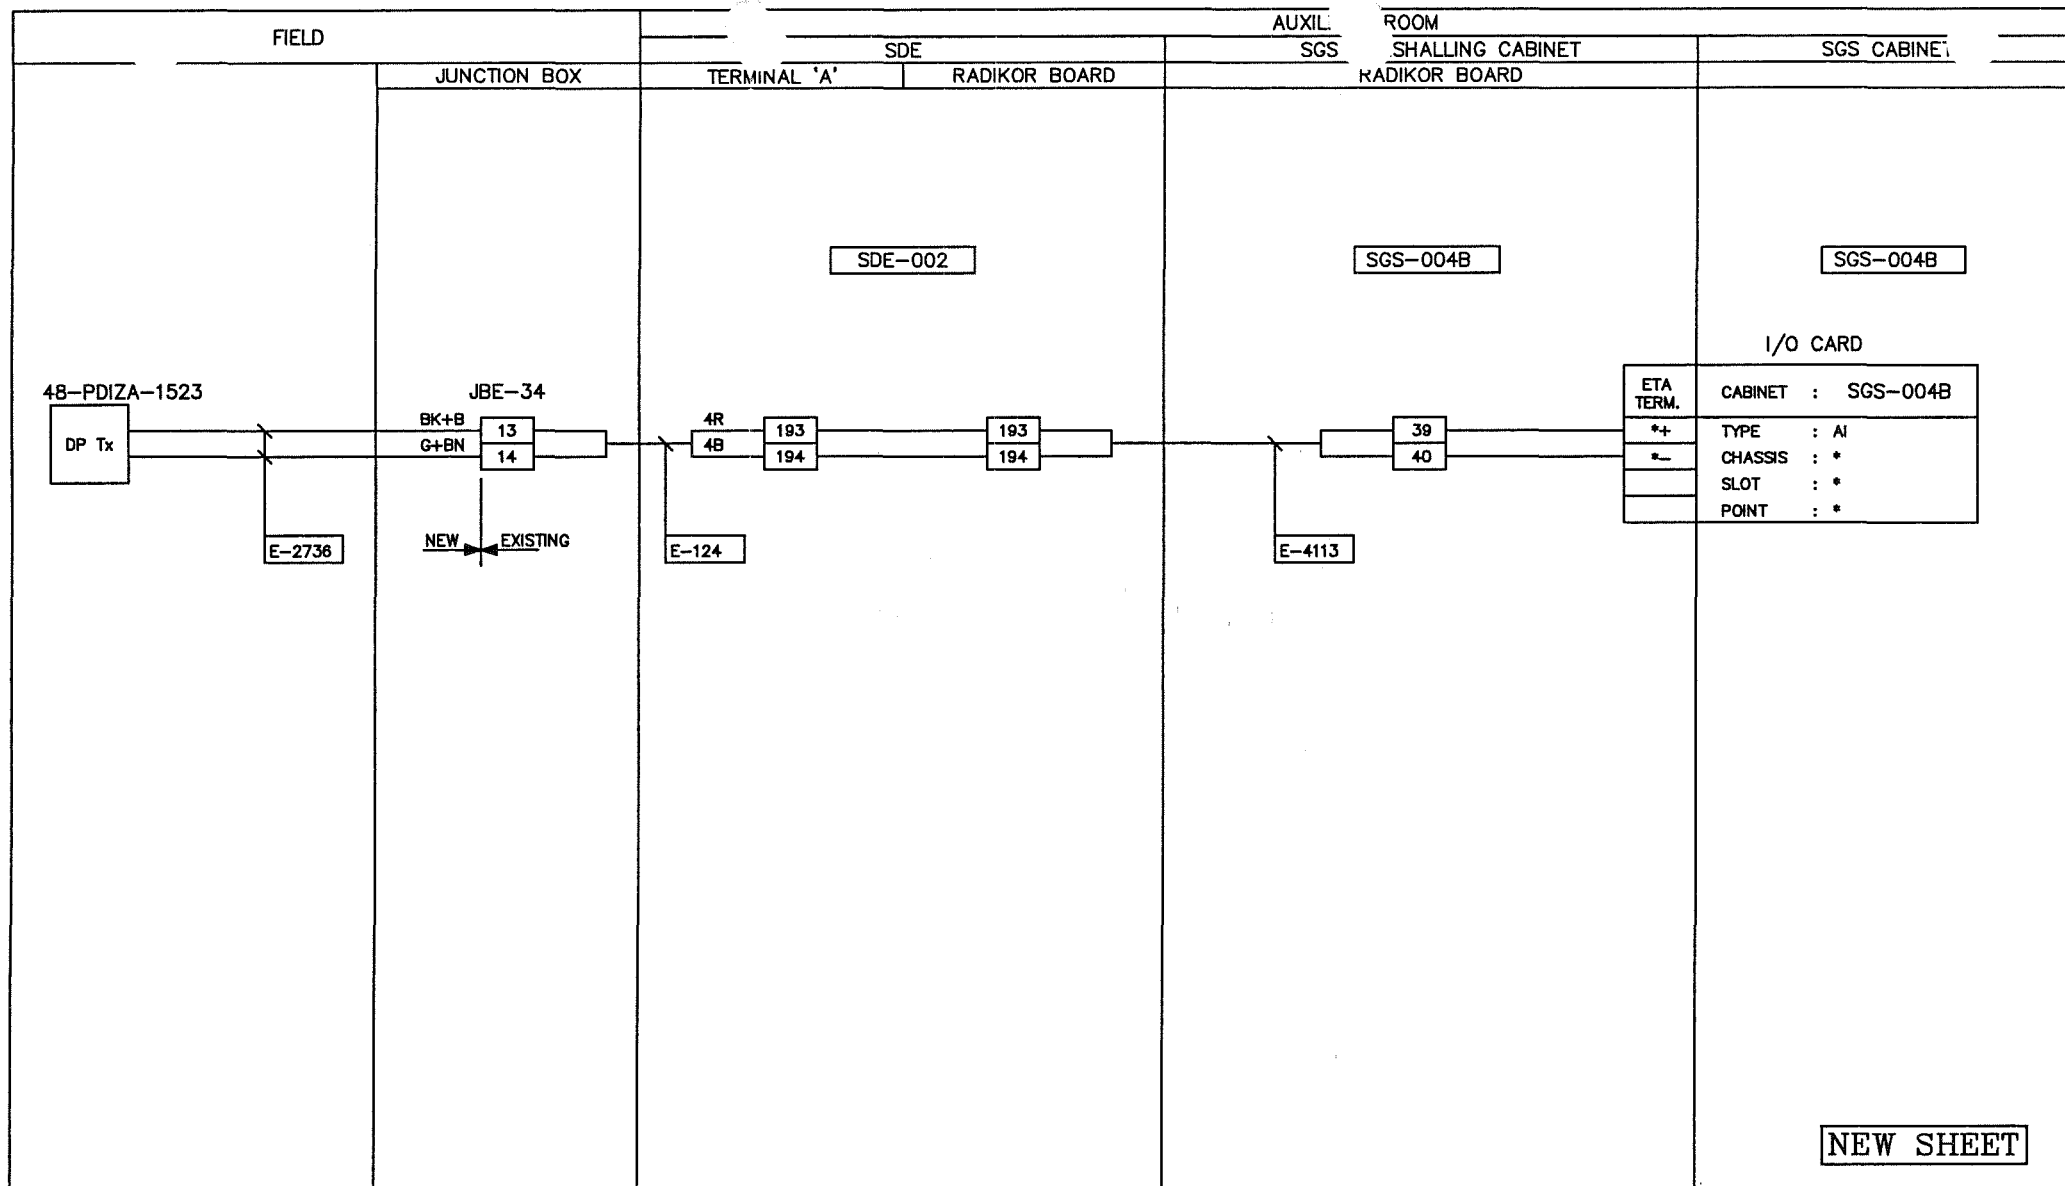

NEW SHEET

* SYSTEM DETAILS AWAITED.		REV DATE APPROVED BY		DESCRIPTION B.I.N.O.		PROJ.ENG. SPEC.ENG. PDO APPROVAL		AREA : NIMR SUB AREA : PRODUCTION STATION NO. 05		DRWG TYPE : SGS INST. LOOP DIAGRAMS DESCRIPTION : 48PDIZA-1523 DP ACROSS 48UZV-2660		SCALE : 0 1 2 3 4 5 6 7 CAD DRAWING	
												NO NIM 5 5596 450DQ 3 A	

SUMMARY OF INSTRUMENTATION CABLES

FOR MULTICORE CABLES REF. DRG. : NIM-5-5044

FOR SIGNAL CABLES REF. DRG. : NIM-5-9925

FOR SYSTEM CABLES REF. DRG. : NIM-5-5591 & NIM-5-5906

PLC shall be replaced with RTU

SCOPE OF 'DQ' PROJECT
WBS.NO: NIM.IN.09.011


[Signature]

15/4/2011

APPROVED FOR
CONSTRUCTION

* LATEST REV. IS 'N' (APR.05)

REV	DATE	DRAWN BY	TEAM LEAD	J. ENG.	CHECKED	DESCRIPTION	B.I. NO	PROJ. ENG.	SIGNATURE
A	MAR.'11	KK				APPROVED FOR CONSTRUCTION	IN.09.011	OSE/23N	
O	DEC.'10	NS	PT	KSD		ISSUED FOR COMMENTS	IN.09.011	OSE/23N	IH
						P D O APPROVAL			

PROJECT DRAWING REVISION									
IN CASE OF DEVIATIONS A MARKED UP PRINT SHALL BE SENT TO THE PROJECT ENGINEER									
AREA : NIMR						SCALE : 1 : 1000			
SUB AREA : PRODUCTION STATION						NO. 05			
DRWG. TYPE : SUMMARY OF INST. CABLES						CAD DRAWING			
DESCRIPTION : COVER SHEET						 شركة تنمية نفط عمان Petroleum Development Oman			
DRWG	AREA CODE	ENG SECT	SERIAL NUMBER	SHEET	PROJ CODE	DWG SIZE	REV.		
NO	NIM	5	5044	000	DQ	3	A		

	N	APR.'05	AS BUILT FOR PROJECT '5X'	02.001		BW
	M	JAN.'05	AS BUILT FOR PROJECT '3Y & X4'	00.394/95.052		BW
	L	DEC.'04	AS BUILT FOR PROJ. '5R'	01.116	OSE/24N	
	K	DEC.'04	AS BUILT FOR PROJECT '5X'	02.001		BW
	J	MAR.'02	AS BUILT FOR PROJECT '4P'	00.802	OME/41	JAMAL
	H	FEB.'02	AS BUILT FOR PROJECT '3R'	00818	OME/26	
	REV	DATE	APPROVED BY	DESCRIPTION	B.I.NO.	PROJ.ENG. SPEC.ENG. PDO APPROVAL

NOTES/REFERENCE DRAWINGS MASTER DRAWING REVISION
IN CASE OF DEVIATIONS MARKED UP PRINT SHALL BE SENT TO COASTAL DESIGN OFFICE



SHEET No.	REVISION	CURRENT REVISION																									
		O	A	B	C	D	E	F	G	H	I	J	K	L	M	N	O	P	Q	R	S	T	U	V	W	X	Y
00	COVER SHEET																										
01	REVISION SHEET																										
02	REVISION SHEET																										
03	REVISION SHEET																										
04	REVISION SHEET																										
05	GENERAL NOTES																										
06	GENERAL NOTES																										
07																											
08																											
09																											
10																											
11	No 6001 TO 6030	SEE SHT 278																									
12	No 6031 TO 6060	SEE SHT 285																									
13	No 6061 TO 6090	SEE SHT 290																									
14	No 6091 TO 6120	SEE SHT 290																									
15	No 6121 TO 6150																										
16	No 6151 TO 6180	SEE SHT 284																									
17	No 6181 TO 6210																										
18	No 6211 TO 6240																										
19	No 6241 TO 6270																										
20	No 6271 TO 6300																										
21	No 6301 TO 6330																										
22	No 6331 TO 6360																										
23	No 6361 TO 6390																										
24	No 6391 TO 6420																										
25	No 6421 TO 6450																										
26	No 6451 TO 6480																										
27	No 6481 TO 6510																										
28	No 6511 TO 6540																										
29	No 6541 TO 6570																										
30	No 6571 TO 6600																										
31	No 6601 TO 6630																										
32	No 6631 TO 6660																										
33	No 6661 TO 6690																										
34	No 6691 TO 6720																										
35	No 6721 TO 6750																										

* LATEST REV. IS 'N' (APR.05)

N	APR '05	AS BUILT FOR PROJECT '5X'	02.001	BW
M	JAN '05	AS BUILT FOR PROJECT '3Y & X4'	00.394/95.052	BW
L	DEC '04	AS BUILT FOR PROJ '5R'	01.116 OSE/24N	
K	DEC '04	AS BUILT FOR PROJECT '5K'	02.001	BW
J	MAR '02	AS BUILT FOR PROJECT '4P'	00.802 OME/41	JAMAL
H	FEB '02	AS BUILT FOR PROJECT '3R'	00.818 OME/26	

1) CABLE No 7001 TO 8000
SEE DWG. NIM-5-9925

REV	DATE	APPROVED BY	DESCRIPTION	B.I.NO.	PROJ.ENG.	SPEC.ENG.	PDO APPROVAL
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NOTES/REFERENCE DRAWINGS

MASTER DRAWING REVISION

IN CASE OF DEVIATIONS MARKED UP PRINT SHALL BE SENT TO COASTAL DESIGN OFFICE


SHEET No.	DESCRIPTION	CURRENT REVISION																									
		O	A	B	C	D	E	F	G	H	J	K	L	M	N	O	P	Q	R	S	T						
36	No 6751 TO 6780																										
37	No 6781 TO 6810																										
38	No 6811 TO 6840																										
39	No 6841 TO 6870																										
40	No 6871 TO 6900																										
41	No 6901 TO 6930																										
42	No 6931 TO 6960																										
43	No 6961 TO 6990																										
44	No 6991 TO 7000																										
45	No 7001 TO 7030																										
46	No 7031 TO 7060																										
47	No 7061 TO 7090																										
48	No 7091 TO 7120																										
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70																											

REV	DATE	DRAWN BY	TEAM L.	J. LENG.	CHECKED	DESCRIPTION	B.I. NO	PROJ. ENG.	SIGNATURE
PROJECT DRAWING REVISION									
IN CASE OF DEVIATIONS A MARKED UP PRINT SHALL BE SENT TO THE PROJECT ENGINEER									
AREA : NIMR							SCALE : 1:1000		
SUB AREA : PRODUCTION STATION							NO. 05		
DRWG. TYPE : INSTR. CONTROL CABLE SCHEDULE							DRWG. AREA ENG. SERIAL SHEET PROJ. DWG. REV.		
DESCRIPTION : REVISION/INDEX SHEET							NO NIM 5 5044 001 DQ 3 A		



REV	DESCRIPTION OF CABLE					DESCRIPTION OF RUN			CABLE REF	GLAND			REMARKS
	NUMBER	SIZE mm	LENGTH M	OUTER SHEATH COLOUR	TYPE	VOLT	FROM	TO		TYPE	SIZE	REF	
	48-												
	-6901												
	-6902												
	-6903												
	-6904												
	-6905												
	-6906												
O	E-6907	10x2x0.8mm	150	BLACK	XLPEI-MS-SWA-PVCS	24	48-JBE-6907	48-PLC-0001					
O	E-6908	10x2x0.8mm	150	BLACK	XLPEI-MS-SWA-PVCS	24	48-JBE-6908	48-PLC-0001					
O	E-6909	10x2x0.8mm	150	BLACK	XLPEI-MS-SWA-PVCS	24	48-JBE-6909	48-PLC-0001					
O	E-6910	10x2x0.8mm	130	BLACK	XLPEI-MS-SWA-PVCS	24	48-JBE-6910	48-PLC-0001					(VENDOR JB)
O	E-6911	10x2x0.8mm	130	BLACK	XLPEI-MS-SWA-PVCS	24	48-JBE-6911	48-PLC-0001					(VENDOR JB)
O	E-6912	10x2x0.8mm	130	BLACK	XLPEI-MS-SWA-PVCS	24	LOCAL CONTRL PNL	48-PLC-0001					(VENDOR PNL)
O	E-6913	10x2x0.8mm	130	BLACK	XLPEI-MS-SWA-PVCS	24	LOCAL CONTRL PNL	48-PLC-0001					(VENDOR PNL)
	E-6914												(SPARE)
	E-6915												(SPARE)
	E-6916												(SPARE)
	-6917												
	-6918												
	-6919												
	-6920												
	-6921												
	-6922												
	-6923												
	-6924												
	-6925												
	-6926												
	-6927												
	-6928												
	-6929												
	-6930												

NEW SHEET

						AREA : NIMR		SCALE : — 0 1 2 3 4 5 6 7		CAD DRAWING	
						SUB AREA : PRODUCTION STATION		NO. 05		 شركة تنمية نفط عمان Petroleum Development Oman	
						DRWG TYPE : INSTRUMENT CABLE SCHEDULE				DRWG AREA ENG SERIAL SHEET PROJ DWG REV. CODE CODE SECT NUMBER CODE CODE SIZE	
						DESCRIPTION : CABLE No. E-6901 TO E-6930				NO NIM 5 5044 303 DQ 3 A	
NOTES/REFERENCE DRAWINGS IN CASE OF DEVIATIONS MARKED UP PRINT SHALL BE SENT TO COASTAL DESIGN OFFICE						MASTER DRAWING REVISION PDG APPROVAL					




REV	DESCRIPTION OF CABLE					DESCRIPTION OF RUN			CABLE REF	GLAND			REMARKS
	NUMBER	SIZE mm	LENGTH M	OUTER SHEATH COLOUR	TYPE	VOLT	FROM	TO		TYPE	SIZE	REF	
	48-												
	-2701												
	-2702												
	-2703												
	-2704												
	-2705												
0	E-2706	2x2x1.13mm	40	BLACK	XLPEI-MS-SWA-PVCS	24	48-LIA-1447	48-JBE-6907					(NEW JB)
0	E-2707	2x2x1.13mm	40	BLACK	XLPEI-MS-SWA-PVCS	24	48-LIZA-1448	48-JBE-6907					(NEW JB)
0	E-2708	2x2x1.13mm	40	BLACK	XLPEI-MS-SWA-PVCS	24	48-TIA-1468	48-JBE-6907					(NEW JB)
0	E-2709	2x2x1.13mm	40	BLACK	XLPEI-MS-SWA-PVCS	24	48-FI-1414	48-JBE-6907					(NEW JB)
0	E-2710	2x2x1.13mm	40	BLACK	XLPEI-MS-SWA-PVCS	24	48-LIZA-1451	48-JBE-6908					(NEW JB)
0	E-2711	2x2x1.13mm	40	BLACK	XLPEI-MS-SWA-PVCS	24	48-LIA-1452	48-JBE-6908					(NEW JB)
0	E-2712	2x2x1.13mm	40	BLACK	XLPEI-MS-SWA-PVCS	24	48-PIZA-1516	48-JBE-6908					(NEW JB)
0	E-2713	2x2x1.13mm	40	BLACK	XLPEI-MS-SWA-PVCS	24	48-PDIA-1520	48-JBE-6908					(NEW JB)
0	E-2714	2x2x1.13mm	40	BLACK	XLPEI-MS-SWA-PVCS	24	48-PDIA-1521	48-JBE-6908					(NEW JB)
0	E-2715	2x2x1.13mm	40	BLACK	XLPEI-MS-SWA-PVCS	24	48-XZA-2342	48-JBE-6909					(NEW JB)
0	E-2716	2x2x1.13mm	40	BLACK	XLPEI-MS-SWA-PVCS	24	48-XZA-2343	48-JBE-6909					(NEW JB)
0	E-2717A	2x2x1.13mm	40	BLACK	XLPEI-MS-SWA-PVCS	24	48-HS-2219A	48-JBE-6909					(NEW JB)
0	E-2717B	2x2x1.13mm	40	BLACK	XLPEI-MS-SWA-PVCS	24	48-HS-2219B	48-JBE-6909					(NEW JB)
0	E-2718	2x2x1.13mm	40	BLACK	XLPEI-MS-SWA-PVCS	24	48-HS-2658	48-JBE-6909					(NEW JB)
0	E-2719A	2x2x1.13mm	40	BLACK	XLPEI-MS-SWA-PVCS	24	48-HS-2220A	48-JBE-6909					(NEW JB)
0	E-2719B	2x2x1.13mm	40	BLACK	XLPEI-MS-SWA-PVCS	24	48-HS-2220B	48-JBE-6909					(NEW JB)
0	E-2720	2x2x1.13mm	40	BLACK	XLPEI-MS-SWA-PVCS	24	48-HS-2660	48-JBE-6909					(NEW JB)
0	E-2721	2x2.5 Sq.mm	30	BLACK	XLPEI-SWA-PVCS	24	48-XA-4106	48-PLC-0001					(STRIGHT RUN)
0	E-2722	2x2.5 Sq.mm	50	BLACK	XLPEI-SWA-PVCS	24	ELECTRICL DB	48-FI-1414					(POWER SUPPLY)
0	E-2723A	2x2x1.13mm	40	BLACK	XLPEI-MS-SWA-PVCS	24	48-HS-2661A	48-JBE-6910					(VENDOR JB)
0	E-2723B	2x2x1.13mm	40	BLACK	XLPEI-MS-SWA-PVCS	24	48-HS-2661B	48-JBE-6910					(VENDOR JB)
0	E-2724A	2x2x1.13mm	40	BLACK	XLPEI-MS-SWA-PVCS	24	48-HS-2662A	48-JBE-6910					(VENDOR JB)
0	E-2724B	2x2x1.13mm	40	BLACK	XLPEI-MS-SWA-PVCS	24	48-HS-2662B	48-JBE-6910					(VENDOR JB)
0	E-2725	2x2x1.13mm	40	BLACK	XLPEI-MS-SWA-PVCS	24	48-HS-2663	48-JBE-6910					(VENDOR JB)
0	E-2726	2x2x1.13mm	40	BLACK	XLPEI-MS-SWA-PVCS	24	48-HS-2664	48-JBE-6910					(VENDOR JB)

NEW SHEET

AREA : NIMR SUB AREA : PRODUCTION STATION DRWG TYPE : INSTRUMENT CABLE SCHEDULE DESCRIPTION : CABLE No. E-2701 TO E-2726						NO. 05 SCALE : 1:1000 CAD DRAWING 0 1 2 3 4 5 6 7	
REV : DATE : APPROVED BY : DESCRIPTION : B.I.NO. : PROJ.ENG. : SPEC.ENG. : PDO APPROVAL :						شركة تنمية نفط عمان Petroleum Development Oman DRWG : AREA CODE : ENG SECT : SERIAL NUMBER : SHEET : PROJ CODE : DWG SIZE : REV. :	
NOTES/REFERENCE DRAWINGS IN CASE OF DEVIATIONS MARKED UP PRINT SHALL BE SENT TO COASTAL DESIGN OFFICE						MASTER DRAWING REVISION NO : NIM 5 5044 400 DQ 3 A	

REV	DESCRIPTION OF CABLE						DESCRIPTION OF RUN		CABLE REF	GLAND			REMARKS
	NUMBER 48-	SIZE mm	LENGTH M	OUTER SHEATH COLOUR	TYPE	VOLT	FROM	TO		TYPE	SIZE	REF	
0	E-2727	2x2x1.13mm	40	BLACK	XLPEI-MS-SWA-PVCS	24	48-LIA-1449	48-JBE-6911					(VENDOR JB)
0	E-2728	2x2x1.13mm	40	BLACK	XLPEI-MS-SWA-PVCS	24	48-LIZA-1450	48-JBE-6911					(VENDOR JB)
0	E-2729	2x2x1.13mm	40	BLACK	XLPEI-MS-SWA-PVCS	24	48-PIZA-1518	48-JBE-6911					(VENDOR JB)
0	E-2730	2x2x1.13mm	40	BLACK	XLPEI-MS-SWA-PVCS	24	48-PIZA-1519	48-JBE-6911					(VENDOR JB)
0	E-2731	2x2x1.13mm	40	BLACK	XLPEI-MS-SWA-PVCS	24	48-PI-1522	48-JBE-6911					(VENDOR JB)
0	E-2732	2x2x1.13mm	40	BLACK	XLPEI-MS-SWA-PVCS	24	48-FI-1415	48-JBE-6911					(VENDOR JB)
0	E-2733	2x2x1.13mm	30	BLACK	XLPEI-MS-SWA-PVCS	24	LOCAL CONTROL	LOCAL CNTRL PNL					(BY VENDOR)
0	E-2734	2x2x1.13mm	30	BLACK	XLPEI-MS-SWA-PVCS	24	LOCAL CONTROL	LOCAL CNTRL PNL					(BY VENDOR)
0	E-2735	2x2.5 Sq.mm	40	BLACK	XLPEI-SWA-PVCS	24	48-UZV-2660	48-JBE-52					(EXISTING JB)
0	E-2736	2x2x1.13mm	40	BLACK	XLPEI-MS-SWA-PVCS	24	48-PDIZA-1523	48-JBE-34					(EXISTING JB)
0	E-2737	2x2x1.13mm	40	BLACK	XLPEI-MS-SWA-PVCS	24	48-GBS-2660	48-JBE-45					(EXISTING JB)
0	E-2738	2x2x1.13mm	40	BLACK	XLPEI-MS-SWA-PVCS	24	48-HS-2230	48-JBE-45					(EXISTING JB)
	E-2739												(SPARE)
	E-2740												(SPARE)
	-2741												
	-2742												
	-2743												
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	-2753												
	-2754												
	-2755												
	-2756												

NEW SHEET

						AREA : NIMR		SCALE : 0 1 2 3 4 5 6 7		CAD DRAWING	
						SUB AREA : PRODUCTION STATION		NO. 05		 شركة تنمية نفط عُمان Petroleum Development Oman	
						DRWG TYPE : INSTRUMENT CABLE SCHEDULE				DRWG AREA ENG SERIAL SHEET PROJ DWG REV. CODE CODE SECT NUMBER CODE SIZE	
						DESCRIPTION : CABLE No. E-2727 TO E-2756				NO NIM 5 5044 401DQ 3 A	
NOTES/REFERENCE DRAWINGS IN CASE OF DEVIATIONS MARKED UP PRINT SHALL BE SENT TO COASTAL DESIGN OFFICE						MASTER DRAWING REVISION PDO APPROVAL					

DCS INSTRUMENT LOOP DIAGRAMS

system details to be provided

SCOPE OF 'DQ' PROJECT
WBS NO.: NIM.IN.09.011

15/4/2011


REFERENCE DRAWINGS :

SGS INST. LOOP DIAGRAMS PART-I : NIM-5-5595-A3
SGS INST. LOOP DIAGRAMS PART-II : NIM-5-5596-A3
INST. SIGNAL DIAGRAMS GFS : NIM-5-5067-A3
DCS INST. LOOP DIAGRAMS : NIM-5-5907

APPROVED FOR
CONSTRUCTION

	S	JUN'07	UMN/ASD	AS BUILT FOR PROJECT '9W'	0T.06.001	OSE/23N	IH
	R	APR.05		AS BUILT FOR PROJECT '5X'	02.001		BW
	Q	JAN.05		AS BUILT FOR PROJECT '3Y & X4'	00.394/95.052		BW
	P	DEC'04		AS BUILT FOR PROJECT '5R'	01.116	OSE/24N	
	O	JULY 97		AS BUILT FOR PROJECT 'L4'	93.609		
	REV	DATE	APPROVED BY	DESCRIPTION	WBS No BULK	PROJ.ENG. SPEC.ENG.	PDO APPROVAL

NOTES/REFERENCE DRAWINGS MASTER DRAWING REVISION
IN CASE OF DEVIATIONS MARKED UP PRINT SHALL BE SENT TO COASTAL DESIGN OFFICE

A	MAR.'11	KK			APPROVED FOR CONSTRUCTION	IN.09.011	OSE/23N	
O	DEC.'10	Mrp	PT	KDA	ISSUED FOR COMMENTS	IN.09.011	OSE/23N	IH
REV	DATE	DRAWN BY	TEAM	LENG.	DESCRIPTION	WBS No BULK	PROJ. ENG.	SIGNATURE
			CHECKED					P D O APPROVAL
PROJECT DRAWING REVISION								
IN CASE OF DEVIATIONS A MARKED UP PRINT SHALL BE SENT TO THE PROJECT ENGINEER								
AREA : NIMR						SCALE : 0 1 2 3 4 5 6 7		
SUB AREA : PRODUCTION STATION						NO. 05		
DRWG. TYPE : DCS INST. LOOP DIAGRAMS						 شركة تنمية نفط عمان Petroleum Development Oman		
DESCRIPTION : COVER SHEET						DRWG AREA ENG SERIAL SHEET PROJ DWG REV. CODE CODE SECT NUMBER CODE SIZE NO NIM 5 5594 001DQ 3 A		




DESCRIPTION	SHEET	REV O	REV A	REV B	REV P	REV Q	REV R	REV S
COVER SHEET	001	DEC.'10	MAR.'11		DEC. 04	JUN.'05	APR.'05	JUN.'07
REVISION/INDEX SHEET	002	DEC.'10	MAR.'11					
REVISION/INDEX SHEET	003							
REVISION/INDEX SHEET	004							
REVISION/INDEX SHEET	005					JAN.'05	APR.'05	
REVISION/INDEX SHEET	006	DEC.'10	MAR.'11					JUN.'07
REVISION/INDEX SHEET	007							
REVISION/INDEX SHEET	008				DEC. 04	JAN.'05		
REVISION/INDEX SHEET	009							
REVISION/INDEX SHEET	010							
REVISION/INDEX SHEET	011						APR.'05	
REVISION/INDEX SHEET	012							
REVISION/INDEX SHEET	013							
REVISION/INDEX SHEET	014							
REVISION/INDEX SHEET	015							
REVISION/INDEX SHEET	016					JAN.'05	APR.'05	
SPARE	017							
FI-1345	018					JAN.'05		
FI-1346	019							
FI-1347	020							
FI-1348	021							
FI-1349	022							
FI-1350	023							
SPARE	024							
LEGEND SHEET	025	JULY.97			DEC. 04			
SPARE	026							
GBS-2081 OPEN/CLOSE	027							
SPARE	028							
SPARE	029							
FRQ-087	030							
FRQ-651	031							
FRQ-653	032							
FRQ-654 DELETED	033						DELETED	
FRQ-655	034							

DESCRIPTION	SHEET	REV O	REV D	REV F	REV G	REV H	REV I	REV J
FRQ-656	035							JUN.'01
FICA-252	036	MAR.98	NOV.98					
FICA-252	037							
FICA-253	038							
FICA-253	039							
FICA-254	040							
FICA-254	041							
FIC-1131	042	JULY.97						
FIC-1132	043							
FIC-1133	044							
FR-131A/B & FRC-131A/B	045							JAN.'05
FRQ-1307	046	MAR.98	NOV.98					
FR-132A/B & FRC-132A/B	047							JAN.'05
FR-133A/B & FRC-133A/B	048							
FR-134A/B & FRC-134A/B	049							
FICA-1252(FLD TO DCS)	050	JULY.97						
FICA-1252(DCS TO SGS)	051							
FICA-428 (FLD TO DCS)	052							
FICA-428 (DCS TO SGS)	053							
FICA-701	054							
FICA-702	055							
FICA-701	056							
FICA-702	057							
SPARE	058							
FR-037	059	JULY.97						
FR-038	060							
FR-039	061							
FR-401	062							
FA-1312	063	SEP.99				SEP.'00		
FA-1313	064							
FA-1314	065							
FA-1315	066							
FRA-031	067	JULY.97						
FRA-033	068							

S	JUN.'07	UMN/ASD	AS BUILT FOR PROJECT '9W'	01.06.001	OSE/23N	HH
R	APR.'05		AS BUILT FOR PROJECT '5X'	02.001		BW
Q	JAN.'05		AS BUILT FOR PROJECT '3Y & X4'	00.394/95.052		BW
P	DEC.'04		AS BUILT FOR PROJECT '5R'	01.116	OSE/24N	
O	JULY 97		AS BUILT FOR PROJECT L4	93.609		
REV	DATE	APPROVED BY	DESCRIPTION	B.I.NO.	PROJ.ENG.	SPEC.ENG.
					PDO APPROVAL	

NOTES/REFERENCE DRAWINGS
IN CASE OF DEVIATIONS MARKED UP PRINT SHALL BE SENT TO COASTAL DESIGN OFFICE

MASTER DRAWING REVISION

REV	DATE	DRAWN BY	TEAM	LENG	DESCRIPTION	B.I. NO	PROJ. ENG.	SIGNATURE
			CHECKED					P D O APPROVAL
PROJECT DRAWING REVISION IN CASE OF DEVIATIONS A MARKED UP PRINT SHALL BE SENT TO THE PROJECT ENGINEER								
AREA : NIMR						SCALE : 0 1 2 3 4 5 6 7		
SUB AREA : PRODUCTION STATION						NO. 05		
DRWG TYPE : DCS INST. LOOP DIAGRAMS						 شركة تنمية نفط عمان Petroleum Development Oman		
DESCRIPTION : REVISION/INDEX SHEET						DRWG AREA ENG SERIAL SHEET PROJ DWG REV NO CODE SECT NUMBER CODE SIZE		
						NO NIM 5 5594 002DQ 3 A		

DESCR	N	SHEET	REV O	REV C	REV D	REV R	REV A	REV B
GBS-793		273	JULY.97					
GBS-794		274						
GBS-796 (FLD TO DCS)		275						
GBS-796 (DCS TO SGS)		276						
GBS-843		277						
GBS-844		278						
GBS-871 DELETED		279						
GBS-872		280						
GBS-876		281						
GBS-874		282						
GBS-893		283						
GBS-895		284						
GBS-901		285						
GBS-902		286						
GBS-904		287						
GBS-905		288						
GBS-906		289						
GBS-907		290						
GBS-909		291						
GB-1711		292	MAR.98		NOV.98			
GB-1712		293						
GB-1721		294						
GBS-1216		295						
GBS-1217		296						
GB-1722		297	MAR.98		NOV.98			
GBS-1501		298		APR. 98				
GBS-1511 DELETED		299		APR. 98		DELETED		
GBS-1520		300		APR. 98		APR.05		
GBS-1521		301		APR. 98				
GBS-1522		302		APR. 98				
GBS-1523		303		APR. 98				
GBS-1561		304		APR. 98				
GBS-1562		305		APR. 98				
GBS-1563 DELETED		306		APR. 98		DELETED		
GBS-1353		306A						
GBS-1354		306B						
SPARE		306C						
SPARE		306D						
SPARE		306E						
GBS-2660 (O/C)		306F						


S	JUN.'07	UMN/ASD	AS BUILT FOR PROJECT '9W'	01.06.001	OSE/23N	IH
R	APR.05		AS BUILT FOR PROJECT '5X'	02.001		BW
Q	JAN.05		AS BUILT FOR PROJECT '5X' & '4X'	00.394/95.052		BW
N	DEC 04		AS BUILT FOR PROJECT '5Y'	IN.02.062	JTP/57	
Q	JULY-97		AS BUILT FOR PROJECT L4	93.609		
REV	DATE	APPROVED BY	DESCRIPTION	B.I.NO.	PROLENG.	SPEC.ENG.
					PDO APPROVAL	

NOTES/REFERENCE DRAWINGS
IN CASE OF DEVIATIONS MARKED UP PRINT SHALL BE SENT TO COASTAL DESIGN OFFICE

MASTER DRAWING REVISION

DESCRIPTION	SHEET	REV O	REV C	REV D	REV E	REV G	REV I	REV S
GB-1330	307	AUG.97			SEPT.99			
GS-028	308	JULY.97	SHEET CANCELLED UNDER PROJECT '2H'				DEC. 04	
GS-035	309		SHEET CANCELLED UNDER PROJECT '2H'					
GS-313	310		SHEET CANCELLED UNDER PROJECT '2H'					
GS-417	311		SHEET CANCELLED UNDER PROJECT '2H'					
GS-418	312							
GS-438	313							
GS-450	314							
GS-696	315							
GS-896	316							
GS-900	317							
GB-1731	318	MAR.98		NOV.98				
GB-1732	319							
GB-1741	320							
GB-1742	321							
GB-1331	322	AUG.97			SEPT.99			
HBS-020	323	JULY.97						
HBS-031	324							
HBS-032	325							
HBS-037	326							
HBS-038	327							
HBS-059	328							
HBS-063	329							
HBS-075	330							
HBS-099	331							
HBS-211	332							
HBS-308	333							
HBS-417	334							JUN.'07
HBSA-335	335							
HBS-858	336							
HBS-859	337							
HBS-1951	338	MAR.98		NOV.98				
HBS-1959	339							
HBS-1961	340							


REV	DATE	DRAWN BY	TEAM	JENG.	DESCRIPTION	B.I. NO	PROJ. ENG.	SIGNATURE
			CHECKED					P D O APPROVAL
PROJECT DRAWING REVISION								
IN CASE OF DEVIATIONS A MARKED UP PRINT SHALL BE SENT TO THE PROJECT ENGINEER								
AREA : NIMR						SCALE : 0 1 2 3 4 5 6 7		
SUB AREA : PRODUCTION STATION						CAD DRAWING		
DRWG. TYPE : DCS INST. LOOP DIAGRAMS						شركة تنمية نفط عمان Petroleum Development Oman		
DESCRIPTION : REVISION/INDEX SHEET						DRWG AREA ENG SERIAL SHEET PROJ DWG REV.		
						NO NIM 5 5594 006DQ 3 A		

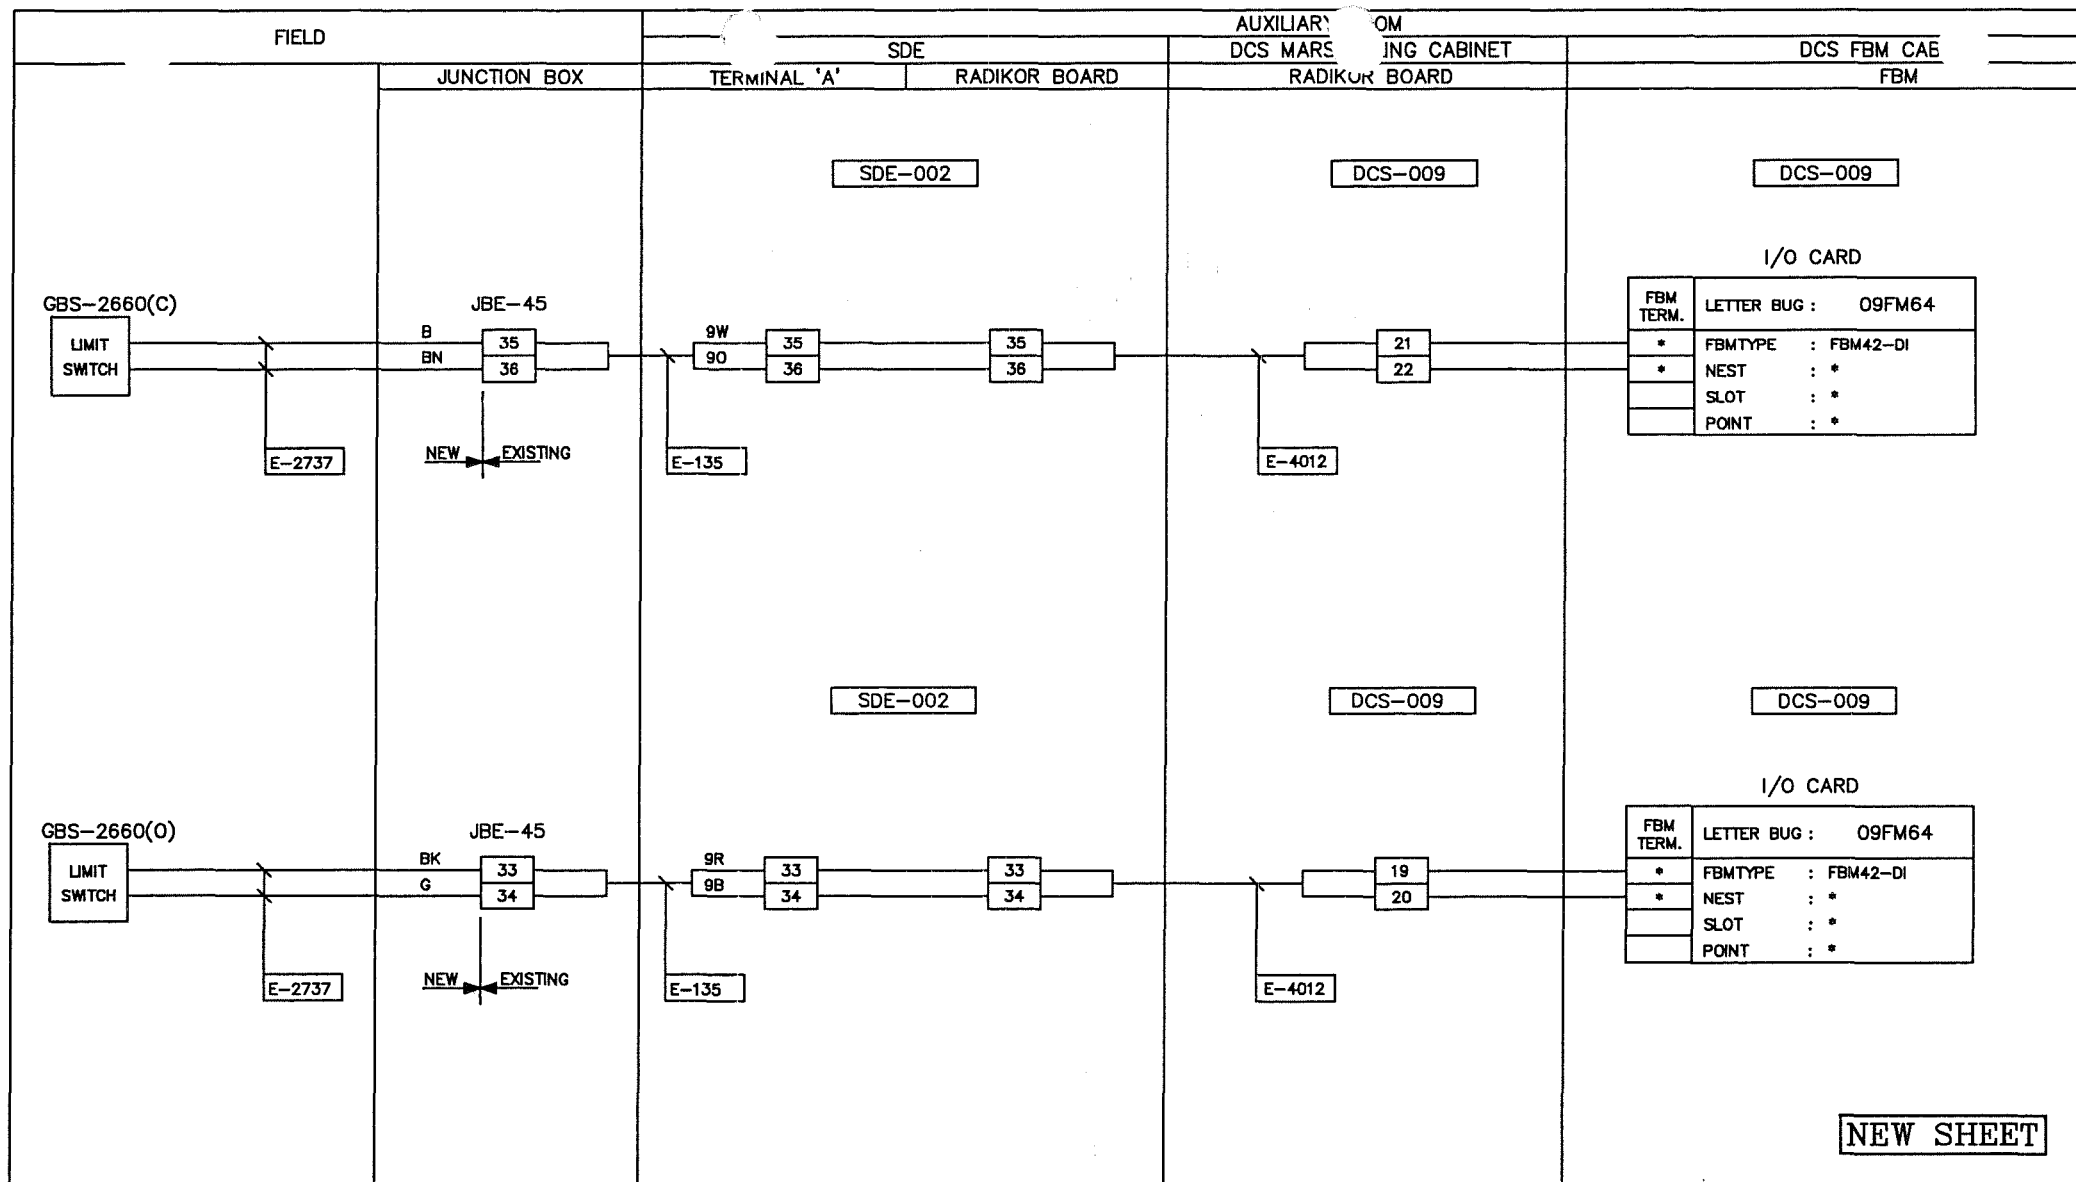

NEW SHEET

* SYSTEM DETAILS AWAITED.								AREA : NIMR				SCALE : 1 2 3 4 5 6 7			
								SUB AREA : PRODUCTION STATION				NO. 05			
								DRWG. TYPE : DCS INST. LOOP DIAGRAMS				 شركة تنمية نفط عمان Petroleum Development Oman			
NOTES/REFERENCE DRAWINGS IN CASE OF DEVIATIONS MARKED UP PRINT SHALL BE SENT TO COASTAL DESIGN OFFICE								MASTER DRAWING REVISION DESCRIPTION : GBS-2660 (O/C) T-4807 INLET VALVE STATUS				DRWG. AREA ENG SERIAL SHEET PROJ DWG REV. CODE CODE SECT NUMBER CODE SIZE NO NIM 5 5594306FDQ 3 A			



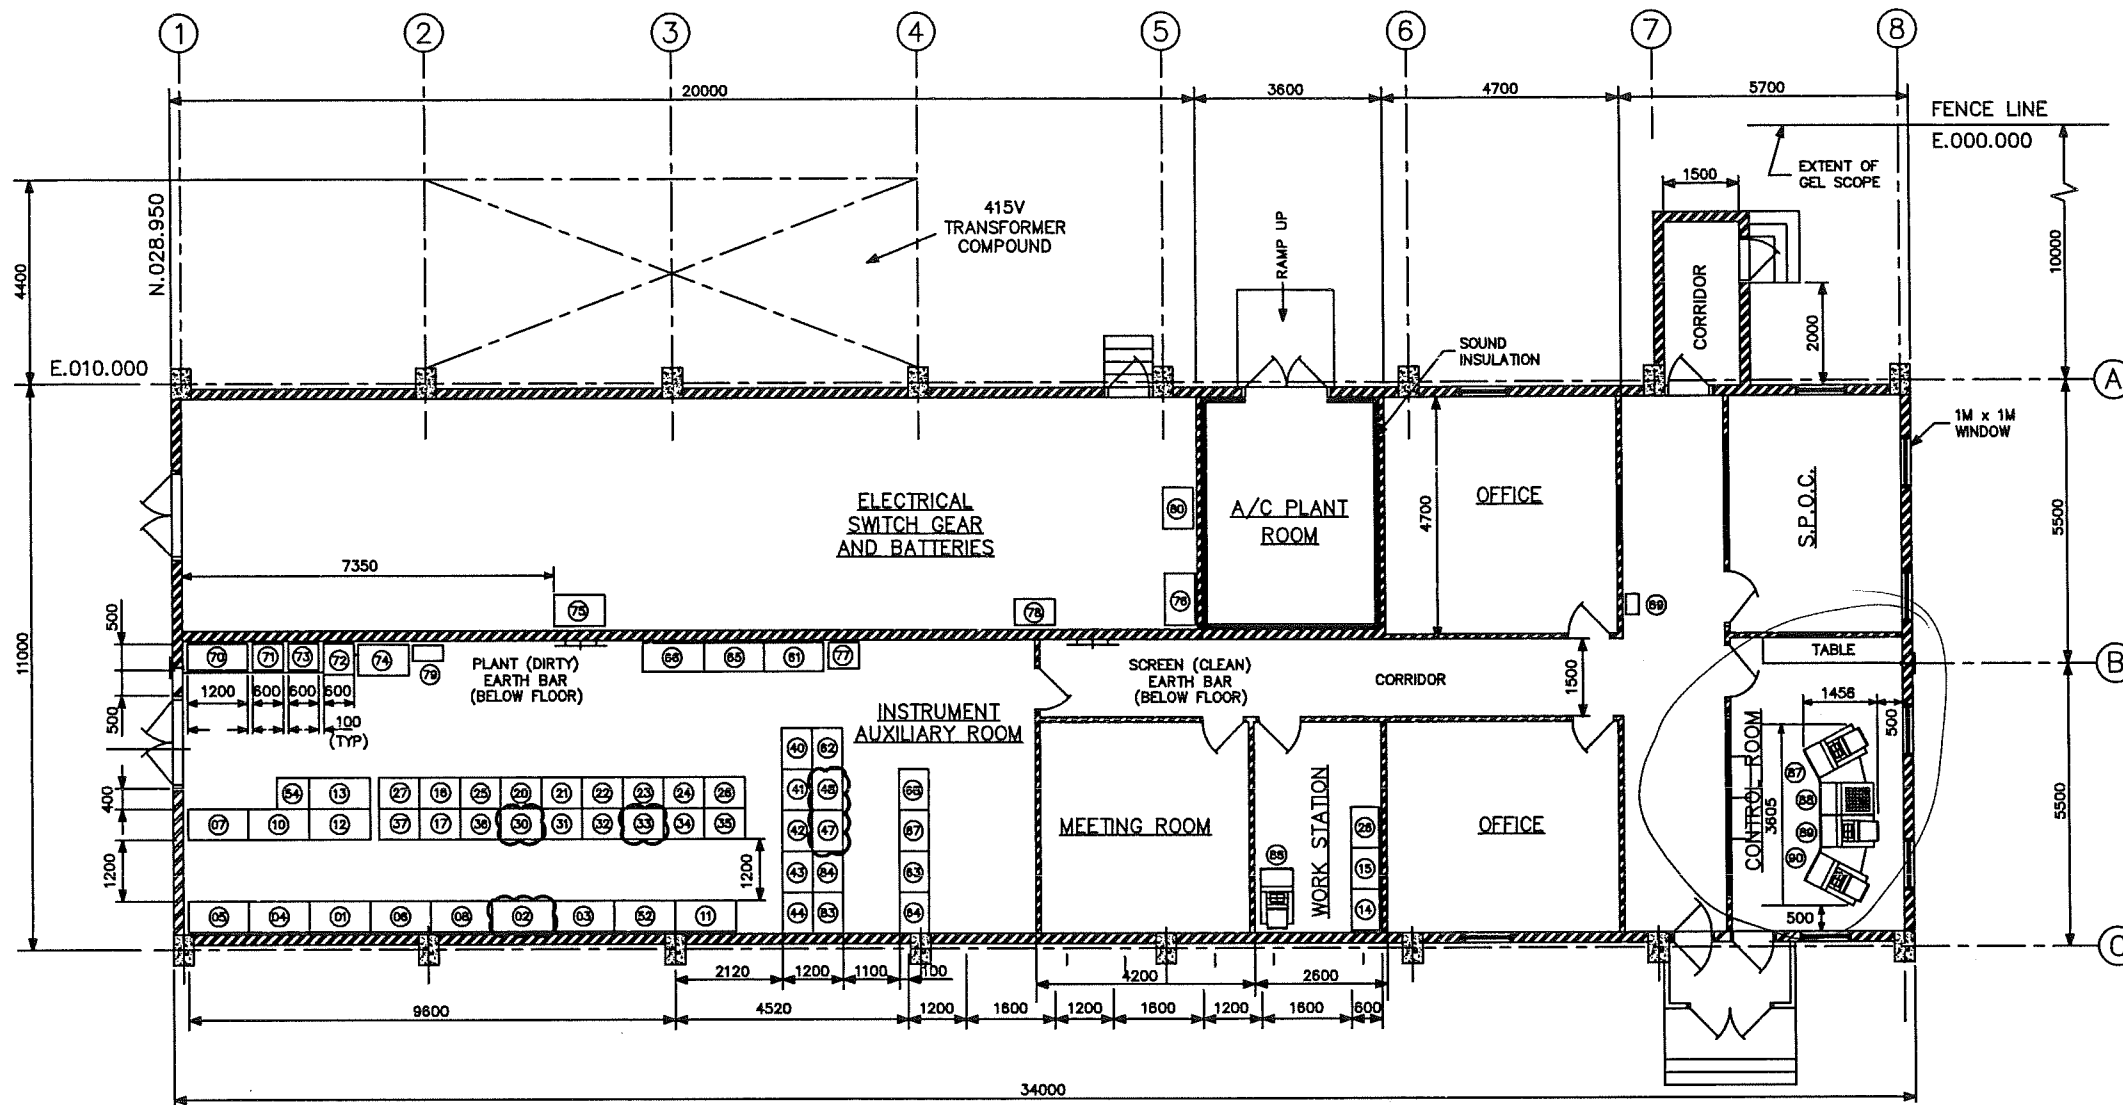

ITEM	TAG NO.	DESCRIPTION	DIMENSION		
			L	D	H
01	SDE-001	SIGNAL DISTRIBUTION CABINET	1200	800	2100
02	SDE-002	SIGNAL DISTRIBUTION CABINET	1200	800	2100
03	SDE-003	SIGNAL DISTRIBUTION CABINET	1200	800	2100
04	SDE-004	SIGNAL DISTRIBUTION CABINET	1200	800	2100
05	SDE-005	SIGNAL DISTRIBUTION CABINET	1200	800	2100
06	SDE-006	SIGNAL DISTRIBUTION CABINET	1200	800	2100
07	SDE-007	SIGNAL DISTRIBUTION CABINET	1200	800	2100
08	SDE-008	SIGNAL DISTRIBUTION CABINET	1200	800	2100
09	SDE-009	SIGNAL DISTRIBUTION CABINET	1200	800	2100
10	SDE-010	SIGNAL DISTRIBUTION CABINET	1200	800	2100
11	SDE-011	SIGNAL DISTRIBUTION CABINET	1200	800	2100
12					
13	SDEI-013	SIGNAL DISTRIBUTION CABINET	1200	800	2100
14	EQC-001	EQUIPMENT CABINET	800	600	2100
15	GFS-001	GAS / FIRE / SMOKE CABINET	800	600	2100
16	SGS-008A	SAFEGUARDING CABINET	800	600	2300
17	SGS-008B	SAFEGUARDING MARSHALLING CABINETS	800	600	2300
18					
19					
20	SGS-001A	SAFEGUARDING CABINET	800	600	2100
21	SGS-002A	SAFEGUARDING CABINET	800	600	2100
22	SGS-003A	SAFEGUARDING CABINET	800	600	2100
23	SGS-004A	SAFEGUARDING CABINET	800	600	2100
24	SGS-005A	SAFEGUARDING CABINET	800	600	2100
25	SGS-007A	SAFEGUARDING CABINET	800	600	2100
26	GFS-002	GAS / FIRE / SMOKE CABINET	800	600	2100
27	SGS-009A	SAFEGUARDING CABINET	800	600	2100
28					
29					
30	SGS-001B	SAFEGUARDING MARSHALLING CABINET	800	600	2100
31	SGS-002B	SAFEGUARDING MARSHALLING CABINET	800	600	2100
32	SGS-003B	SAFEGUARDING MARSHALLING CABINET	800	600	2100
33	SGS-004B	SAFEGUARDING MARSHALLING CABINET	800	600	2100
34	SGS-005B	SAFEGUARDING MARSHALLING CABINET	800	600	2100
35	SGS-006B	SAFEGUARDING MARSHALLING CABINET	800	600	2100
36	SGS-007B	SAFEGUARDING MARSHALLING CABINET	800	600	2100
37	SGS-009B	SAFEGUARDING MARSHALLING CABINET	800	600	2100
38					
39					
40	DCS-005	SYSTEM CABINET	800	600	2300
41	DCS-006	FBM CABINET	800	600	2300
42	DCS-008	DCS MARSHALLING CABINET	800	600	2300
43	DCS-007	FBM CABINET	800	600	2300
44	DCS-007	DCS MARSHALLING CABINET	800	600	2300
45					
46					
47	DCS-009	FBM CABINET	800	600	2300
48	DCS-009	DCS MARSHALLING CABINET	800	600	2300
49					
50					
51					
52					
53					
54	SDEI-013	SIGNAL DISTRIBUTION CABINET	800	600	2100
55					
56					
57					
58					
59					
60					

ITEM	TAG NO.	DESCRIPTION	DIMENSION		
			L	D	H
61	PSC-001	24V AC/24VDC CABINET	1200	800	2100
62	DCS-005A	SYSTEM CABINET	800	600	2300
63	DCS-010	FBM CABINET	800	600	2300
64	DCS-010	DCS MARSHALLING CABINET	800	600	2300
65	IFB-001	INSTRUMENT / ELECTRICAL INTERFACE BOX	1200	600	2100
66	IFB-002	INSTRUMENT / ELECTRICAL INTERFACE BOX	800	600	2100
67	DCS-011	FBM CABINET	800	600	2300
68	DCS-011	DCS MARSHALLING CABINET	800	600	2300
69		RADIO			
70	IDB-001	-	1200	500	-
71	IDB-001/1	-	600	500	-
72	IDB-002	-	600	500	-
73	IDB-003	-	800	500	-
74		UPS SYSTEM (DISTRIBUTION BOARD)			
75		UPS SYSTEM (RECTIFIER / INVERTER UNIT)			
76		UPS SYSTEM (BATTERY CUBICLE)			
77	DCS-IDB-001	24VDC POWER SUPPLY CABINET (FOR DCS MARSHALLING CABINETS)			
78		UPS SYSTEM (BATTERY CUBICLE)	1800	500	2000
79		UPS SYSTEM (DISTRIBUTION BOARD)	800	300	-
80		UPS SYSTEM (RECTIFIER / INVERTER UNIT)	800	800	-
83	DCS-008	FBM CABINET	800	600	2300
84	DCS-008	DCS MARSHALLING CABINET	800	600	2300
86	DCS-011	DCS WORKSTATION			
87	DCS-001	DCS WORKSTATION			
88	DCS-002	ESD PANEL OPERATOR CONSOLE			
89	DCS-003	DCS WORKSTATION			
90	DCS-004	DCS WORKSTATION			

use "As-Built"
Drawing

OSE/23N
15/4/2011

SCOPE OF 'DQ' PROJECT
WBS NO.: NIM.IN.09.011

APPROVED FOR
CONSTRUCTION

DATE	01.08.05	BY	SK	DATE	01.11.05	BY	SK
DATE	02.01.06	BY	BW	DATE	00.39.06	BY	BW
DATE	00.81.06	BY	ONE/26	DATE	00.81.06	BY	ONE/26

CONTRACT NO.: C31/0606 PROJ. NO.: PAIP00405

WorleyParsons - Arabian Industries (JV)

PROJECT DRAWING REVISION

IN CASE OF DEVIATIONS A MARKED UP PRINT SHALL BE SENT TO THE PROJECT ENGINEER

SCALE: 1:75

CAD DRAWING

AREA: NIMR

SUB AREA: PRODUCTION STATION

NO. 05

DRAWING TYPE: EQUIPMENT LAYOUT

DESCRIPTION: CONTROL / AUXILIARY ROOM

NO. NIM 5 5047 001 DQ 1 A

REV	DATE	DESCRIPTION	BY	CHKD	APPD
1	NOV.08	AS-BUILT UP TO NOV.08	ASD		
2	APR.07	AS-BUILT FOR PROJECT 'SR'			
3	APR.05	AS-BUILT FOR PROJECT 'SR'			
4	JAN.05	AS-BUILT FOR PROJECT '3Y'			
5	FEB.02	AS-BUILT FOR PROJECT '3R'			

2. EARTH BARS TO BE 2000mm LONG & MOUNTED BELOW FLOOR.

1. IDB-001, IDB-001/1 & IDB-002 ARE 2000mm HIGH FREE STANDING BOARDS. IDB-003 IS A WALL MOUNTED BOARD.

NOTES



REV	DATE	DESCRIPTION	BY	CHKD	APPD
1	NOV.08	AS-BUILT UP TO NOV.08	ASD		
2	APR.07	AS-BUILT FOR PROJECT 'SR'			
3	APR.05	AS-BUILT FOR PROJECT 'SR'			
4	JAN.05	AS-BUILT FOR PROJECT '3Y'			
5	FEB.02	AS-BUILT FOR PROJECT '3R'			

DRAWING CONTROL INDEX

REFERENCE DRAWINGS

MASTER DRAWING REVISION

IN CASE OF DEVIATIONS MARKED UP PRINT SHALL BE SENT TO COASTAL DESIGN OFFICE

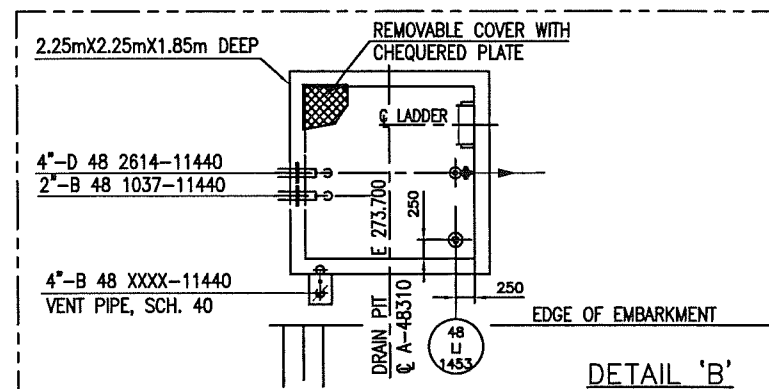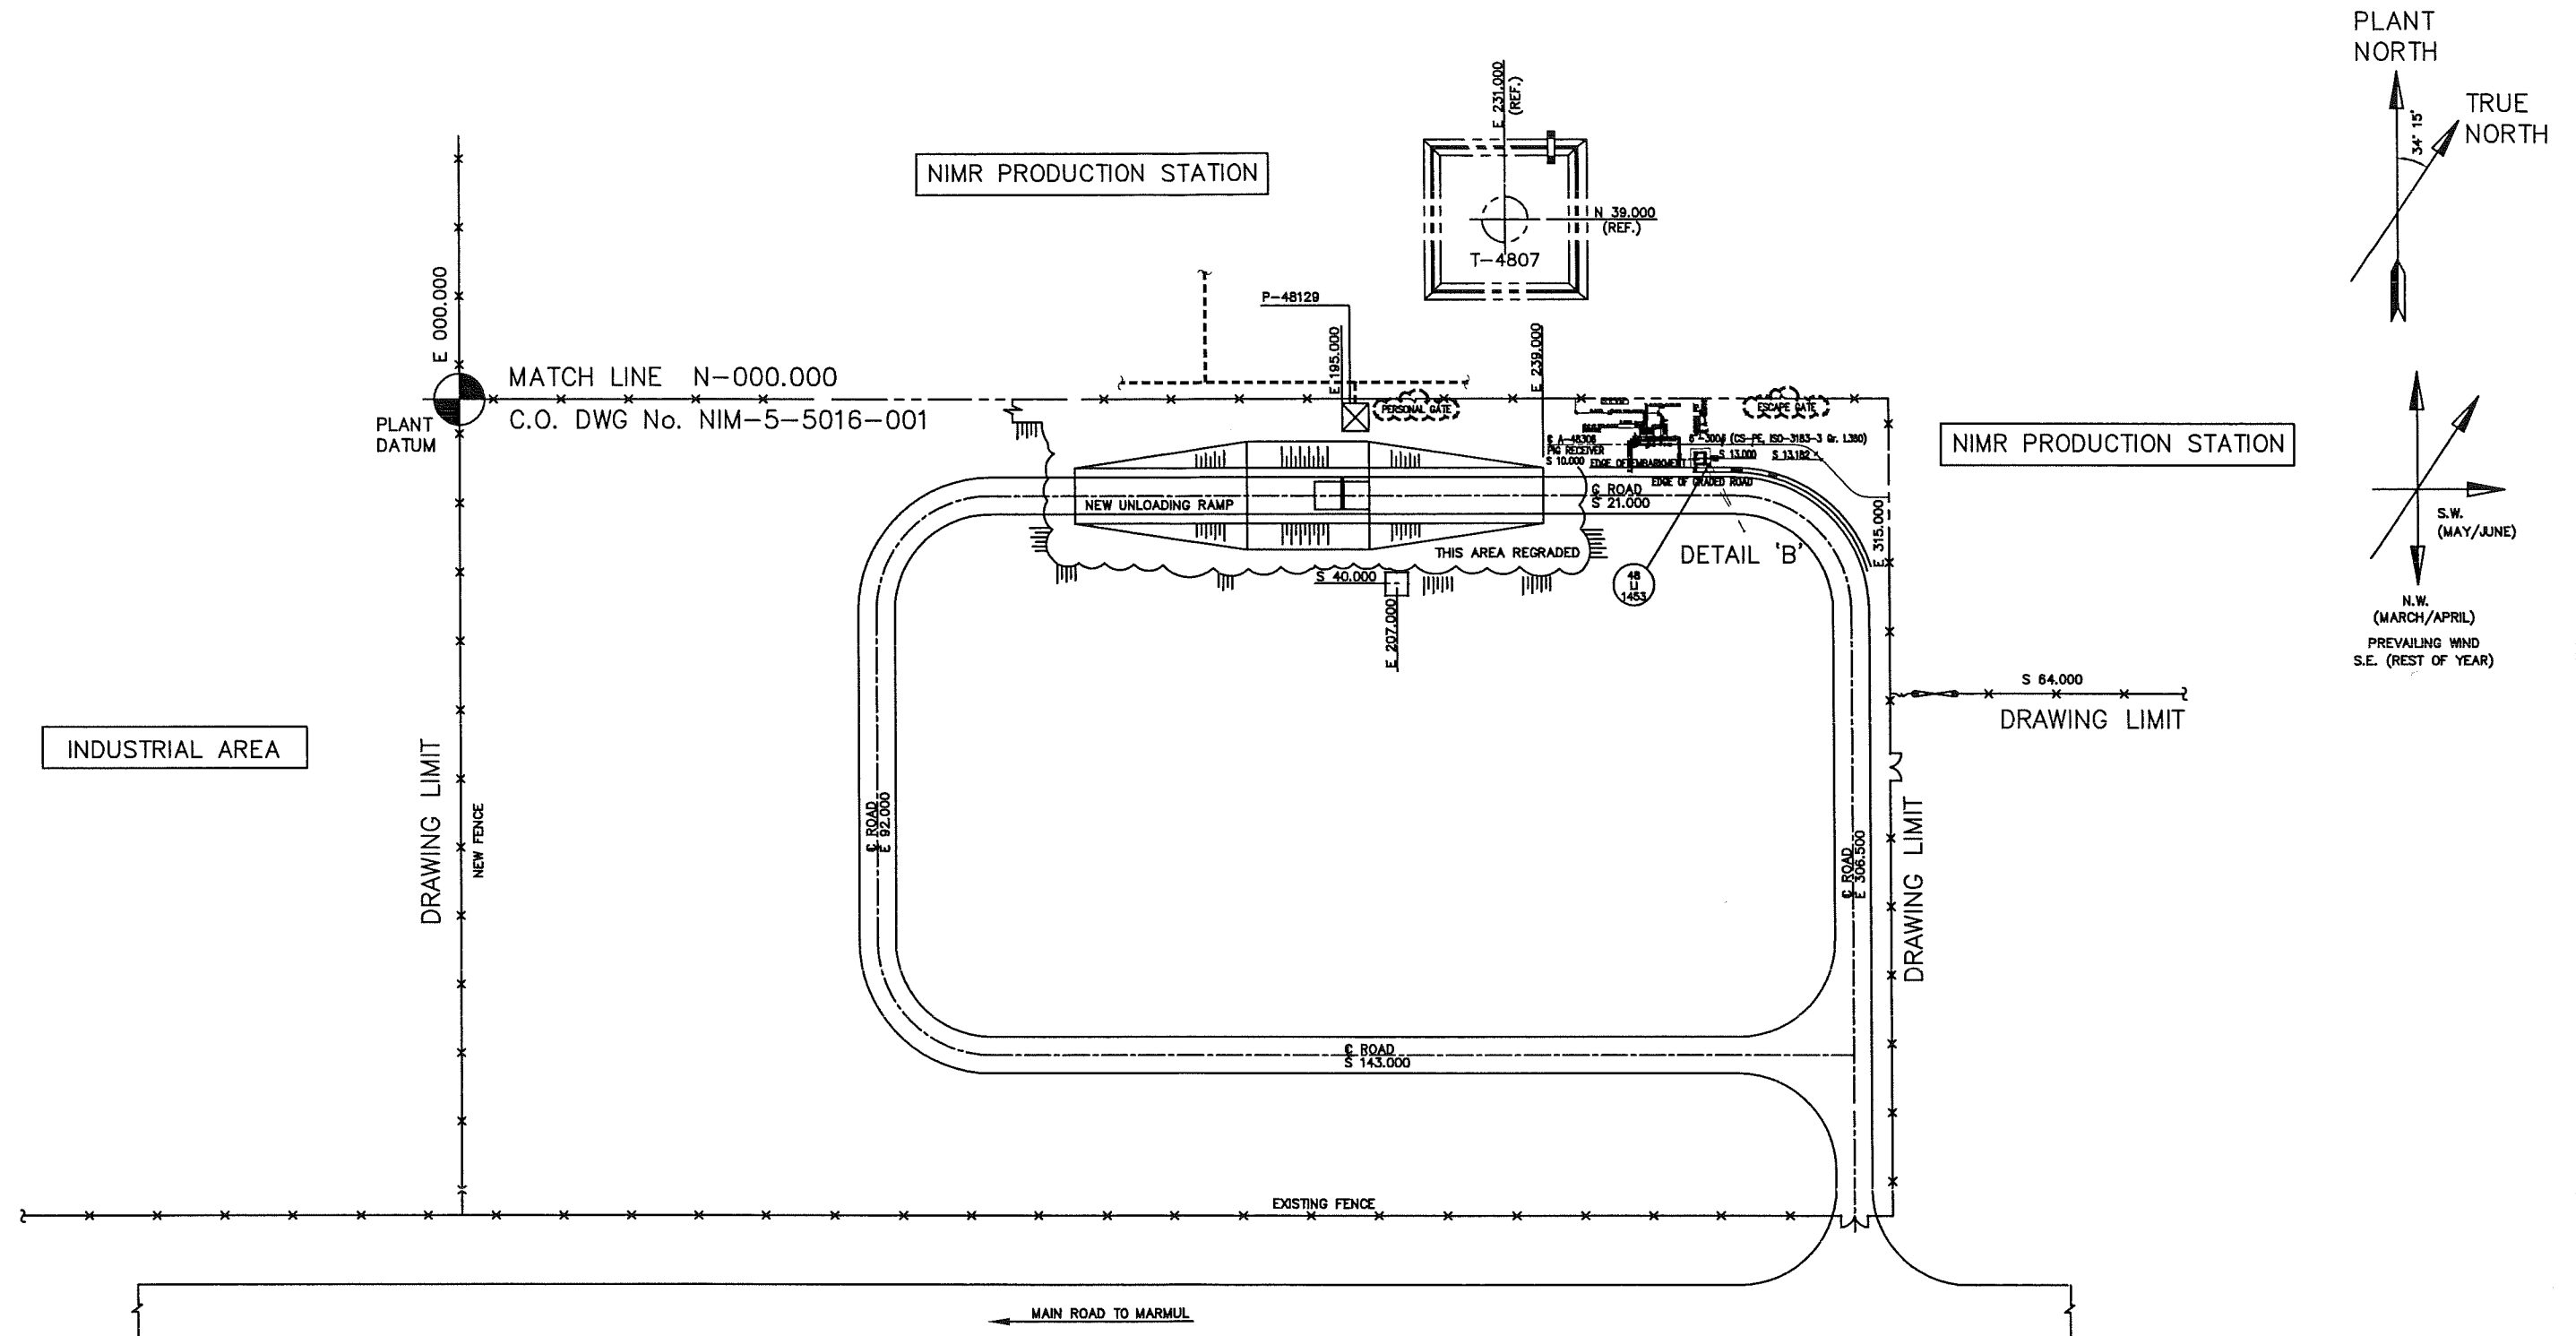

AS BUILT INFORMATION ADDED

THIS COMPLETE DRAWING IS NEW AND FORMS PART OF SCOPE OF PROJECT 'DQ'
WBS No. NIM.IN.09.011

CONTRACT NO.: C31/0606 PROJ. NO.: PAIP00405
WorleyParsons - Arabian Industries (JV)

APPROVED FOR CONSTRUCTION				APPROVED FOR CONSTRUCTION			
REV	DATE	DRAWN BY	CHECKED	REV	DATE	DRAWN BY	CHECKED
0	DEC.10	Mrp/NS	PT	0	DEC.10	Mrp/NS	PT
PROJECT DRAWING REVISION				PROJECT DRAWING REVISION			
IN CASE OF DEVIATIONS A MARKED UP PRINT SHALL BE SENT TO THE PROJECT ENGINEER				IN CASE OF DEVIATIONS A MARKED UP PRINT SHALL BE SENT TO THE PROJECT ENGINEER			
AREA	NIMR			AREA	NIMR		
SUB AREA	PRODUCTION STATION			SUB AREA	PRODUCTION STATION		
DRAWING TYPE	PLOT PLAN			DRAWING TYPE	PLOT PLAN		
DESCRIPTION	INST.LOCATION & JB LAYOUT			DESCRIPTION	INST.LOCATION & JB LAYOUT		
NO	NIM 5 5016 002DQ 1 A			NO	NIM 5 5016 002DQ 1 A		

1. ALL DIMENSIONS ARE IN MM, AND CO-ORDINATES & ELEVATIONS ARE IN METERS UNLESS NOTED.	
NOTES	

INSTRUMENT LOCATION LAYOUT	
DRAWING CONTROL INDEX	
DESCRIPTION	DRAWING NUMBER
NIM 5 5016 001 DQ 1	
NIM 1 2835 500 DQ 4	
AREA 2 SERIAL 24 P 2	

REFERENCE DRAWINGS	
MASTER DRAWING REVISION	
IN CASE OF DEVIATIONS MARKED UP PRINT SHALL BE SENT TO COASTAL DESIGN OFFICE	

F-4801 48-	F-4802 48-	F-4803 48-	F-4804 48-
GSS-771 O/C	GSS-783 O/C	GSS-781 O/C	GSS-701 O/C
GSS-772 O/C	GSS-784 O/C	GSS-782 O/C	GSS-702 O/C
GSS-773 O/C	GSS-786 O/C	GSS-791 O/C	GSS-703 O/C
GSS-774 O/C	GSS-787 O/C	GSS-792 O/C	GSS-704 O/C
GSS-776 O/C		GSS-793 O/C	GSS-705 O/C
GSS-777 O/C		GSS-794 O/C	GSS-707 O/C
		GSS-796 O/C	
		GSS-797 O/C	

PG-108	PG-118	PG-124	PG-429
PG-109	PG-117	PG-125	PG-430
PG-110	PG-118	PG-126	PG-431
PG-111	PG-119	PG-127	PG-432
PG-112	PG-120	PG-128	PG-433
PG-113	PG-121	PG-129	PG-434
PG-114	PG-122	PG-130	PG-435
PG-115	PG-123	PG-131	PG-436

PRA-075	PICA-078	PRA-085	PRA-415
PZA-131	PZA-132	PZA-133	PZA-134
PZA-070	PRA-128	PZA-072	PZA-413
PZA-074	PZA-071	PZA-084	PZA-414
PZA-076	PZA-079	PZA-086	PZA-416
	PZA-081		

XZA-026	XZA-028	XZA-030	XZA-404
XZA-192	XZA-197	XZA-202	XZA-405
XZA-193	XZA-198	XZA-203	XZA-406
XZA-194	XZA-199	XZA-204	XZA-407

TA-052	TA-069	TA-086	TA-427
TA-058	TA-073	TA-090	TA-428
TA-057	TA-074	TA-091	TA-429
TA-059	TA-078	TA-093	TA-430
TA-060	TA-077	TA-094	TA-431
TA-134	TA-154	TA-174	TA-432
TA-135	TA-155	TA-175	TA-433
TA-136	TA-156	TA-176	TA-434
TA-137	TA-157	TA-177	TA-435
TA-138	TA-158	TA-178	TA-436
TA-139	TA-159	TA-179	TA-437
TA-140	TA-160	TA-180	TA-438
TA-141	TA-161	TA-181	TA-439

TC-060	TC-061	TC-062	TC-411
TC-067	TC-072	TC-077	TC-412
TC-068	TC-073	TC-078	TC-413
TC-069	TC-074	TC-079	TC-414
TC-070	TC-075	TC-080	TC-415
TC-071	TC-076	TC-081	TC-416
TC-082	TC-090	TC-098	TC-417
TC-083	TC-091	TC-099	TC-418
TC-084	TC-092	TC-100	TC-419
TC-085	TC-093	TC-101	TC-420
TC-086	TC-094	TC-102	TC-421
TC-087	TC-095	TC-103	TC-422
TC-088	TC-096	TC-104	TC-423
TC-089	TC-097	TC-105	TC-424

11-1-053	11-2-070	11-3-087	11-4-414
11-1-054	11-2-071	11-3-088	11-4-415
11-1-055	11-2-072	11-3-089	11-4-416
11-1-061	11-2-078	11-3-095	11-4-417
11-1-082	11-2-079	11-3-098	11-4-418
11-1-130	11-2-150	11-3-170	11-4-419
11-1-131	11-2-151	11-3-171	11-4-420
11-1-132	11-2-152	11-3-172	11-4-421
11-1-133	11-2-153	11-3-173	11-4-422
11-1-142	11-2-162	11-3-182	11-4-423
11-1-143	11-2-163	11-3-183	11-4-424
11-1-144	11-2-164	11-3-184	11-4-425
11-1-145	11-2-165	11-3-185	11-4-426

TZA-064	TZA-081	TZA-098	TZA-440
TZA-065	TZA-082	TZA-099	TZA-441
TZA-148	TZA-186	TZA-186	TZA-442
TZA-147	TZA-167	TZA-187	TZA-443
TZA-148	TZA-168	TZA-188	TZA-444
TZA-149	TZA-189	TZA-189	TZA-445

UZ-771	UZ-781	UZ-791	UZ-701
UZ-772	UZ-782	UZ-792	UZ-702
UZ-773	UZ-783	UZ-793	UZ-703
UZ-774	UZ-784	UZ-794	UZ-704
UZ-778	UZ-788	UZ-798	UZ-708
UZ-777	UZ-787	UZ-797	UZ-707


INSTRUMENT LOCATED ON / ADJACENT
PUMP AND / OR PUMP BASE

P-4801 48-	P-4802 48-	P-4803 48-	P-4861 48-
PG-015	PG-018	PG-017	PG-068
PG-016	PG-020	PG-018	PG-070



P-4821 48-	P-4822 48-	P-4823 48-	P-4854 48-	P-4855 48-
PG-102	PG-104	PG-106	PG-342	PG-406
PG-103	PG-105	PG-107	PG-343	PG-407

1	2	3	4	5	6	7
48 FZA 405	48 PZA 405	48 PA 406	48 HS 401	48 FZA 305	48 PZA 330	48 PA 331
8	9	10	11	12	13	14
48 FZA 314	48 FZA 228	48 PZA 203	48 PA 208	48 HS 039	48 FZA 228	48 PA 204


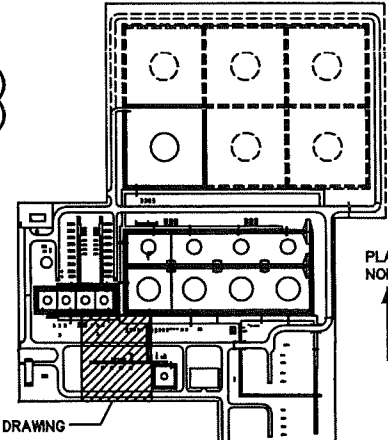
E-117	E-135	E-173	E-204	E-217	E-259
E-122	E-136	E-174	E-205	E-218	E-261
E-123	E-137	E-184	E-206	E-225	E-277
E-124	E-138	E-193	E-207	E-226	E-278
E-128	E-140	E-197	E-208	E-227	E-279
E-129	E-141	E-199	E-209	E-241	E-280
E-130	E-142	E-200	E-210	E-242	E-282
E-131	E-150	E-201	E-211	E-240	E-284
E-132	E-151	E-202	E-212	E-247	E-291
E-133	E-172	E-203	E-213	E-248	E-291
	E-6137			E-6023	E-292
					E-6236

[illegible]

KEY PLAN

A	MAR '11	KK	TS	APPROVED FOR CONSTRUCTION	IN-09.011	OSE/23H	
0	DEC '10	Mrp	PT	ISSUED FOR COMMENTS	IN-09.011	OSE/23H	TH
REV	DATE	DRAWN BY	TRNL. CHECKED	DESCRIPTION	WES No. 02-10	PNOL ENCL.	SIGNATURE
						P D O APPROVAL	
PROJECT DRAWING REVISION							
IN CASE OF DEVIATIONS A MARKED UP PRINT SHALL BE SENT TO THE PROJECT ENGINEER							
AREA	NIMR			SCALE 1: 300 CAD DRAWING  شمالية قدامى			
SUB AREA	PRODUCTION STATION			NO. 05	Petroleum Development Oman 		
DRAWN TYPE	LOCATION OF PLANT INSTRUMENTS AND CABLES						
DESCRIPTION	HEATING SYSTEM						
NO	NIM 5 5015 001DQ			1			

DRAWING CONTROL INDEX		NIM	1	2835	500	DQ	4	5	NOV-98	ASD	AS BUILT UP TO NOV-08	07.08.005	OSD/22M	SK
INSTRUMENT CABLE SCHEDULE		NIM	5	5044		DQ	3	R	DEC-04		AS BUILT FOR PROJECT 5V	11.02.002	TIP/57	
INST. CABLE TERMIN. DETAILS JUNCTION BOXES		NIM	5	5043		DQ	4	R	JUL-00		AS BUILT FOR PROJECT 4U	98.020	ONE/24	
INST. CABLE TRENCH LAYOUT		NIM	5	5001	001			P	JUN-00		AS BUILT FOR PROJECT 3F	98.053	ONE/22	
ENGINEERING PLOT PLAN - CPI AREA		NIM	1	5083	001				0 14.06.85		ISSUED FOR COMMENTS			
DESCRIPTION		AREA	S	REVAL	SH.	P	S	REV	DATE	APPROVED BY	DESCRIPTION	WBS NO 123456	PROBLEMS	SPEC. ENGR
		DRAWING NUMBER								MASTER DRAWING REVISION		P50 APPROVAL		
REFERENCE DRAWINGS										IN CASE OF DEVIATIONS MARKED UP, REVIS. SHALL BE SENT TO COASTAL DESIGN OFFICE				

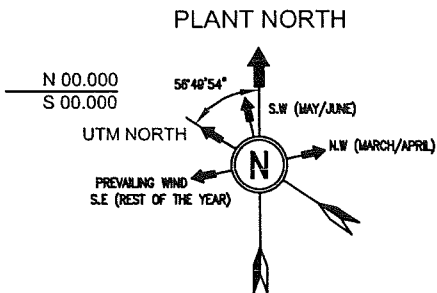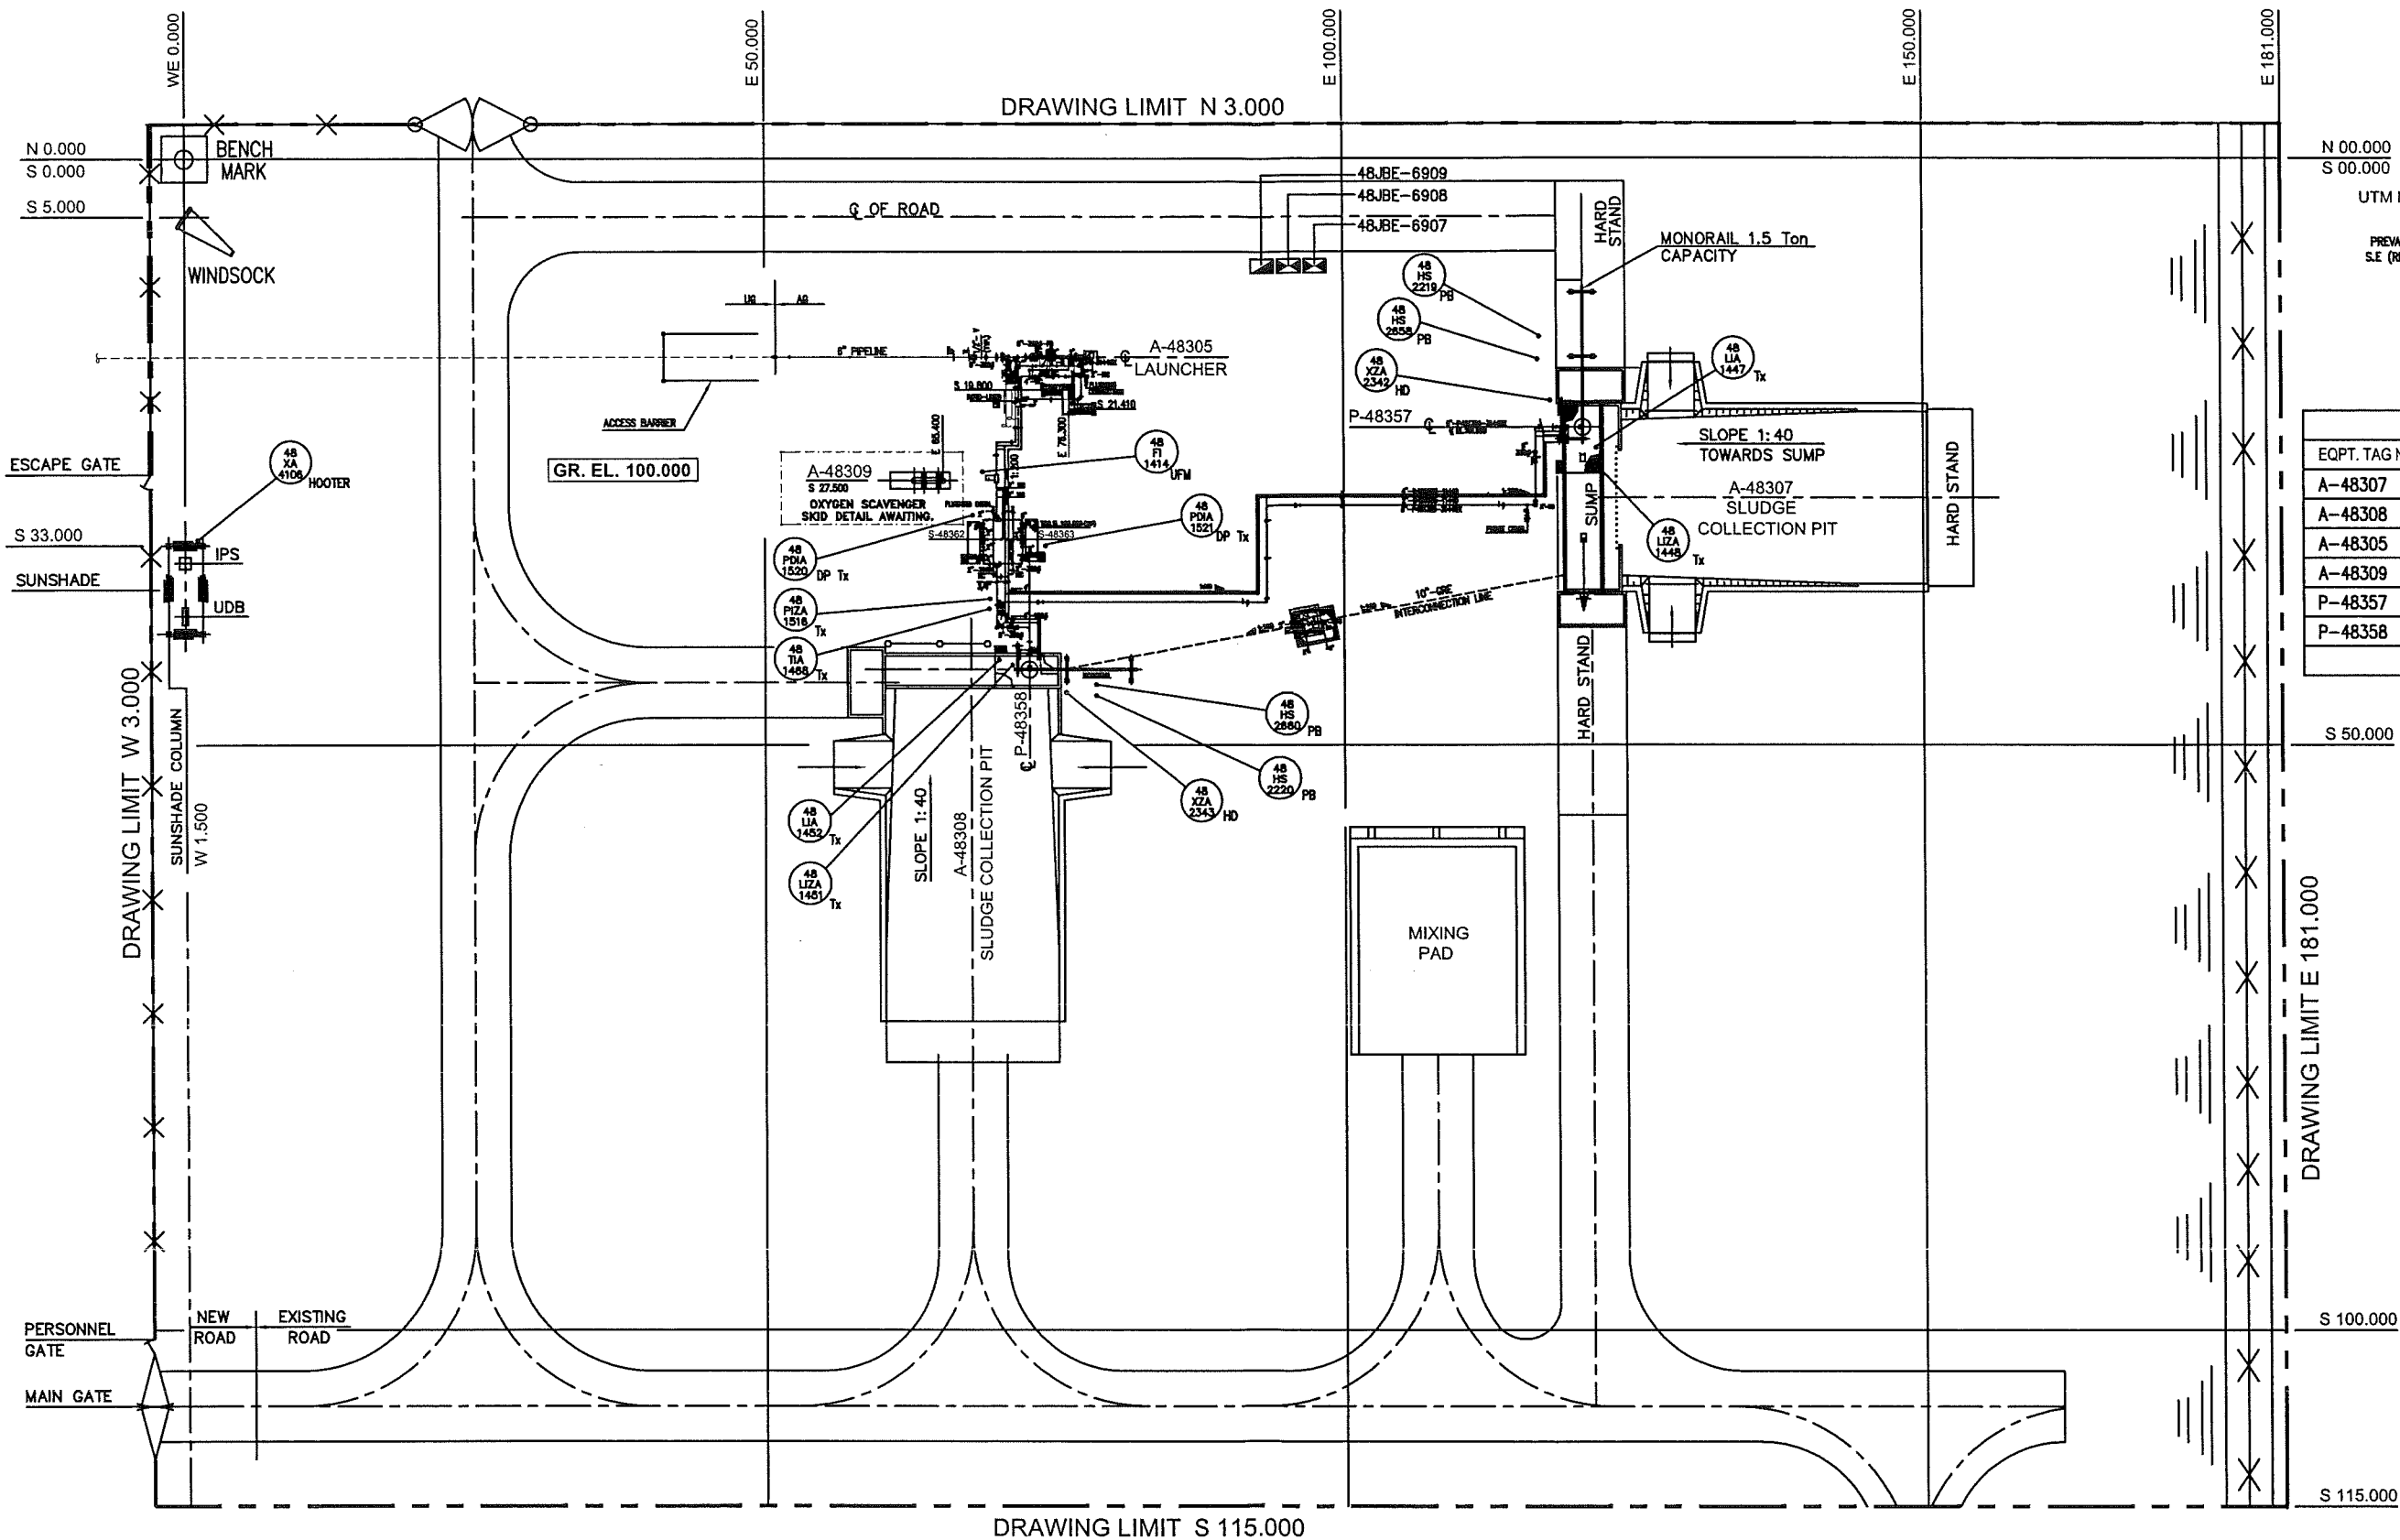

EQUIPMENT DATA	
EQPT. TAG NO.	DESCRIPTION
A-48307	SLUDGE COLLECTION PIT
A-48308	SLUDGE COLLECTION PIT
A-48305	PIG LAUNCHER
A-48309	OXYGEN SCAVENGER SKID
P-48357	SLUDGE OIL TRANSFER PUMP
P-48358	SLUDGE OIL TRANSFER PUMP

S 50.000
DRAWING LIMIT E 181.000
S 100.000
S 115.000

APPROVED FOR CONSTRUCTION

THIS COMPLETE DRAWING IS NEW AND FORMS PART OF SCOPE OF PROJECT 'DQ' WBS No. NIM.IN.09.011

WorleyParsons - Arabian Industries (JV)

REV	DATE	BY	CHKD	DESCRIPTION	IN.09.011	OSE/23N	HI
A	MAR.11	KK	PT	APPROVED FOR CONSTRUCTION	IN.09.011	OSE/23N	HI
0	DEC.10	Wp/NS	PT	ISSUED FOR COMMENTS	IN.09.011	OSE/23N	HI

PROJECT DRAWING REVISION IN CASE OF DEVIATIONS A MARKED UP PRINT SHALL BE SENT TO THE PROJECT ENGINEER

AREA	SUB AREA	NO.	DESCRIPTION	NO.
NIMR	WASTE MANAGEMENT COMPLEX	05	INST. & JB LOCATION LAYOUT	
			SLUDGE COLLECTION AREA	


REV	DATE	BY	CHKD	DESCRIPTION	BLND	PROJ. NO.	SPEC. NO.	POD APPROVAL
NIM	5	4741	001	DQ	1			
NIM	1	2835	500	DQ	4			

2. GRADE ELEVATION 100.000 m. IS EQUAL TO EL. HOLD ABOVE M.S.L.
1. ALL CO-ORDINATES & ELEVATIONS ARE IN m. AND DIMENSIONS ARE IN mm.

NOTES

REFERENCE DRAWINGS

MASTER DRAWING REVISION IN CASE OF DEVIATIONS MARKED UP PRINT SHALL BE SENT TO COASTAL DESIGN OFFICE

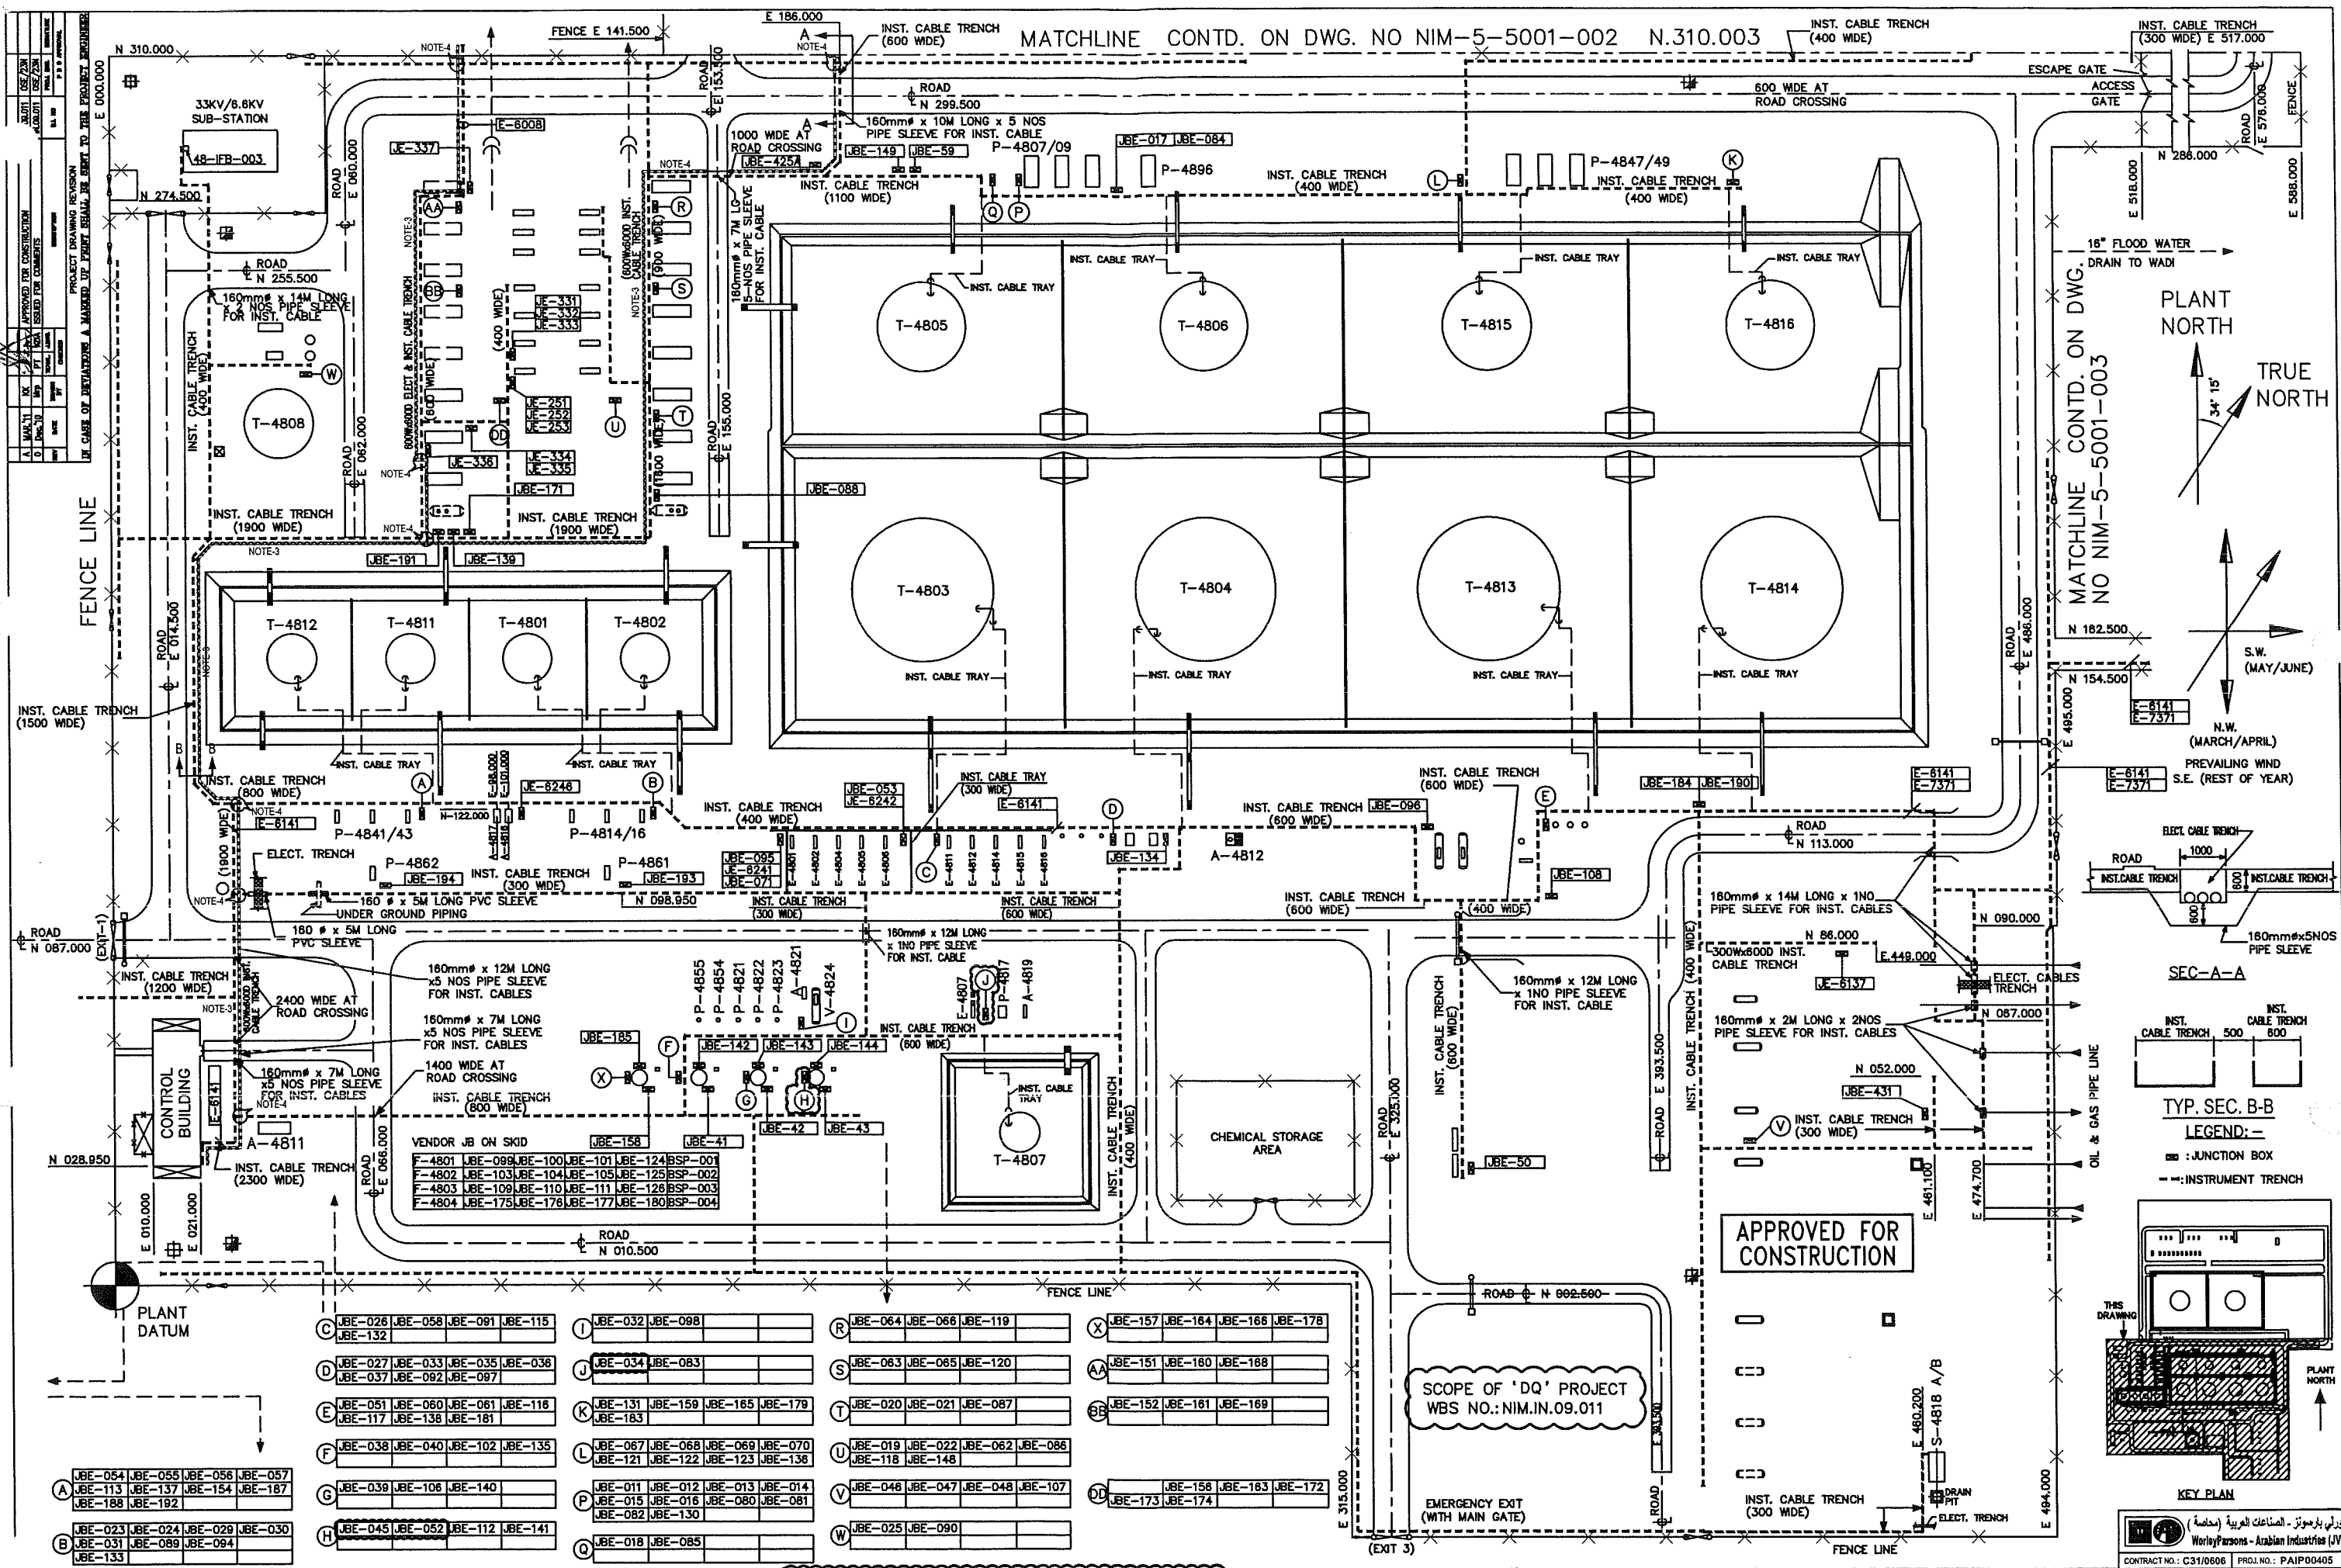

4. 180mm ϕ 5Nos. PIPE SLEEVES USED FOR INST. CABLE CROSSING 3. INST. CABLE TRENCH DISTANCE IS 500mm 2. INSTRUMENT CABLE TRENCH WIDTH SHOWN IN BRACKETS I.e. (400 WIDE). 1. ALL TAG NUMBERS PREFIXED BY 48 I.e. FOR JB12 READ 48-JBE-12.		LOCATION OF PLANT INST. DRAWING CONTROL INDEX INSTRUMENT CABLE SCHEDULE INST. CABLE TERM. DETAILS JUNCTION BOXES OVERALL AREA LAYOUT		NIM 5 5016 001 DQ 1 C NOV/08 ASD AS BUILT UP TO NOV/08		01.08.005 050/22N SK		AREA ,NIMR		SCALE 1:750		CAD DRAWING																																																																																																																																																																																																																																																																																																																																																																																																																																																																																																																																																																																																																																																																																																																																																																																																																																																																																																																																																																																																																											
				NIM 1 3835 002 DQ 4 B DEC/04 ASD AS BUILT FOR PROJECT '5R'		01.116 050/24N				0 1 2 3 4 5 6 7 8 9 10																																																																																																																																																																																																																																																																																																																																																																																																																																																																																																																																																																																																																																																																																																																																																																																																																																																																																																																																																																																																																													
				NIM 5 5044 001 A DEC/04 ASD AS BUILT FOR PROJECT '5R'		N02.002 TTP/54																																																																																																																																																																																																																																																																																																																																																																																																																																																																																																																																																																																																																																																																																																																																																																																																																																																																																																																																																																																																																																	
				NIM 5 5043 001 Z MAR/02 ASD AS BUILT FOR PROJECT CODE '4P'		00.802 050/41 JAMAL																																																																																																																																																																																																																																																																																																																																																																																																																																																																																																																																																																																																																																																																																																																																																																																																																																																																																																																																																																																																																																	
NOTES		DESCRIPTION		AREA B SERIAL 04 P B		REV		DATE		APPROVED BY		DESCRIPTION		WBS No		PROJ. No		SPECIAL		P.D. APPROVAL		DRWG TYPE ,PLOT PLAN		DRWG		AREA CODE		DWG SECT		SERIAL NUMBER		SHEET		PROJ CODE		WBS CODE		REV																																																																																																																																																																																																																																																																																																																																																																																																																																																																																																																																																																																																																																																																																																																																																																																																																																																																																																																																																																																																	
				NIM 1 5073 001 O 10.06.85 FOR CONSTRUCTION TENDER,FP-4361/FP-6251																																																																																																																																																																																																																																																																																																																																																																																																																																																																																																																																																																																																																																																																																																																																																																																																																																																																																																																																																																																																																																			

INSTRUMENT CABLE TERMINATION DETAILS SIGNAL DISTRIBUTION CABINET COVER SHEET

SCOPE OF 'DQ' PROJECT
WBS NO.: NIM.IN.09.011

APPROVED FOR
CONSTRUCTION

A	MAR.'11	KK			APPROVED FOR COMMENTS	IN.09.011	OSE/23N	
0	DEC.'10	Mrp	PT	KDA	ISSUED FOR COMMENTS	IN.09.011	OSE/23N	IH
REV	DATE	DRAWN BY	TEAM L	J.ENG.	DESCRIPTION	WBS No.	PROJ. ENG.	SIGNATURE
			CHECKED				P D O APPROVAL	

PROJECT DRAWING REVISION

IN CASE OF DEVIATIONS A MARKED UP PRINT SHALL BE SENT TO THE PROJECT ENGINEER

	S	NOV.'08	ASD	AS-BUILT UP TO NOV.'08	0T.08.005	OSO/22N	SK
	R	APR.'05		AS BUILT FOR PROJ. '5X'	02.001		BW
	Q	JAN.'05		AS BUILT FOR PROJECT '3Y & X4'	00.304/95.052		BW
	P	DEC.'04		AS BUILT FOR PROJ. 5R	01.116	OSE/24N	
	N	DEC.'04		AS BUILT FOR PROJ. 5V	IN.02.002	TTP/57	
	0	JUNE'97		AS BUILT FOR PROJECT 'L4'	93.609		

REFERENCE TO EQUIPMENT/TAG NUMBERS
ARE TO BE PREFIXED BY AREA CODE

REV	DATE	APPROVED BY	DESCRIPTION	B.I.NO.	PROJ.ENG.	SPEC.ENG.

NOTES/REFERENCE DRAWINGS

MASTER DRAWING REVISION

IN CASE OF DEVIATIONS MARKED UP PRINT SHALL BE SENT TO COASTAL DESIGN OFFICE


AREA : NIMR	SCALE : 0 1 2 3 4 5 6 7 																
SUB AREA : PRODUCTION STATION	CAD DRAWING شركة تنمية نفط عمان Petroleum Development Oman																
DRWG. TYPE : ICTD	<table border="1" style="width: 100%; border-collapse: collapse;"> <tr> <th>DRWG</th><th>AREA CODE</th><th>ENG SECT</th><th>SERIAL NUMBER</th><th>SHEET</th><th>PROJ CODE</th><th>DWG SIZE</th><th>REV.</th></tr> <tr> <td>NO</td><td>NIM</td><td>5</td><td>5589</td><td>001</td><td>DQ</td><td>4</td><td>A</td></tr> </table>	DRWG	AREA CODE	ENG SECT	SERIAL NUMBER	SHEET	PROJ CODE	DWG SIZE	REV.	NO	NIM	5	5589	001	DQ	4	A
DRWG	AREA CODE	ENG SECT	SERIAL NUMBER	SHEET	PROJ CODE	DWG SIZE	REV.										
NO	NIM	5	5589	001	DQ	4	A										
DESCRIPTION : COVER SHEET																	



DESCRIPTION	SHEET	REV 0	REV L	REV R	REV S	REV 0	REV A	REV B
COVER SHEET	001	JUNE 97	FEB'02	APR.05	NOV.'08	DEC.'10	MAR.'11	
REV. / INDEX SHEET	002		↓	↓	NOV'08	DEC.'10	MAR.'11	
REV. / INDEX SHEET	003					DEC.'10	MAR.'11	
REV. / INDEX SHEET	004			APR.05				
REV. / INDEX SHEET	005							
REV. / INDEX SHEET	006							
REV. / INDEX SHEET	007				NOV.'08			
REV. / INDEX SHEET	008			APR.05	NOV.'08			
REV. / INDEX SHEET	009		FEB'02	↓	NOV.'08			
REV. / INDEX SHEET	010							
REV. / INDEX SHEET	011			APR.05				
REV. / INDEX SHEET	012	REV. J JULY'00	FEB'02	↓	NOV.'08			
REV. / INDEX SHEET	013	↓		↓	NOV.'08			
REV. / INDEX SHEET	014	↓	FEB'02					
SPARE	015							
SPARE	016							
SPARE	017							
SPARE	018							
SPARE	019							
SPARE	020							
LEGEND SHEET	021	JUNE 97						
SDE-001 / 48-E-101	022	↓						
SDE-001 / 48-E-131	023							
SDE-001 / 48-E-143 =TERM 061-080	024							
SDE-001 / 48-E-102	025							
SDE-001 / 48-E-113	026							
SDE-001 / 48-E-105	027							
SDE-001 / 48-E-104	028							
SDE-001 / 48-E-107	029							
SDE-001 / 48-E-108	030							
SDE-001 / 48-E-111	031							
SDE-001 / 48-E-112	032	↓						

	P	NOV.'08	ASD	AS-BUILT UP TO NOV.'08	OT.08.005	OSO/22N	SK
	R	APR.05		AS BUILT FOR PROJ. '5X'	02.001		BW
	Q	JAN.05		AS BUILT FOR PROJECT '3Y & X4'	00.394/95.052		BW
	P	DEC'04		AS BUILT FOR PROJ. '5R'	01.116	OSE/24N	
	N	DEC'04		AS BUILT FOR PROJ. '5V'	IN.02.002	TTP/57	
	O	JUNE'97		AS BUILT FOR PROJECT 'L4'	93.609		
REFERENCE TO EQUIPMENT/TAG NUMBERS ARE TO BE PREFIXED BY AREA CODE	REV	DATE	APPROVED BY	DESCRIPTION	B.I.NO.	PROJ.ENG.	SPEC.ENG.
PDO APPROVAL							

NOTES/REFERENCE DRAWINGS | MASTER DRAWING REVISION
IN CASE OF DEVIATIONS MARKED UP PRINT SHALL BE SENT TO COASTAL DESIGN OFFICE

AREA : NIMR	SCALE : 0 1 2 3 4 5 6 7 CAD DRAWING																
SUB AREA : PRODUCTION STATION	NO. 05																
DRWG. TYPE : ICTD	 شركة تنمية نفط عمان Petroleum Development Oman																
DESCRIPTION : REVISION/INDEX SHEET	<table> <tr> <th>DRWG</th><th>AREA CODE</th><th>ENG SECT</th><th>SERIAL NUMBER</th><th>SHEET</th><th>PROJ CODE</th><th>DWG SIZE</th><th>REV.</th></tr> <tr> <td>NO</td><td>NIM</td><td>5</td><td>5589</td><td>002</td><td>DQ</td><td>4</td><td>A</td></tr> </table>	DRWG	AREA CODE	ENG SECT	SERIAL NUMBER	SHEET	PROJ CODE	DWG SIZE	REV.	NO	NIM	5	5589	002	DQ	4	A
DRWG	AREA CODE	ENG SECT	SERIAL NUMBER	SHEET	PROJ CODE	DWG SIZE	REV.										
NO	NIM	5	5589	002	DQ	4	A										



DESCRIPTION	SHEET	REV O	REV J	REV K	REV N	REV O	REV A
SDE-001 / 48-E-120	033	JUNE 97					
SDE-001 / 48-E-121	034						
SDE-001 / 48-E-122	035	JULY'00					
SDE-001 / 48-E-126	036						
SDE-001 / 48-E-127	037						
SDE-001 / 48-E-130	038						
SDE-001 / 48-E-132	039						
SDE-001 / 48-E-6246	040	JULY'00					
SDE-001 / 48-E-133	041						
SDE-001 /	042						
SDE-001 / 48-E-1823	043						
SDE-001 / 48-E-138	044	OCT'02			DEC.04		
SDE-001 / 48-E-141	045	JUNE 97					
SDE-001 / 48-E-140	046						
SDE-001 / 48-E-115	047						
SDE-002 / 48-E-135	048					DEC.'10	MAR.'11
SDE-002 / 48-E-123	049						
SDE-002 / 48-E-109	050						
SDE-002 / 48-E-142	051					DEC.'10	MAR.'11
SDE-002 / 48-E-116	052						
SDE-002 / 48-E-117	053	JULY'00					
SDE-002 / 48-E-6236	054	OCT'02			DEC.04		
SDE-002 / 48-E-144	055	JUNE'97					
SDE-002 / 48-E-124	056					DEC.'10	MAR.'11
SDE-002 / 48-E-153	057						
SDE-002 / 48-E-136	058	OCT'02			DEC.04		
SDE-002 / 48-E-103	059						
SDE-002 / 48-E-106	060						
SDE-002 / 48-E-110	061						
SDE-002 / 48-E-114	062						
SDE-002 / 48-E-119	063						
SDE-002 / 48-E-125	064						

N DEC'04		AS BUILT FOR PROJECT '5V'		IN.02.002	TIP/57
J JULY'00	DVD	AS-BUILT FOR PROJ.'7G' & SITE MARKUP		00.826	ONE/23
O JUNE 97	AJAY	AS BUILT FOR PROJECT 14		93.609	
REV	DATE	TEAM LEAD	DESCRIPTION	PROJ. ENG.	SIGNATURE
	DRAWN BY	CHECKED		WBS No	P D O-APPROVAL

MASTER DRAWING REVISION

IN CASE OF DEVIATIONS A MARKED UP PRINT SHALL BE SENT TO COSTAL DESIGN OFFICE

AREA	:NIMR	SCALE :	0 1 2 3 4 5 6 7	CAD DRAWING
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SUB AREA	: PRODUCTION STATION	NO.	05
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DRWG. TYPE	: ICTD
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DESCRIPTION	: REVISION/INDEX SHEET
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Petroleum Development Oman


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NO	NIM	5	5589 003	DQ	4	A



WorleyParsons-Arabian Industries (JV) Contract No.: C31/0606 Job No.: PAIP00405

FIELD DEVICES		MARSHALLING				SYSTEM CABLE & BOARD					
TAG NUMBER 48	MULTICORE NO. TYPE/SIZE CONNECTED TO	CORE		STRIP A TML'S		NUMBER	TYPE	SIZE	TML'S		TO
GBS-791 O	48-E-135 PVCi-MS-SWA-PVCS 10x4x0.8MM 48-JBE-45	1R	1B	001	002	E-4012	RADIKOR	EM56/54	01	02	DCS-009
GBS-791 C		1W	10	003	004	E-4012	RADIKOR	EM56/54	03	04	DCS-009
GBS-7920		2R	2B	005	006	E-4012	RADIKOR	EM56/54	05	06	DCS-009
GBS-792C		2W	20	007	008	E-4012	RADIKOR	EM56/54	07	08	DCS-009
PZA-084		3R	3B	009	010	E-4113	RADIKOR	EM56/54	23	24	SGS-004B
PZA-086		3W	30	011	012	E-4113	RADIKOR	EM56/54	25	26	SGS-004B
SPARE		4R	4B	013	014						
SPARE		4W	40	015	016						
SPARE		5R	5B	017	018						
SPARE		5W	50	019	020						
PZA-072		6R	6B	021	022	E-4113	RADIKOR	EM56/54	21	22	SGS-004B
GBS-7940		6W	60	023	024	E-4012	RADIKOR	EM56/54	13	14	DCS-009
GBS-794C		7R	7B	025	026	E-4012	RADIKOR	EM56/54	15	16	DCS-009
GBS-7930		7W	70	027	028	E-4012	RADIKOR	EM56/54	09	10	DCS-009
GBS-793C		8R	8B	029	030	E-4012	RADIKOR	EM56/54	11	12	DCS-009
SPARE		8W	80	031	032						
GBS-2660(O)		9R	9B	033	034	E-4012	RADIKOR	EM56/54	19	20	DCS-009
GBS-2660(C)		9W	90	035	036	E-4012	RADIKOR	EM56/54	21	22	DCS-009
SPARE		10R	10B	037	038						
SPARE		10W	100	039	040						


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AREA : NIMR		SCALE : 0 1 2 3 4 5 6 7		CAD DRAWING	
SUB AREA : PRODUCTION STATION		No. 05		 شركة تنمية نفط عُمان Petroleum Development Oman	
DRWG. TYPE : ICTD		DRWG		AREA CODE	ENG SECT
DESCRIPTION : SDE-002 / 48-E-135		SERIAL NUMBER		SHEET	PROJ CODE
		NO		DWG SIZE	REV.
		NIM 5 5589 048 DQ		4	A



FIELD DEVICES		MARSHALLING				SYSTEM CABLE & BOARD					
TAG NUMBER 48	MULTICORE NO. TYPE/SIZE CONNECTED TO	CORE		STRIP A TML'S		NUMBER	TYPE	SIZE	TML'S		TO
UZ-794	48-E-142 PVCI-SWA-PVCS 21x2.5MM2 48-JBE-52	01	02	081	082	E-4122	RADIKOR	EM30/28	07	08	SGS-001B
UZ-793		03	04	083	084	E-4122	RADIKOR	EM30/28	05	06	SGS-001B
UZ-792		05	06	085	086	E-4122	RADIKOR	EM30/28	03	04	SGS-001B
UZ-791		07	08	087	088	E-4122	RADIKOR	EM30/28	01	02	SGS-001B
UZ-797		09	10	089	090	E-4122	RADIKOR	EM30/28	09	10	SGS-001B
PICA-083		11	12	091	092	E-4122	RADIKOR	EM30/28	11	12	SGS-001B
SPARE		13	14	093	094						
UZV-2660		15	16	095	096	E-4122	RADIKOR	EM30/28	25	26	SGS-001B
SPARE		17	18	097	098						
SPARE		19	20	099	100						


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AREA : NIMR		SCALE : 0 1 2 3 4 5 6 7		CAD DRAWING	
SUB AREA : PRODUCTION STATION		no. 05		 شركة تنمية نفط عُمان Petroleum Development Oman	
DRWG. TYPE : ICTD		DRWG		AREA CODE	ENG SECT
DESCRIPTION : SDE-002 / 48-E-142		SERIAL NUMBER		SHEET	PROJ CODE
		NO		DWG SIZE	REV.
		NIM 5 5589 051 DQ		4	A



FIELD DEVICES		MARSHALLING				SYSTEM CABLE & BOARD					
TAG NUMBER 48	MULTICORE NO. TYPE/SIZE CONNECTED TO	CORE		STRIP A TML'S		NUMBER	TYPE	SIZE	TML'S		TO
PDZA-212	48-E-124 PVC1-MS-SWA-PVCS 5x4x0.8MM 48-JBE-34	1R	1B	181	182	E-4113	RADIKOR	EM56/54	29	30	SGS-004B
HS-028		1W	10	183	184	E-4113	RADIKOR	EM56/54	07	08	SGS-004B
PZA-106		2R	2B	185	186	E-4113	RADIKOR	EM56/54	11	12	SGS-004B
PZA-105		2W	20	187	188	E-4113	RADIKOR	EM56/54	09	10	SGS-004B
PZA-107		3R	3B	189	190	E-4113	RADIKOR	EM56/54	13	14	SGS-004B
SPARE		3W	30	191	192						
PDIZA-1523		4R	4B	193	194	E-4113	RADIKOR	EM56/54	39	40	SGS-004B
HS-2230	48-E-135	10R	10B	195	196	E-4113	RADIKOR	EM56/54	41	42	SGS-004B
SPARE	PVC1-MS-SWA-PVCS	5R	5B	197	198						
SPARE	10x4x0.8MM										
SPARE	48-JBE-45	5W	50	199	200						

M1TYPE20

AREA : NIMR		SCALE : 0 1 2 3 4 5 6 7		CAD DRAWING																				
SUB AREA : PRODUCTION STATION		No. 05		 شركة تنمية نفط عُمان Petroleum Development Oman																				
DRWG. TYPE : ICTD		<table border="1"> <tr> <th>DRWG</th> <th>AREA CODE</th> <th>ENG SECT</th> <th>SERIAL NUMBER</th> <th>SHEET</th> <th>PROJ CODE</th> <th>DWG SIZE</th> <th>REV.</th> </tr> <tr> <td>NO</td> <td>NIM</td> <td>5</td> <td>5589</td> <td>056</td> <td>DQ</td> <td>4</td> <td>0</td> </tr> </table>							DRWG	AREA CODE	ENG SECT	SERIAL NUMBER	SHEET	PROJ CODE	DWG SIZE	REV.	NO	NIM	5	5589	056	DQ	4	0
DRWG	AREA CODE	ENG SECT	SERIAL NUMBER	SHEET	PROJ CODE	DWG SIZE	REV.																	
NO	NIM	5	5589	056	DQ	4	0																	
DESCRIPTION : SDE-002 / 48-E-124																								

INSTRUMENT
CABLE BLOCK DIAGRAMS
NIMR SLUDGE PIT SYSTEM UPGRADE

See comments.


15/4/2011

APPROVED FOR
CONSTRUCTION

THIS COMPLETE DRAWING IS NEW AND FORMS PART OF SCOPE OF PROJECT 'DQ' WBS No.NM.N.09.011										CONTRACT NO.: C31/0606 PROJ NO.: PAIP00405										IN CASE OF DEVIATIONS A MARKED UP PRINT SHALL BE SENT TO THE PROJECT ENGINEER									
DRAWING CONTROL INDEX										PROJECT DRAWING REVISION										SCALE: 1:100									
DESCRIPTION										AREA										SUB AREA									
DRAWING NUMBER										NO. 05										CABLE BLOCK DIAGRAM									
DATE										NO. 05										COVER SHEET									
REFERENCE DRAWINGS										MASTER DRAWING REVISION										IN CASE OF DEVIATIONS MARKED UP PRINT SHALL BE SENT TO COASTAL DESIGN OFFICE									
NOTES																													


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001	COVER SHEET	DEC.'10	MAR.'11				031						
002	REVISION / INDEX SHEET	DEC.'10	MAR.'11				032						
003	SLUDGE COLLECTION AREA	DEC.'10	MAR.'11				033						
004	SLUDGE COLLECTION AREA	DEC.'10	MAR.'11				034						
005	PRODUCTION STATION	DEC.'10	MAR.'11				035						
006							036						
007							037						
008							038						
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011							041						
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
FIELD (NIMR SLUDGE PIT)


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

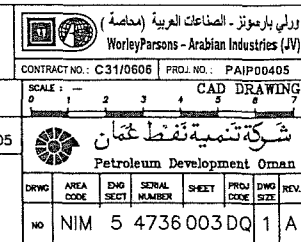
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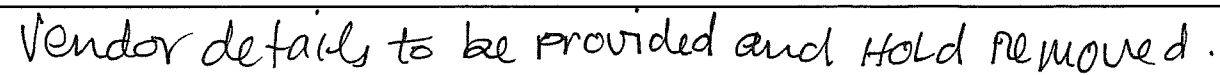
SCADA ROOM (EXISTING)




															AREA : NIMR															SCALE : 1:1 0 1 2 3 4 5 6 7 CAD DRAWING																																																																																																																																																																																																																																																																																																																																																																																																																																																																																																																																																																																																																																																																																																																																																																																																																																																																																																																																																																																																																																																																																																																																																																																																																																																																																																																																																																																																																																																																																																																																																																																																																																																																																																																																																																																																																																																																																																																																																																																																																																																																																																																																																																																																																																																																																																																																																																																																																																																																																																																																																																																																																																																																																																																																																																																																																																																																																																																																																																																																																																																																																																																																																																																																																																																																																																																																																																																																																																																																																																																																																																																																																																																																																																																																																																																																																																																																																																																																																																																																																																																																																																																																																																																																																																																																																																																																																																																																																																																																																																																																																																																																																																																																																																																																																																																																																																																																																																																																																																																																																																																																																																																																																																																																	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 (مخصصة) WorleyParsons - Arabian Industries (JV)	
CONTRACT NO.: C31/0606	PROJ. NO.: PAIPD0405
SCALE: — 	
 شركة تنمية نفط عمان Petroleum Development Oman	
DWG NO	REV
AREA CODE	ENG. SECT
SERIAL NUMBER	SHEET
PROJ. CODE	DWG. SIZE
NO	1
NIM 5 4736003DQ	1 A

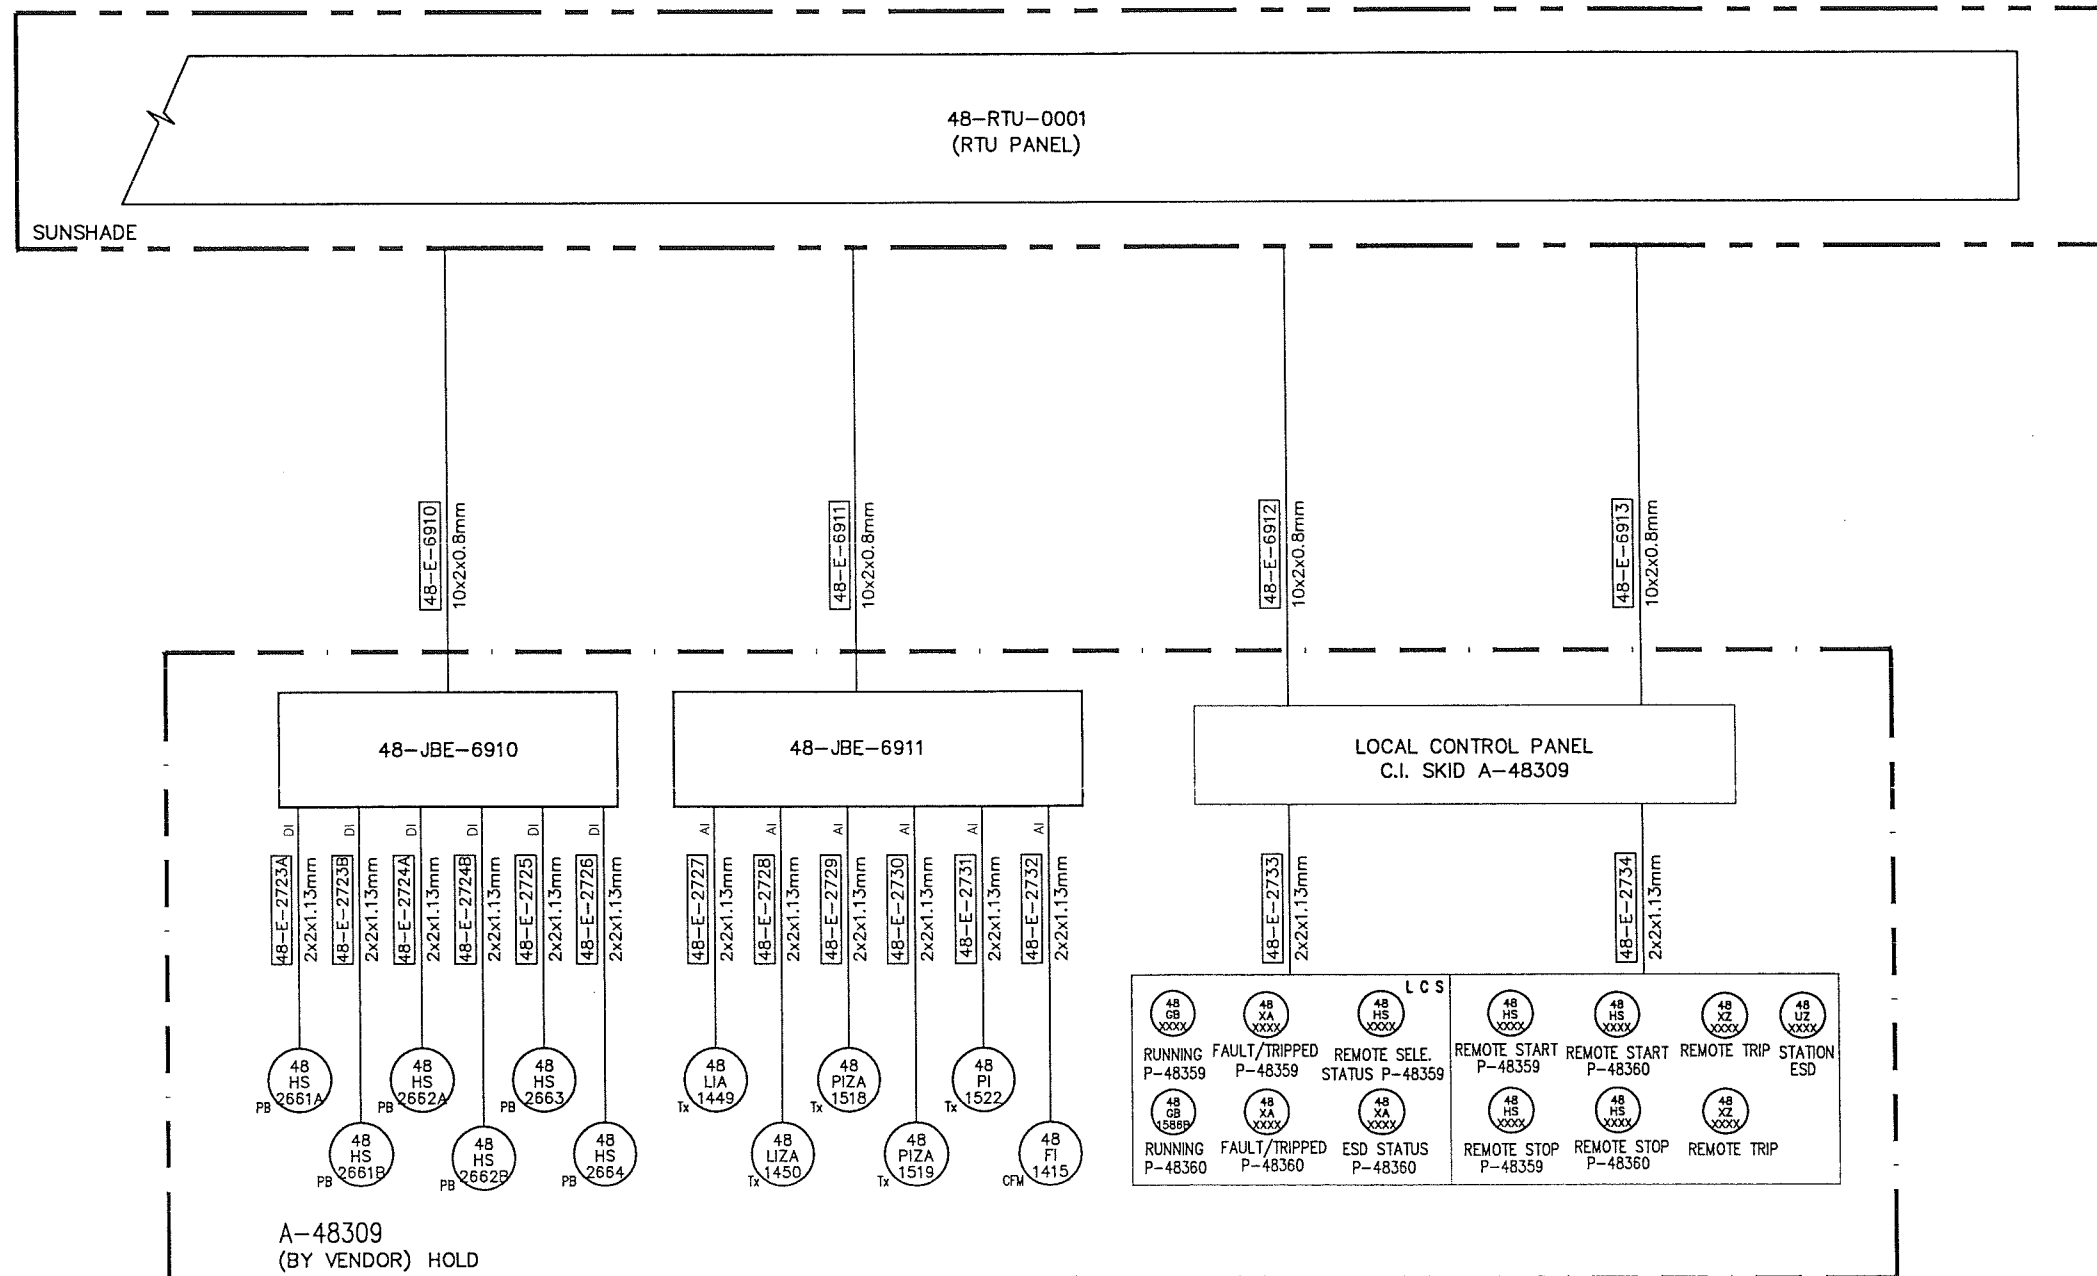

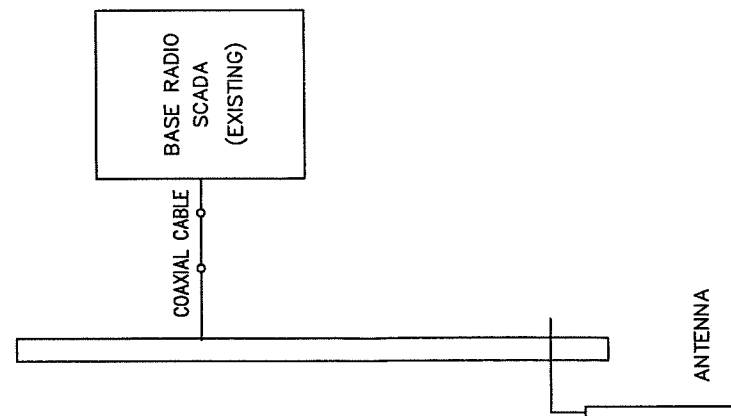																				AREA : NIMR SUB AREA : NIMR SLUDGE PIT NO. 05 SCALE : 1" = 10' 0" CAD DRAWING 0 1 2 3 4 5 6 7 شركة تنمية نفط عمان Petroleum Development Oman									
DRAWING CONTROL INDEX										NIM 1 2635 500 DQ 4 AREA SERIAL ISL P REV DATE APPROVED BY DESCRIPTION										DWTG TYPE : CABLE BLOCK DIAGRAM DWTG : NIM 5 4736 004 DQ 1 A NO. NIM 5 4736 004 DQ 1 A									
NOTES										REFERENCE DRAWINGS										MASTER DRAWING REVISION IN CASE OF DEVIATIONS MARKED UP PRINT SHALL BE SENT TO COASTAL DESIGN OFFICE									



Petroleum Development of Oman

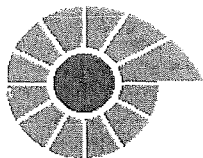To: WPAI

Attn: Bachcha Ram Yadav

TRANSMITTAL LETTER No: PAIP00405/WPAI /PDO/NIMR/T0060/11

W.B.S No:	Date:08/02/2011
Project Title: Nimr Sludge Pits System upgrade – FED & DD	

Identification Number	Issue	Code	Nos	Short Description
PAIP00405/PDO/TR00098		2		Cause & Effect Diagrams

Codes:

- | | | |
|----------------------|--------------------|--------------------|
| 1. Comments as Noted | 5.For Construction | 9.For Final |
| 2. Approved | 6.For Enquiry | 10.Cancelled |
| 3. Revised | 7.For Purchase | 11.For Information |

External	Code	Nos.	Number	Internal	Code	Nos.	Number
A = Copy of the transmittal B = Full documentation P = Print T = Reproducible O = Original					Originator = OSE/44N		

Additional Remarks:

Yours Very Truly
Sr. Khalid Al-Maqbali. OSE22N
Project Engineer
Petroleum Development of Oman

[illegible]



Document Transmittal

Job No: PAIP00405 **Transmittal No:** PAIP00405/PDO/TR00098
Title: Nimr Sludge Pits System upgrade - FED & DD **Date:** 05/02/2011
Client Code: PDO **Name:** Petroleum Development Oman LLC
From: Bachcha Ram Yadav **To:** KHALID AL-Maqbali OSE22N

We enclosed herewith the following documents for **Original for Signature**
Please acknowledge by returning a copy of this transmittal dully signed


Sr. No.	Document No.	Rev.#	Title	Copies	Remarks
1	NIM-5-5005-001	B	Cause & Effect Diagrams	11	
2	NIM-5-5005-002	A	Cause & Effect Diagrams		
3	NIM-5-5005-007	A	Cause & Effect Diagrams		

Internal Distribution:

Project: Indraneel Dutta
Process: Manisha Devghare
Mechanical: Himanshu Desai
Electrical: Shahaul Diwan
Control & Automation: Prakash Thomas

Civil: Balaraj Reddy
Pipeline: Malleesh Mallik
Client: KHALID AL-Maqbali OSE22N
Construction: N
Procurement: N

Others :

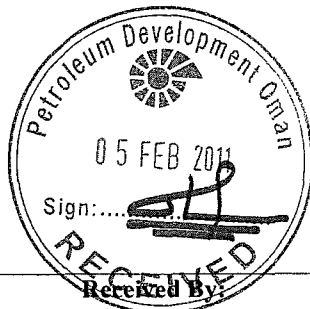

Transmitted By

WorleyParsons Project Engineer
Bachcha Ram Yadav

Received By

Date

✓✓ WorleyParsons/CLIENT Copy

Printed by: ABDULAZIZ.AL-FOURY, Based on Release notes: INST 00020.

EFFECT			CAUSE		
TITLE	DESCRIPTION	TAG NO.	TITLE	DESCRIPTION	TAG NO.
FIELD H'DR INLET VALVES	CLOSE NIMR H'DR ESD VALVE	48-UZ-007	ESD INITIATION	ESD/MANUAL SWITCH (TOTAL STATION SHUTDOWN)	48-HBZA-100
	CLOSE AMAL H'DR ESD VALVE	48-UZ-112		MANUAL SWITCH TRAIN A SHUTDOWN	48-HBZA-101
	CLOSE NIMR-A INLET HDR.	48-UZ-113		MANUAL SWITCH TRAIN B SHUTDOWN	48-HBZA-102
	CLOSE W-S H'DR ESD VALVE	48-UZ-071		MANUAL SWITCH TRAIN C SHUTDOWN	48-HBZA-103
	CLOSE KARIM WEST ESD VALVE	48-UZ-300		MANUAL SWITCH TRAIN D SHUTDOWN	48-HBZA-104
FEEDERS	CLOSE AMIN/KARIM WEST HD'R ESD VALVE	48-UZ-114		TRANS ABC & D SHUTDOWN	48-HBZA-105
	STOP BEAM PUMPS W-S	48-UZ-202		SHUTDOWN FROM MARMUL CCR	48-HBZA-106
	STOP BEAM PUMPS KARIM WEST/AMIN	48-UZ-302		SHUTDOWN FROM MARMUL CCR	48-HBZA-107
	STOP AMAL BEAM PUMPS	48-UZ-303		SHUTDOWN FROM MARMUL CCR	48-HBZA-108
	CLOSE RECOVERED OIL ISO'N VALVE TRAIN A	48-UZ-131		SHUTDOWN FROM MARMUL CCR	48-HBZA-109
RECOVERED OIL ISO'N VALVES	CLOSE RECOVERED OIL ISO'N VALVE TRAIN B	48-UZ-132		SHUTDOWN FROM MARMUL CCR	48-HBZA-110
	CLOSE RECOVERED OIL ISO'N VALVE TRAIN C	48-UZ-133		SHUTDOWN FROM MARMUL CCR	48-HBZA-111
	CLOSE RECOVERED OIL ISO'N VALVE TRAIN D	48-UZ-091		SHUTDOWN FROM MARMUL CCR	48-HBZA-112
	CLOSE WATER OUTLET VALVE T-4801	48-UZ-141		SHUTDOWN FROM MARMUL CCR	48-HBZA-113
	CLOSE WATER OUTLET VALVE T-4802	48-UZ-151		SHUTDOWN FROM MARMUL CCR	48-HBZA-114
FREE WATER KNOCK-OUT TANKS	CLOSE WATER OUTLET VALVE T-4801	48-UZ-821		SHUTDOWN FROM MARMUL CCR	48-HBZA-115
	CLOSE WATER OUTLET VALVE T-4802	48-UZ-821		SHUTDOWN FROM MARMUL CCR	48-HBZA-116
	CLOSE WATER OUTLET VALVE T-4803	48-UZ-811		SHUTDOWN FROM MARMUL CCR	48-HBZA-117
	CLOSE WATER OUTLET VALVE T-4804	48-UZ-811		SHUTDOWN FROM MARMUL CCR	48-HBZA-118
	CLOSE WATER OUTLET VALVE T-4805	48-UZ-811		SHUTDOWN FROM MARMUL CCR	48-HBZA-119
CONCENTRIC WASH TANKS	CLOSE WATER OUTLET VALVE T-4803	48-UZ-161.1/2		SHUTDOWN FROM MARMUL CCR	48-HBZA-120
	CLOSE WATER OUTLET VALVE T-4804	48-UZ-171.1/2		SHUTDOWN FROM MARMUL CCR	48-HBZA-121
	CLOSE WATER OUTLET VALVE T-4813	48-UZ-851.1/2		SHUTDOWN FROM MARMUL CCR	48-HBZA-122
	CLOSE WATER OUTLET VALVE T-4814	48-UZ-652.1/2		SHUTDOWN FROM MARMUL CCR	48-HBZA-123
	CLOSE WATER OUTLET VALVE T-4805	48-UZ-751		SHUTDOWN FROM MARMUL CCR	48-HBZA-124
STORAGE TANKS	CLOSE WATER OUTLET VALVE T-4806	48-UZ-761		SHUTDOWN FROM MARMUL CCR	48-HBZA-125
	CLOSE WATER OUTLET VALVE T-4815	48-UZ-881		SHUTDOWN FROM MARMUL CCR	48-HBZA-126
	CLOSE WATER OUTLET VALVE T-4816	48-UZ-681		SHUTDOWN FROM MARMUL CCR	48-HBZA-127
	CLOSE EXPORT VALVE TO MARMUL-HUBARA	48-UZ-101		SHUTDOWN FROM MARMUL CCR	48-HBZA-128
	CLOSE EXPORT VALVE TO MARMUL-HUBARA	48-UZ-1276		SHUTDOWN FROM MARMUL CCR	48-HBZA-129
EXPORT OIL	SHUTDOWN BURN PIT	48-UZ-740		SHUTDOWN FROM MARMUL CCR	48-HBZA-130
BURN PIT	CLOSE FUEL GAS SUPPLY PIPELINE VALVES	48-UZ-102.1/2		SHUTDOWN FROM MARMUL CCR	48-HBZA-131
FUEL GAS	OPEN FUEL GAS K.O.DRUM BLOWDOWN VALVE	48-UZ-103		SHUTDOWN FROM MARMUL CCR	48-HBZA-132
	CLOSE FUEL GAS SUPPLY TO NIMR GATH. STN.	48-UZ-181		SHUTDOWN FROM MARMUL CCR	48-HBZA-133
	CLOSE FUEL GAS SUPPLY TO K-WEST GATH.STN.	48-UZ-191		SHUTDOWN FROM MARMUL CCR	48-HBZA-134
	SHUTDOWN HEATER F-4801	48-UZ-770		SHUTDOWN FROM MARMUL CCR	48-HBZA-135
	SHUTDOWN HEATER F-4802	48-UZ-780		SHUTDOWN FROM MARMUL CCR	48-HBZA-136
HEATING MEDIUM HEATERS	SHUTDOWN HEATER F-4803	48-UZ-790		SHUTDOWN FROM MARMUL CCR	48-HBZA-137
	SHUTDOWN HEATER F-4804	48-UZ-700		SHUTDOWN FROM MARMUL CCR	48-HBZA-138
	CLOSE WATER INLET VALVE TO V-4801	48-UZ-711		SHUTDOWN FROM MARMUL CCR	48-HBZA-139
	CLOSE WATER OUTLET VALVE TO V-4801	48-UZ-712		SHUTDOWN FROM MARMUL CCR	48-HBZA-140
	CLOSE WATER INLET VALVE TO V-4802	48-UZ-721		SHUTDOWN FROM MARMUL CCR	48-HBZA-141
CPI SEPARATORS	CLOSE WATER OUTLET VALVE TO V-4802	48-UZ-722		SHUTDOWN FROM MARMUL CCR	48-HBZA-142
	CLOSE WATER INLET VALVE TO V-4803	48-UZ-731		SHUTDOWN FROM MARMUL CCR	48-HBZA-143
	CLOSE WATER OUTLET VALVE TO V-4803	48-UZ-732		SHUTDOWN FROM MARMUL CCR	48-HBZA-144
	CLOSE WATER INLET VALVE TO V-4830	48-UZ-911		SHUTDOWN FROM MARMUL CCR	48-HBZA-145
	CLOSE WATER OUTLET VALVE TO V-4830	48-UZ-912		SHUTDOWN FROM MARMUL CCR	48-HBZA-146
	CLOSE WATER INLET VALVE TO V-4831	48-UZ-921		SHUTDOWN FROM MARMUL CCR	48-HBZA-147
	CLOSE WATER OUTLET VALVE TO V-4831	48-UZ-922		SHUTDOWN FROM MARMUL CCR	48-HBZA-148
	CLOSE WATER INLET VALVE TO V-4832	48-UZ-931		SHUTDOWN FROM MARMUL CCR	48-HBZA-149
	CLOSE WATER OUTLET VALVE TO V-4832	48-UZ-932		SHUTDOWN FROM MARMUL CCR	48-HBZA-150
	CLOSE WATER INLET VALVE TO V-4833	48-UZ-941		SHUTDOWN FROM MARMUL CCR	48-HBZA-151
	CLOSE WATER OUTLET VALVE TO V-4833	48-UZ-942		SHUTDOWN FROM MARMUL CCR	48-HBZA-152
	CLOSE WATER INLET VALVE TO V-4834	48-UZ-951		SHUTDOWN FROM MARMUL CCR	48-HBZA-153
	CLOSE WATER OUTLET VALVE TO V-4834	48-UZ-952		SHUTDOWN FROM MARMUL CCR	48-HBZA-154
	CLOSE WATER INLET VALVE TO V-4861	48-UZ-211		SHUTDOWN FROM MARMUL CCR	48-HBZA-155
	CLOSE WATER OUTLET VALVE TO V-4861	48-UZ-212		SHUTDOWN FROM MARMUL CCR	48-HBZA-156
CPI SEPARATORS	CLOSE WATER INLET VALVE TO V-4862	48-UZ-221		SHUTDOWN FROM MARMUL CCR	48-HBZA-157
	CLOSE WATER OUTLET VALVE TO V-4862	48-UZ-222		SHUTDOWN FROM MARMUL CCR	48-HBZA-158
	CLOSE WATER INLET VALVE TO V-4863	48-UZ-231		SHUTDOWN FROM MARMUL CCR	48-HBZA-159
	CLOSE WATER OUTLET VALVE TO V-4863	48-UZ-232		SHUTDOWN FROM MARMUL CCR	48-HBZA-160
	CLOSE CPI BYPASS VALVE	48-UZ-1251		SHUTDOWN FROM MARMUL CCR	48-HBZA-161
SLUDGE TANK	CLOSE T-4807 SLUDGE OIL INLET ESD VALVE 48-UZV-2660	48-UZ-2659		SHUTDOWN FROM MARMUL CCR	48-HBZA-162

SH1	SH4	SH7	SH10	SH13	SH16
SH5	SH8	SH11	SH14	SH17	
SH3	SH6	SH9	SH12	SH15	SH18

AS BUILT INFORMATION ADDED

THIS DRAWING IS BASED ON 'CN' PROJECT
DRAWING UNDER WBS No. IN.08.002
REV.'0' AS-BUILT UPDATION

THIS DRG. IS ONLY MADE FOR
AS BUILT UPDATION AND IS NOT
IN THE SCOPE OF 'CN' PROJECT
WBS NO.:NIM.IN.08.002

SCOPE OF 'DQ' PROJECT
WBS NO.:NIM.IN.09.011

ورلي بارسونز - الصناعات العربية (محصاة)
WorleyParsons - Arabian Industries (JV)
CONTRACT NO.: C31/0606 PROJECT NO.: PAIP00405

A	JAN.'11	Mtp	PT	WSD	APPROVED FOR CONSTRUCTION	IN.09.011	OSE/23N		
D	MAY'10	MAJ	PT	WSD	ISSUED FOR COMMENTS	IN.09.011	OSE/23N		
REV	DATE	DRAWN BY	TEAM	JENL	DESCRIPTION	WBS No.	PROJ. ENG.	SIGNATURE	P. D. APPROVAL
				CHECKED					

PROJECT DRAWING REVISION									
IN CASE OF DEVIATIONS A MARKED UP PRINT SHALL BE SENT TO THE PROJECT ENGINEER									
AREA	:NIMR					NO. 05	SCALE 1 2 3 4 5 0 1 2 3 4 5 CAD DRAWING		
SUB AREA	:NIMR PRODUCTION STATION					NO. 05	شركة تنمية نفط عمان Petroleum Development Oman		
DWG. TYPE	: CAUSE & EFFECT DIAGRAM					DWG. AREA CODE ENG. SECT. SHEET PROJ. DWG. P.D. NO.			
DESCRIPTION	: SHEET 2					NO NIM 5 5005 002 DQ 1 A			

- 6 CLOSURES ON 2/3 VOTING FAILS.
5. 48-LZA-050 IS EXISTING.
4. EQUIPMENT PROTECTION TRIPS ARE NOT SHOWN.
3. VALVE CLOSED WHEN EITHER P-4858 OR P-4859 IS NOT RUNNING.
- 2 * CARRY OUT SAFETY ACTION IF PLANT ITEM SELECTED FOR TRAIN DUTY.
1. X CARRY OUT SAFETY ACTION.

DRAWING CONTROL INDEX

DESCRIPTION

REV	DATE	APPROVED BY	DESCRIPTION	WBS No.	PROJ. ENG.	SIGNATURE	P. D. APPROVAL
1	DEC'04		AS BUILT FOR PROJECT 'SV'	IN.02.002	TTP/57		
2	JULY'00		AS BUILT FOR PROJECT '22'	00.828	ONE/23		
3	JUN'00		AS BUILT FOR PROJECT '3F'	99.063	ONE/22		
4	MAR'00		AS BUILT FOR FCP-1234	0.833	ONE/33		
5	MAR'00		AS BUILT FOR PROJECT '1D'	99.134	ONE/24		

REFERENCE DRAWINGS

MASTER DRAWING REVISION
IN CASE OF DEVIATIONS MARKED UP PRINT SHALL BE SENT TO COASTAL DESIGN OFFICE

